

studio rai,

Architectural Design P.C.

290 Salem Rd.

Pound Ridge, NY 10576

Tel: (914) 273-6843

Fax: (914) 763-0216

Att: Adam R. Kaufman, AICP

Re: Proposed Pool and Cabana for the Kirschner Residence
8 Spruce Hill Rd.
Town of North Castle
Sec. 1, Blk. 4, Lot 10-2

Dear Mr. Kaufman,

Attached please find the following for review by the Residential Review Committee for a New inground Swimming Pool and Cabana.

- RPRC Review Form
- Dwg. SP-1 Residential Site Plan dated 10-16-20
- Dwg. SP-2 Pool, Cabana and Terrace Plan and Details.
- Dwg. SU- As-Built Survey of existing conditions.
- Dwg. GN- General Notes.
- Dwg. A1- Cabana Floor Plans.
- Dwg. A2- Cabana Elevations.
- Dwg. A3- Cabana Section Detail.
- Dwg. P1- Pool Plan and Details.
- Dwg. S1-E1- Framing Plans/Lighting.



I am additionally attaching the original RPRC Submission Form and documents from 2010 Submission Prepared by Barry Naderman, when we first submitted plans for the new residence.

A portion of the Proposed Project/Site Plan was never built, (Terraces and Swimming Pool) Mr. Naderman designed the Infiltration System to accommodate Terraces, Swimming Pool, and swimming pool drawdown. The designed system was installed as designed.

Sincerely,

Lucio Di Leo

Lucio Di Leo R.A., AIA

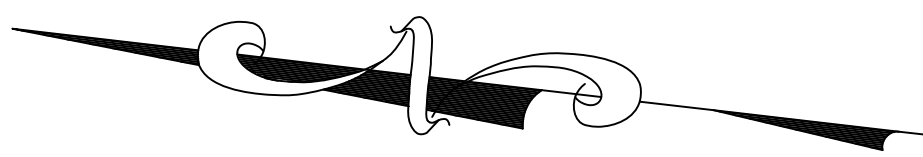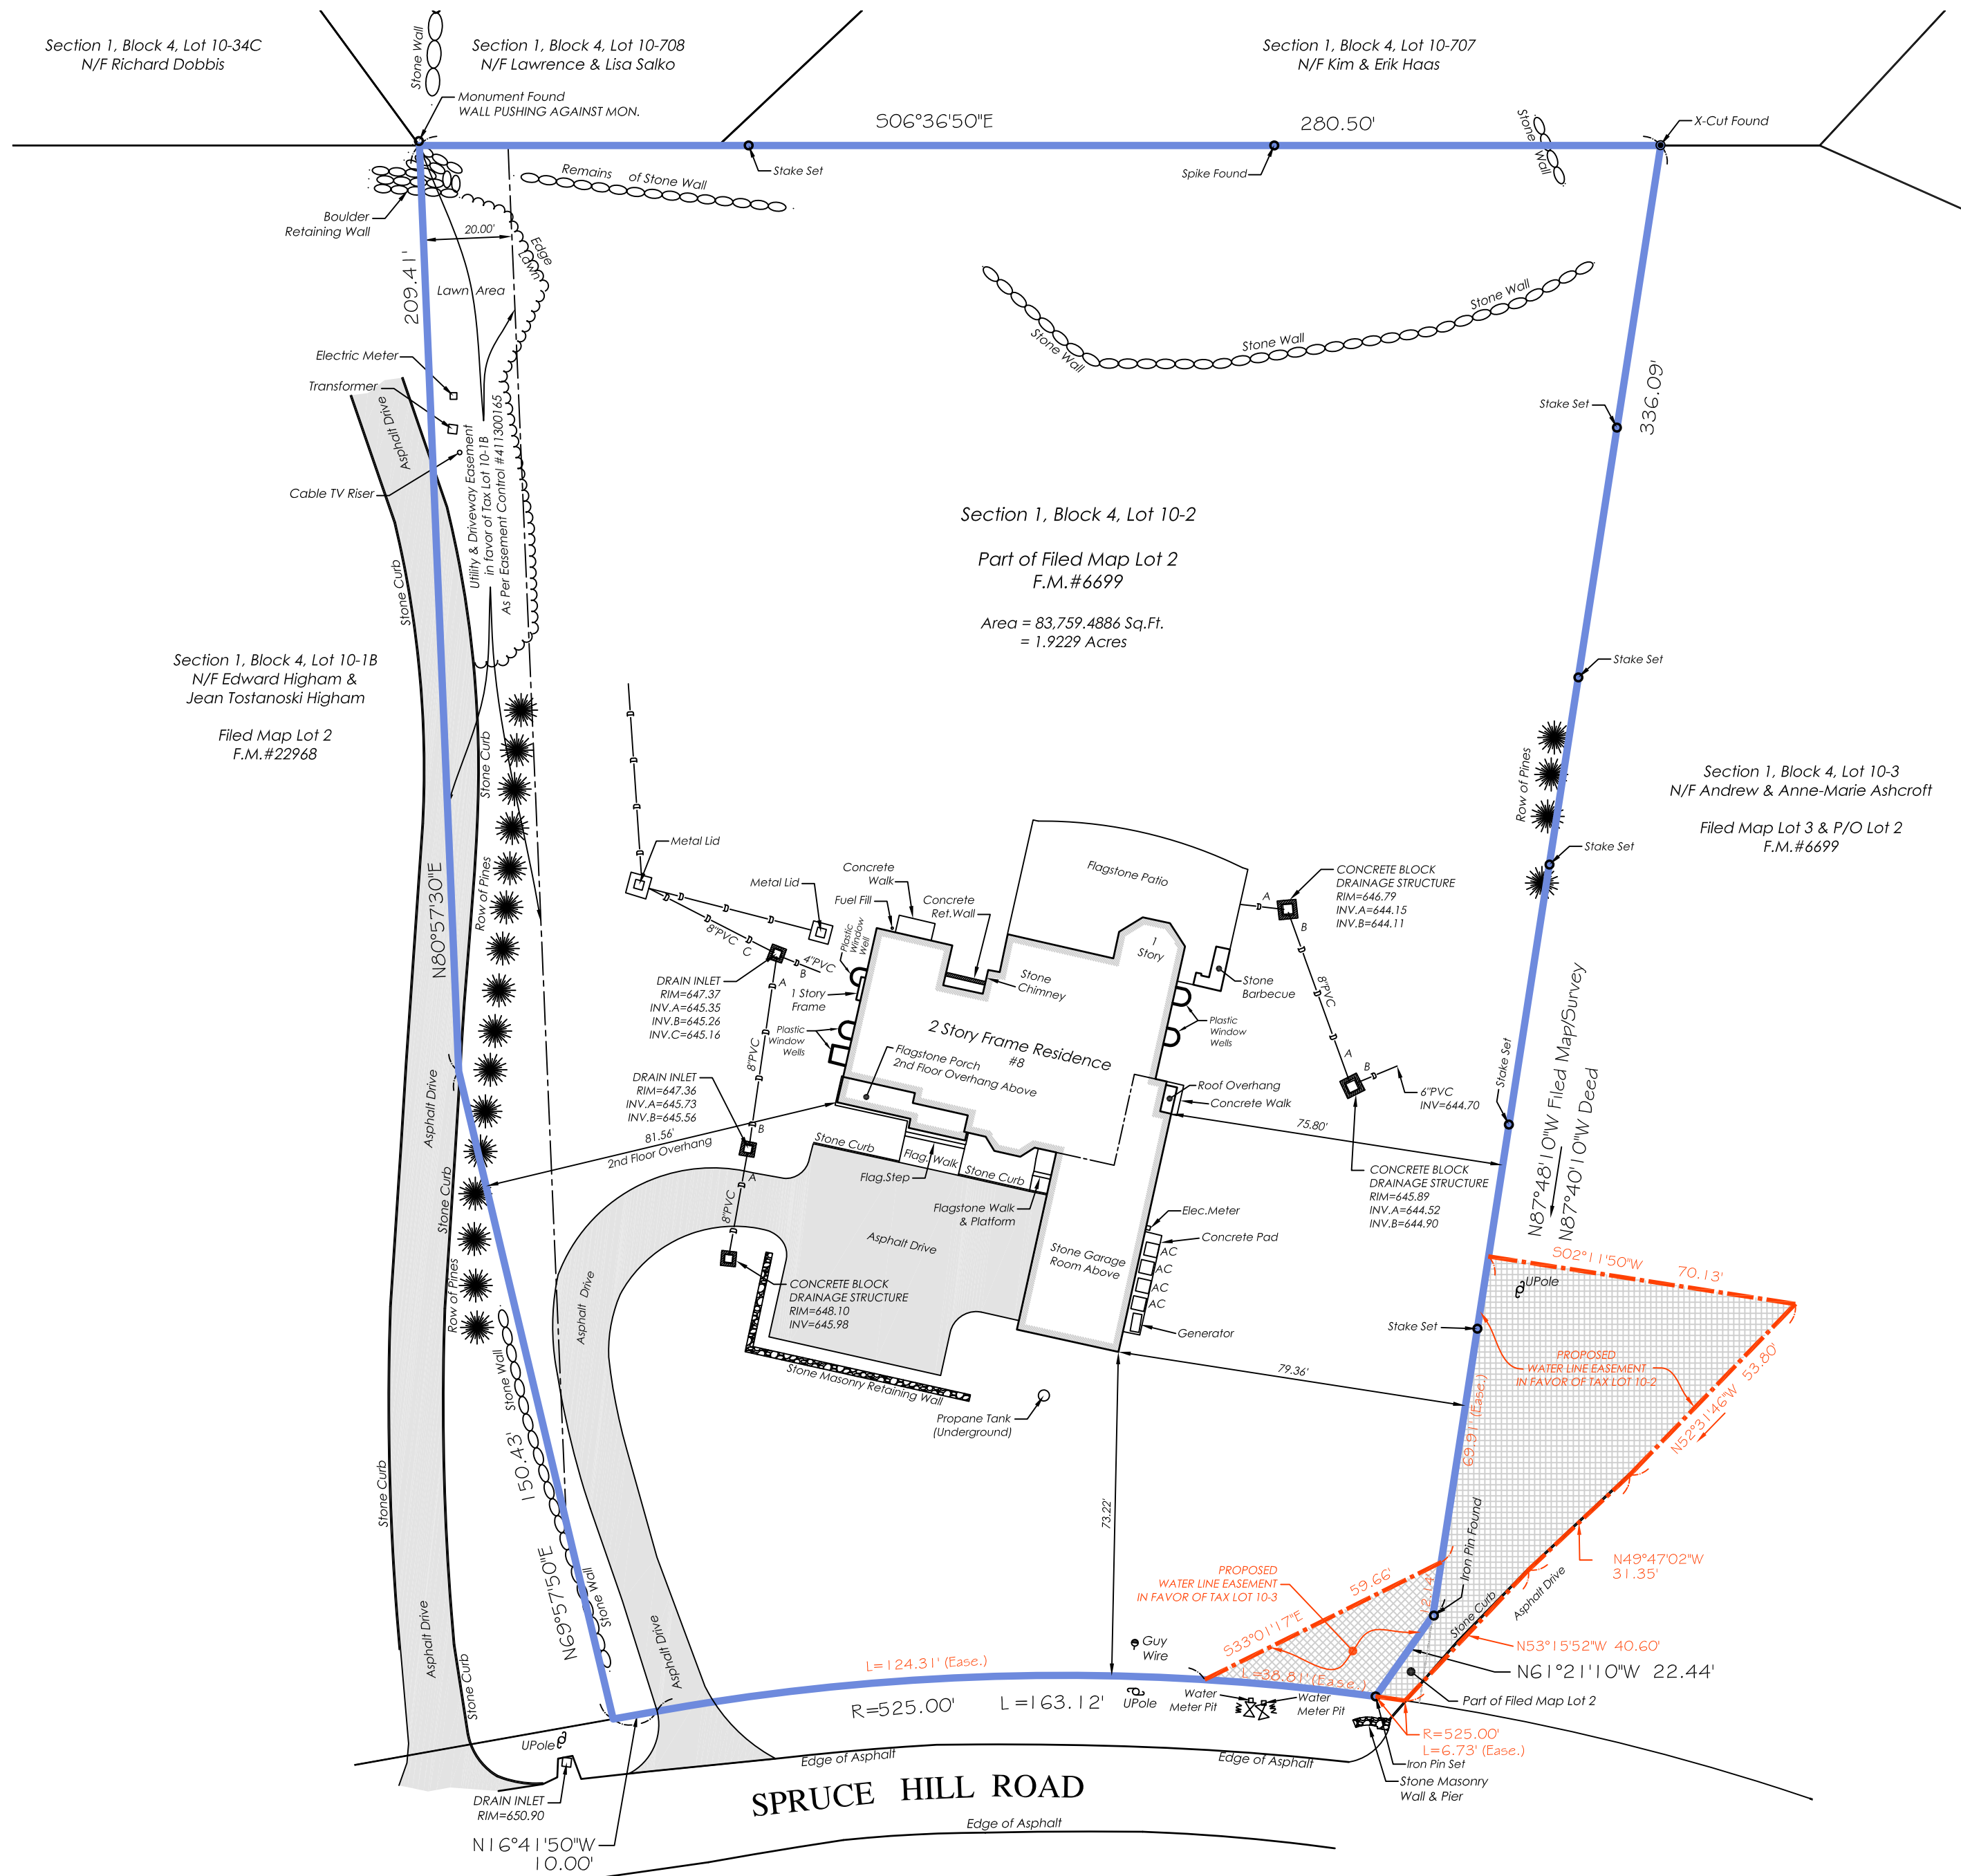

Only copies from the original of this survey marked with an original of the Land Surveyors embossed seal shall be considered to be true, valid copies.

Said certifications shall run only to the person for whom this survey is prepared and on his/her behalf to the title company, governmental agency and lending institutions listed hereon. Certifications are not transferable to additional institutions or subsequent owners.

Unauthorized alteration or addition to a survey map bearing a licensed Land Surveyors seal is a violation of Section 7209, Subdivision 2 of the New York State Education Law.

Possession only where indicated.

Adjacent property lines and easements not surveyed or certified. Access to adjacent rights of way, easements and public or private lands not guaranteed or certified.

Underground utilities shown hereon are approximate and should be verified before excavating. Additional underground utilities are not shown or certified. Encroachments and structures below grade, if any, not shown or certified.

Subject to covenants, easements, restrictions, conditions and agreements of record.

Premises hereon being part of Lot 2 as shown on a certain map entitled, "Subdivision Map, Windmill Farm - Section A-1." Said map filed in the Westchester County Clerk's Office, Division of Land Records November 9, 1948 as map number 6699.

Premises hereon designated on the Town of North Castle Tax Maps as: Section 1, Block 4, Lot 10-2.

**PROPOSED EASEMENT MAP
PREPARED FOR
SAMUEL KIRSCHNER
AND
CATHY KIRSCHNER
SITUATE IN THE
TOWN OF NORTH CASTLE
WESTCHESTER COUNTY, NEW YORK**

SCALE: 1" = 30'

GRAPHIC SCALE



(IN FEET)
1 inch = 30 ft.

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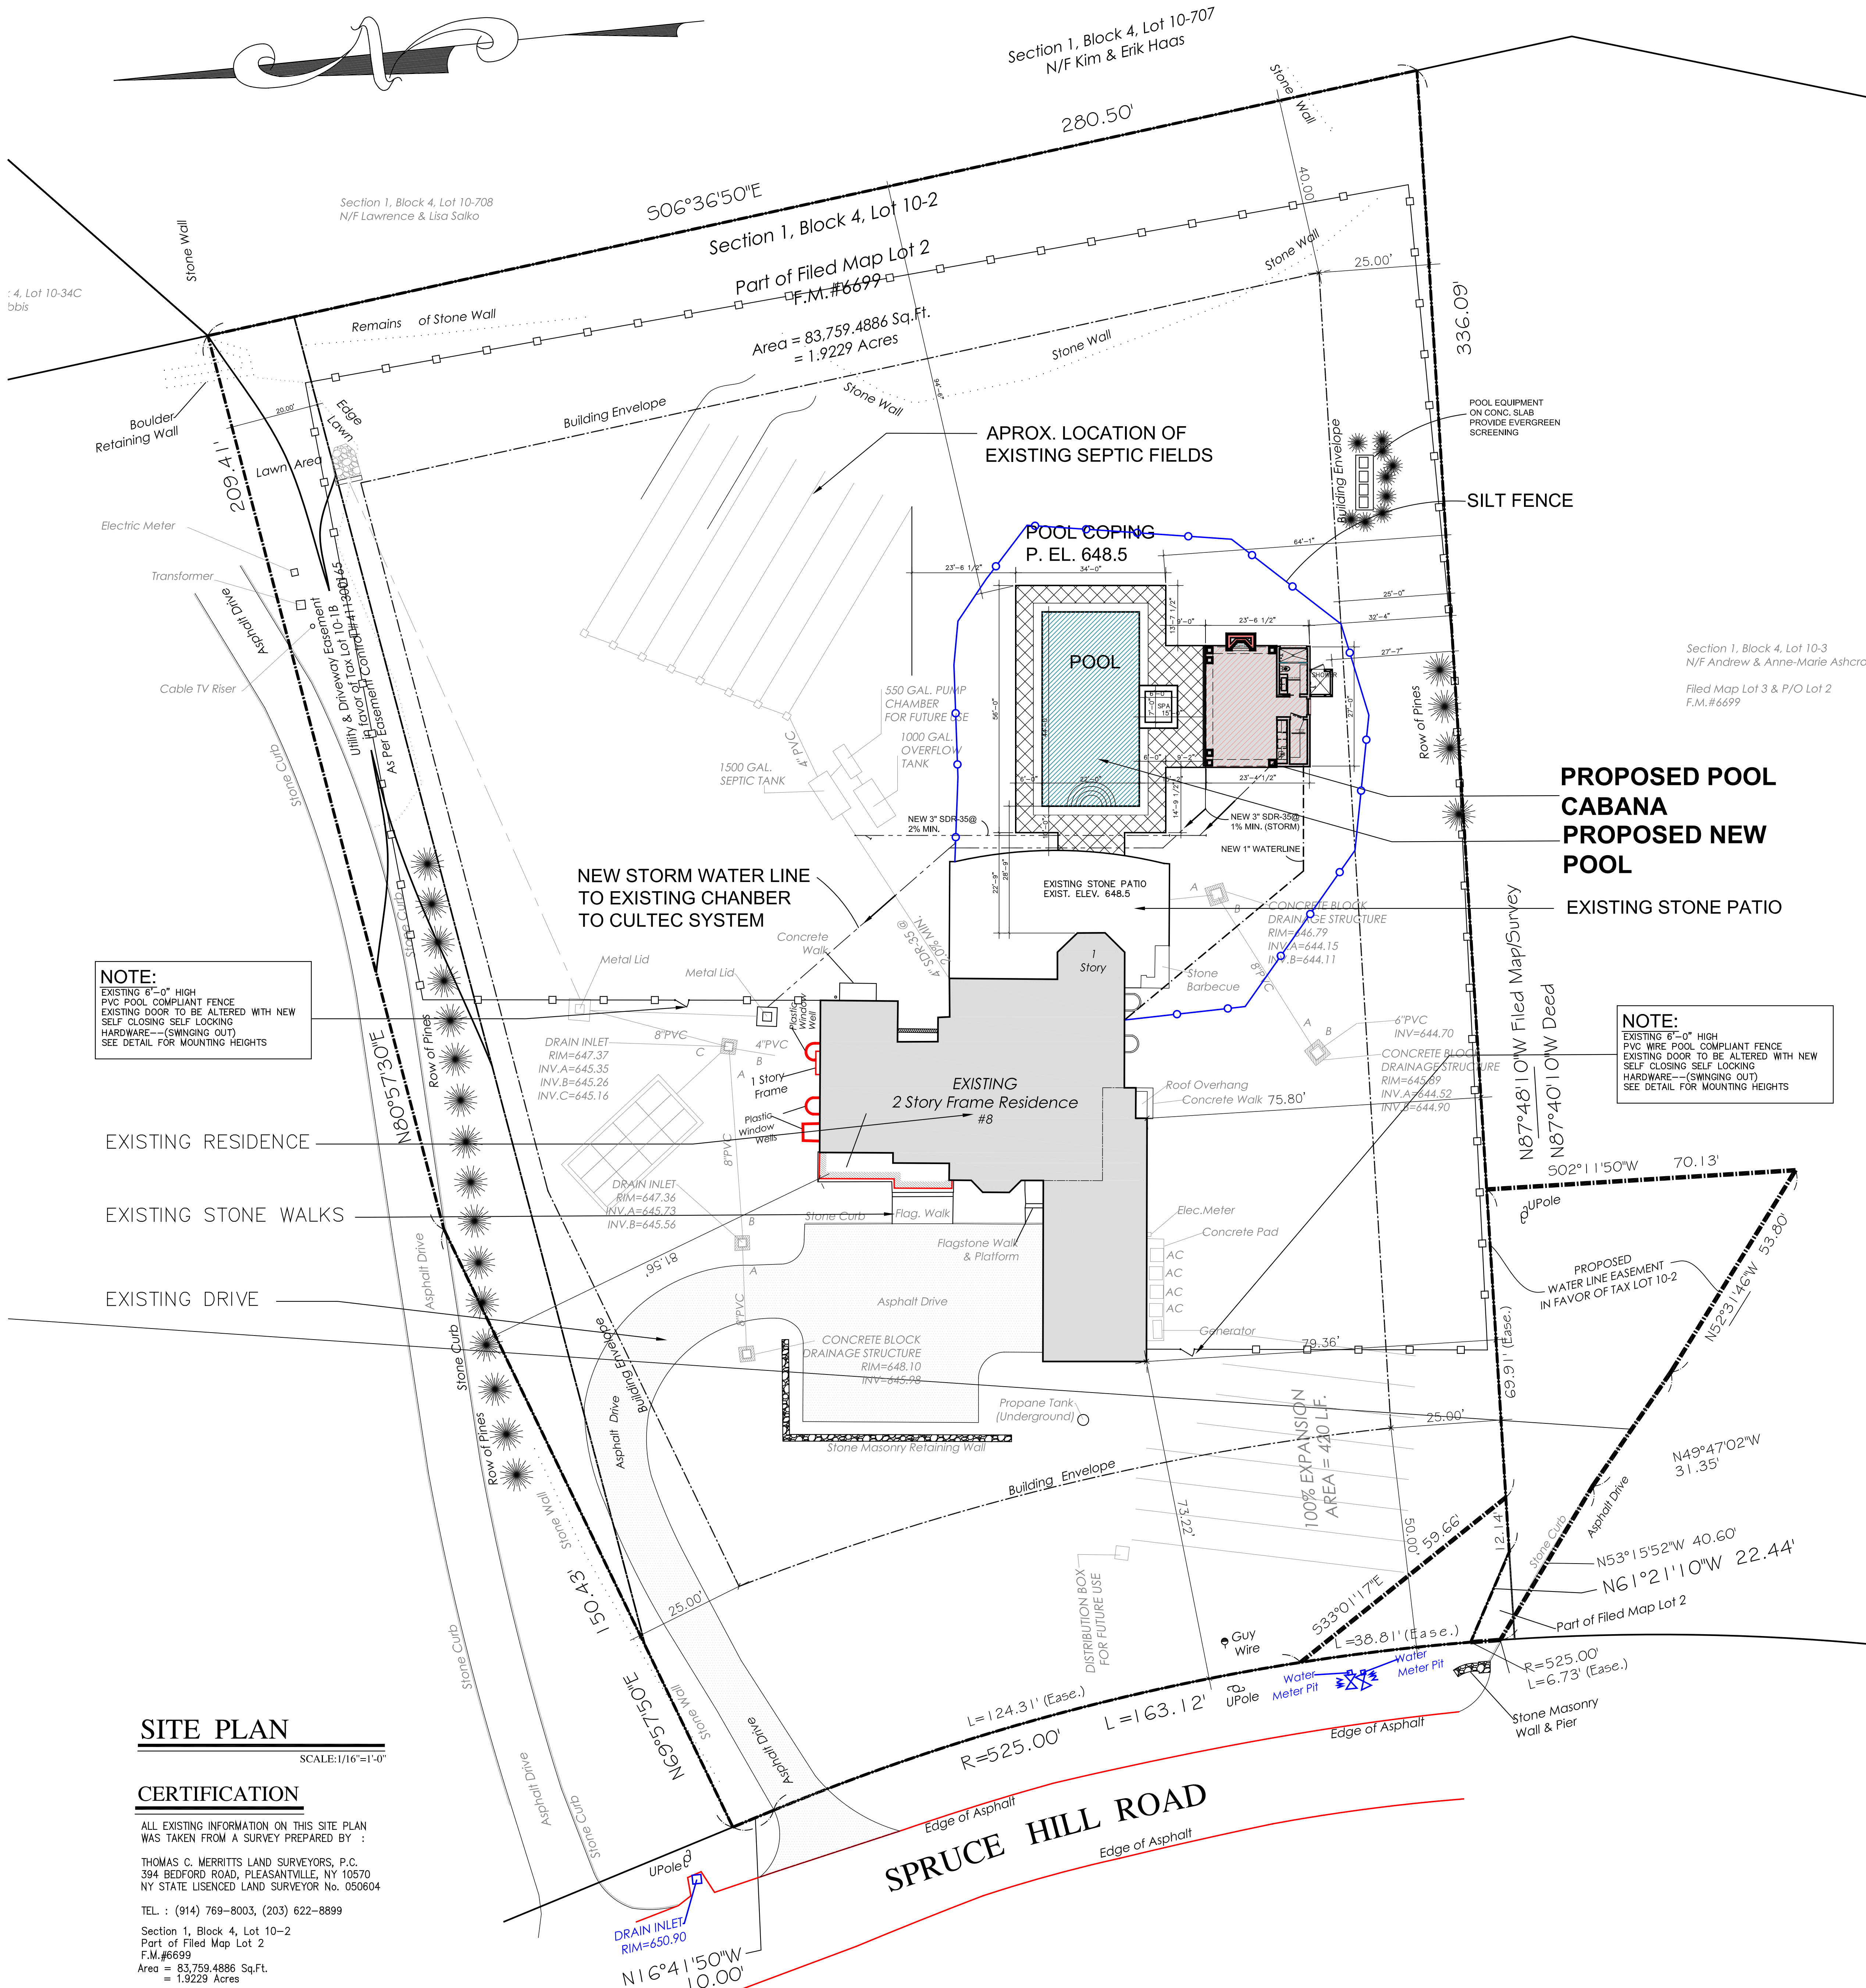
THOMAS C. MERRITTS LAND SURVEYORS, P.C.
394 BEDFORD ROAD • PLEASANTVILLE • N.Y.10570
(914) 769-8003 • (203) 622-8899



Surveyed: March 19, 2010
Map Prepared: March 22, 2010
Map Revised: September 5, 2012 to show final as built
Map Revised: October 28, 2015

By: *Daniel T. Merritt*
New York State Licensed Land Surveyor No. 050604


Project: Ref.10-026 10-040	Field Survey By: BC/AN
Drawn By: DA	Checked By: DM



LIST OF DRAWINGS

No.	DRAWING NAME
SP1	SITE PLAN/ SCHEDULES
SP2	SITE DETAILS
S	SURVEY
GN	GENERAL NOTES SHEET
A1	FLOOR PLANS
A2	ELEVATIONS
A3	SECTION
P1	POOL PLAN AND DETAILS
S1-E1	FRAMING PLANS/ LIGHTING PLAN

LOCATION MAP NOT TO SCALE

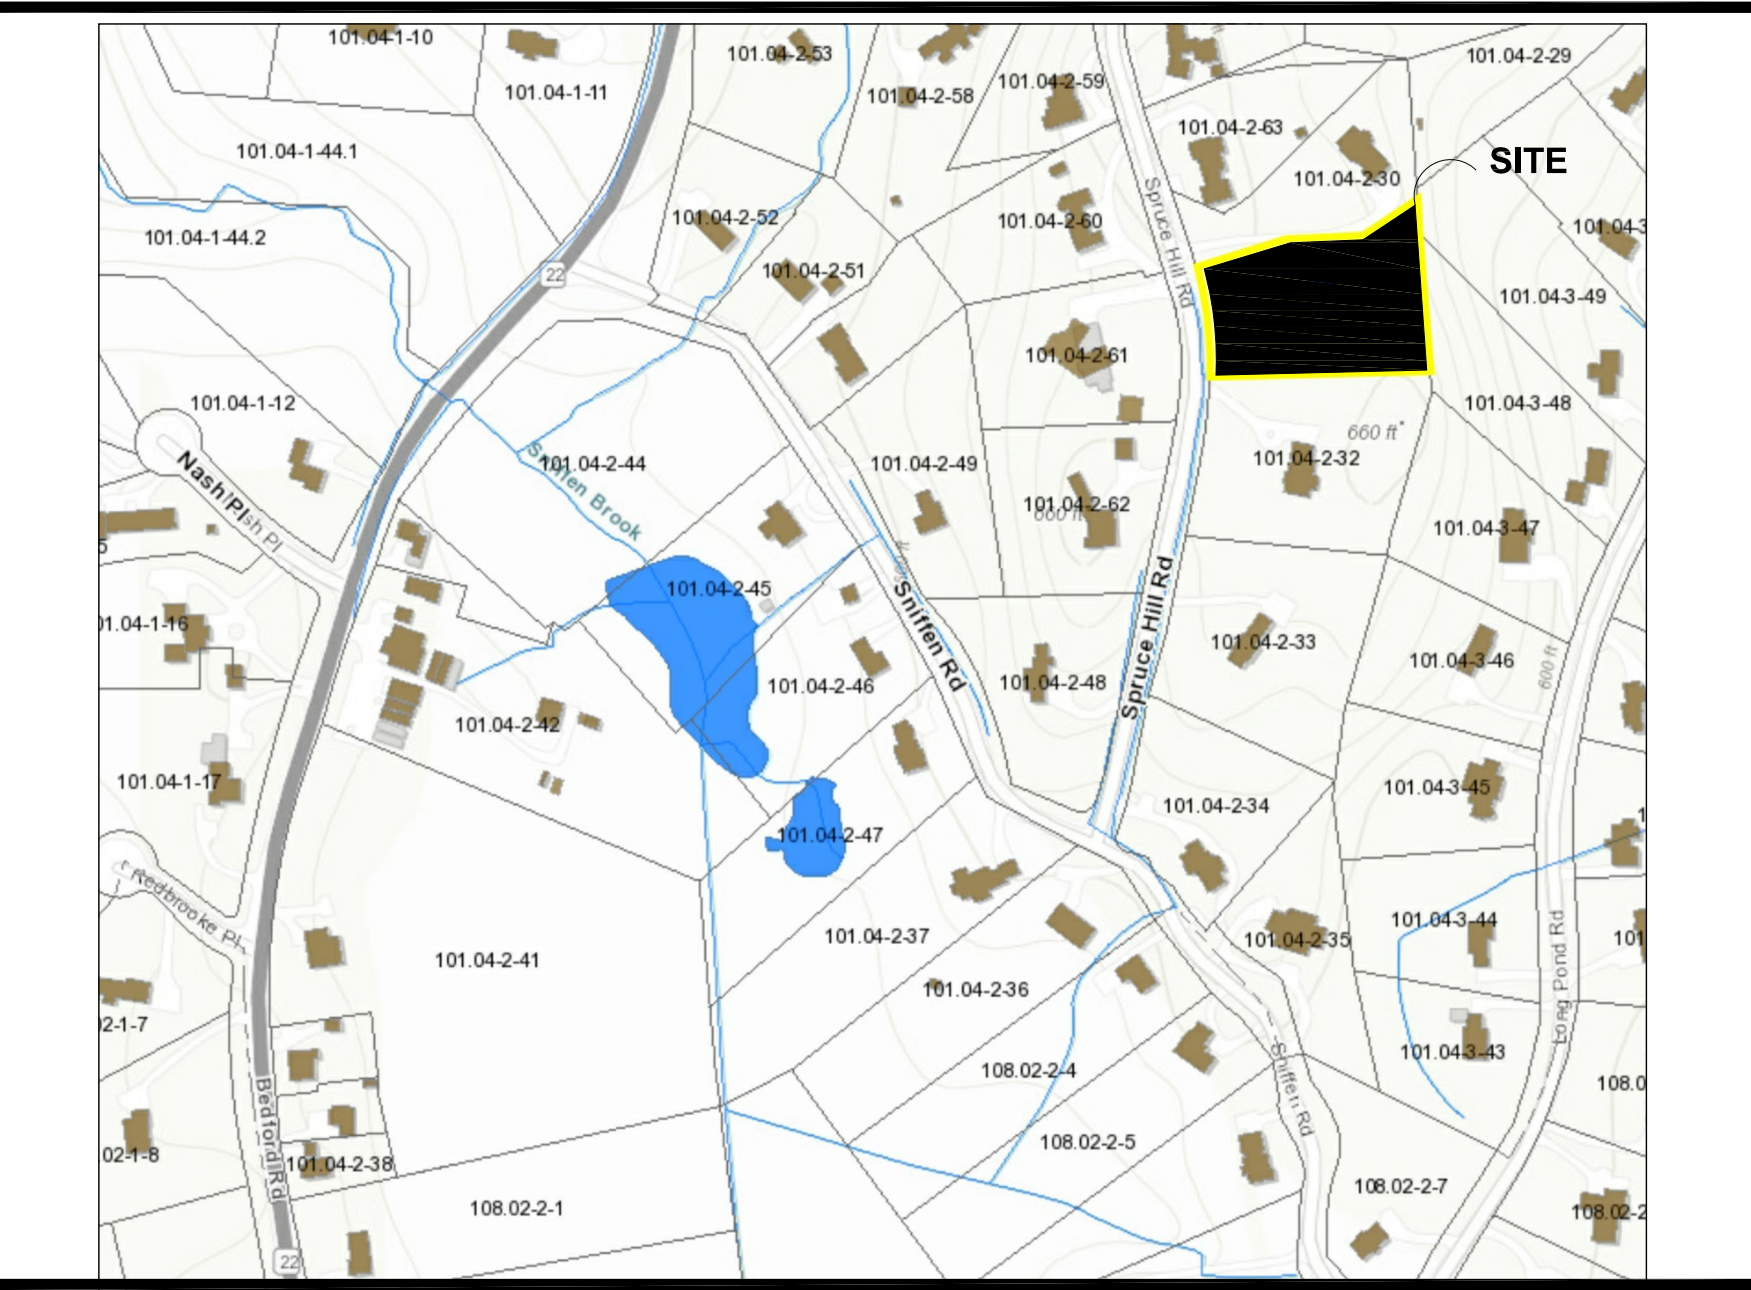

ZONING SCHEDULE TOWN OF ARMONK, NY

ZONE / USE : R 1A			
ITEM	REQUIRED	EXISTING HOUSE	PROPOSED CABANA
MINIMUM LOT SIZE (SQ. FT.)	1 ACR.	1.9229 ACR.	1.9229 ACR.
	36,000.00 Sq. Ft.	83,759.4886 Sq.Ft.	83,759.4886 Sq.Ft.
MINIMUM LOT WIDTH (FEET)	125'	163'	NA
MINIMUM FRONT YARD (FEET)	50'	73.5'	NA
MINIMUM EACH SIDE YARD (FEET)	20'	74'/82"	31' 2-1/2"
MINIMUM 2 SIDE YARDS (FEET)	25'	156'	NA
MINIMUM REAR YARD (FEET)	40'	174.3'	87' 11-1/2"
MAXIMUM HEIGHT (FEET)	30'	29.25'	14' 9-5/8"

SITE PLAN

SCALE: 1/16" = 1'-0"

CERTIFICATION

ALL EXISTING INFORMATION ON THIS SITE PLAN WAS TAKEN FROM A SURVEY PREPARED BY :

THOMAS C. MERRITTS LAND SURVEYORS, P.C.
394 BEDFORD ROAD, PLEASANTVILLE, NY 10570
NY STATE LICENCED LAND SURVEYOR No. 050604
TEL. : (914) 789-8003, (203) 622-8899

Section 1, Block 4, Lot 10-2
Part of Filed Map Lot 2
F.M.#6699
Area = 83,759,4886 Sq.Ft.
= 1.9229 Acres

studio rai

Architectural Design P.C.
290 SALEM RD
POUND RIDGE, NY
TEL 914-273-6843
WWW.STUDIORAID.COM

ARCHITECTS

STRUCTURAL ENGINEERS

landscape architect

FOODSERVICE EQUIPMENT

PROJECT INFORMATION

PROPOSED POOL & CABANA


FDR:
MR. & MRS. KIRSCHNER

8 SPRUCE HILL RD.
ARMONK, NY

No.	Revision	Date	Description
		10-16-20	D.O.B. SUBMISSION

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KEY PLAN





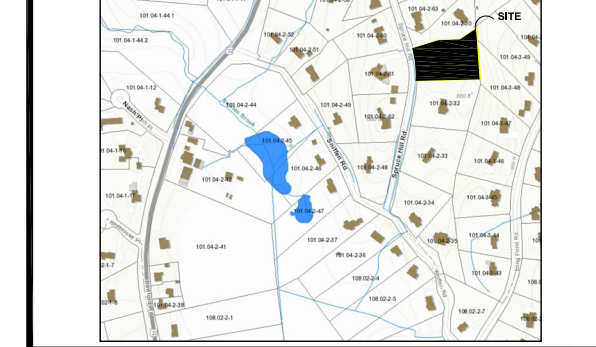


DRAWING TITLE

SP1

DRAWING NUMBER

	ISSUE DATE : 10-16-20 DRAWN BY : T.M. CHECKED BY : L.S. PROJECT NO. : 05077 AS NOTED SCALE: AS NOTED DATE:
	SEAL/SIGNATURE

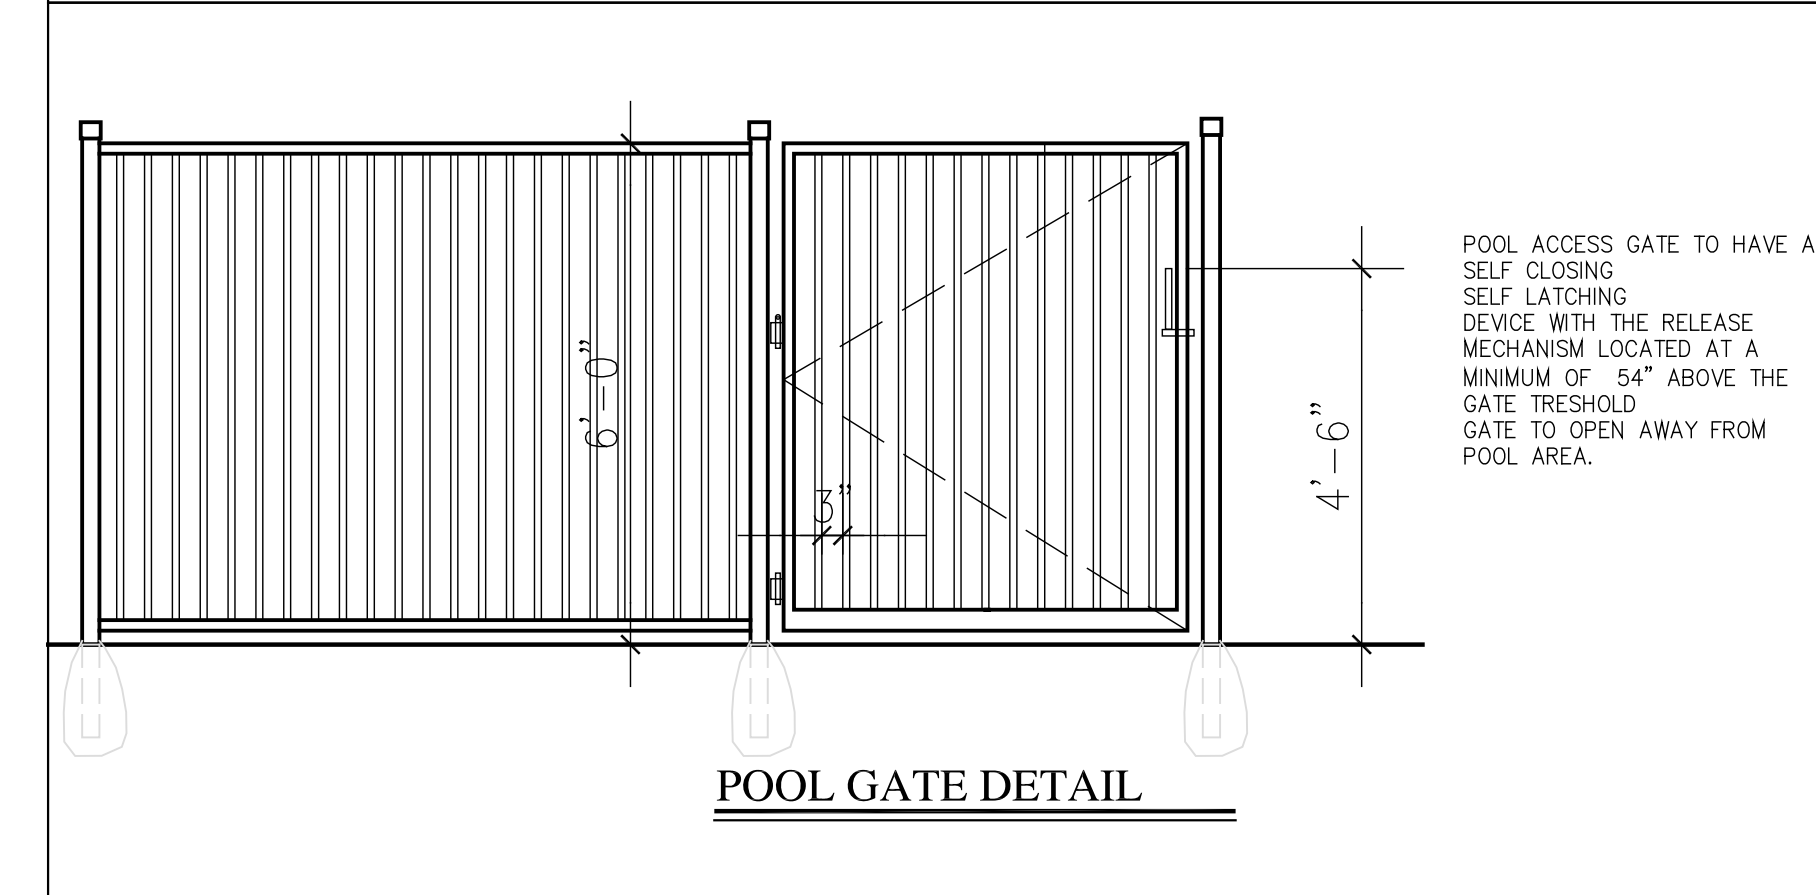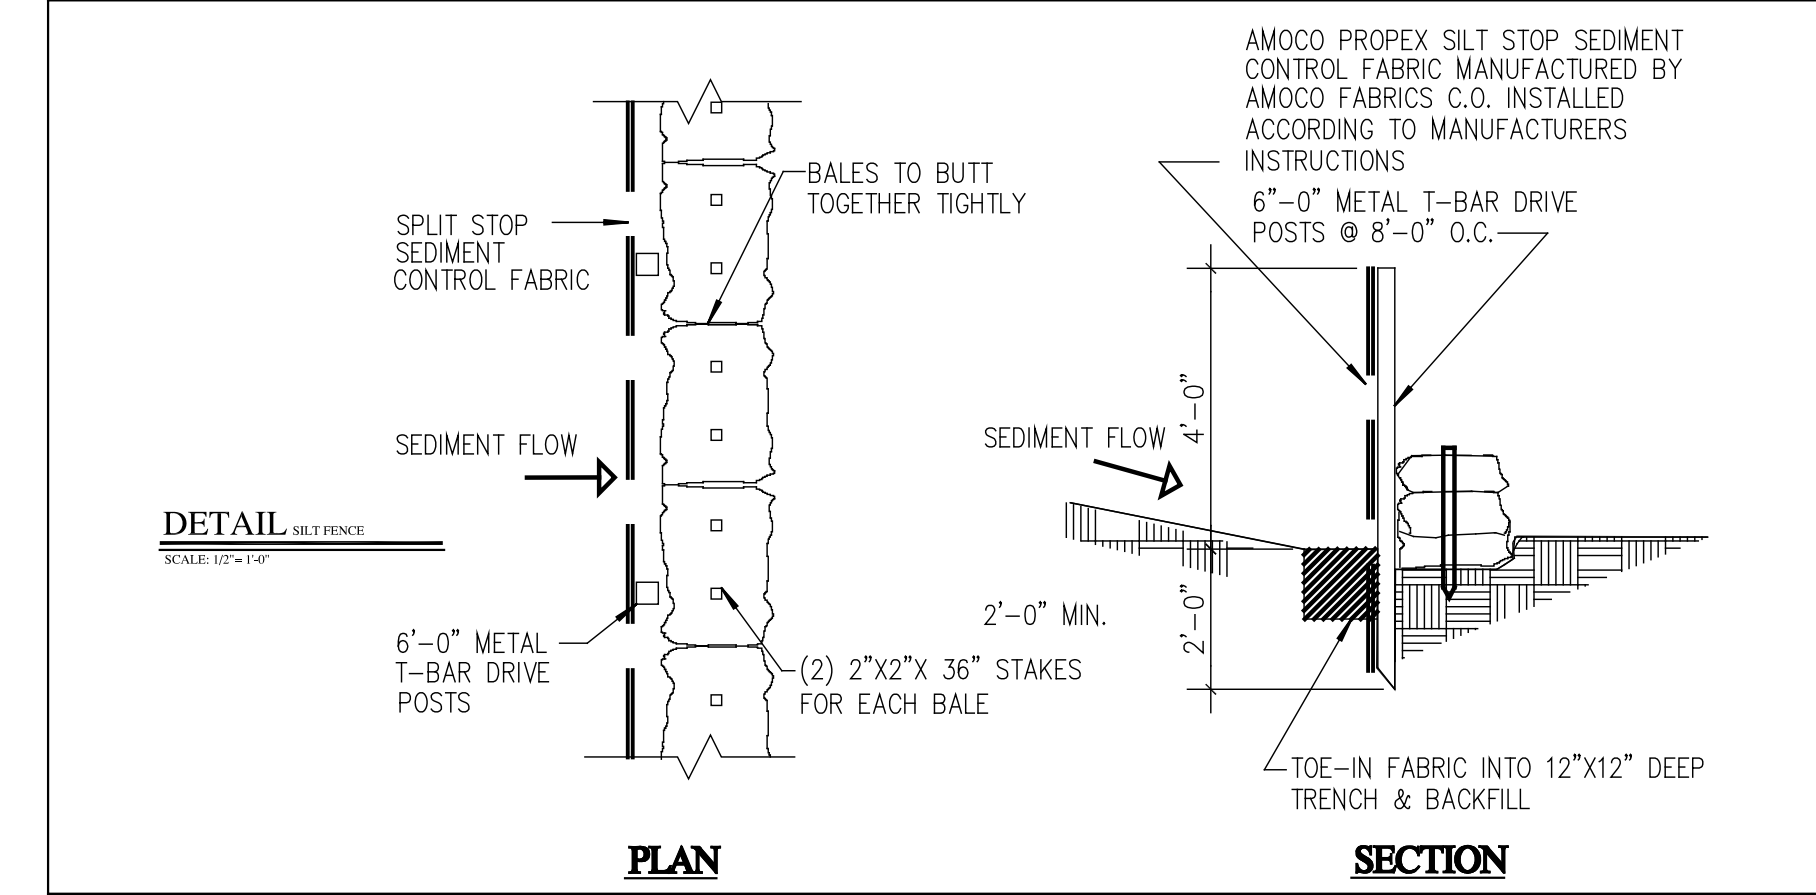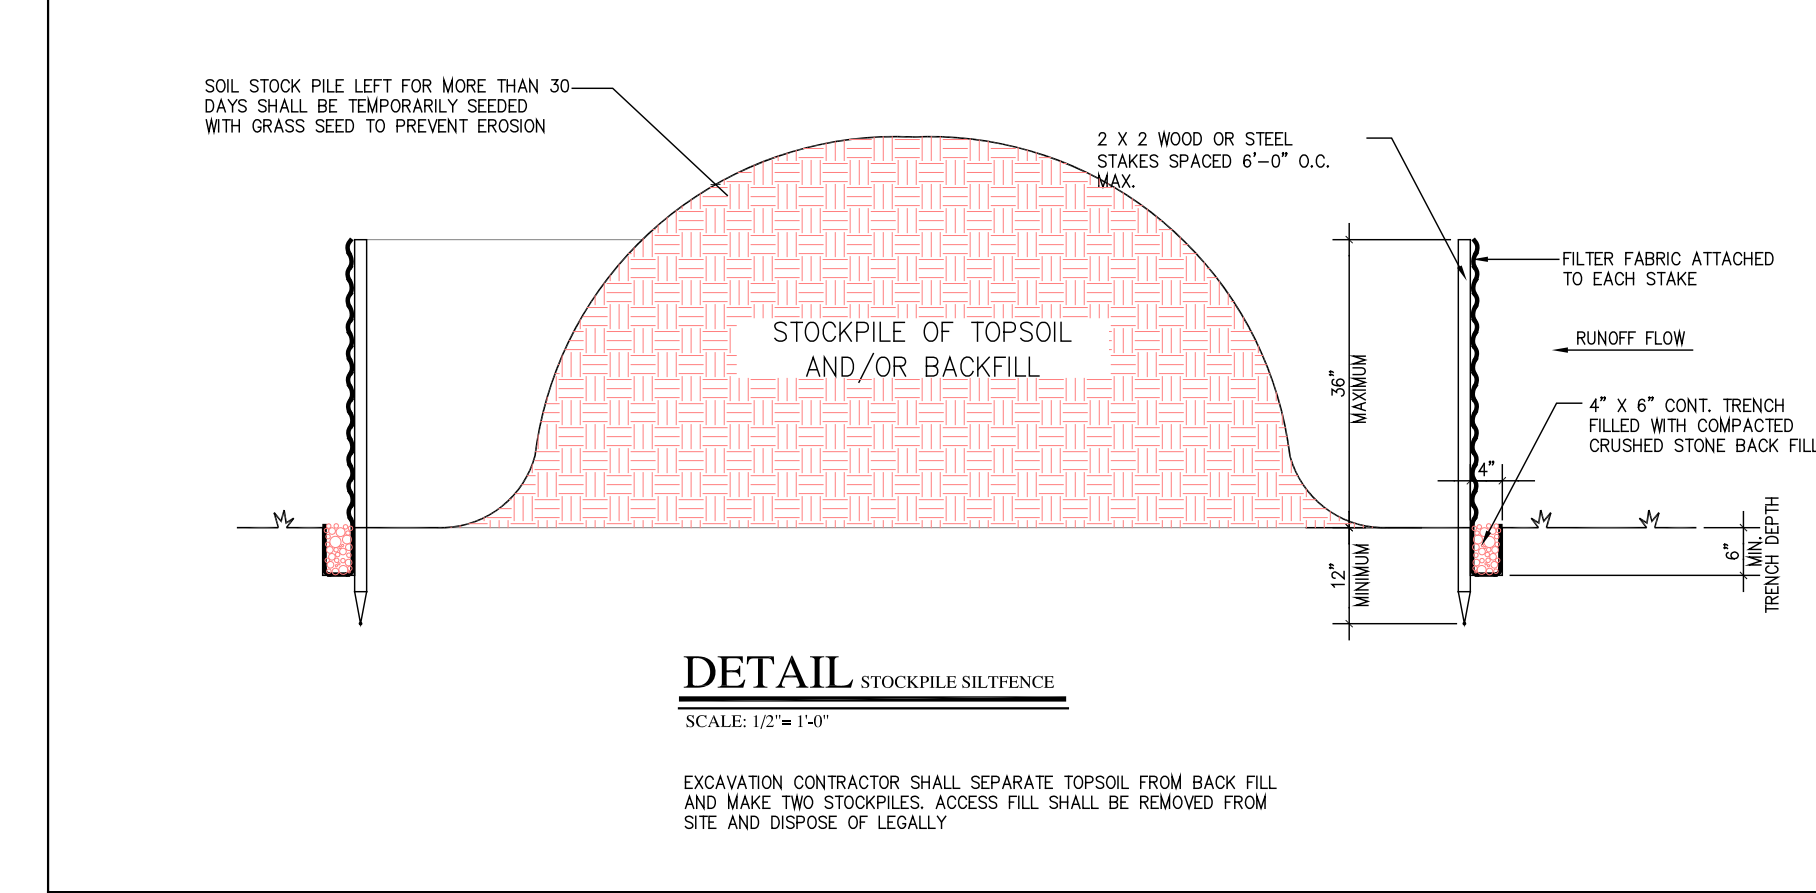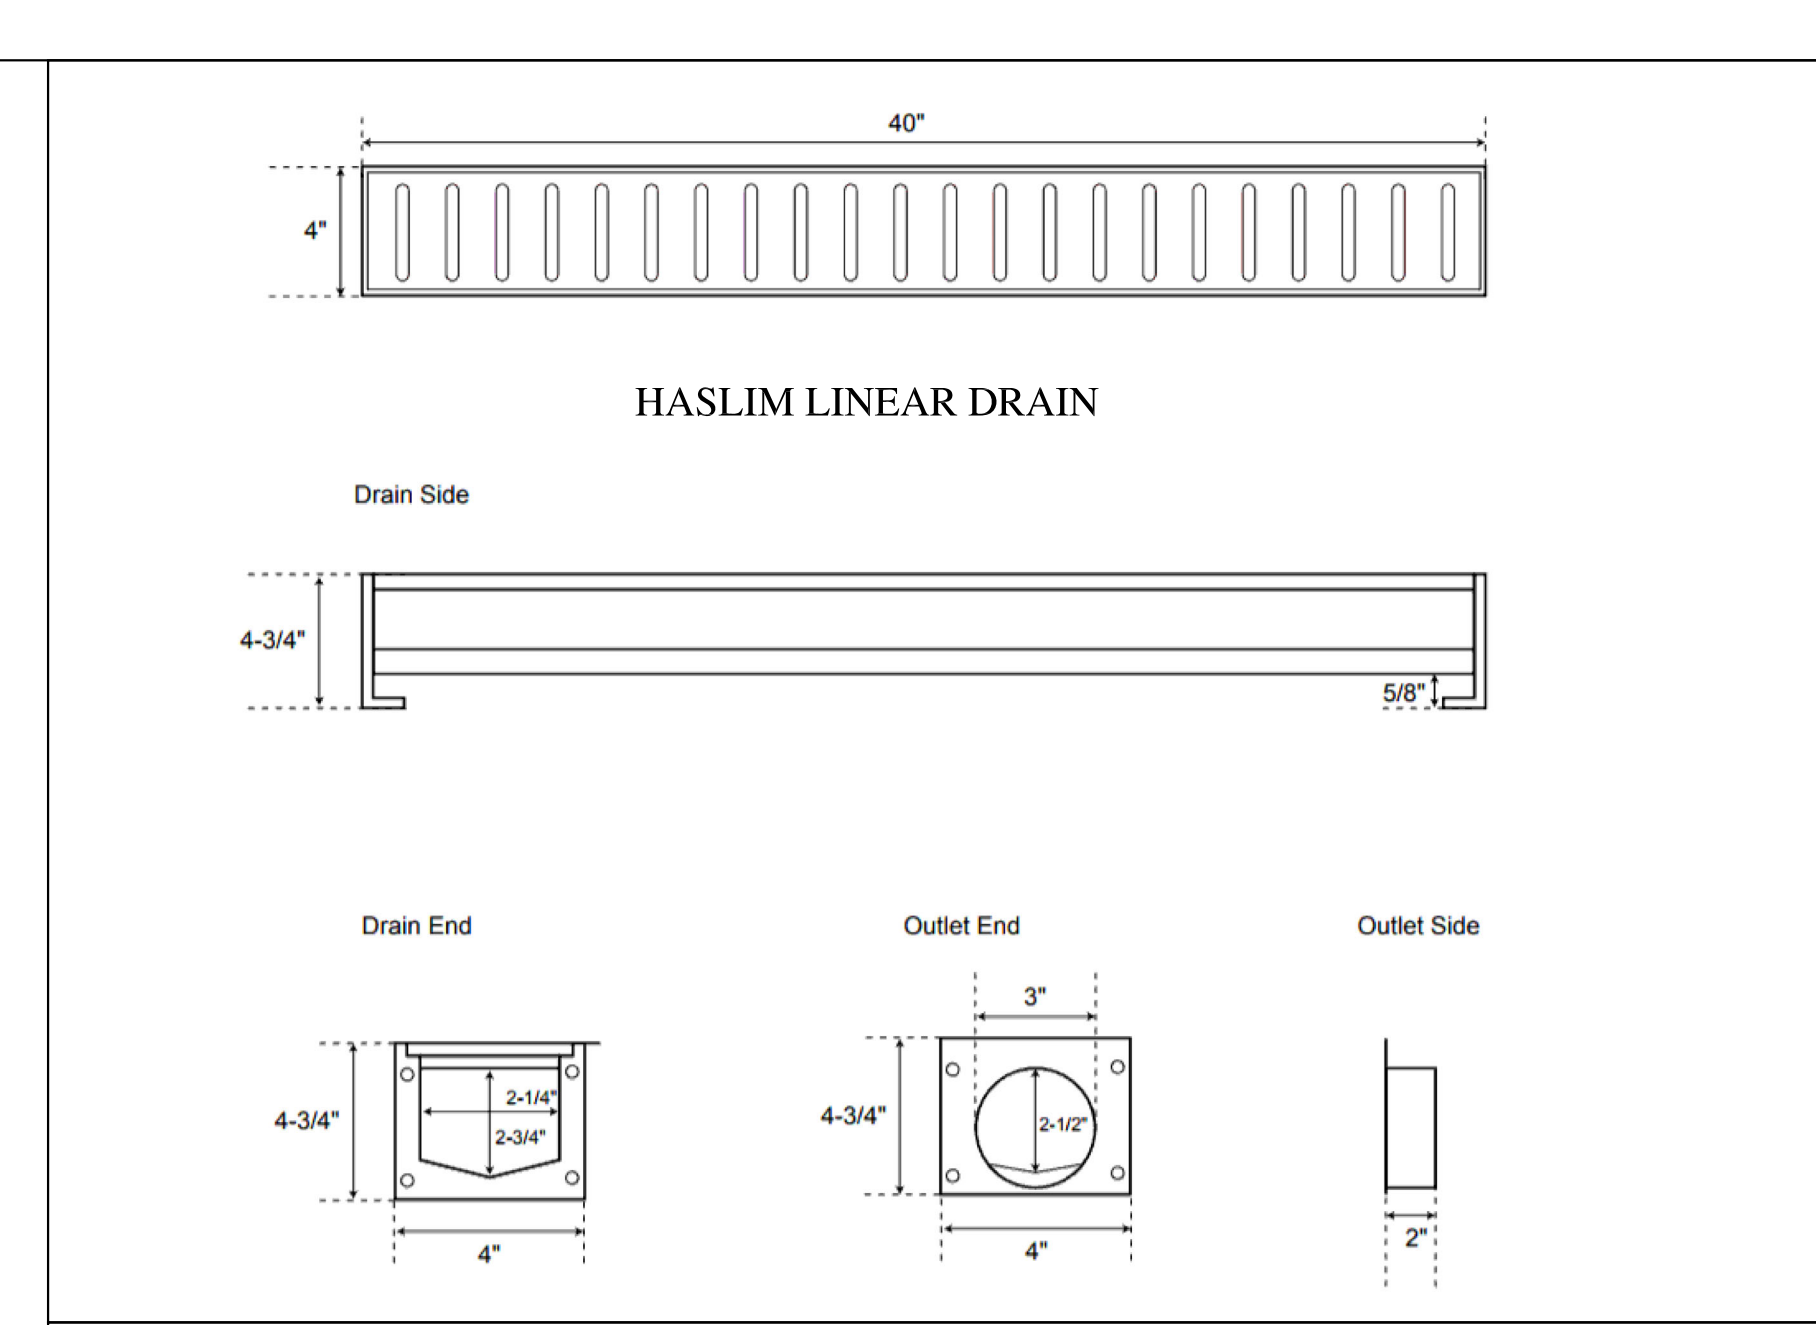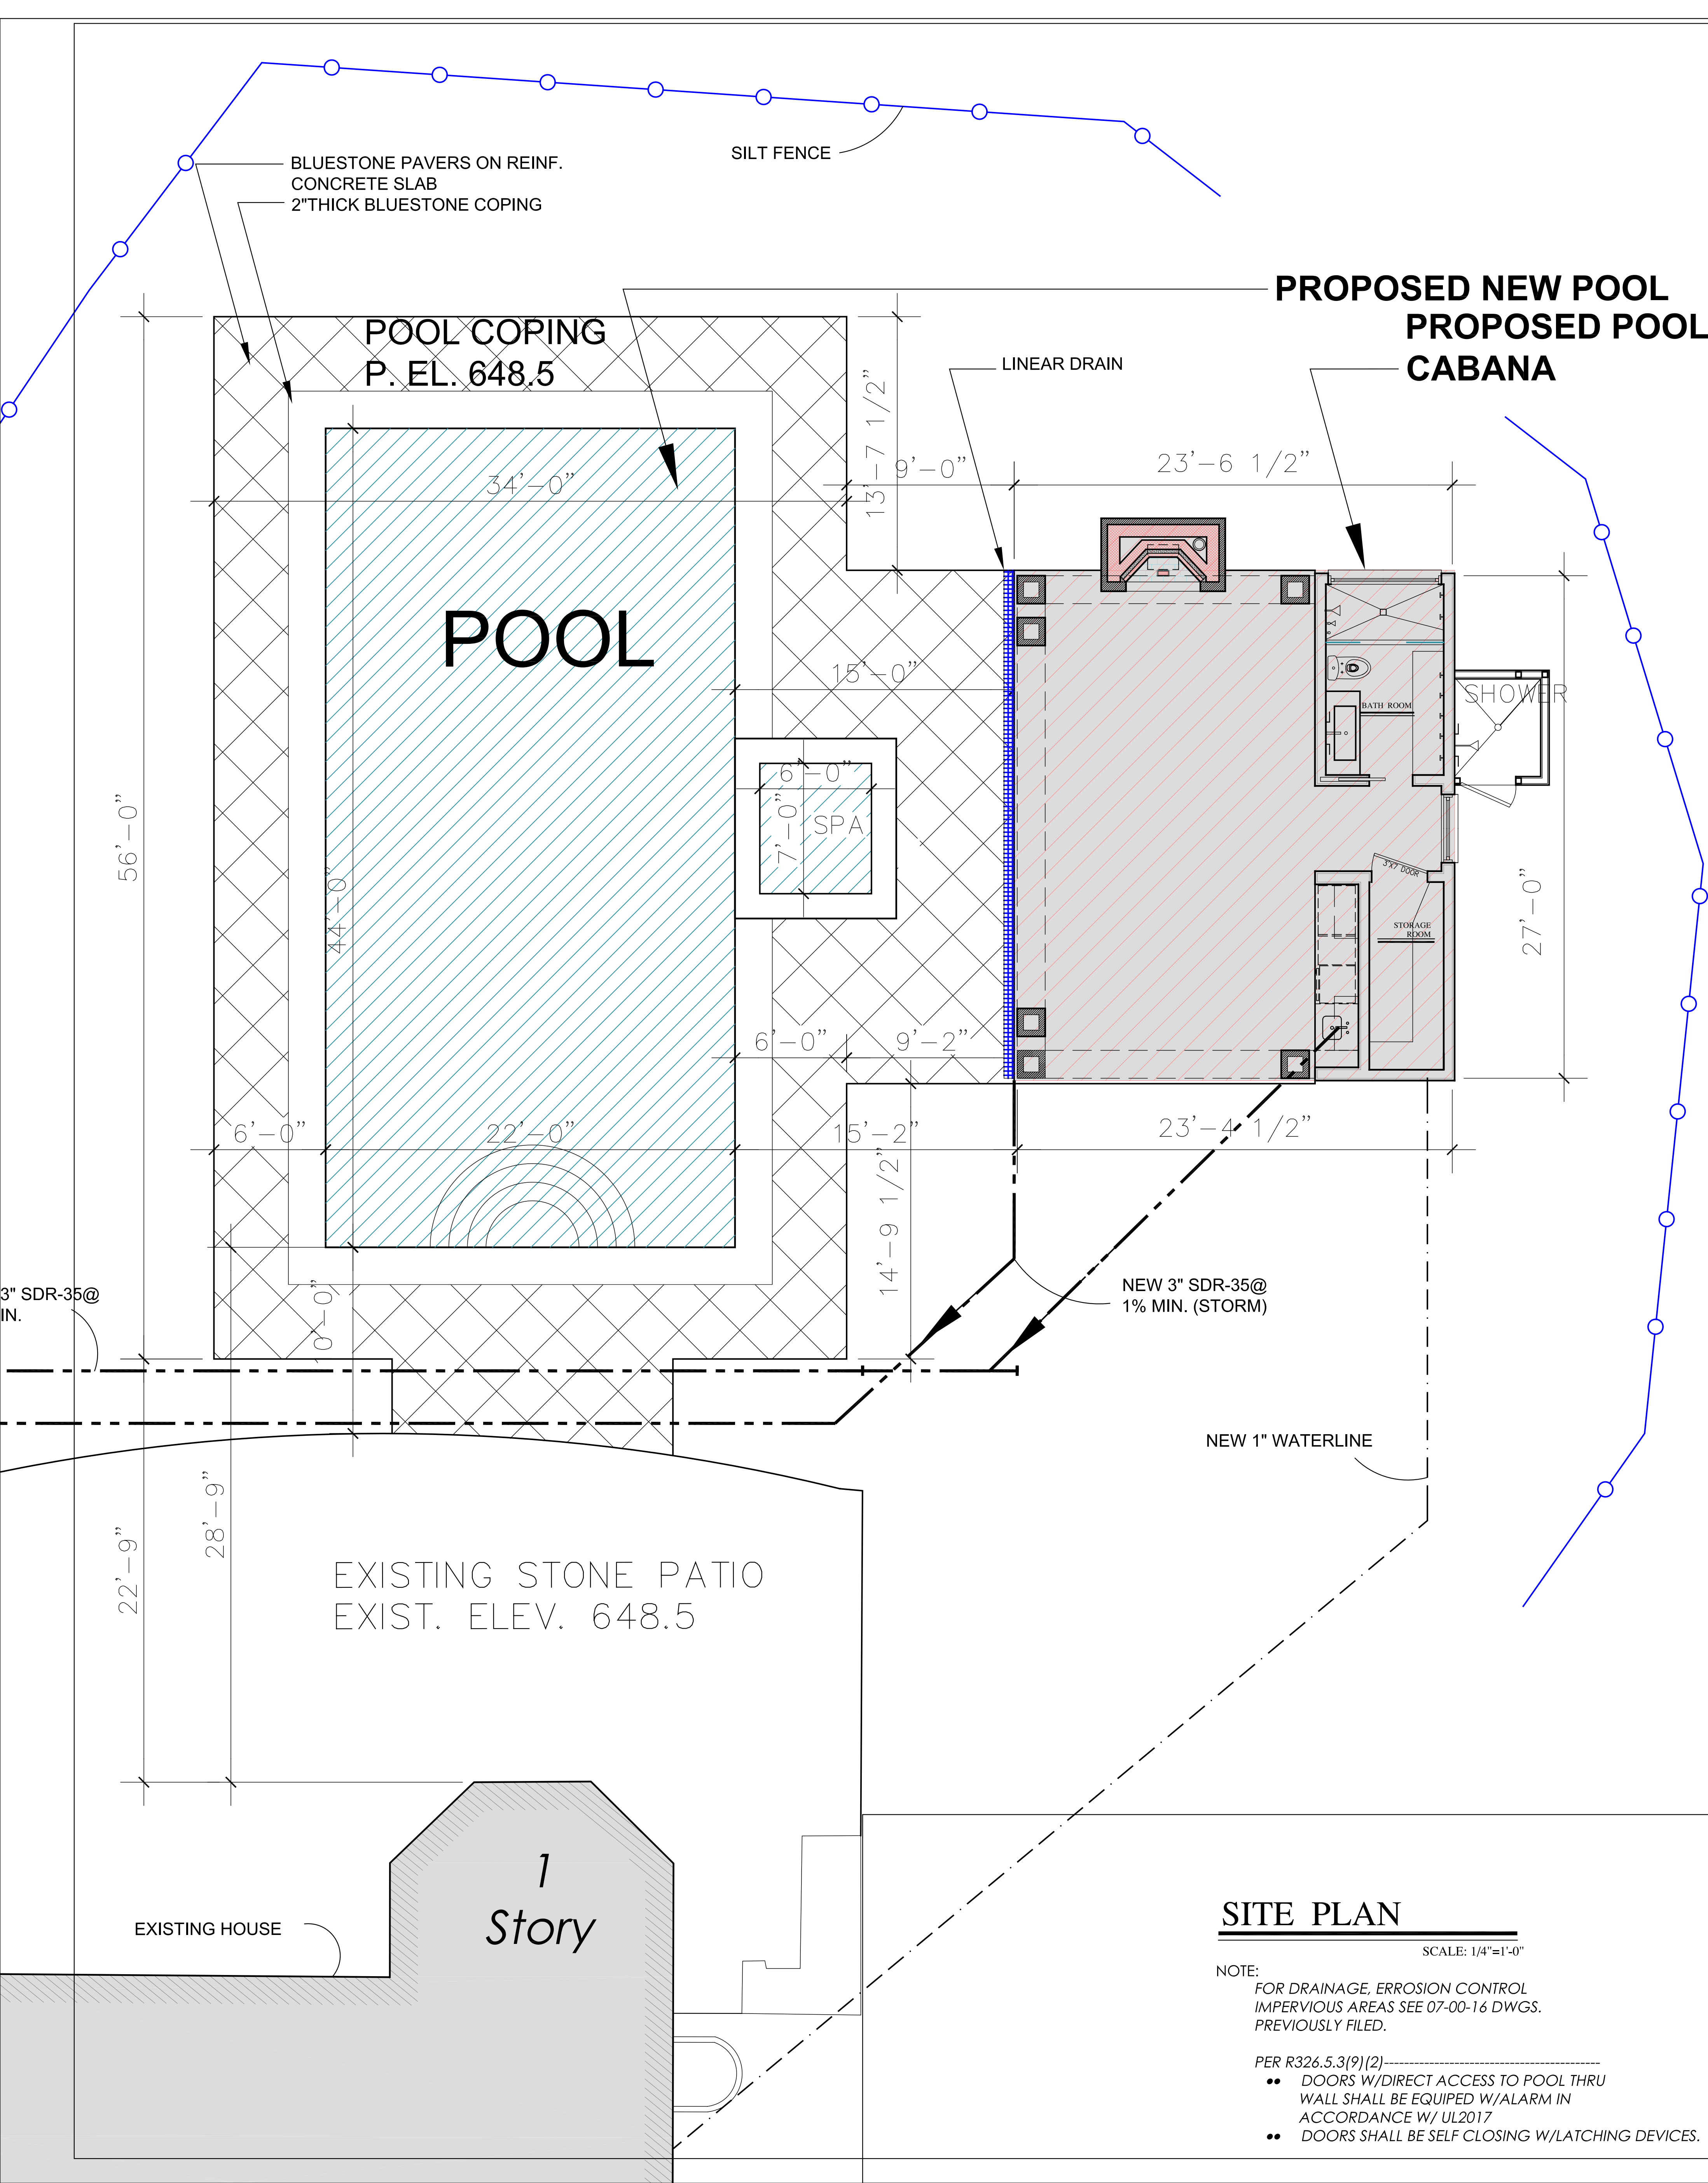

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POUND RIDGE, NY
Tl. 914-273-6843
www.studiorai.com

ARCHITECTS

STRUCTURAL ENGINEERS

landscape architect

FLOODSERVICE EQUIPMENT


PROJECT INFORMATION

PROPOSED POOL & CABANA

FOR:
MR. & MRS. KIRSCHNER
8 SPRUCE HILL RD.
ARMONK, NY

No.	Revision	Date	Description
10-16-20	D.O.B.		SUBMISSION

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DRAWING TITLE

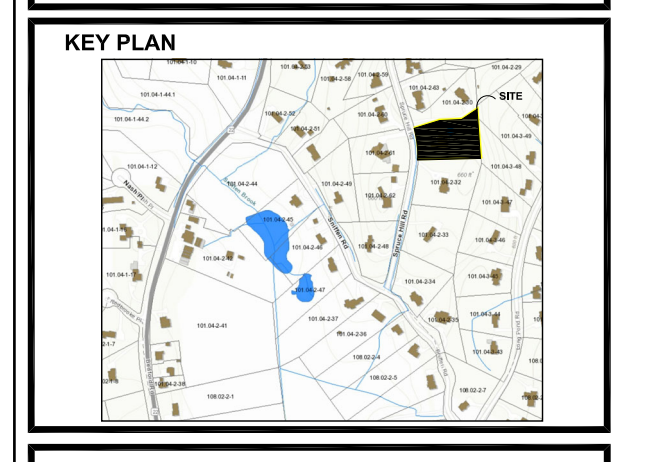SP2

DRAWING NUMBER

REGISTERED ARCHITECT
STATE OF NEW YORK

DATE: 10-16-20
BY: [Signature]
PROJECT NO: [Number]
SCALE: 1/4"=1'-0"
AS NOTED


SEAL/SIGNATURE

PROPOSED POOL & CABANA

FOR:
 MR. & MRS. KIRSCHNER
 8 SPRUCE HILL RD.
 ARMONK, NY

No.	Revision	Date	Description
		10-16-20	D.O.B. SUBMISSION

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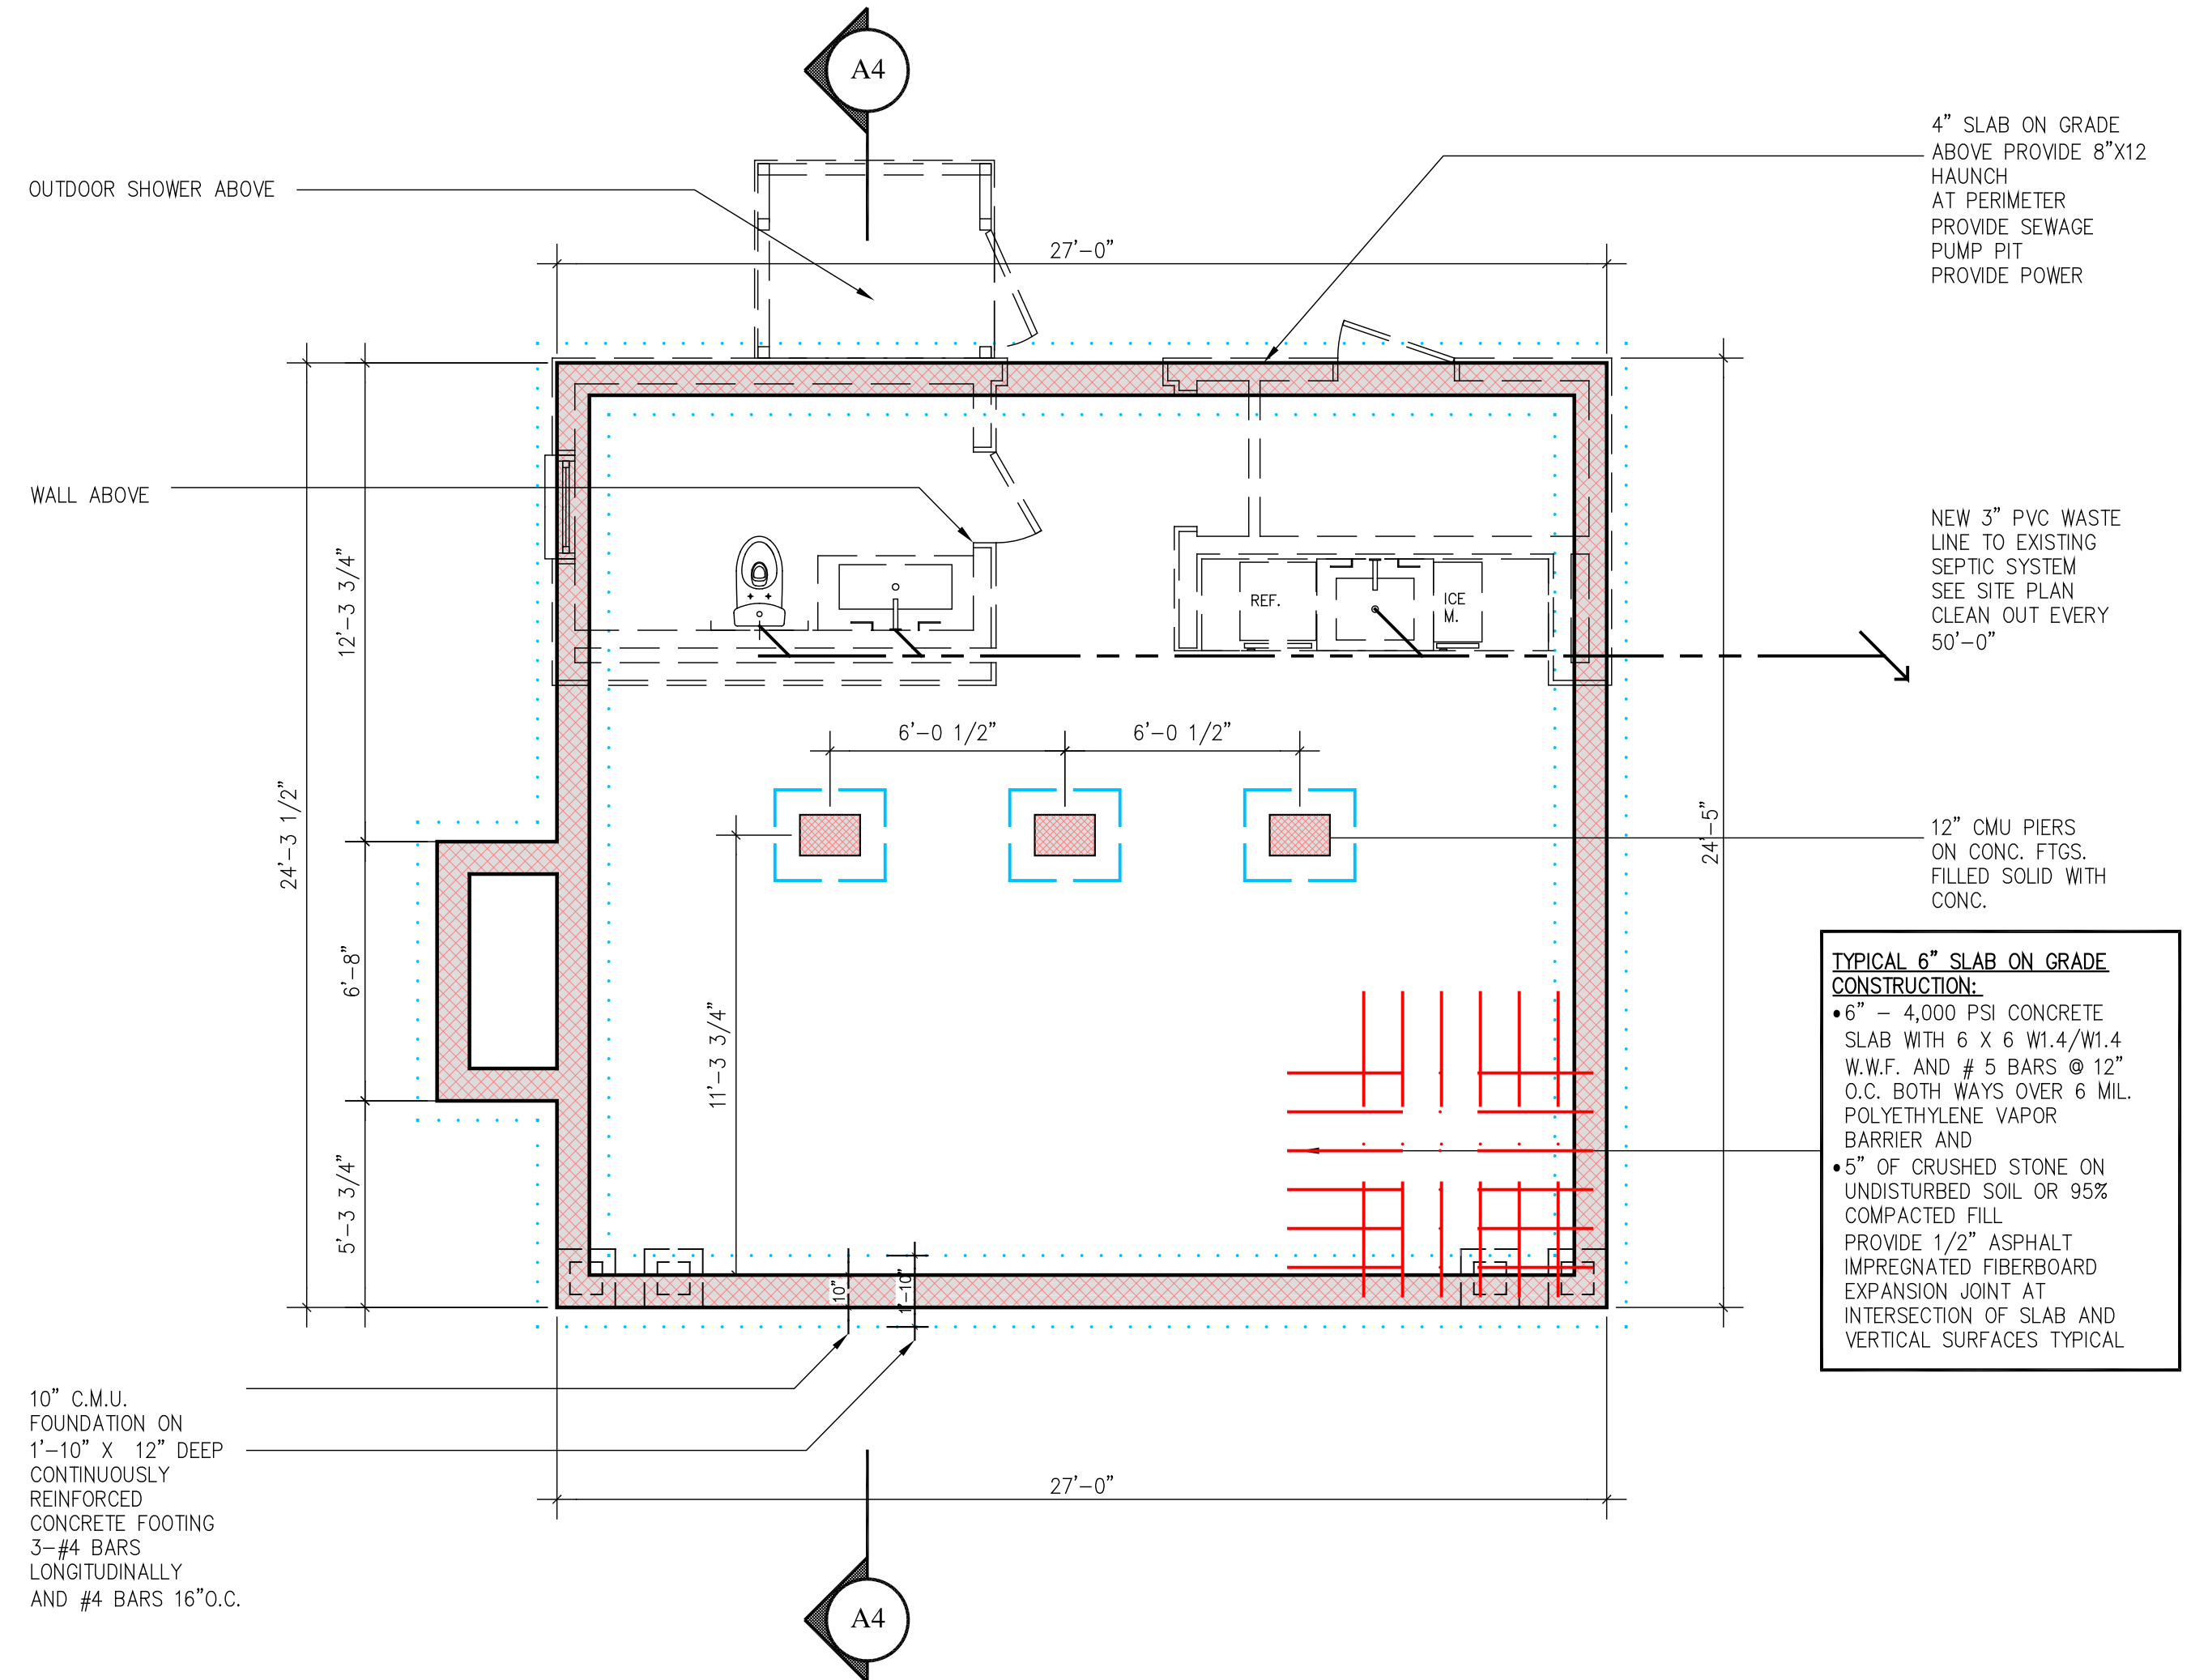
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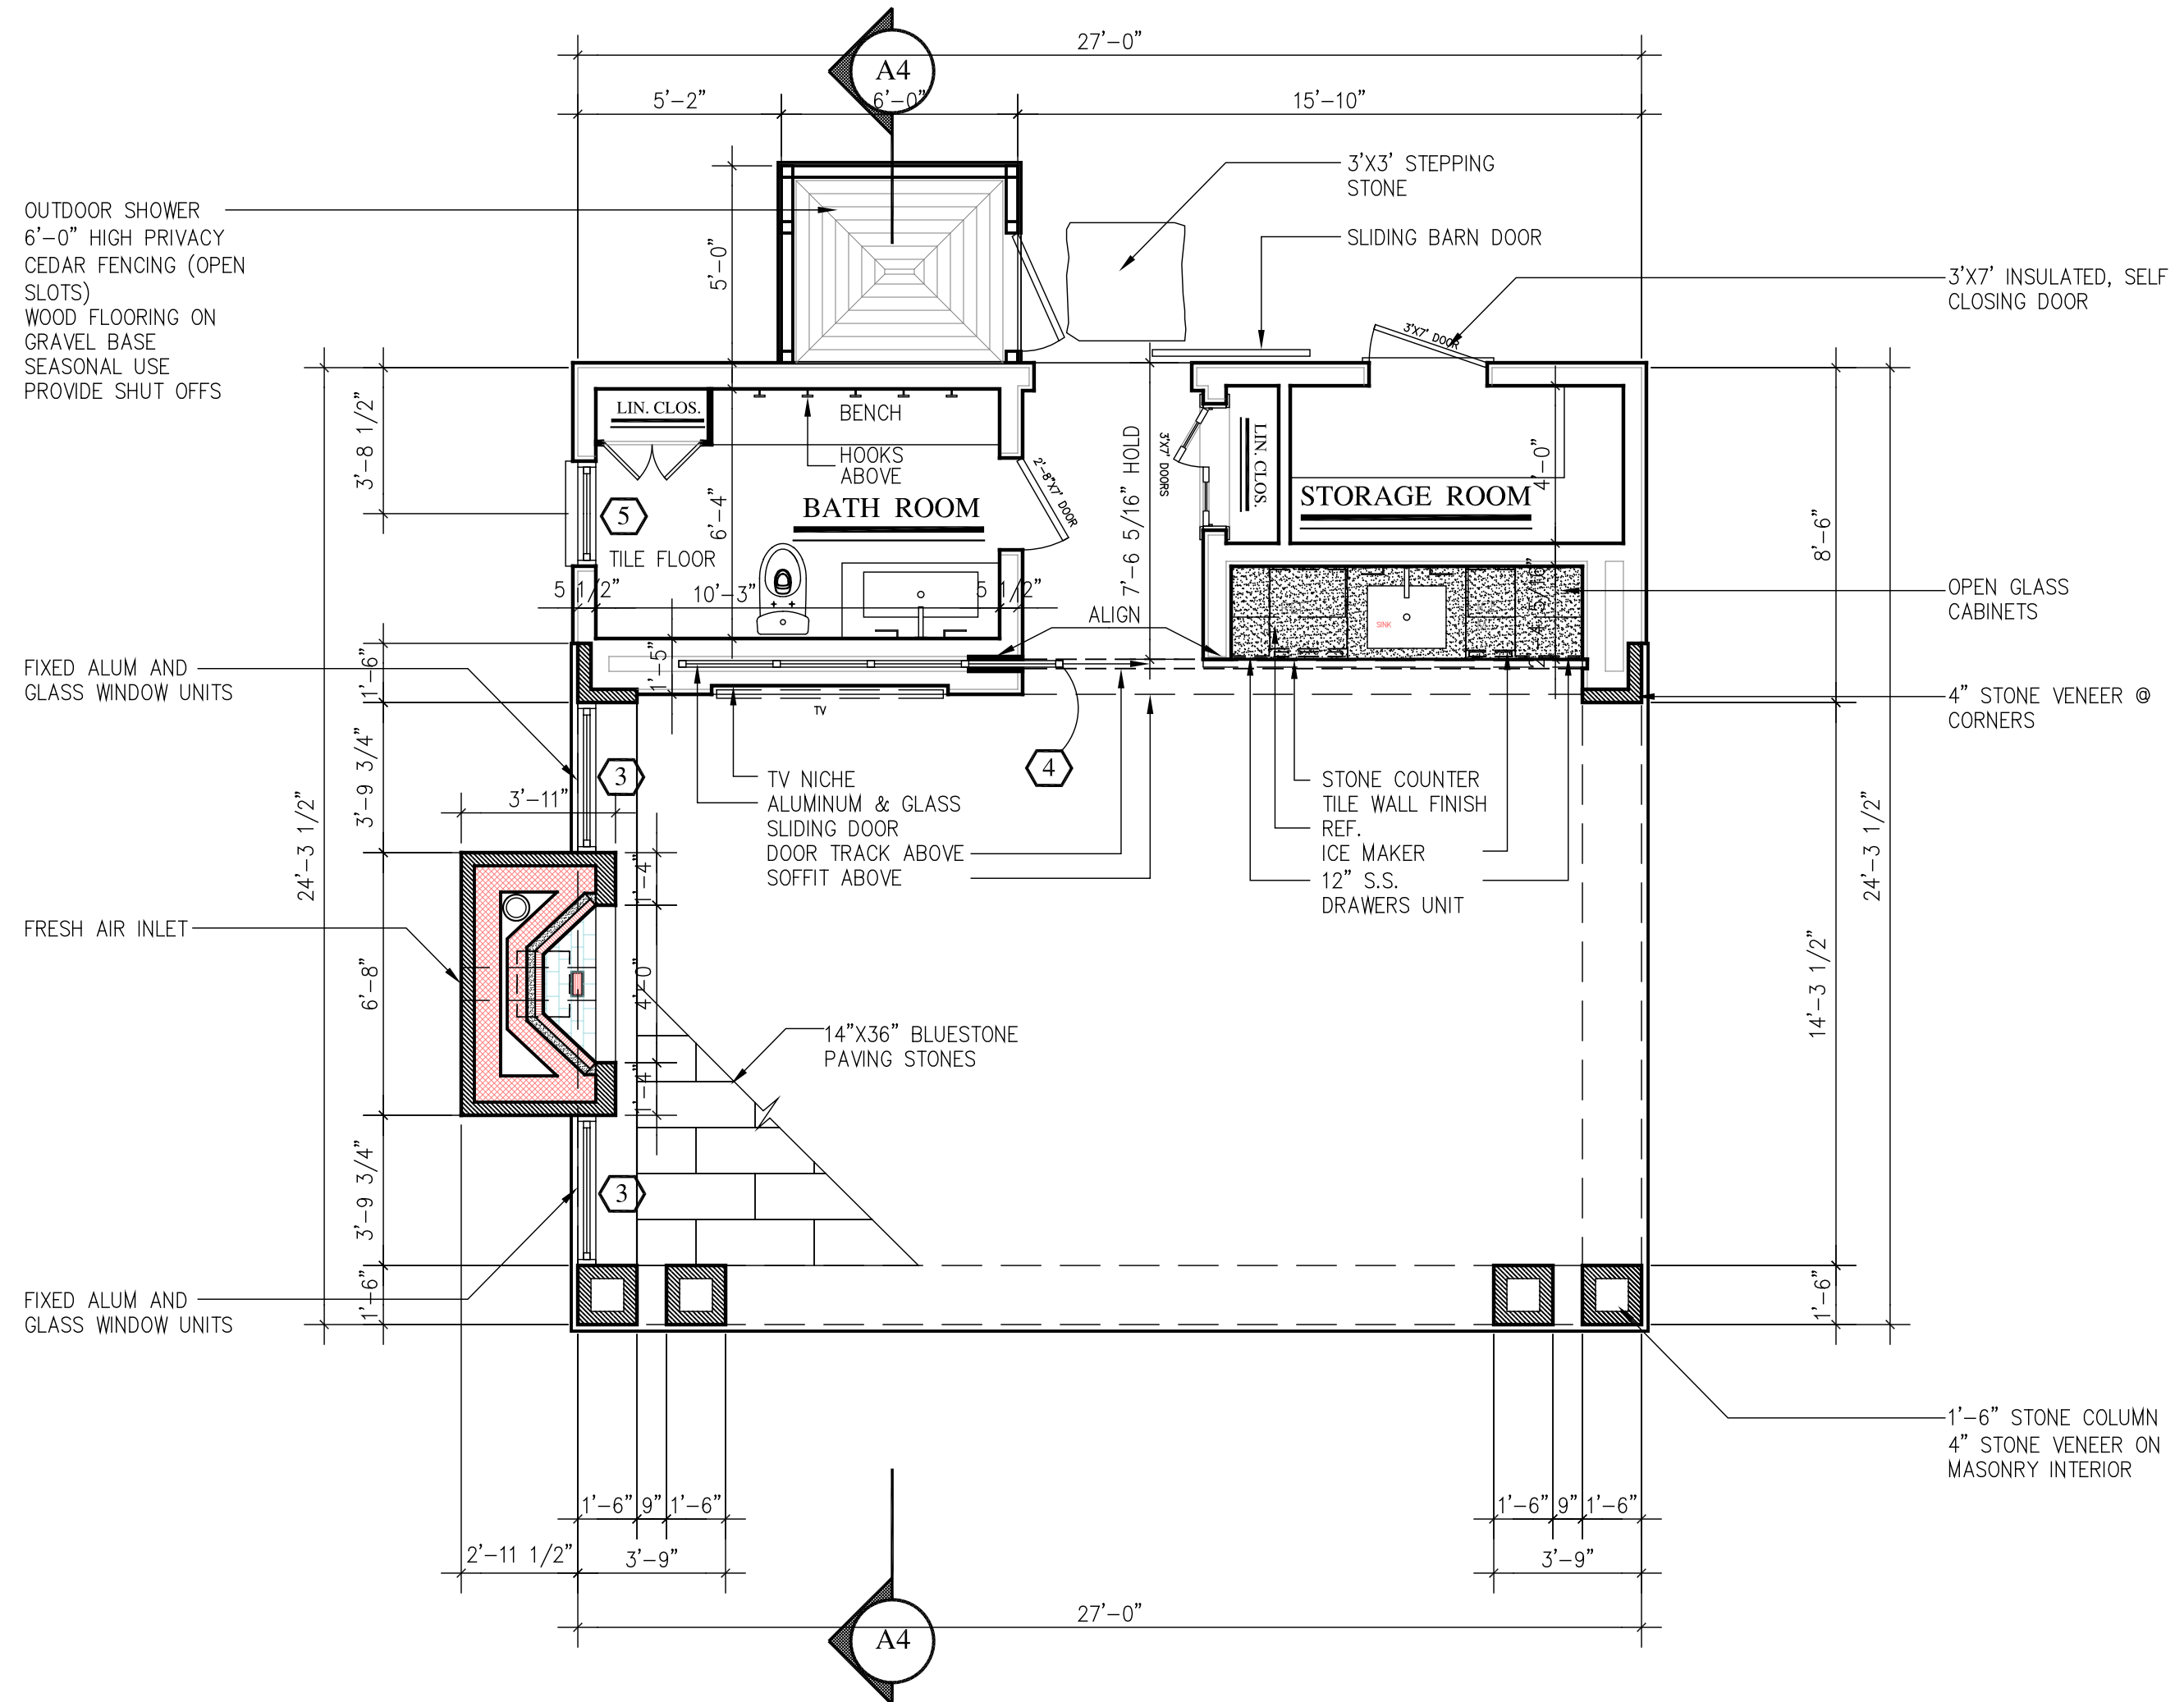
DRAWING NUMBER

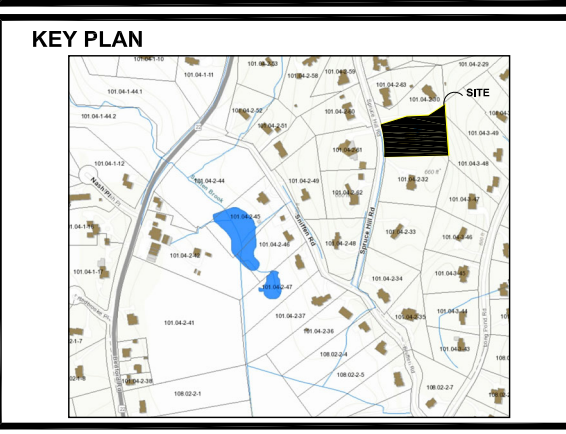ISSUE DATE	10-24-20
BY	JLR
CHECKED	MS
PROJECT NO.	20077
SCALE	AS NOTED

SEAL/SIGNATURE



FOUNDATION PLAN
 SCALE: 1/4" = 1'-0"



FIRST FLOOR PLAN
 SCALE: 1/4" = 1'-0"

WINDOW SCHEDULE

1	
2	
3	
4	
5	

INTERIOR DOORS:

- ALL INTERIOR DOOR SIZES INDICATED ON FLOOR PLANS OR THE INTERIOR DOOR SCHEDULE ARE NOMINAL SIZES. CONTRACTOR IS RESPONSIBLE TO COORDINATE ROUGH OPENING REQUIREMENTS WITH DOOR MANUFACTURER.
- CONTRACTOR IS RESPONSIBLE TO COORDINATE WITH OWNER ALL OPTIONS OF INTERIOR DOORS REGARDING MATERIAL, STYLE, HARDWARE, FINISHES, COLORS AND ALL OTHER COMPONENTS OF INTERIOR DOORS.

EXTERIOR DOORS:

- ENTRANCE DOORS SHALL BE BY "THERMA-TRU" UNLESS NOTED OTHERWISE. (SEE PLANS FOR MODEL NUMBERS AND ELEVATIONS FOR GRILL PATTERNS).
- CONTRACTOR IS RESPONSIBLE TO COORDINATE WITH OWNER ALL OPTIONS REGARDING GRILLS, HARDWARE, SCREENS, FINISHES, COLORS AND ALL OTHER COMPONENTS OF WINDOWS & DOORS.
- CONTRACTOR IS RESPONSIBLE TO COORDINATE ROUGH OPENING AND MASONRY OPENING REQUIREMENTS WITH WINDOW & DOOR MANUFACTURER PRIOR TO FRAMING.

WINDOWS AND EXTERIOR FRENCH DOORS:

- ALL EXTERIOR WINDOWS AND GLAZED FRENCH PATIO OR SLIDING DOORS SHALL BE BY "ANDERSEN" SERIES 400 VINYL CLAD EXTERIOR UNLESS NOTED OTHERWISE. (SEE PLANS FOR MODEL NUMBERS AND ELEVATIONS FOR GRILL PATTERNS).
- WINDOW SUPPLIER SHALL SUBMIT (4) COPIES OF WINDOW OUT SHEETS TO THE OWNER AND ARCHITECT FOR REVIEW AND APPROVAL SHOWING WINDOW ROUGH OPENING SIZES, EXCESS WINDOW DESIGNATIONS, ALL STANDARD FEATURES AND OPTIONS PRIOR TO FABRICATION OF WINDOWS AND DOORS.
- WINDOWS AND FRENCH DOORS TO HAVE WHITE EXTERIOR CLADDING WITH SIMULATED DIVIDED LITES IN 6 OVER 6 BARE FRAME INTERIOR FRAME. JAMB EXTENSIONS FOR 2 X 6 STUD WALL CONSTRUCTION. STANDARD STONE FINISH HARDWARE, INSECT SCREENS UNLESS OTHERWISE NOTED ON PLANS OR AS REQUESTED BY OWNER/CONTRACTOR.
- CONTRACTOR IS RESPONSIBLE TO COORDINATE WITH OWNER ALL OPTIONS REGARDING GRILLS, HARDWARE, SCREENS, FINISHES, COLORS AND ALL OTHER COMPONENTS OF WINDOWS & DOORS.
- CONTRACTOR IS RESPONSIBLE TO COORDINATE ROUGH OPENING AND MASONRY OPENING REQUIREMENTS WITH WINDOW & DOOR MANUFACTURER PRIOR TO FRAMING.

SPECIFICATIONS NOTE:
 SEE GENERAL NOTES SHEET ON FOR ADDITIONAL CONSTRUCTION INFORMATION - THE CONTRACTOR AND ALL SUB CONTRACTORS ARE TO READ ALL CONSTRUCTION NOTES AND BE FAMILAR WITH WORK OF OTHER TRADES.

NOTE:
 ALL DIMENSIONS INDICATED ARE ROUGH FRAMING TO ROUGH FRAMING OR ROUGH FRAMING TO FINISH DIMENSIONS - CONTRACTOR IS TO VERIFY FINISH TO FINISH DIMENSIONS IN THE FIELD.


STRUCTURAL NOTE:
 SEE STRUCTURAL PLANS FOR ADDITIONAL STRUCTURAL CONSTRUCTION INFORMATION.

SOUND ATTENUATION BLANKET NOTE:
 CONTRACTOR IS TO INSTALL 3" SOUND ATTENUATION BATT INSULATION IN WALLS AND CEILING OF LAUNDRY ROOM, ALL BATHROOMS, ALL BEDROOMS AND AS NOTED ON THE DRAWINGS.

CLOSET NOTES:
 CONTRACTOR TO PROVIDE AND INSTALL ONE CLOTHES ROD AND 12" DEEP WOOD SHELF MTD. + 64" A.F.F. IN ALL CLOSETS EXCEPT LINEN CLOSETS AND MASTER BEDROOM CLOSETS.
 PROVIDE AND INSTALL (4) 12" DEEP WOOD SHELVES ON ADJUSTABLE STANDARDS IN LINEN CLOSETS.
 MASTER BEDROOM CLOSETS TO HAVE CUSTOM SHELVING/STORAGE SYSTEMS INSTALLED (TO BE SELECTED BY OWNER)

RESIDENTIAL LEGEND

SYMBOL	DESCRIPTION
	EXISTING WALL OR PARTITION TO REMAIN
	EXISTING WALL OR PARTITION TO BE REMOVED
	NEW 2 X 4 OR 2 X 6 WOOD STUD PARTITION SEE PLANS FOR THICKNESS
	NEW 2 X 4 OR 2 X 6 STUD ONE HOUR FIRE RATED PARTITION
	NEW 2 X 4 OR 2 X 6 STUD BEARING WALL
1	EXTERIOR DOOR DESIGNATION
BO1	INTERIOR DOOR DESIGNATION
W2	WINDOW NUMBER
	SMOKE DETECTOR WITH AUXILIARY BATTERY BACKUP - HARD WIRED AND INTERCONNECTED TO ALL OTHER SMOKE DETECTORS
	HEAT DETECTOR HARDWIRED WITH AUXILIARY BATTERY BACKUP
	CARBON MONOXIDE DETECTOR HARD WIRED WITH AUXILIARY BATTERY BACKUP
	RECESSED CEILING MTD. EXHAUST FAN DUCTED TO EXTERIOR - CONNECTED TO LIGHT SWITCH - SEE PLAN FOR CFM REQUIREMENTS

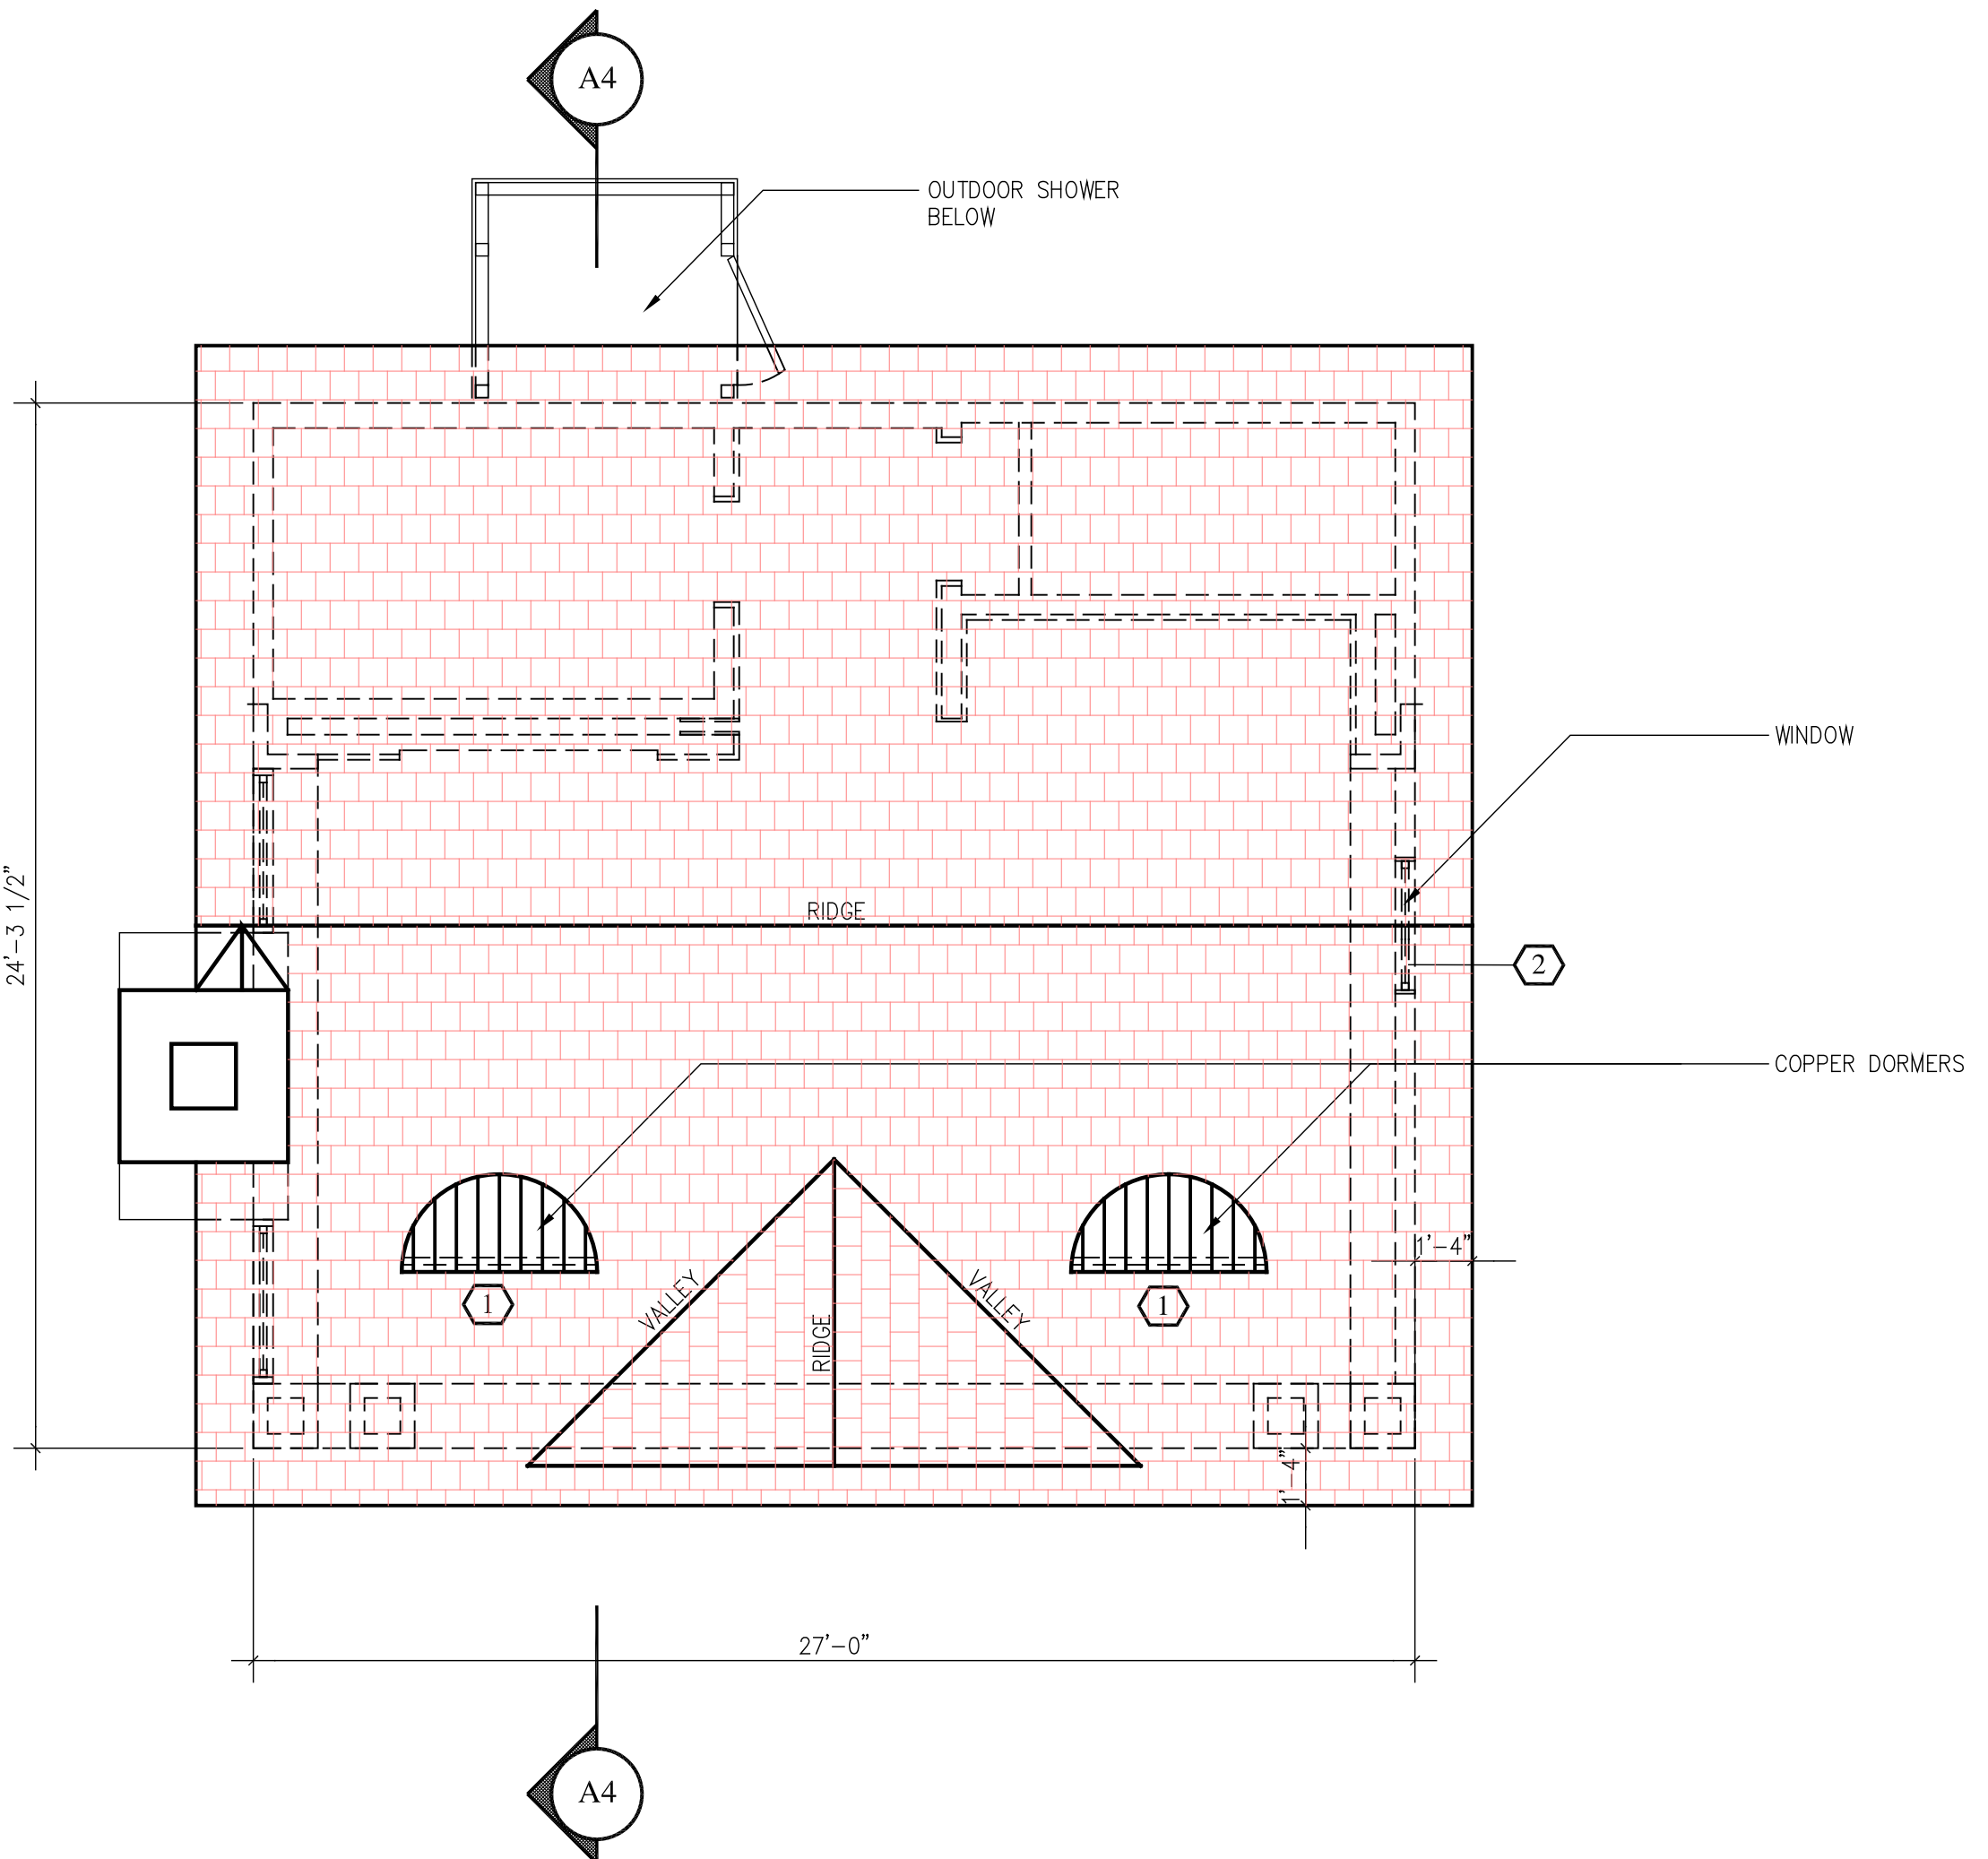

ROOF PLAN
 SCALE: 1/4" = 1'-0"

ARCHITECTS

STRUCTURAL ENGINEERS

landscape architect

FOODSERVICE EQUIPMENT

PROJECT INFORMATION

PROPOSED POOL & CABANA

FDR:
 MR. & MRS. KIRSCHNER

8 SPRUCE HILL RD.
 ARMONK, NY


No. Revision	Date	Description
	10-16-20	D.O.B. SUBMISSION

RESIDENTIAL LEGEND

SYMBOL	DESCRIPTION
	EXISTING WALL OR PARTITION TO REMAIN
	EXISTING WALL OR PARTITION TO BE REMOVED
	NEW 2 X 4 OR 2 X 6 WOOD STUD PARTITION SEE PLANS FOR THICKNESS
	NEW 2 X 4 OR 2 X 6 STUD ONE HOUR FIRE RATED PARTITION
	NEW 2 X 4 OR 2 X 6 STUD BEARING WALL
	EXTERIOR DOOR DESIGNATION
	INTERIOR DOOR DESIGNATION
	WINDOW NUMBER
	SMOKE DETECTOR WITH AUXILIARY BATTERY BACKUP - HARD WIRED AND INTERCONNECTED TO ALL OTHER SMOKE DETECTORS
	HEAT DETECTOR HARDWIRED WITH AUXILIARY BATTERY BACKUP
	CARBON MONOXIDE DETECTOR HARD WIRED WITH AUXILIARY BATTERY BACKUP
	RECESSED CEILING MTD. EXHAUST FAN DUCTED TO EXTERIOR - CONNECTED TO LIGHT SWITCH - SEE PLAN FOR CFM REQUIREMENTS

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KEY PLAN

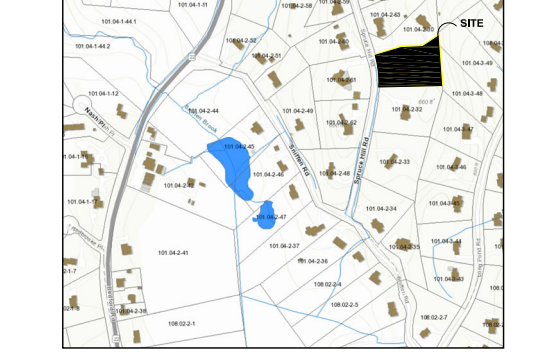


DRAWING TITLE

A2


DRAWING NUMBER

REGISTERED ARCHITECT
 STATE OF NEW YORK
 100777
 ISSUE DATE: 08-04-19
 PROJECT NO.: 100777
 SCALE: AS NOTED

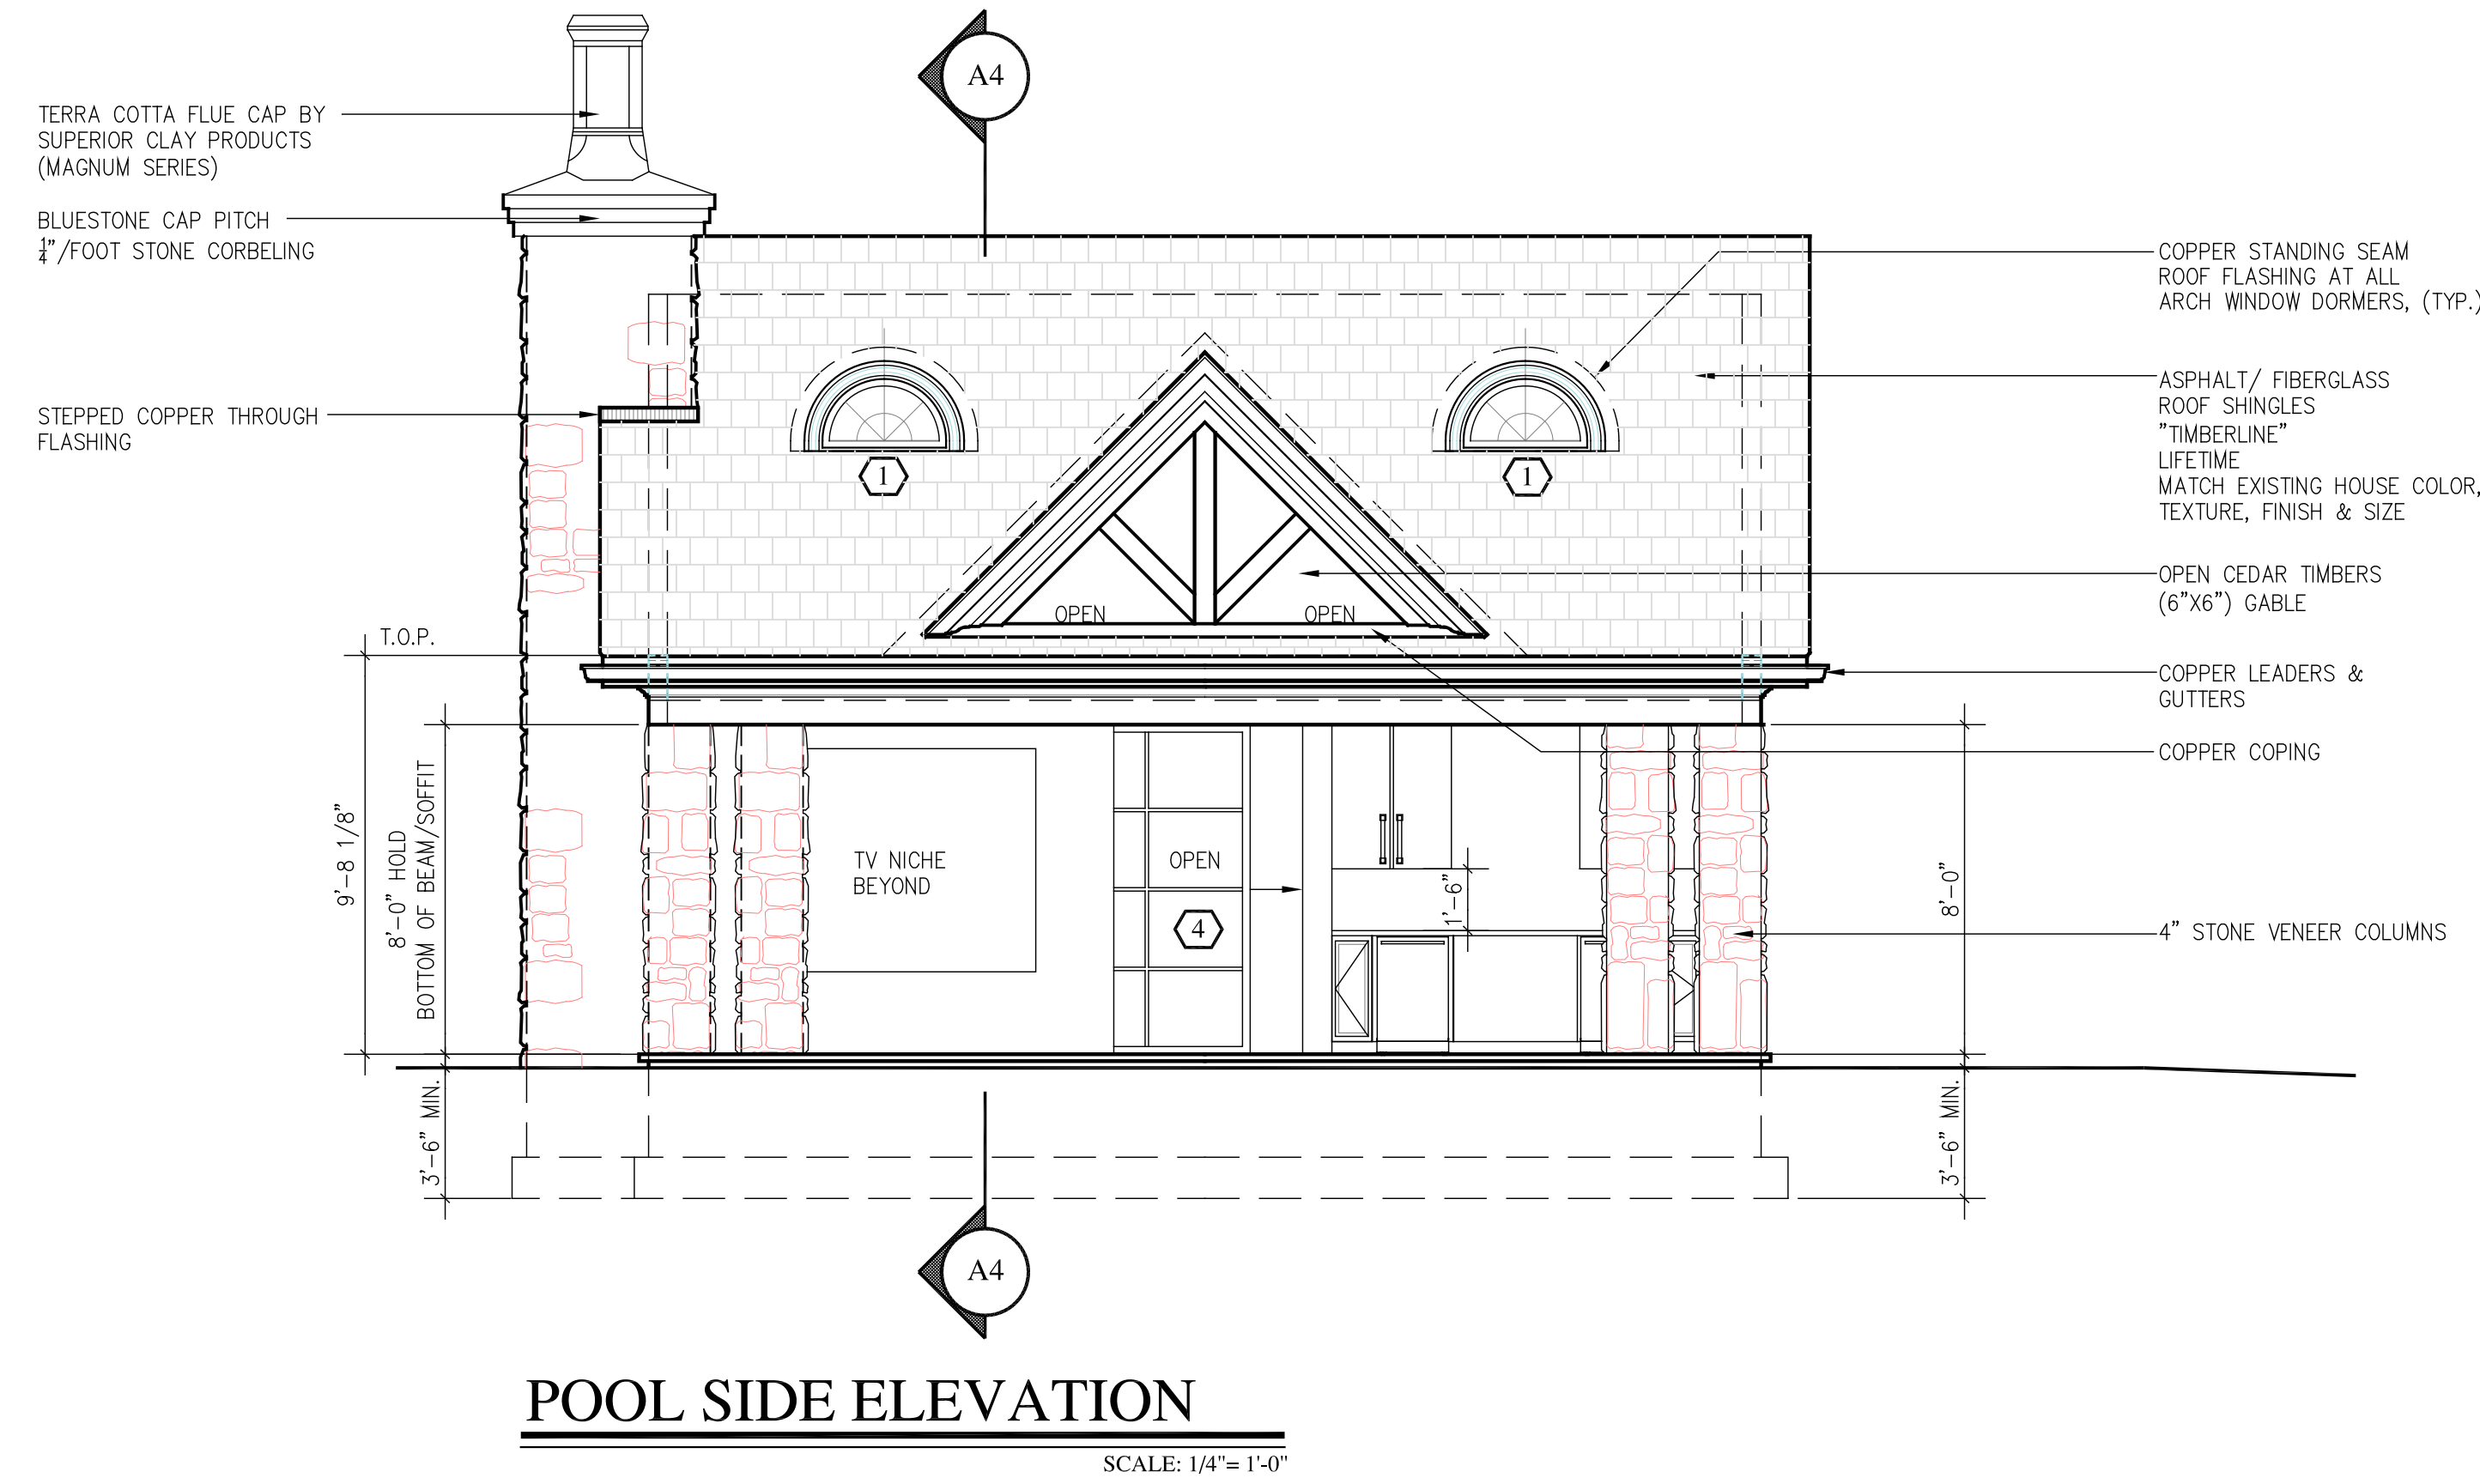


POOL SIDE ELEVATION

SCALE: 1/4"=1'-0"

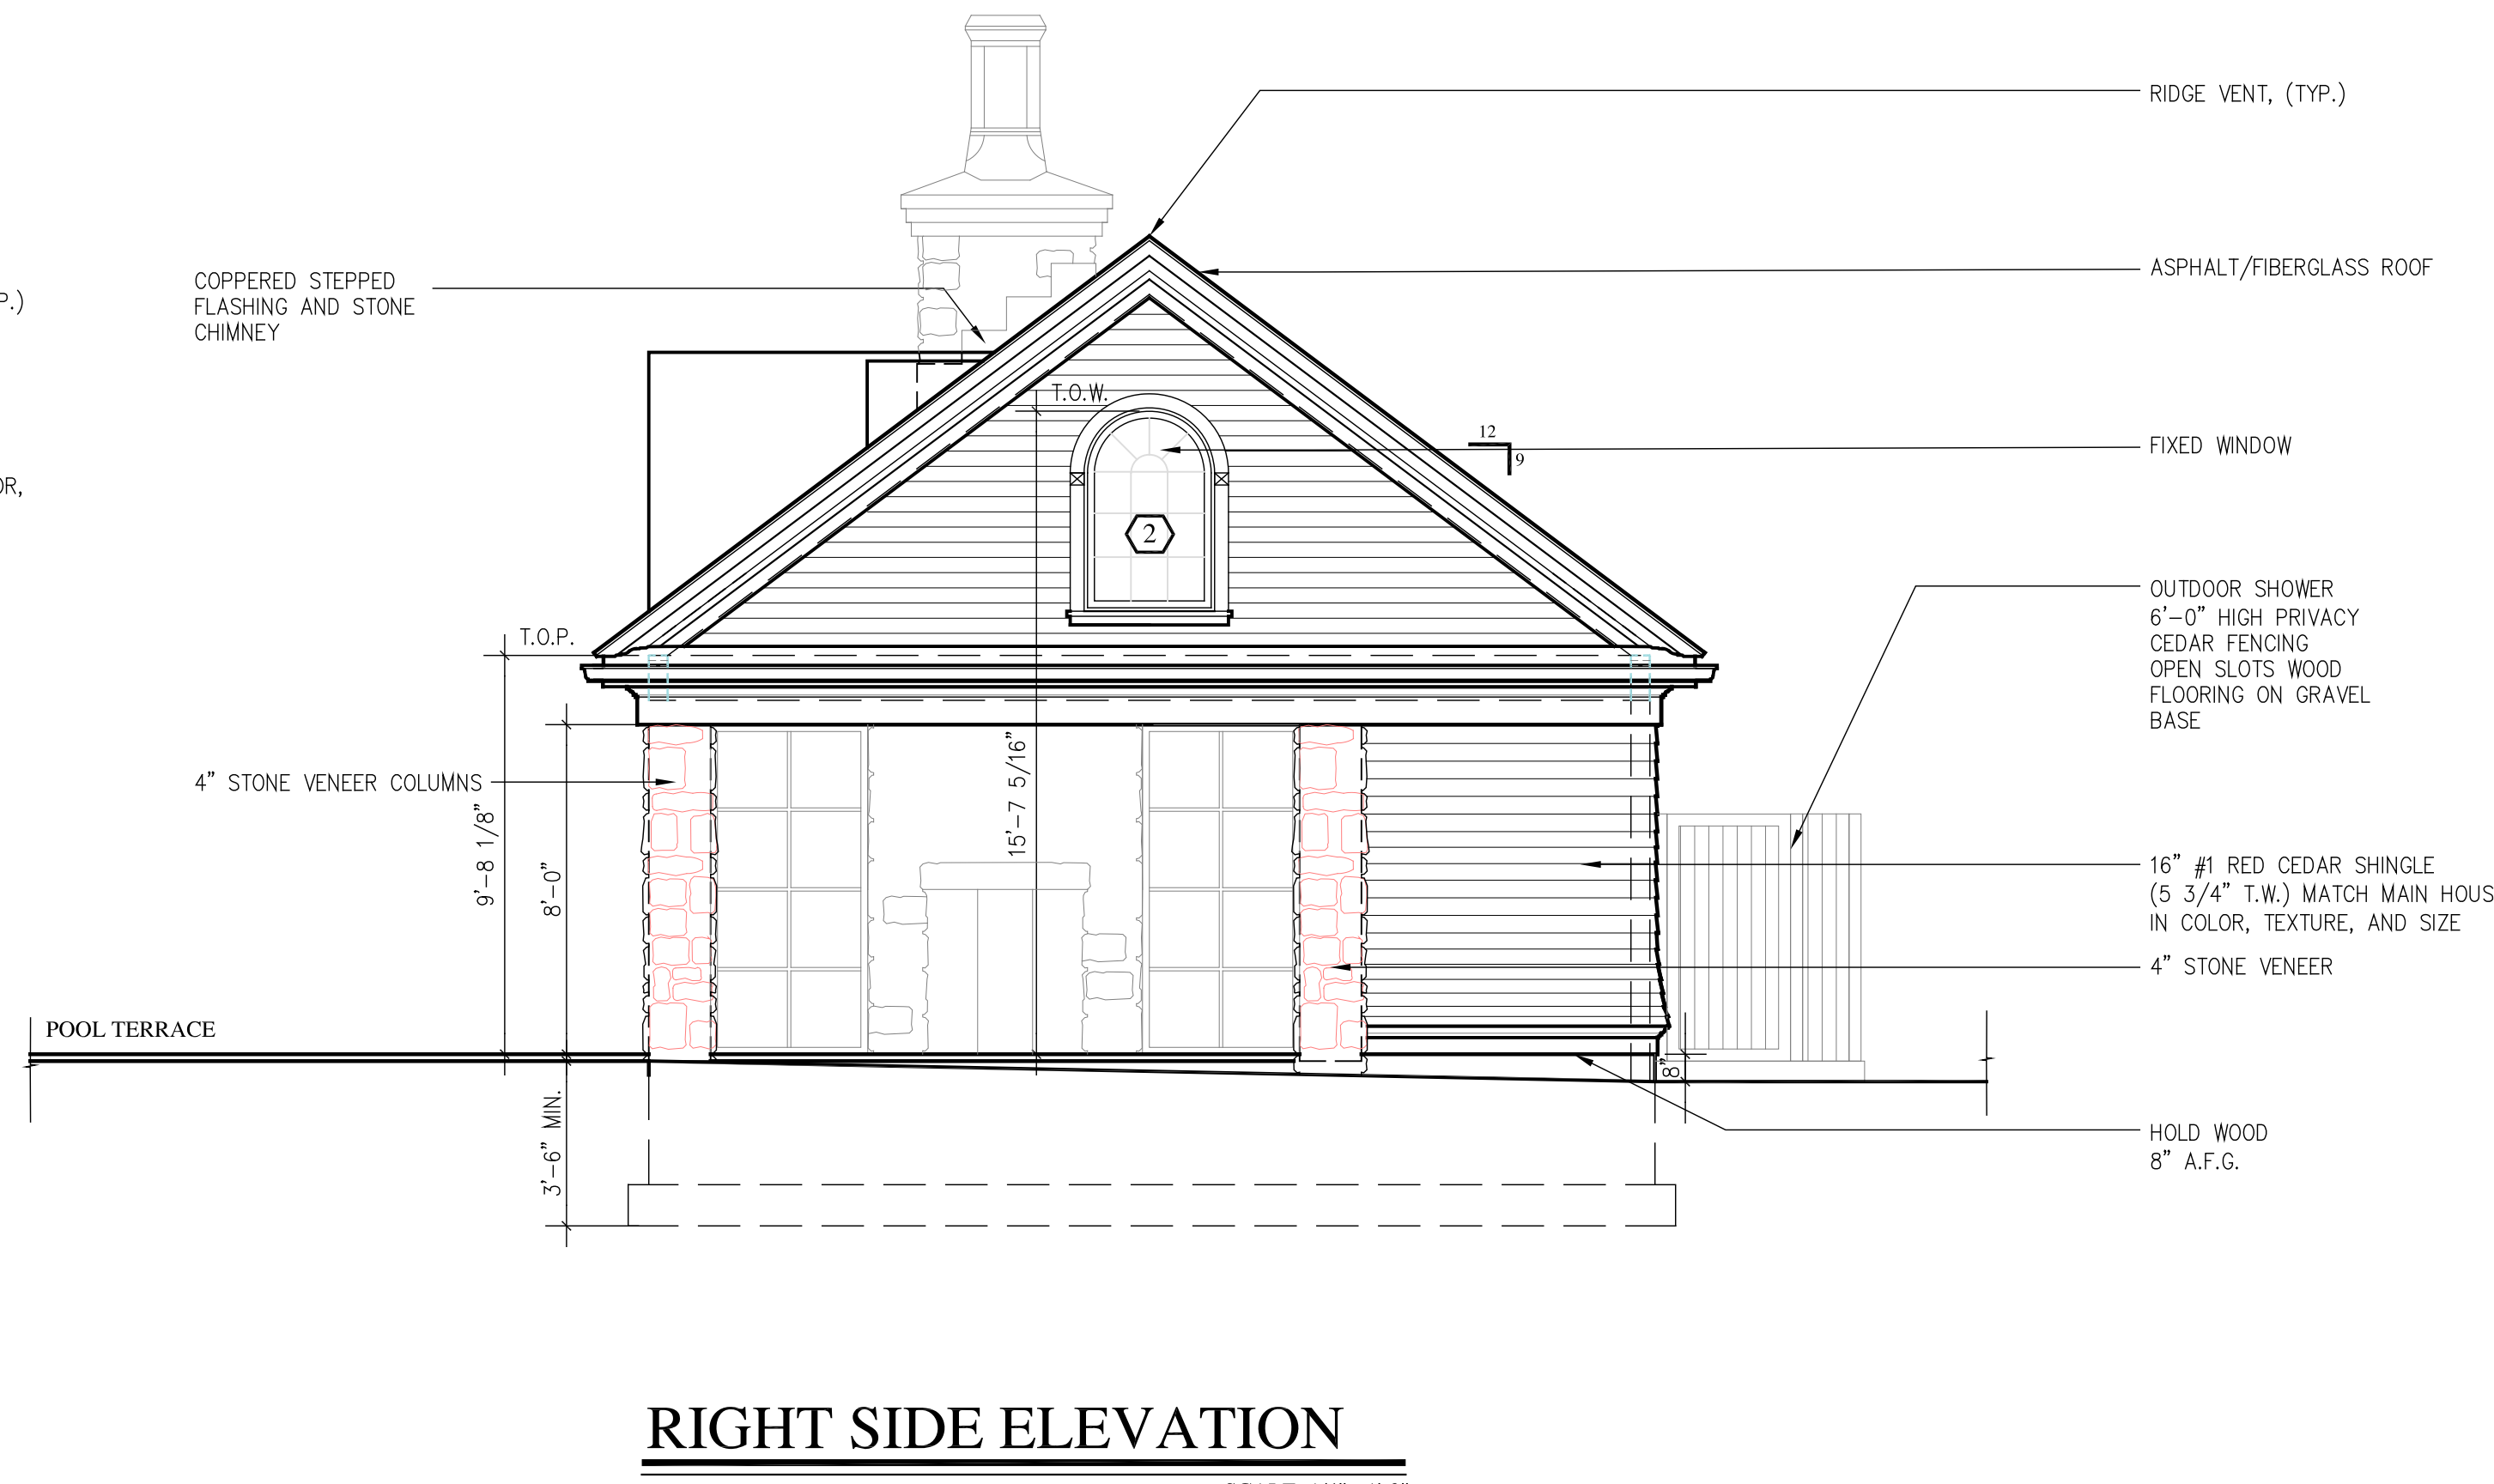


RIGHT SIDE ELEVATION

SCALE: 1/4"=1'-0"

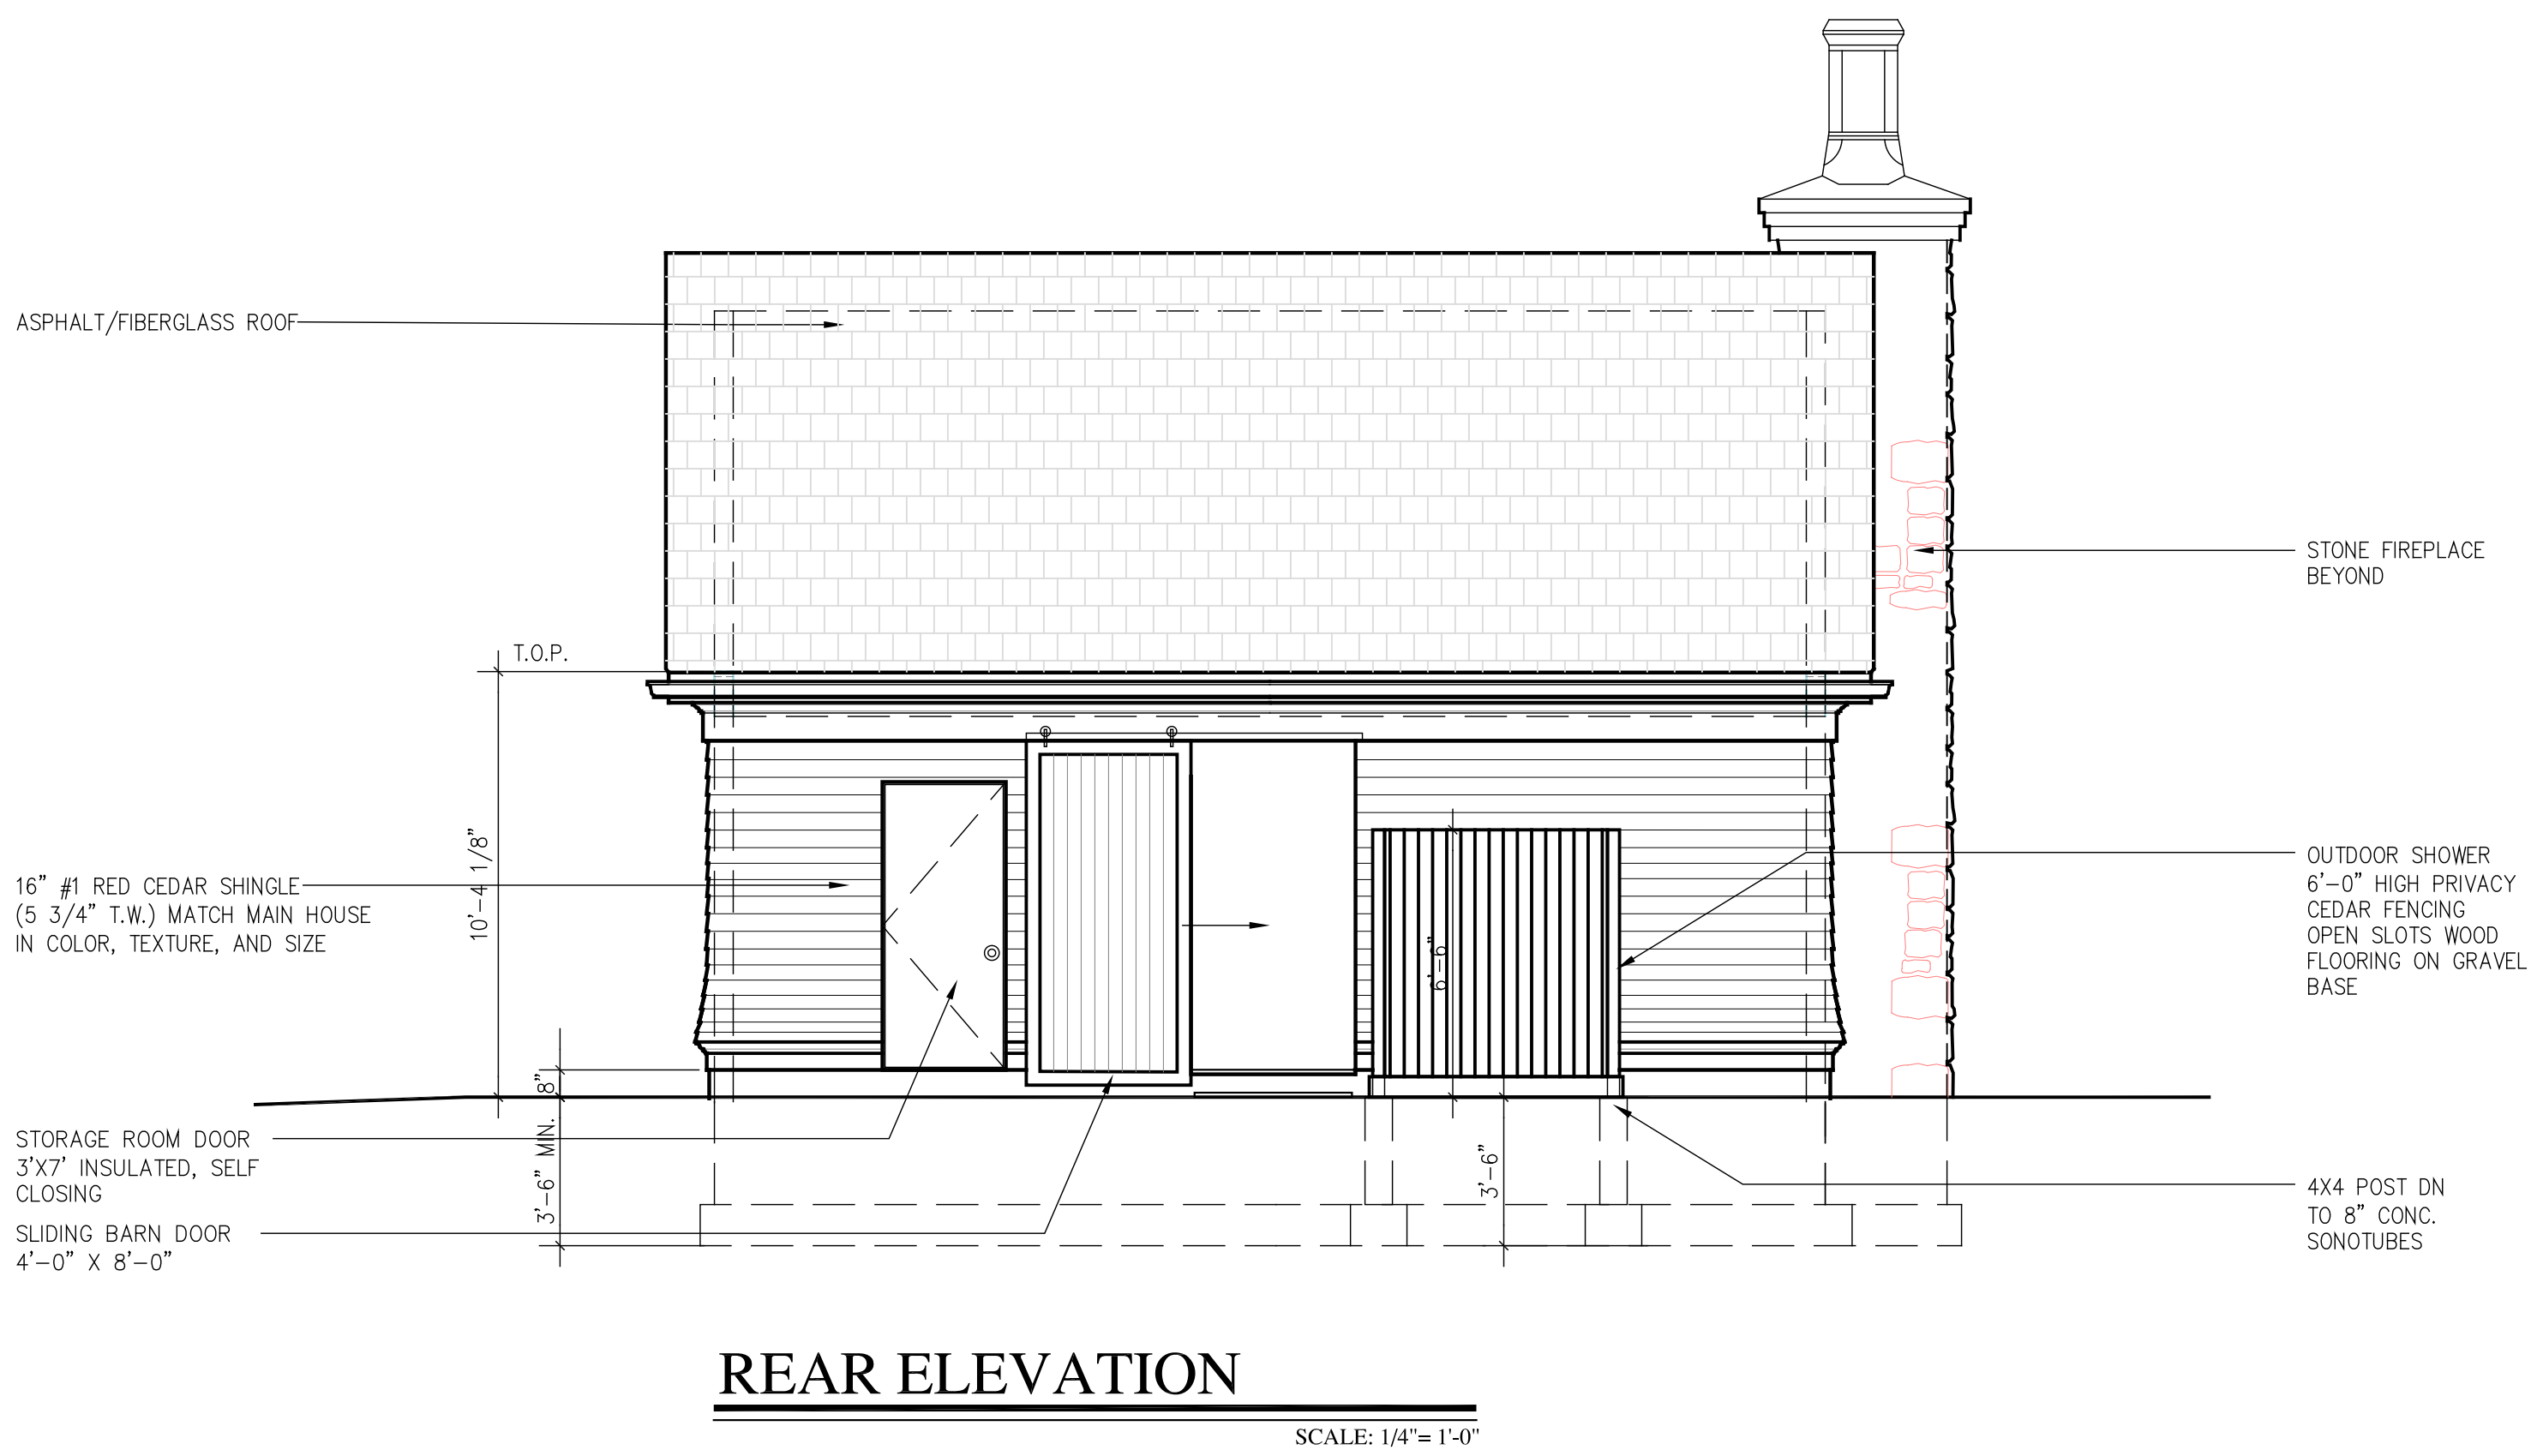

REAR ELEVATION

SCALE: 1/4"=1'-0"

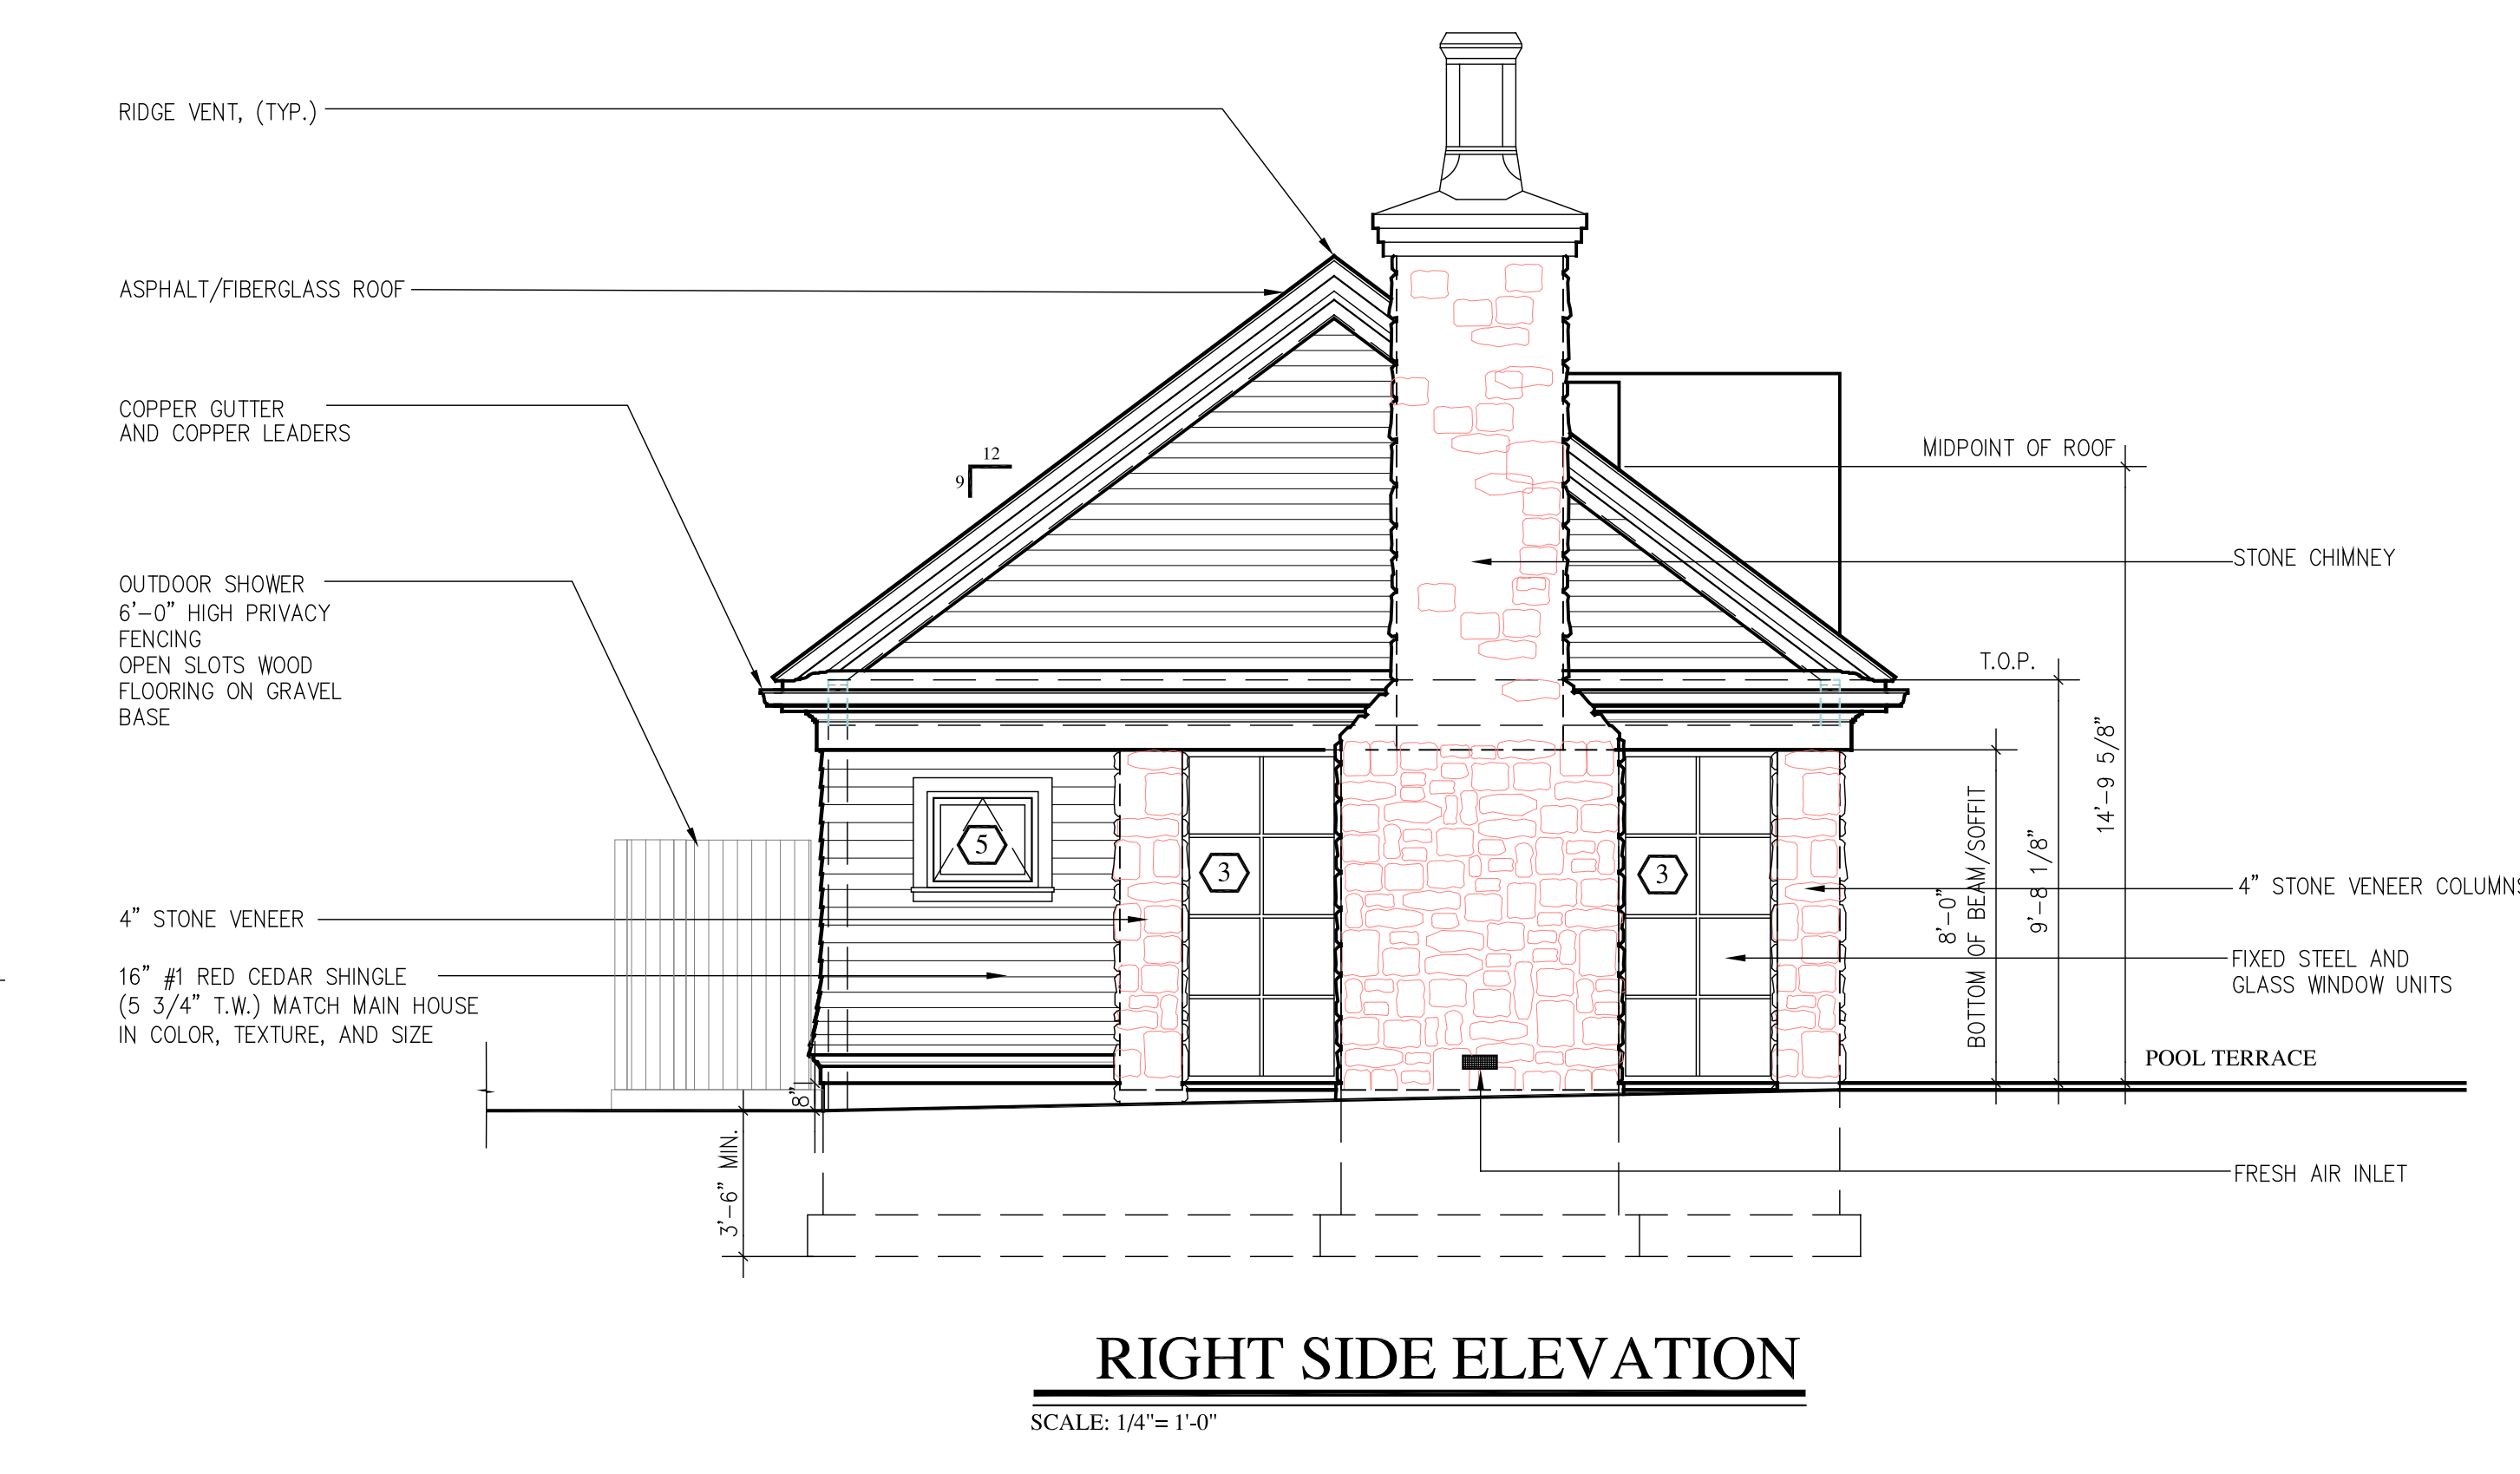


RIGHT SIDE ELEVATION

SCALE: 1/4"=1'-0"

SCHEDULE PROPOSED BUILDING MATERIALS AND COLOR SCHEME			
COLOR	NAME	TYPE	STYLE
SIDING	RED CEDAR SHINGLES	SHINGLES 5/2" T.W.	STAINED WHITE
WINDOWS	EAGLE	DOUBLE HUNG	OFF WHITE
TRIM	5/4x4	WOOD	OFF WHITE
EXT. DOOR	PINECREST	MAHOGONY	NATURAL
ROOFING	TIMBERLINE	40 YEARS ARCHITECTURAL	WEATHER CEDAR
STONE AND/OR BRICK	CONNECTICUT FIELDSTONE	DRY LOOK	GREY BROWN
STYLE	COLONIAL / SHINGLE STYLE		

48" Rumford Fireplace


.....Components by Superior Clay Corp.

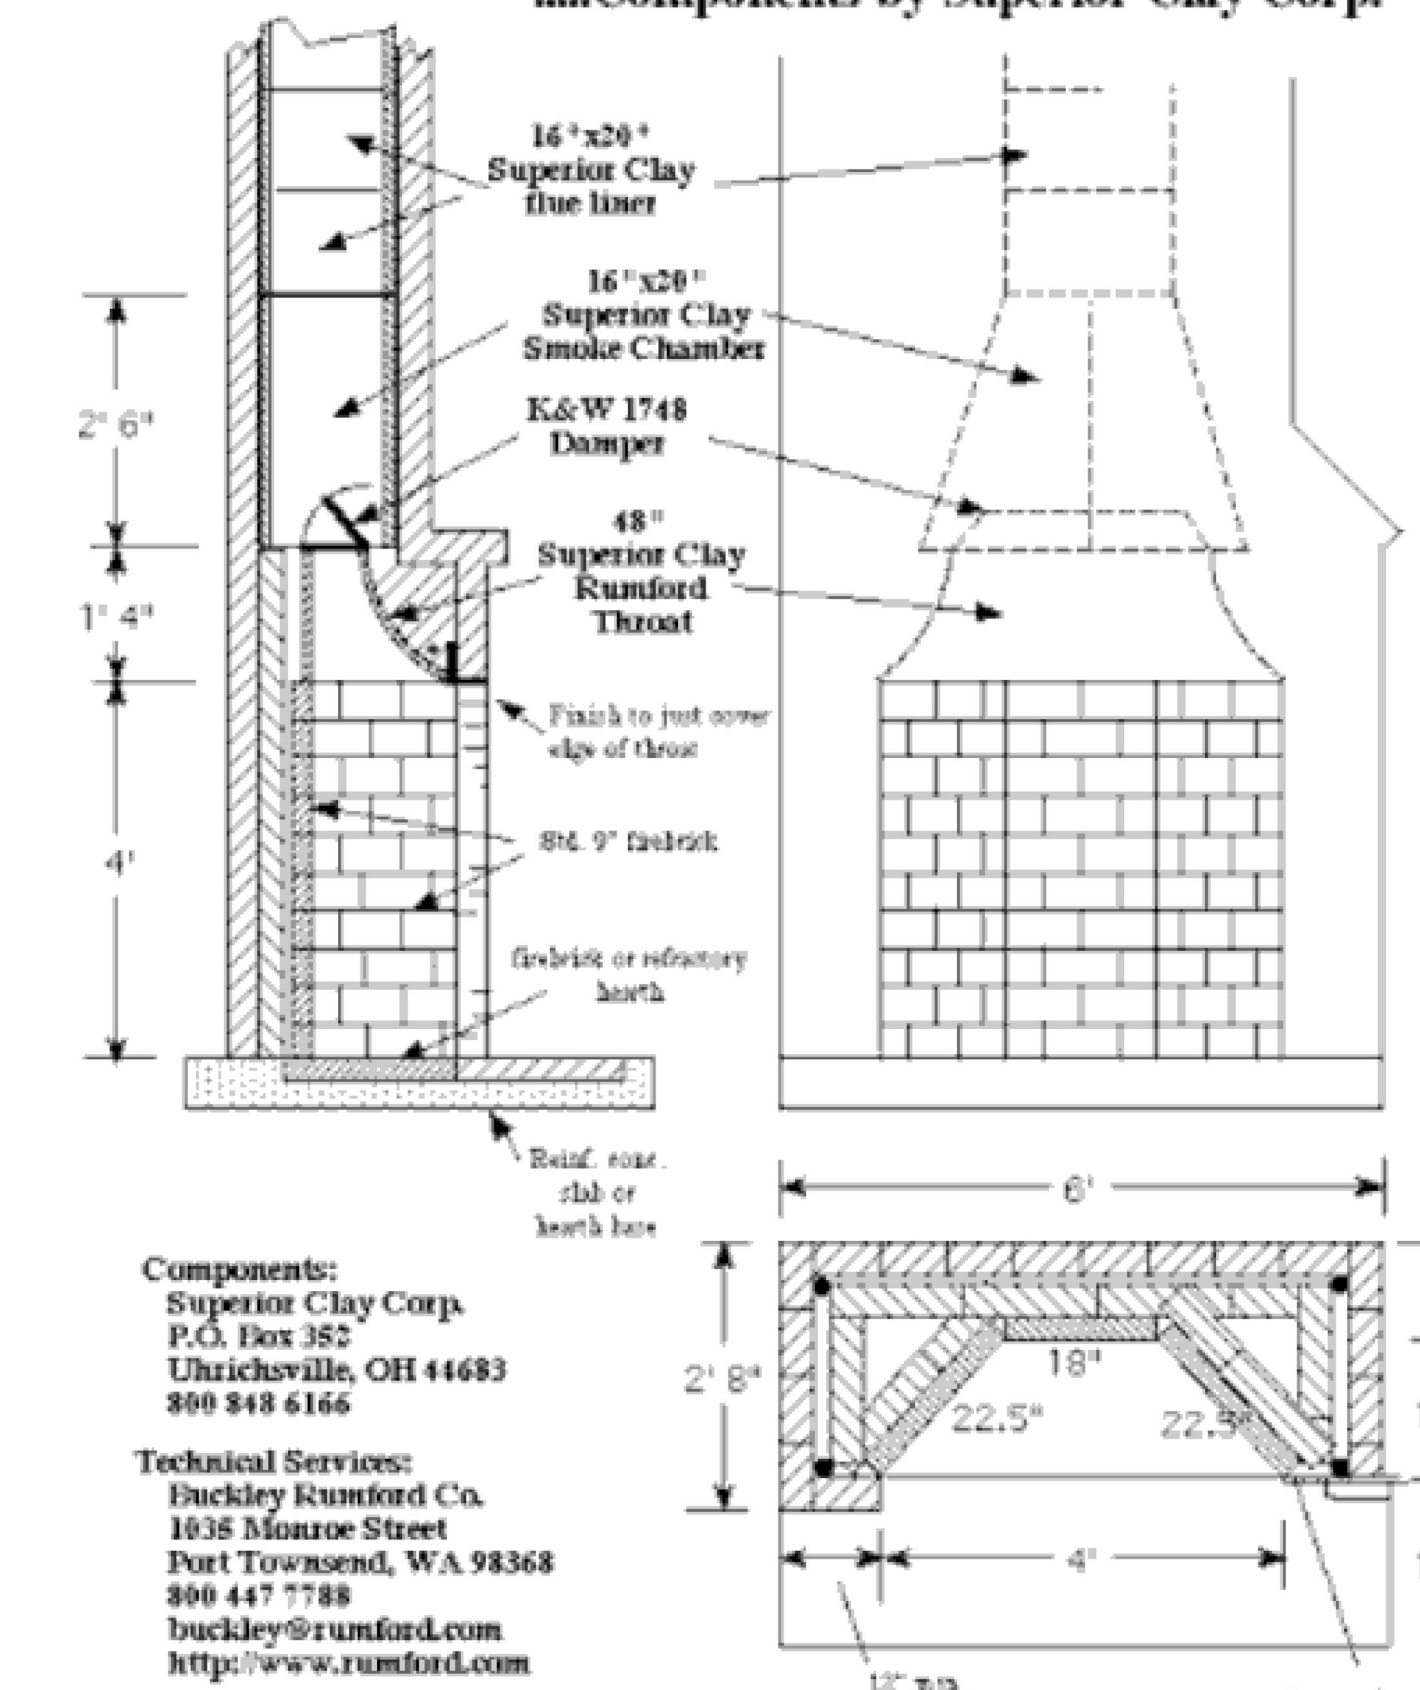

Components:
 Superior Clay Corp.
 P.O. Box 352
 Uhrichsville, OH 44683
 800 848 6166

Technical Services:
 Buckley Rumford Co.
 1636 Niagara Street
 Port Townsend, WA 98368
 800 447 7788
 buckley@rumford.com
 http://www.rumford.com

MAGNUM EDWARDIAN
 48" Tall
 400 lbs.
 14.25" Top Opening
 18.25"x18.25" Base I.D.
 21.5"x21.5" Base O.D.

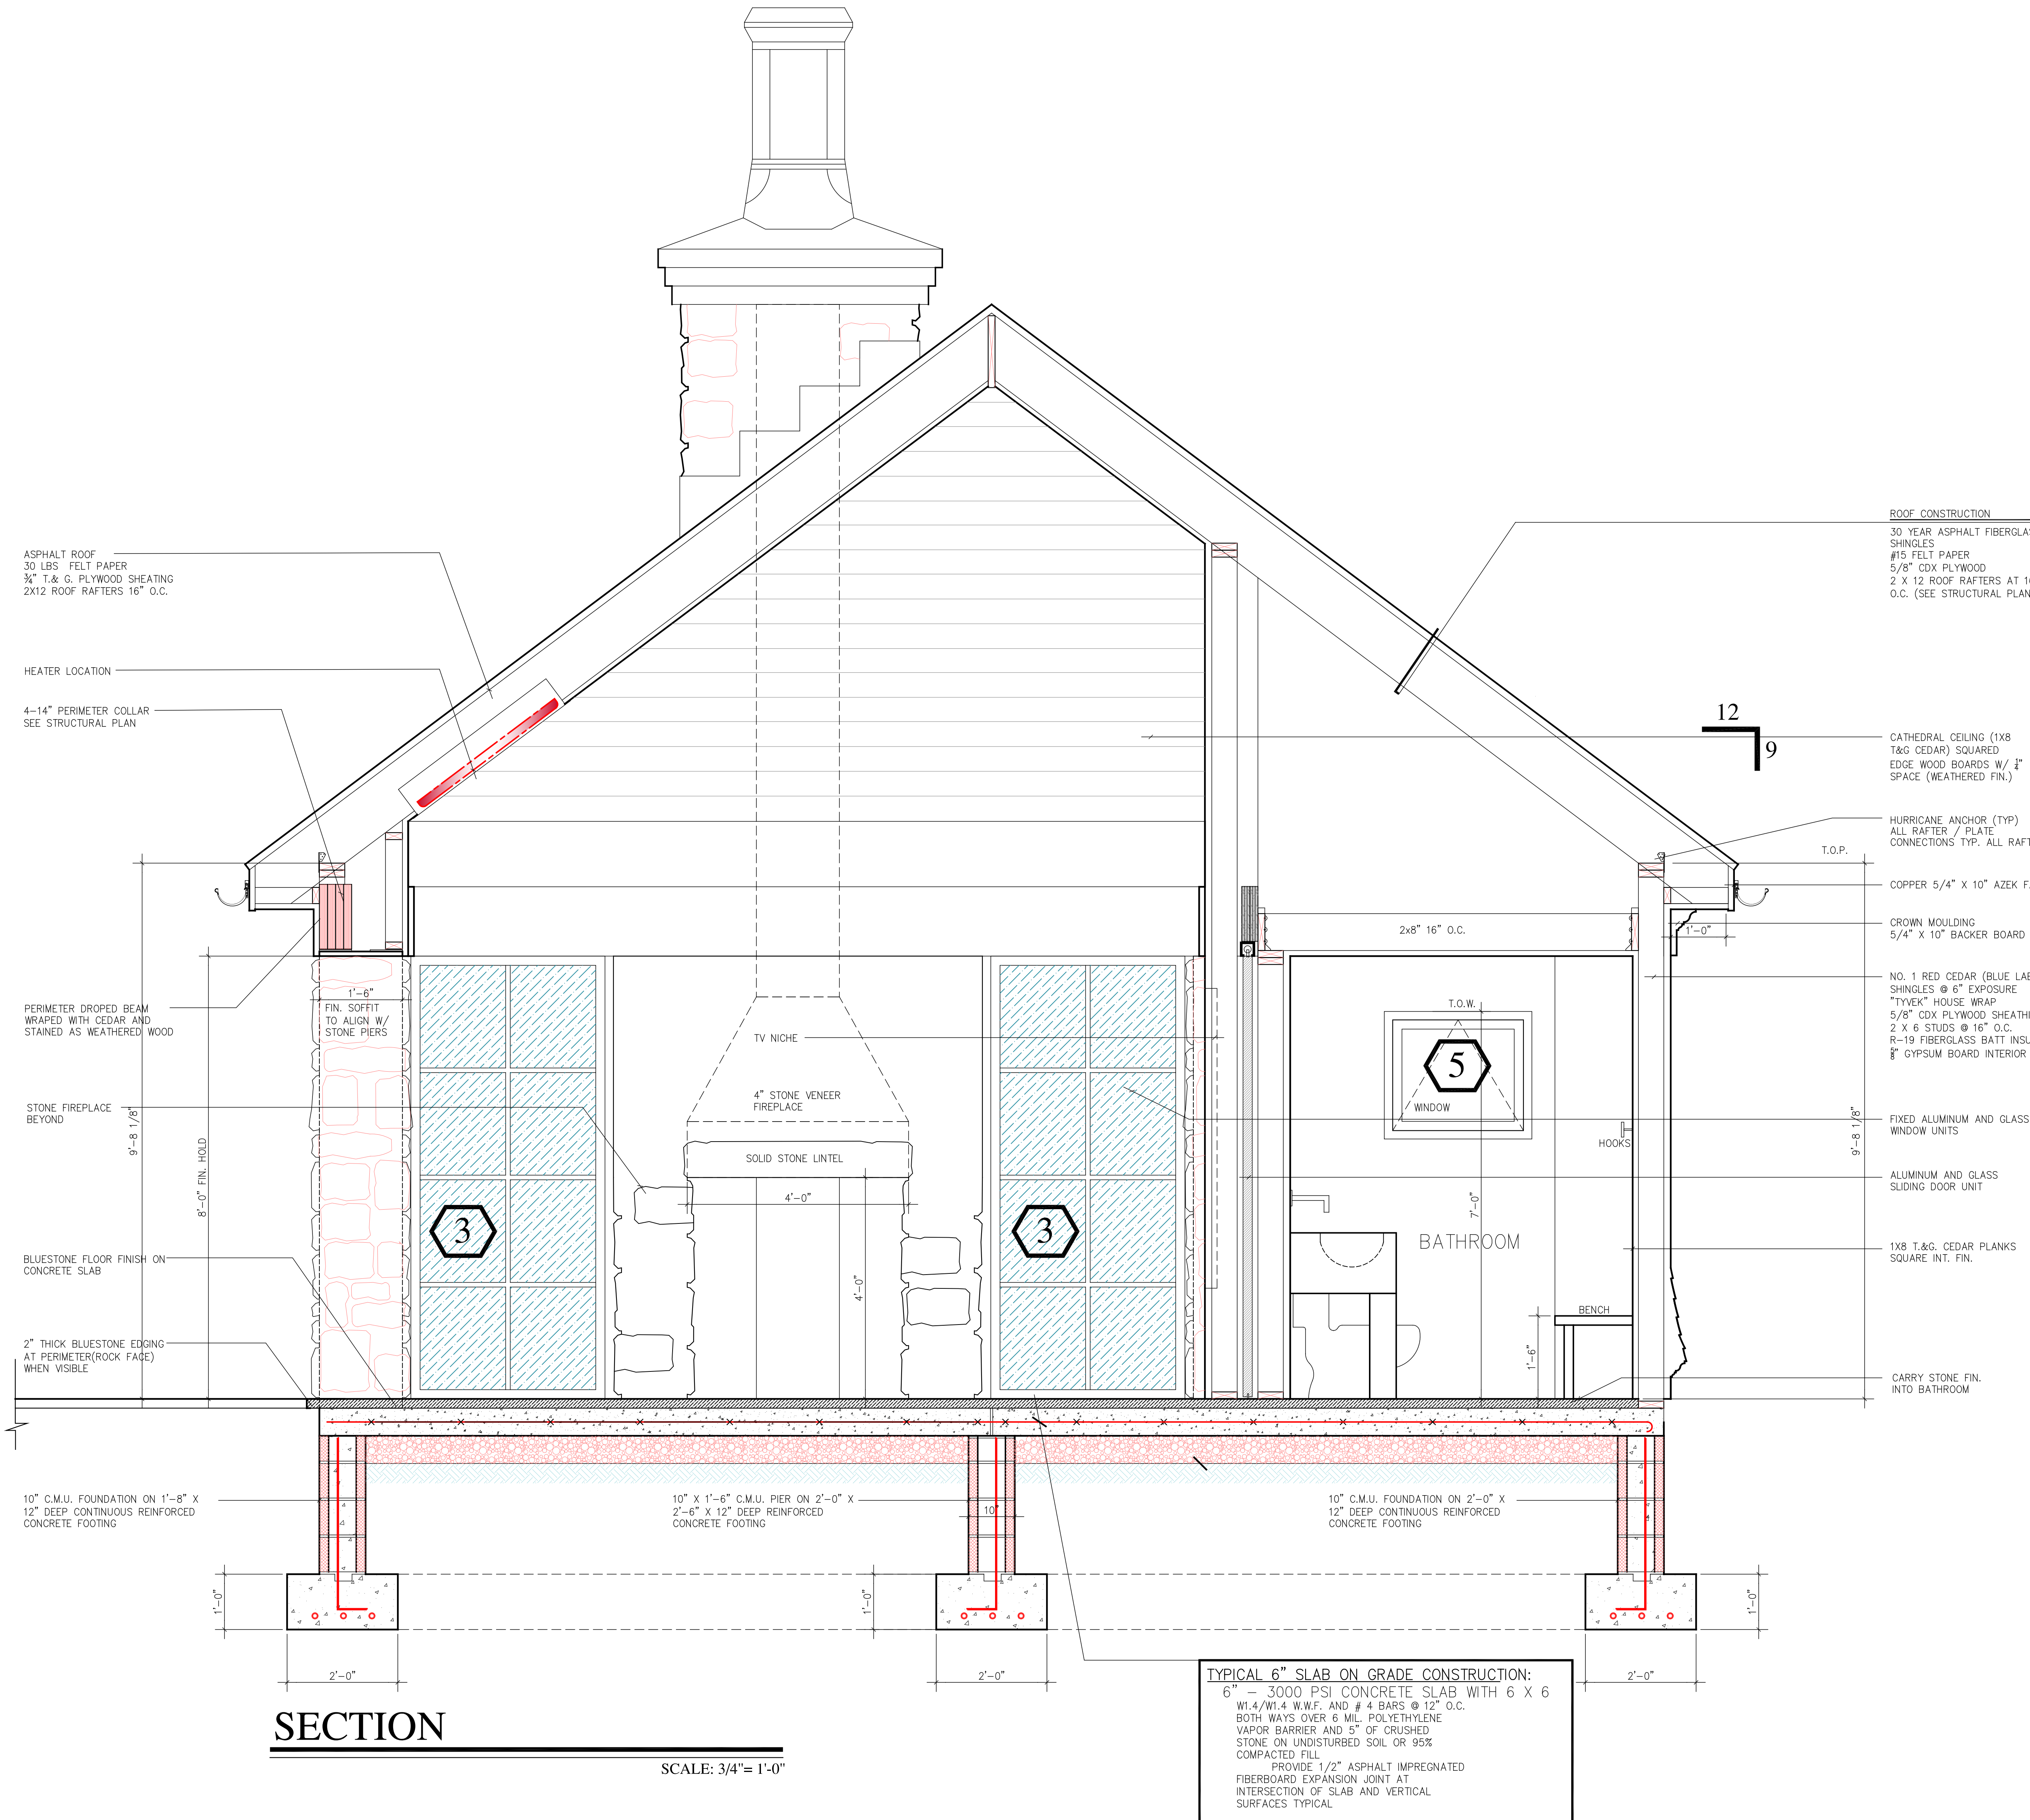

SECTION

SCALE: 3/4" = 1'-0"

ARCHITECTS

STRUCTURAL ENGINEERS

landscape architect

POODSERVICE EQUIPMENT

PROJECT INFORMATION


PROPOSED POOL & CABANA

FDR:
 MR. & MRS. KIRSCHNER

8 SPRUCE HILL RD.
 ARMONK, NY

No.	Revision	Date	Description
10-16-20	D.O.B.		SUBMISSION

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DRAWING TITLE

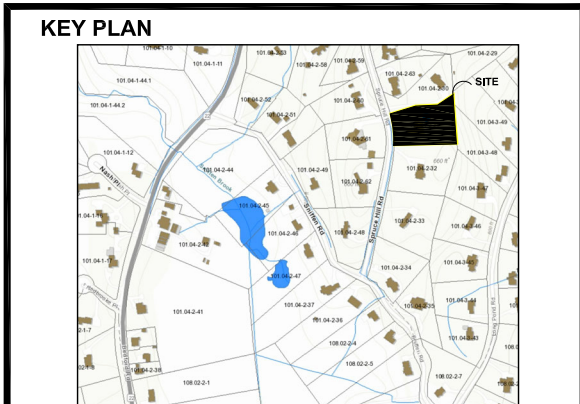A3

DRAWING NUMBER

	ISSUE DATE:	09-24-20
	ISSUED BY:	SR/AM
	BY - L.S.	
	PROJECT NO.:	180717
SCALE:		AS NOTED
SEAL/SIGNATURE		

PROPOSED POOL & CABANA


FOR:
MR. & MRS. KIRSCHNER

9 SPRUCE HILL RD.
ARMONK, NY

No. Revision	Date	Description
	10-16-20	D.O.B. SUBMISSION

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KEY PLAN

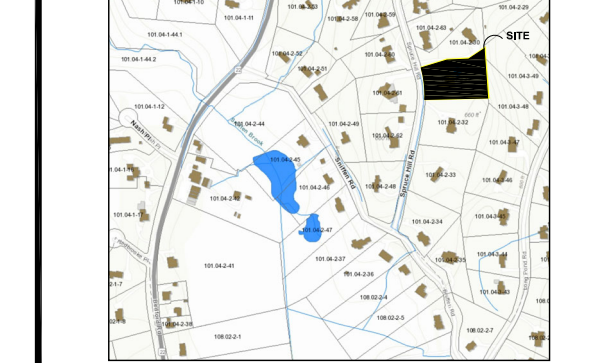


DRAWING TITLE

S1-E1

DRAWING NUMBER

ISSUE DATE: 04-24-15
BY: J.L.B.
PROJECT NO.: 16077
SHEET AS NOTED

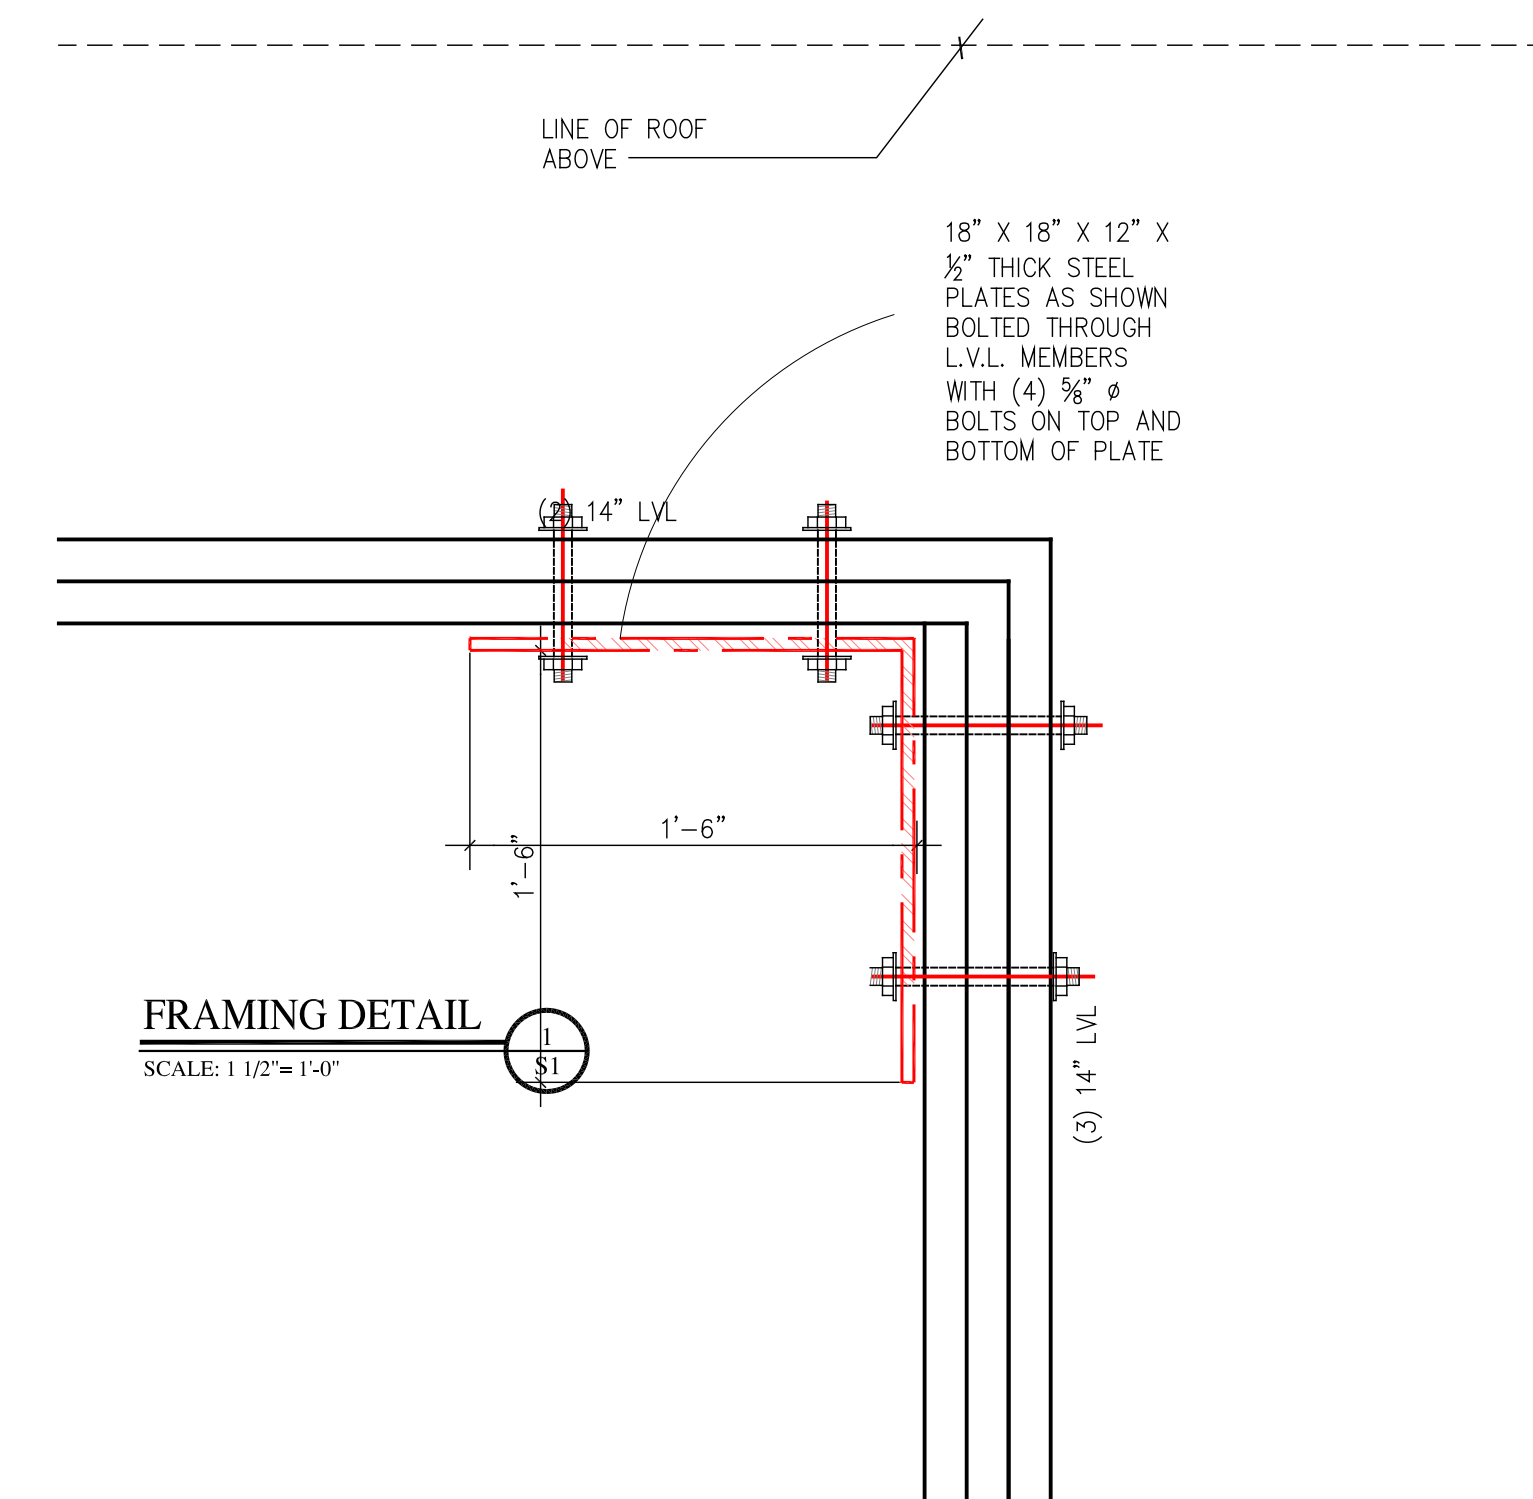

FRAMING DETAIL

SCALE: 1/2" = 1'-0"

TRUSS JOIST SUBSTITUTION NOTE :

1. CONTRACTOR SHALL SUBMIT TO ARCHITECT WRITTEN PROOF THAT ANY SUBSTITUTIONS OF THE TRUSS JOIST MANUFACTURER INDICATED ON THESE DRAWINGS SHALL BE OF EQUAL STRUCTURAL CAPACITY PRIOR TO ORDERING.

TRUSS JOIST NOTES :

- TRUSS JOISTS ARE TO BE MANUFACTURED BY "TRUSSJOIST MACMILLAN" OR APPROVED EQUAL. SIZE AND SPACING AS INDICATED ON THE DRAWINGS.
- FOLLOW ALL MANUFACTURER'S INSTALLATION INSTRUCTIONS AND RECOMMENDATIONS.
- MINIMUM BEARING LENGTH IS TO BE 1 3/4" AT JOIST ENDS AND 3 1/2" AT INTERMEDIATE SUPPORTS.
- PROVIDE "TIMBERSTRAND LSL RIM BOARDS AT PERIMETER WALL AND AS INDICATED. DO NOT USE SOLID DIMENSIONAL LUMBER AS RIM BOARDS.
- PROVIDE 2 X 4 WEB STIFFENER "SQUASH BLOCKS" AT ALL JOINT LOADS AND AT INTERMEDIATE BEARING POINTS WHERE THERE IS A BEARING WALL ABOVE TO TRANSFER LOAD TO BEARING PLATE. PROVIDE WEB STIFFENERS AT JUST INTERMEDIATE BEARING POINTS WHERE NO LOAD BEARING BEARING WALL IS ABOVE.
- DO NOT BEVEL CUT JOIST BEARING BEYOND INSIDE FACE OF STUD WALL (MAXIMUM OF 5 1/2" FOR 2 X 6 PLATE).
- FOLLOW NAILING REQUIREMENTS AS RECOMMENDED BY "TRUSSJOIST MACMILLAN".
- USE GALVANIZED JOIST HANGERS WHEN SUPPORTING TRUSS JOISTS FROM MICROROLL LVL BEAMS, DOUBLED TRUSS JOISTS AND LEDGER BOARDS. PROVIDE WEB BLOTTING IF JOIST HANGERS DO NOT LATERALLY SUPPORT THE TRUSS JOIST TOP FLANGE. PROVIDE BACKER BLOCKS WHERE TRUSS JOISTS ARE FRAMED INTO ANOTHER TRUSS JOIST.
- DOUBLE UP T.J. JOISTS UNDER PARALLEL PARTITIONS ABOVE.

LVL NOTE :

- ALL DESIGNATED LVL'S SHALL BE 1.9E "MICROLLAM" BY "TRUSSJOIST MACMILLAN" WITH A FLEXURAL FIBER STRESS OF $F_b = 2,600$ P.S.I. - OR AN APPROVED EQUAL.
- CONTRACTOR TO FOLLOW ALL RECOMMENDATIONS OF LVL MANUFACTURER IN REGARDS TO INSTALLATION, NOTCHING, DRILLING HOLES, BEARING, FASTENING OF MULTIPLE MEMBERS (NAILING OR BOLTING) AND ALL OTHER PERTINENT INFORMATION FOR PROPER INSTALLATION.
- NOTCHING AND DRILLING HOLES IN LVL'S SHOULD BE AVOIDED, HOWEVER IF REQUIRED DUE TO FIELD CONDITIONS, NOTCHING AND DRILLING HOLES SHALL BE LIMITED TO THE RECOMMENDATIONS OF THE LVL MANUFACTURER. THE G.C. IS TO COORDINATE FRAMING WITH MECHANICAL PLUMBING AND ELECTRICAL TRADES. THE G.C. IS TO BE RESPONSIBLE FOR ALL MODIFICATIONS TO LVL'S.
- FASTEN MULTIPLE LVL MEMBERS PER LVL MANUFACTURER'S RECOMMENDATIONS. (2) AND (3) MEMBER LVL BEAMS MAY BE NAILED OR BOLTED. (4) OR MORE MEMBER BEAMS ARE TO BE BOLTED.

HEADER AND LINTEL NOTES :

- ALL WOOD HEADERS AT WINDOWS AND EXTERIOR DOORS TO BEAR ON (2) 2 X 4 OR (2) 2 X 6 JACK STUDS AT EACH END.
- ALL STEEL ANGLES AT MASONRY VENEER IS TO BEAR A MINIMUM OF 4" ONTO MASONRY, OR AS INDICATED ON THE DRAWINGS.
- FLUSH FRAMED BEAMS ARE TO BEAR ONTO CORNER POSTS, SOLD OR BUILT - UP POSTS AS INDICATED ON THE DRAWINGS.
- WHERE (3) 2 X HEADERS ARE INDICATED, INSTALL (2) 1/2" PLYWOOD SPACERS BETWEEN EACH MEMBER.

FIRST FLR. LOADING SCHEDULE


LIVE LOAD	: 40 P.S.F.
DEAD LOAD	: 15 P.S.F.
TILE & MUD	: 20 P.S.F.
TOTAL LOAD	: 75 P.S.F.

FIRST FLR. LOADING SCHEDULE

LIVE LOAD	: 40 P.S.F.
DEAD LOAD	: 15 P.S.F.
TOTAL LOAD	: 55 P.S.F.

FRAMING PLAN LEGEND


- INDICATES FLOOR, CEILING, OR ROOF FRAMING DIRECTION AND SPACING.
- INDICATES STEEL BEAM OR LVL BEAM OR GIRDER (AS NOTED).
- BEARING PLATE LOCATION - SEE NOTES ON PLAN FOR SIZE AND BOLTING INFO.
- BUILT-UP SOLID WOOD POST - SEE NOTES ON PLANS FOR SIZE.
- BUILT-UP SOLID WOOD POST FROM ABOVE - SEE PLANS FOR SIZE.
- STEEL COLUMN - DIAMETER AS INDICATED ON PLANS.
- LOAD BEARING INTERIOR PARTITION

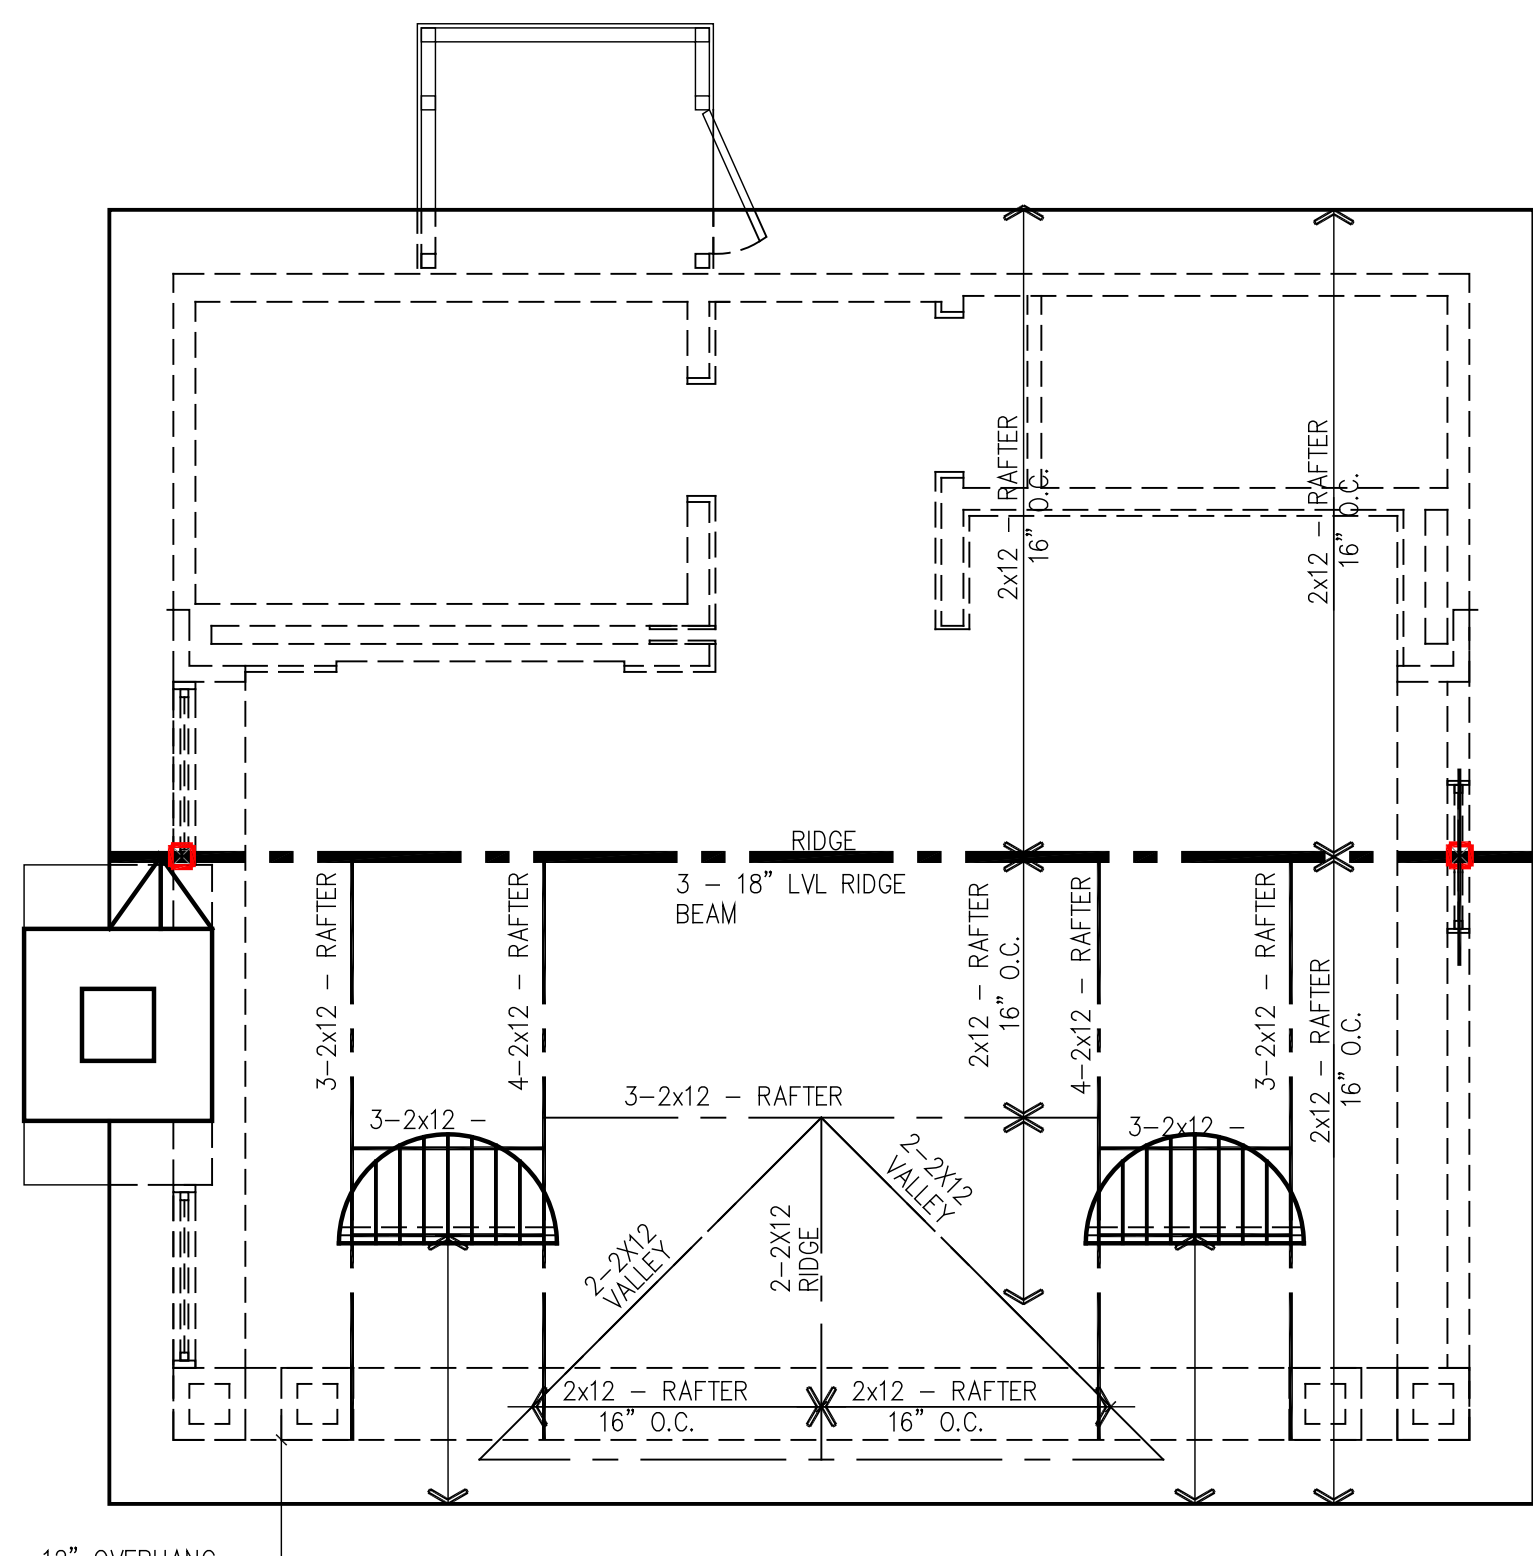

ROOF FRAMING PLAN

SCALE: 1/4" = 1'-0"

NOTE :
SEE ARCHITECTURAL PLANS FOR ALL DIMENSIONAL AND CONSTRUCTION INFORMATION NOT INDICATED ON FRAMING PLANS

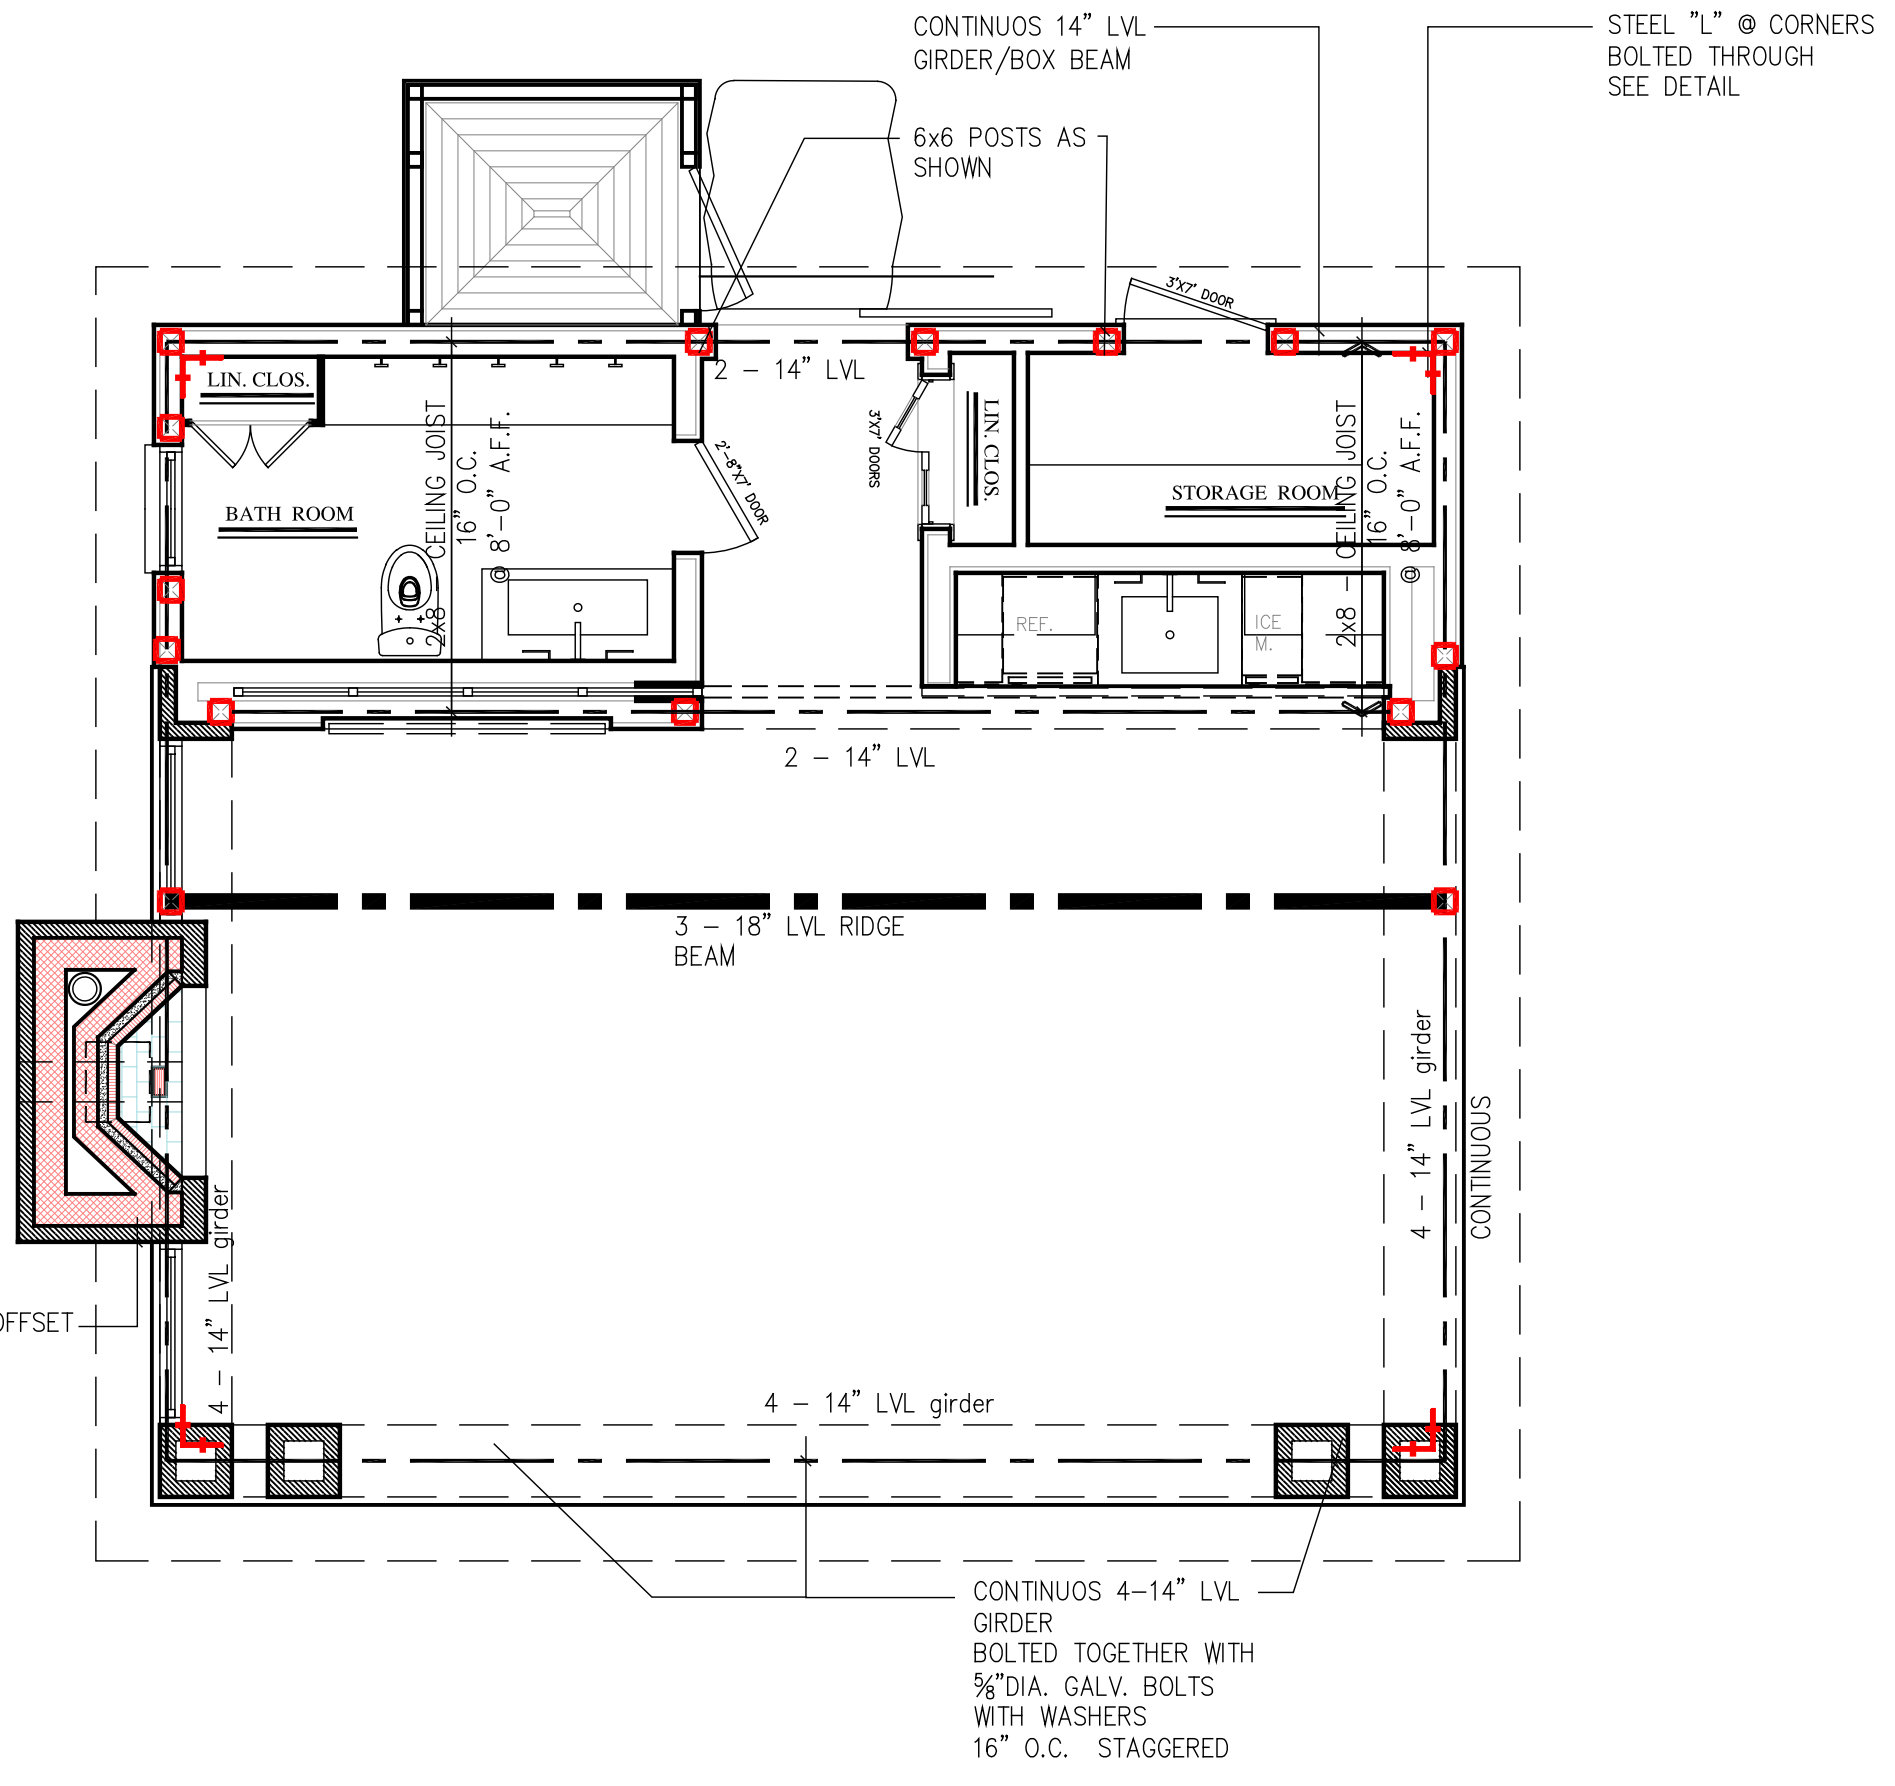

FIRST FLOOR FRAMING PLAN

SCALE: 1/2" = 1'-0"

NOTE :
SEE ARCHITECTURAL PLANS FOR ALL DIMENSIONAL AND CONSTRUCTION INFORMATION NOT INDICATED ON FRAMING PLANS

OWNER PURCHASED ELECTRICAL ITEMS

QUANTITY	DESCRIPTION
4	WALL MOUNTED LIGHT FIXTURE SCENE (WATERPROOF)
2	WALL MOUNTED LIGHT FIXTURE SCENE (BATHROOM)
1	MAIN PENDANT (48" DIA.)
1	UTILITY CEILING MOUNTED (WP.)
2	CEILING FANS (72" DIA.)
5	WELL LIGHTS - "VOLY" LIGHTING, DIRECT BURIAL -LED

ELECTRICAL LEGEND

KEY	PICTURE TYPE	REMARKS
⊕	DUPLEX OUTLET	
⊕	DUPLEX OUTLET (ONE PLUG ACTIVATED BY LIGHT SWITCH)	
⊕	DUPLEX OUTLET (44" A.F.F.) WITH GROUND FAULT INTERRUPT	
⊕	DUPLEX OUTLET FOR APPLIANCE (VOLTAGE AS PER MANUF. SPECS)	
⊕	DUPLEX OUTLET	POP OUT OUTLETS BY "LE GRAND"
⊕	QUAD OUTLET	
⊕	APPLIANCE OUTLET-220V	SEE TO VERIFY APPLIANCE VOLTAGE, AMPERAGE, CONDUCTOR SIZE, GROUND BONDING REQUIREMENTS WITH APPLIANCE MANUFACTURER
⊕	WALL MOUNTED LIGHT SWITCH	
⊕	THREE WAY WALL MOUNTED LIGHT SWITCH	
⊕	WALL MOUNTED LIGHT SWITCH WITH DIMMER	
⊕	THREE WAY WALL MOUNTED LIGHT SWITCH WITH DIMMER	
⊕	3.5"X3.5" SQUARE RECESSED DOWNLIGHT	BY MAC-LED
⊕	3.5"X3.5" SQUARE RECESSED DOWNLIGHT	BY MAC-LED
⊕	PENDANT LIGHT FIXTURE	BY/OWNER T.B.S.
⊕	CEILING MOUNTED LIGHT FIXTURE	BY/OWNER T.B.S.


⊕	WALL MOUNTED LIGHT FIXTURE	
⊕	WALL MOUNTED LIGHT FIXTURE (WATERPROOF)	
⊕	RECESSED LINEAR COVE LIGHTING	LED FIXTURE BY "MAC"
⊕	LINEAR INCANDESCENT COVE LIGHTING	LED FIXTURE BY "MAC"
⊕	LINEAR WALL WASHER	FLANGELESS, LIGHTTOWER
⊕	TRACK LIGHT	FLANGELESS, LIGHTTOWER
⊕	WELL LIGHT	LED FIXTURE BY "MAC"
⊕	ELECTRIC HEATER	
⊕	SMOKE DETECTOR	
⊕	HEAT DETECTOR	
⊕	CARBON MONOXIDE DETECTOR	
⊕	TELEPHONE JACK	
⊕	CABLE T.V. OUTLET	
⊕	MECHANICAL EXHAUST FAN VENTED TO OUTSIDE AIR - CAPACITY AS PER CODE	PANASONIC-QUIET 75 CFM
⊕	FLOODLIGHT HOUSING (DEPENDING AS PER INDICATION)	
⊕	CEILING MOUNTED FAN	BY/OWNER T.B.S.
⊕	CEILING MOUNTED OVERHEAD GARAGE DOOR - MOTORIZED OPENER	
⊕	DISCONNECT SWITCH	

ELECTRICAL NOTES:
1. ALL ELECTRICAL WORK IS TO COMPLY WITH THE NATIONAL ELECTRICAL CODE (NEC) AND ALL OTHER STATE AND LOCAL CODES AND REGULATIONS APPLICABLE THEREIN.
2. ELECTRICAL LAYOUT INDICATED IS SCHEMATIC AND IS FOR BIDDING PURPOSES ONLY. THE ELECTRICAL CONTRACTOR IS TO REVIEW FINAL ELECTRICAL LAYOUT WITH OWNER PRIOR TO START OF WORK.
3. ALL LIGHTING FIXTURES ARE TO BE SELECTED BY THE OWNER.
4. ALL CLOSETS TO HAVE DOOR ACTIVATED SWITCHES FOR CLOSEST LIGHTS UNLESS OTHERWISE INDICATED.
5. ALL NEW OUTLETS AND SWITCHES TO BE "ARCHITECTURAL SERIES" SQUARE/RECTANGULAR UNLESS NOTED OTHERWISE.

FIRST FLOOR LIGHTING PLAN

SCALE: 1/4" = 1'-0"

ALL DOORS TO RECEIVE STAINLESS STEEL HARDWARE

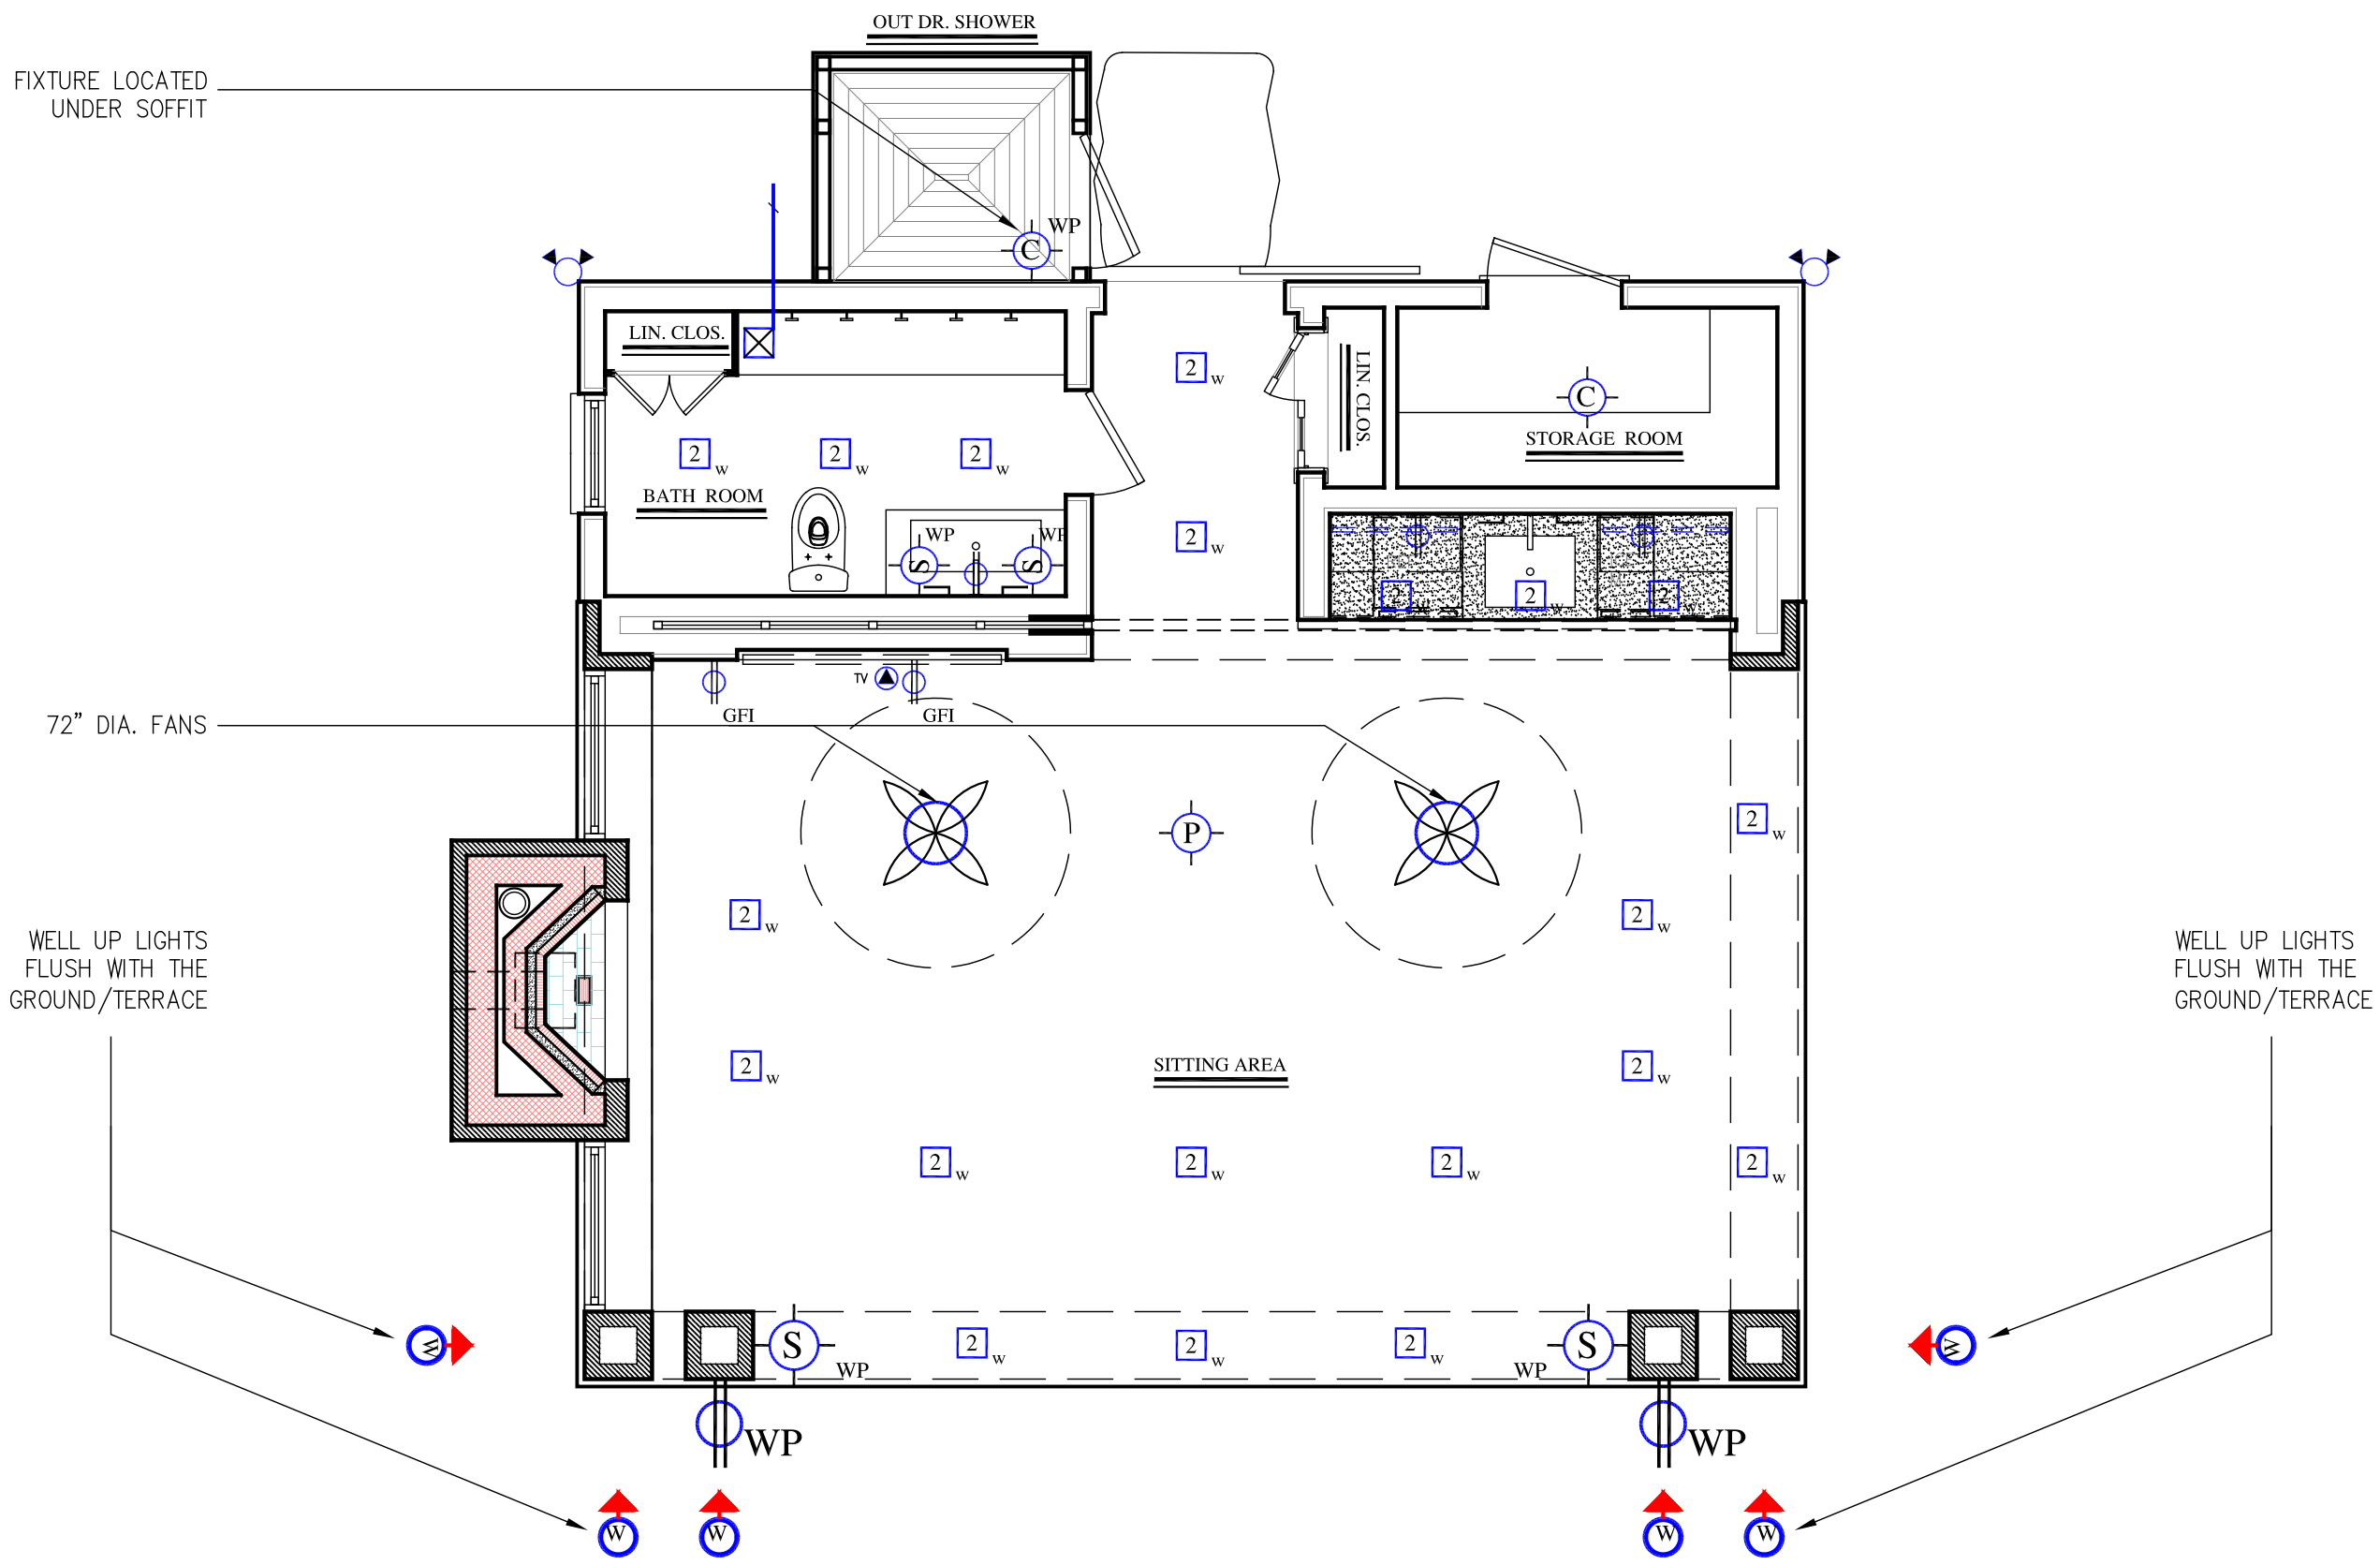

ARCHITECTS
STRUCTURAL ENGINEERS
landscape architect
FLOODSERVICE EQUIPMENT
PROJECT INFORMATION


PROPOSED POOL & CABANA

FOR:
 MR. & MRS. KIRSCHNER

8 SPRUCE HILL RD.
 ARMONK, NY

No.	Revision	Date	Description
10-16-20	D.O.B.		SUBMISSION
-	-	-	-
-	-	-	-
-	-	-	-
-	-	-	-
-	-	-	-
-	-	-	-
-	-	-	-
-	-	-	-

DRAWINGS AND SPECIFICATIONS AS INSTRUMENTS OF PROFESSIONAL SERVICE ARE AND SHALL REMAIN THE PROPERTY OF STUDIO RAI ARCHITECTS. ANY REUSE OR REPRODUCTION OF ANY PART OF THESE DRAWINGS WITHOUT THE WRITTEN CONSENT OF STUDIO RAI ARCHITECTS IS PROHIBITED.

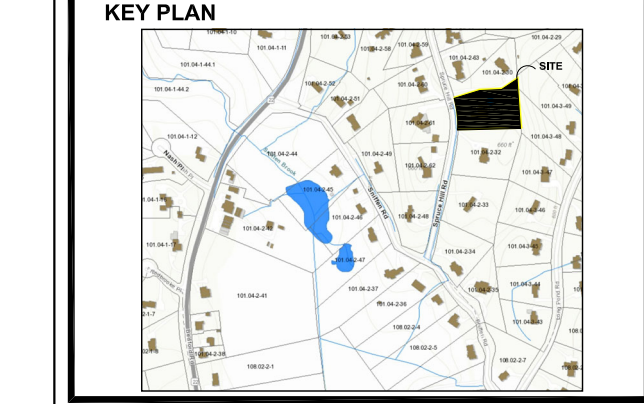

POOL PLAN AND DETAILS

DRAWING TITLE

P-1

DRAWING NUMBER

ISSUE DATE: 10-16-20

BY: J.L.B.

PROJECT NO: 1

SCALE: 1/4" = 1'-0"

AS NOTED

SEAL/SIGNATURE

GENERAL NOTES:

NOTE:
 WRITTEN CONTRACTUAL AGREEMENT BETWEEN CARDILLO POOLS & SPAS, LLC AND OWNER OVER RULES THE FOLLOWING SPECIFICATIONS.

1. VERIFICATION :

- PRIOR TO EXCAVATION, CONTRACTOR IS TO NOTIFY AGENCY WHICH HAS JURISDICTION TO FIELD LOCATE AND MARK LOCATIONS OF BURIED UTILITIES WITHIN AREA OF WORK TO BE PERFORMED.
- CONTRACTOR MUST VERIFY SOIL CONDITIONS PRIOR TO COMMENCING WORK. IF SOIL CONDITIONS ARE NOT ADEQUATE FOR BEARING AND VIRGIN SOIL NOT OBTAINABLE WITHIN POOL EXCAVATION DESIGN, CONTRACTOR MUST RETAIN SOIL AND STRUCTURAL ENGINEER TO DESIGN APPROPRIATE POOL STRUCTURE FOR FIELD CONDITIONS AND NOTIFY ARCHITECT.

2. APPROVALS :

- NO WORK SHALL COMMENCE PRIOR TO OBTAINING REQUIRED PERMITS.
- POOL CONTRACTOR SHALL OBTAIN ALL NECESSARY PERMITS AND APPROVALS AS REQUIRED BY THE BLDG. DEPT. OF SCARSDALE, N.Y.
- POOL CONTRACTOR SHALL ARRANGE FOR ALL REQUIRED INSPECTIONS AND APPLY FOR AND SECURE FINAL CERTIFICATE OF OCCUPANCY.
- ALL CONSTRUCTION TO COMPLY WITH ALL APPLICABLE SECTIONS OF THE N.Y.S. BUILDING AND RESIDENTIAL CODE LATEST EDITION 2007.
- ALL ELECTRICAL WORK SHALL BE EXECUTED BY A LICENSED ELECTRICIAN.
- ALL PLUMBING WORK SHALL BE EXECUTED BY A LICENSED PLUMBER.
- POOL AND FOUNTAIN SHALL BE GROUNDED IN STRICT ACCORDANCE WITH THE LATEST EDITION OF THE NATIONAL ELECTRICAL AND STATE BOARD OF FIRE UNDERWRITERS AND ALL APPLICABLE SECTIONS OF THE N.Y.S. BUILDING CODES.

3. EXCAVATION AND GRADING :

- ALL EXCAVATED SOIL MATERIAL FROM POOL DIG SHALL BE TEMPORARILY STOCK PILED AND REGRADED AS DIRECTED AND AS REQUIRED.

4. EQUIPMENT :

- POOL CONTRACTOR SHALL SUPPLY AND INSTALL ALL EQUIPMENT NECESSARY TO OPERATE THE POOL, SPA AND ALL RELATED EQUIPMENT, INCLUDING ALL ELECTRICAL, GAS AND PLUMBING CONNECTIONS INCLUDING ALL TRENCHING.
- POOL CONTRACTOR SHALL SUPPLY AND INSTALL ALL ITEMS SHOWN ON THESE PLANS INCLUDING BUT NOT LIMITED TO :
 - A) 2 (TWO) IN - WALL SKIMMERS AND FIVE RETURNS BY "HAYWARD PRODUCTS INC."
 - B) 2 (TWO) UNDERWATER LIGHT FIXTURES EACH BEING A 300W, 110V BY "AMERICAN PRODUCTS" (IN POOL).
 - C) 1 (ONE) UNDERWATER LIGHT FIXTURE BEING A 300W, 110V BY "AMERICAN PRODUCTS" (IN SPA).
 - D) FILTER SHALL BE A 72 SQUARE FOOT DE BY "PAC FAB" WITH 2 (TWO) - 2 HP PUMPS AND A SEPARATION TANK.
 - E) A 400,000 B.T.U. HEATER BY "TELEDYNE LAARS".
 - F) AN AUTOMATIC POOL FILLER BY "POOL MIZER".
 - G) AN AUTOMATIC COMPUTER SYSTEM FOR POOL OPERATION BY "JANDY".
 - H) 2 (TWO) 8" MAIN FLOOR DRAINS WITH HYDROSTATIC PRESSURE VALVES.
 - I) AN OVERFLOW POOL DRAIN LOCATED IN A SKIMMER UNIT.
 - J) 1 (ONE) CHEMICAL FEEDER.
 - K) PROVIDE ONE EACH OF THE FOLLOWING :
 HAND SKIMMER - WALL BRUSH - THERMOMETER
 TEST KIT - MANUAL CLEANER UNIT WITH A 50 FOOT HOSE AND A 16 FOOT TELESCOPE POLE HANDLE.
 - L) ALL ELECTRICAL SWITCHES FROM HOUSE TO POOL & SPA AS DIRECTED BY: OWNER.
- ALL ITEMS NOT GIVEN A MANUFACTURER AND CATALOGUE NUMBER SHALL BE THE LATEST MODEL AVAILABLE FOR THAT ITEM.

5. FILTER BACKWASH AND DRAINAGE :

- POOL FILTRATION SYSTEM TO BE EQUIPPED WITH A SEPARATION TANK TO ENSURE MINIMAL WATER LOSS DURING BACKWASH.
- POOL WATER SHALL BE TRUCKED IN FOR INITIAL FILL UP AS PER WRITTEN CONTRACTUAL AGREEMENT.

6. STRUCTURE :

- GUNITE WALLS AND POOL FLOOR SHALL BE A MINIMUM OF 4,000 P.S.I. WITH A MINIMUM WALL THICKNESS OF 8" AND A CONTINUOUS BEAM OF 12" WIDE AT POOL PERIMETER (SEE DETAILS - THIS SHEET).
- REINFORCING BARS FOR POOL SHALL BE SIZED AND SPACED AS PER REINFORCING DETAILS ON THIS SHEET.

7. POOL AND SPA DEPTH :

- POOL WATER DEPTH SHALL BE AS INDICATED ON PLAN @ SHALLOW END @STEPS. AND SHALL BE AS DEEP AS INDICATED ON SECTION - AA AT DEEP END.
- SPA WATER DEPTH AS SHOWN ON PLAN.

8. TILE AND PLASTER :

- BORDER TILES SHALL BE 6" X 6" FROST TILE. POOL CONTRACTOR SHALL SUBMIT COLOR SAMPLES TO OWNER FOR SELECTION.
- TILE GROUT COLOR SHALL MATCH POOL PLASTER COLOR.
- POOL AND SPA INTERIOR PLASTER COLOR SHALL BE AS PER OWNER AND AGREED UPON SELECTION.

9. POOL ENCLOSURE :

- AS LOCAL TOWN CODE AND STATE CODE (MOST STRINGENT CODE GOVERNS)
- APPENDIX "G" OF THE LATEST RESIDENTIAL AND STATE CODE.
- SWIMMING POOL NECESSARY EQUIPMENT SHALL BE PROVIDED WITH AN ENCLOSURE WHICH SHALL BE A MINIMUM OF 4 (FOUR) FEET IN HEIGHT AND HAVE A MAXIMUM VERTICAL CLEARANCE TO GRADE OF 2 (TWO) INCHES. MAXIMUM BALLSTRADES 4" O.C.
- ENCLOSURE SHALL BE CONSTRUCTED SO AS NOT TO PROVIDE FOOTHOLDS. SHALL HAVE RAILINGS AND POSTS WITHIN THE ENCLOSURE WHICH SHALL BE CAPABLE OF RESISTING A MINIMUM LATERAL LOAD OF 150 LBS. APPLIED MIDWAY BETWEEN POSTS AND AT THE TOP OF POSTS RESPECTIVELY.
- GATES PROVIDED IN THE ENCLOSURE SHALL BE SELF - CLOSING AND SELF - LATCHING WITH THE LATCH HANDLE LOCATED WITHIN THE ENCLOSURE AND AT LEAST 48 INCHES ABOVE GRADE.



10. POOL ENTRANCES FROM RESIDENCE & POOL ALARM:

- A WALL OF A DWELLING IS PERMITTED TO SERVE AS PART OF THE ENCLOSURE UNDER THE CONDITIONS AS PER N.Y. STATE SWIMMING POOL CODE APPENDIX "G" OF THE LATEST RESIDENTIAL AND STATE CODE.
- PROVIDE POOL ALARM AS PER STATE AND LOCAL CODE. POOL PATROL POOL ALARM WITH REMOTE RECEIVER (MODEL PA-30)
- ALL DOORS LEADING TO POOL PATIO TO BE SELF CLOSING, SELF LATCHING AND ALARMED LATCH TO BE LOCATED 54" A.F.F.
- ALL GATES MUST BE SELF-CLOSING SELF LATCHING.
- ALL GATES MUST OPEN OUTWARD OF POOL AWAY FROM POOL.
- POOL TO HAVE A POWER SAFETY COVER IN COMPLIANCE WITH REFERENCE STANDARD (ASTM F1346)

ARCHITECT CERTIFICATION :

STUDIO RAI, ARCHITECTURAL DESIGN P.C. IS NOT RESPONSIBLE FOR ACCURACY OF EXISTING CONDITIONS, ZONING REQUIREMENTS AND COMPLIANCE.


STUDIO RAI, ARCHITECTURAL DESIGN P.C. IS NOT RETAINED FOR CONSTRUCTION ADMINISTRATION AND OR SUPERVISION.

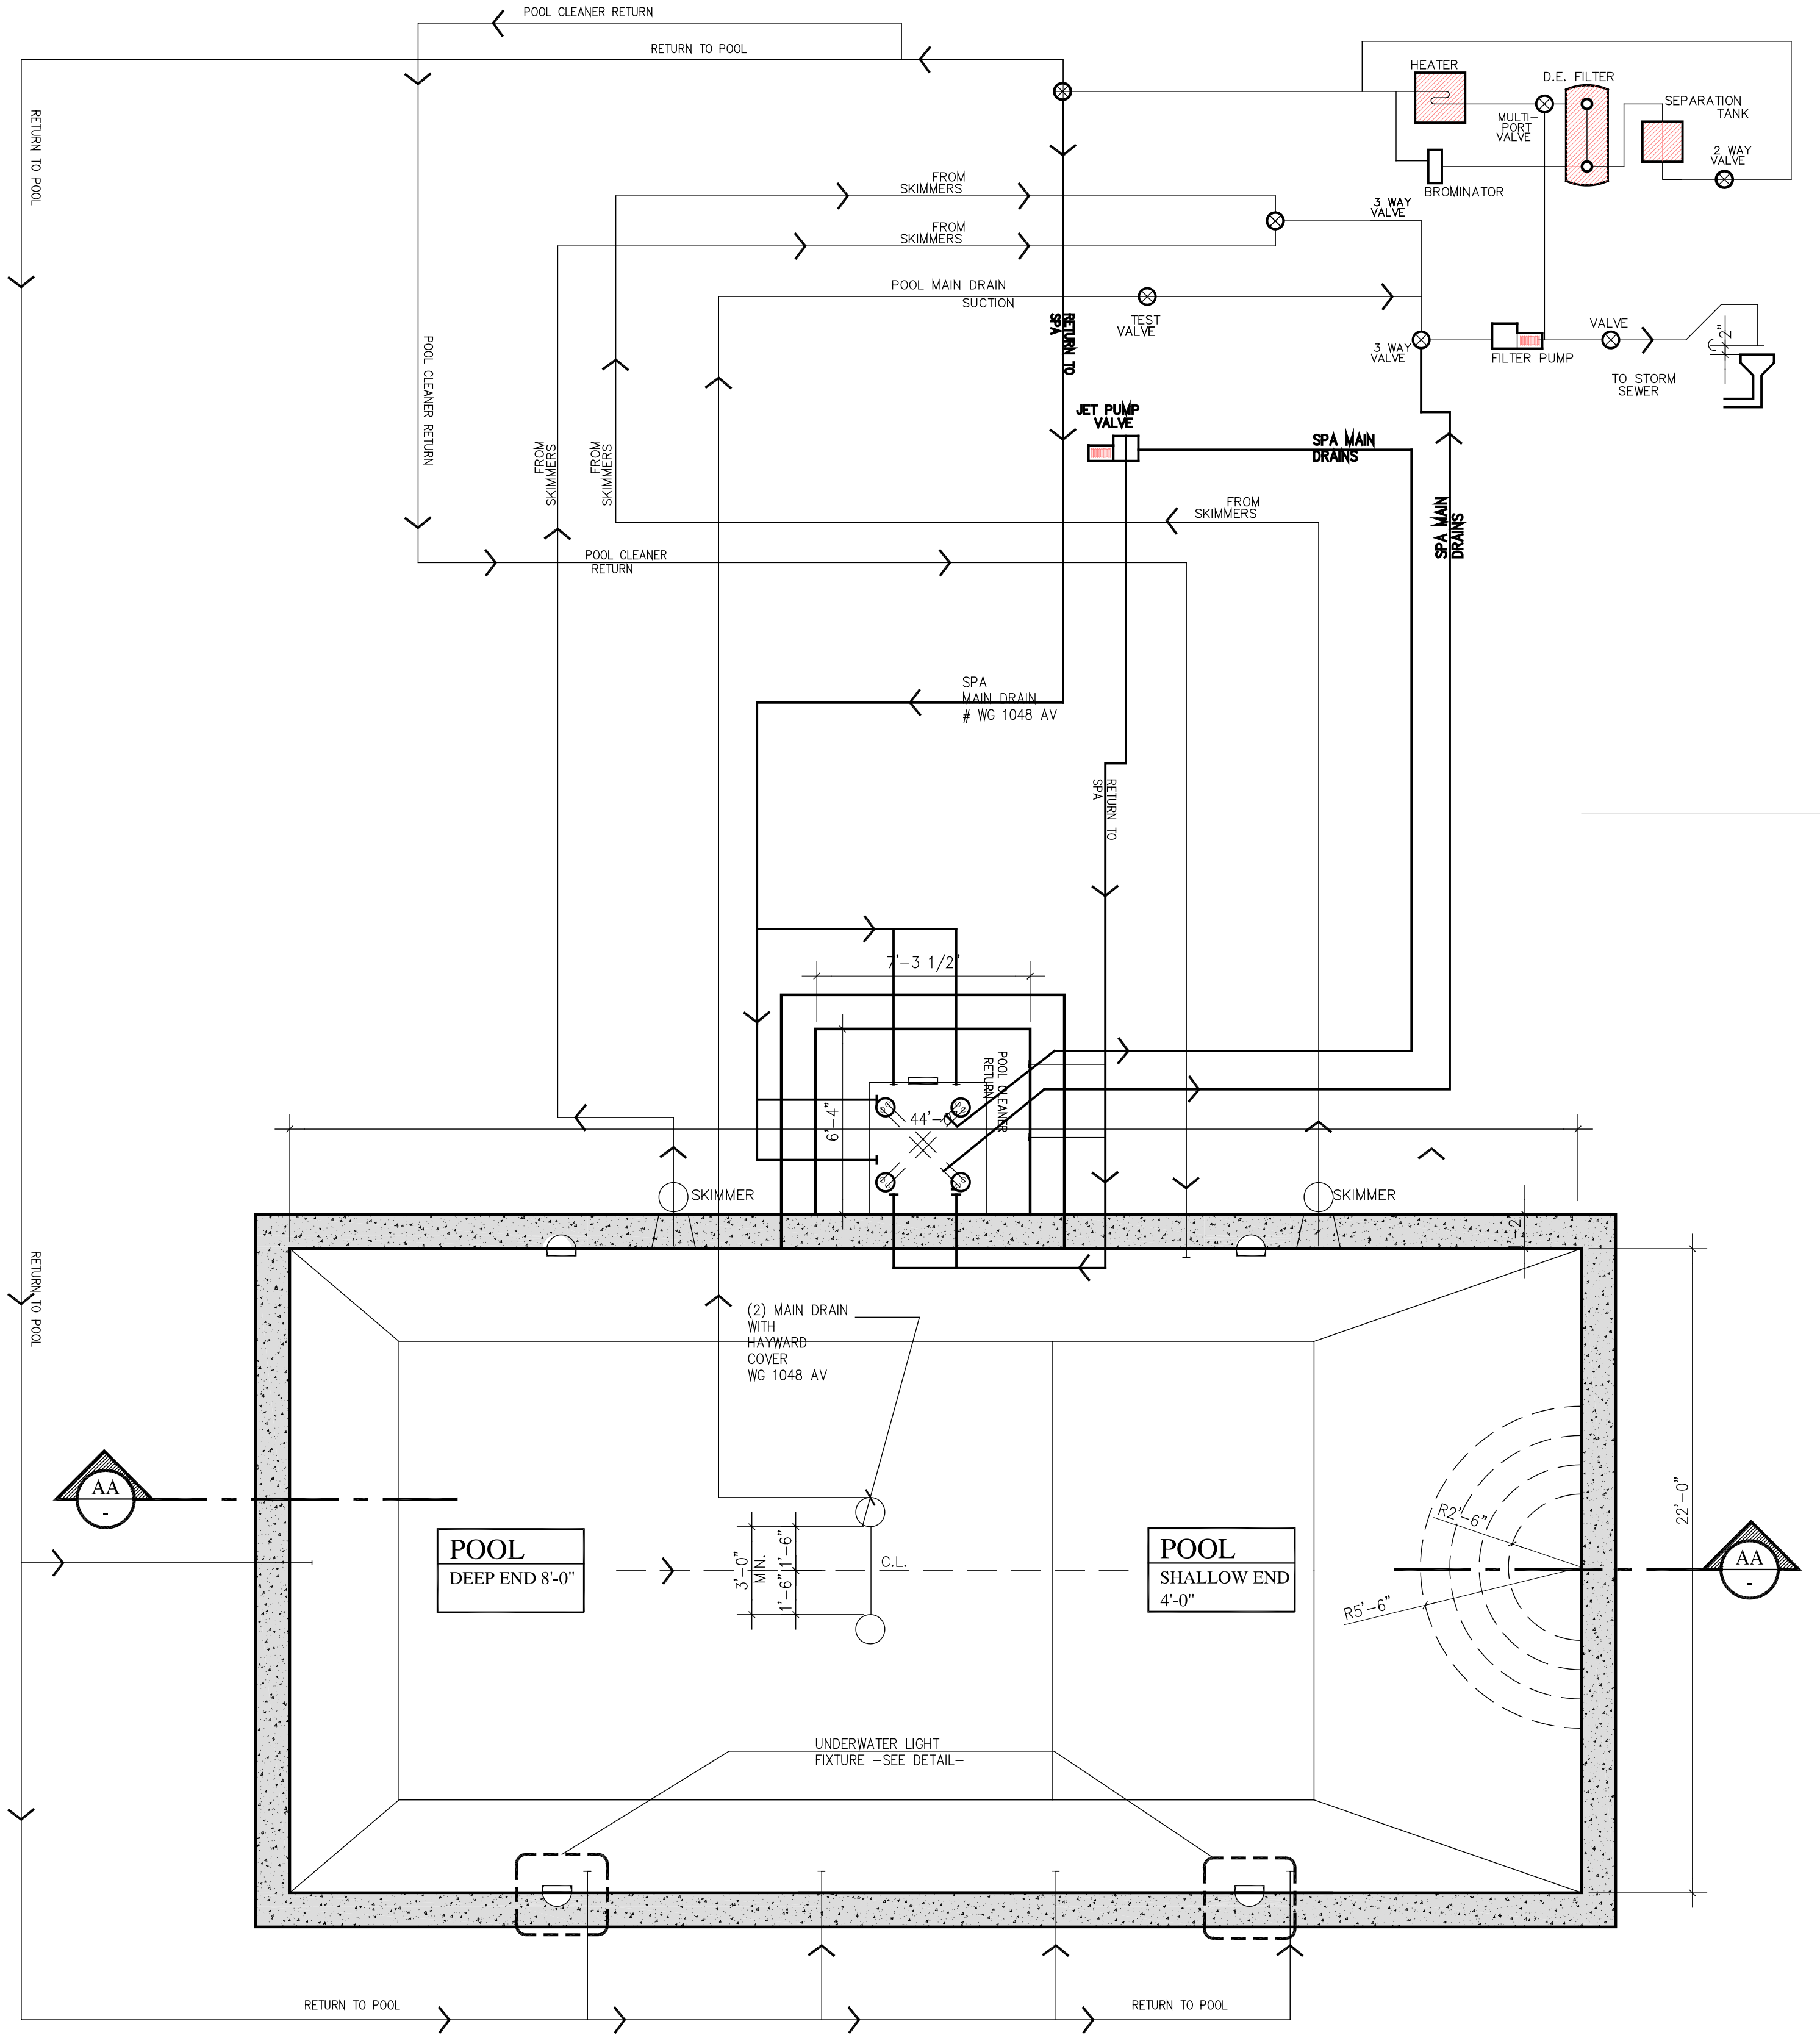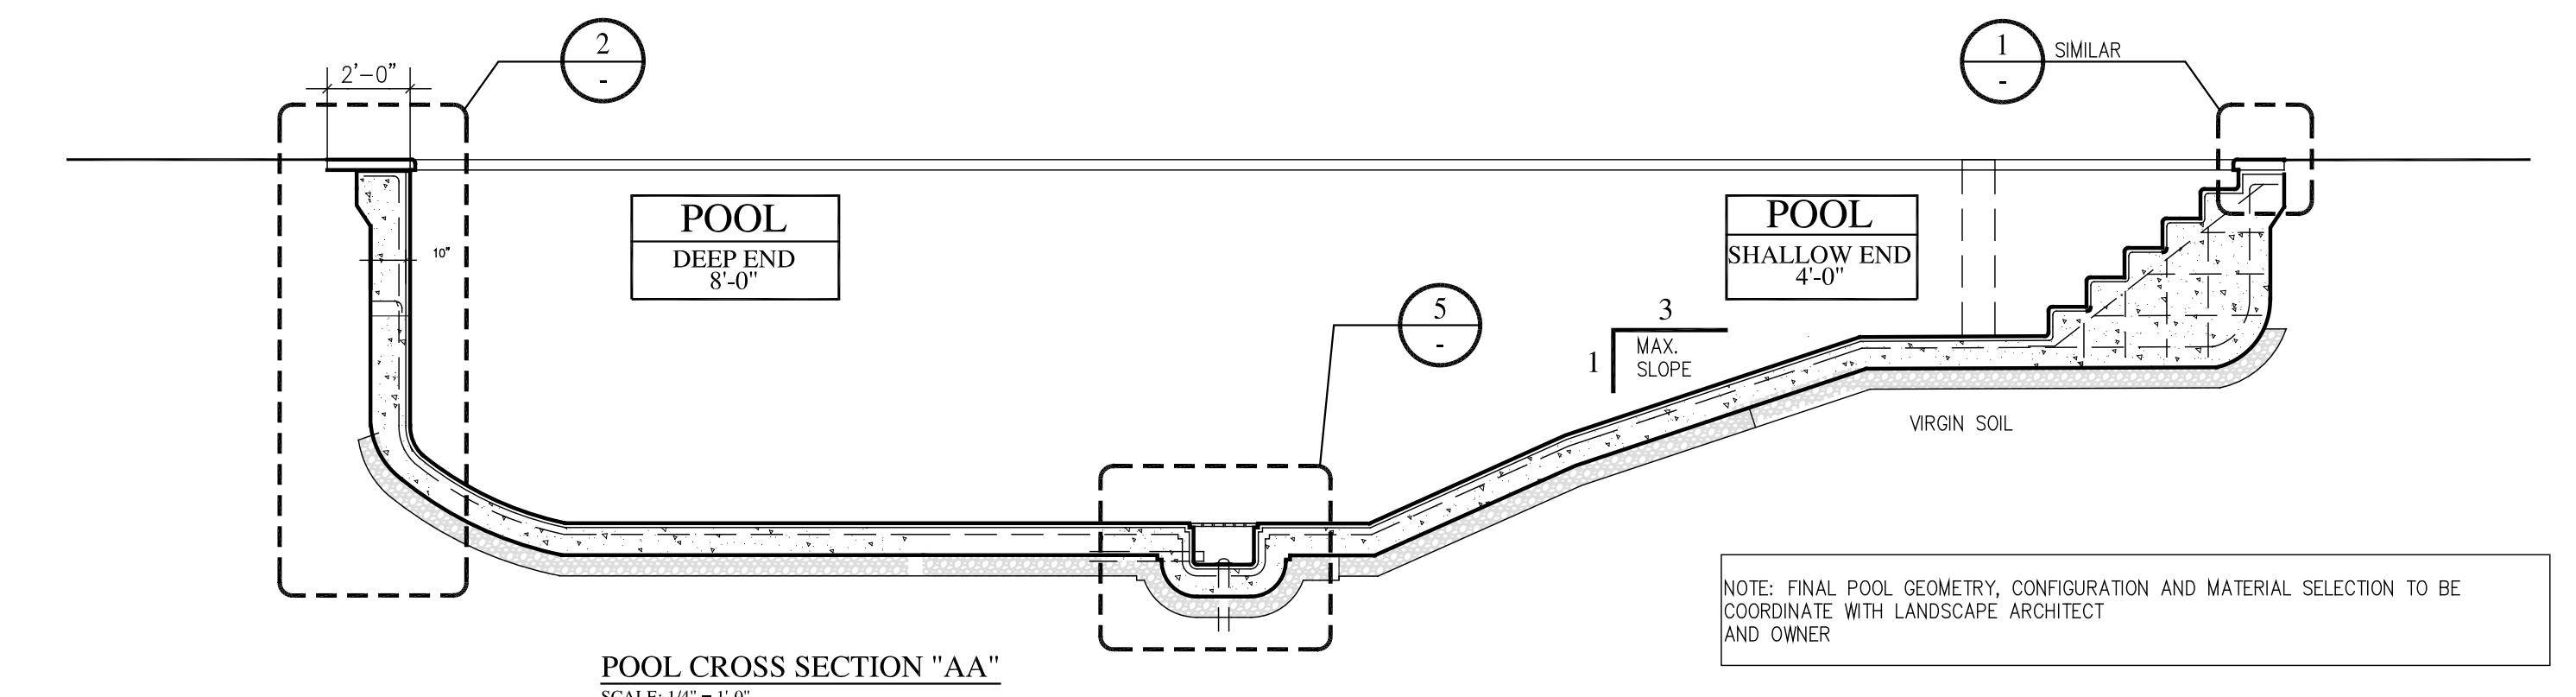

PLUMBING SCHEMATIC DIAGRAM
 SCALE: 1/4" = 1'-0"

DIAGRAM IS FOR GENERAL INFORMATION ONLY. LICENSE PLUMBER TO CONFORM WITH LATEST NEW YORK STATE POOL CODE APPENDIX "G", PLUMBING, GAS AND ALL SECTIONS PERTAINING TO POOL REQUIREMENTS AND COMPLIANCE.

NOTE:
 POOL PROVIDED WITH DUAL DRAINS WITH 3'-0" SEPARATION AS PER SECTION-G106.4

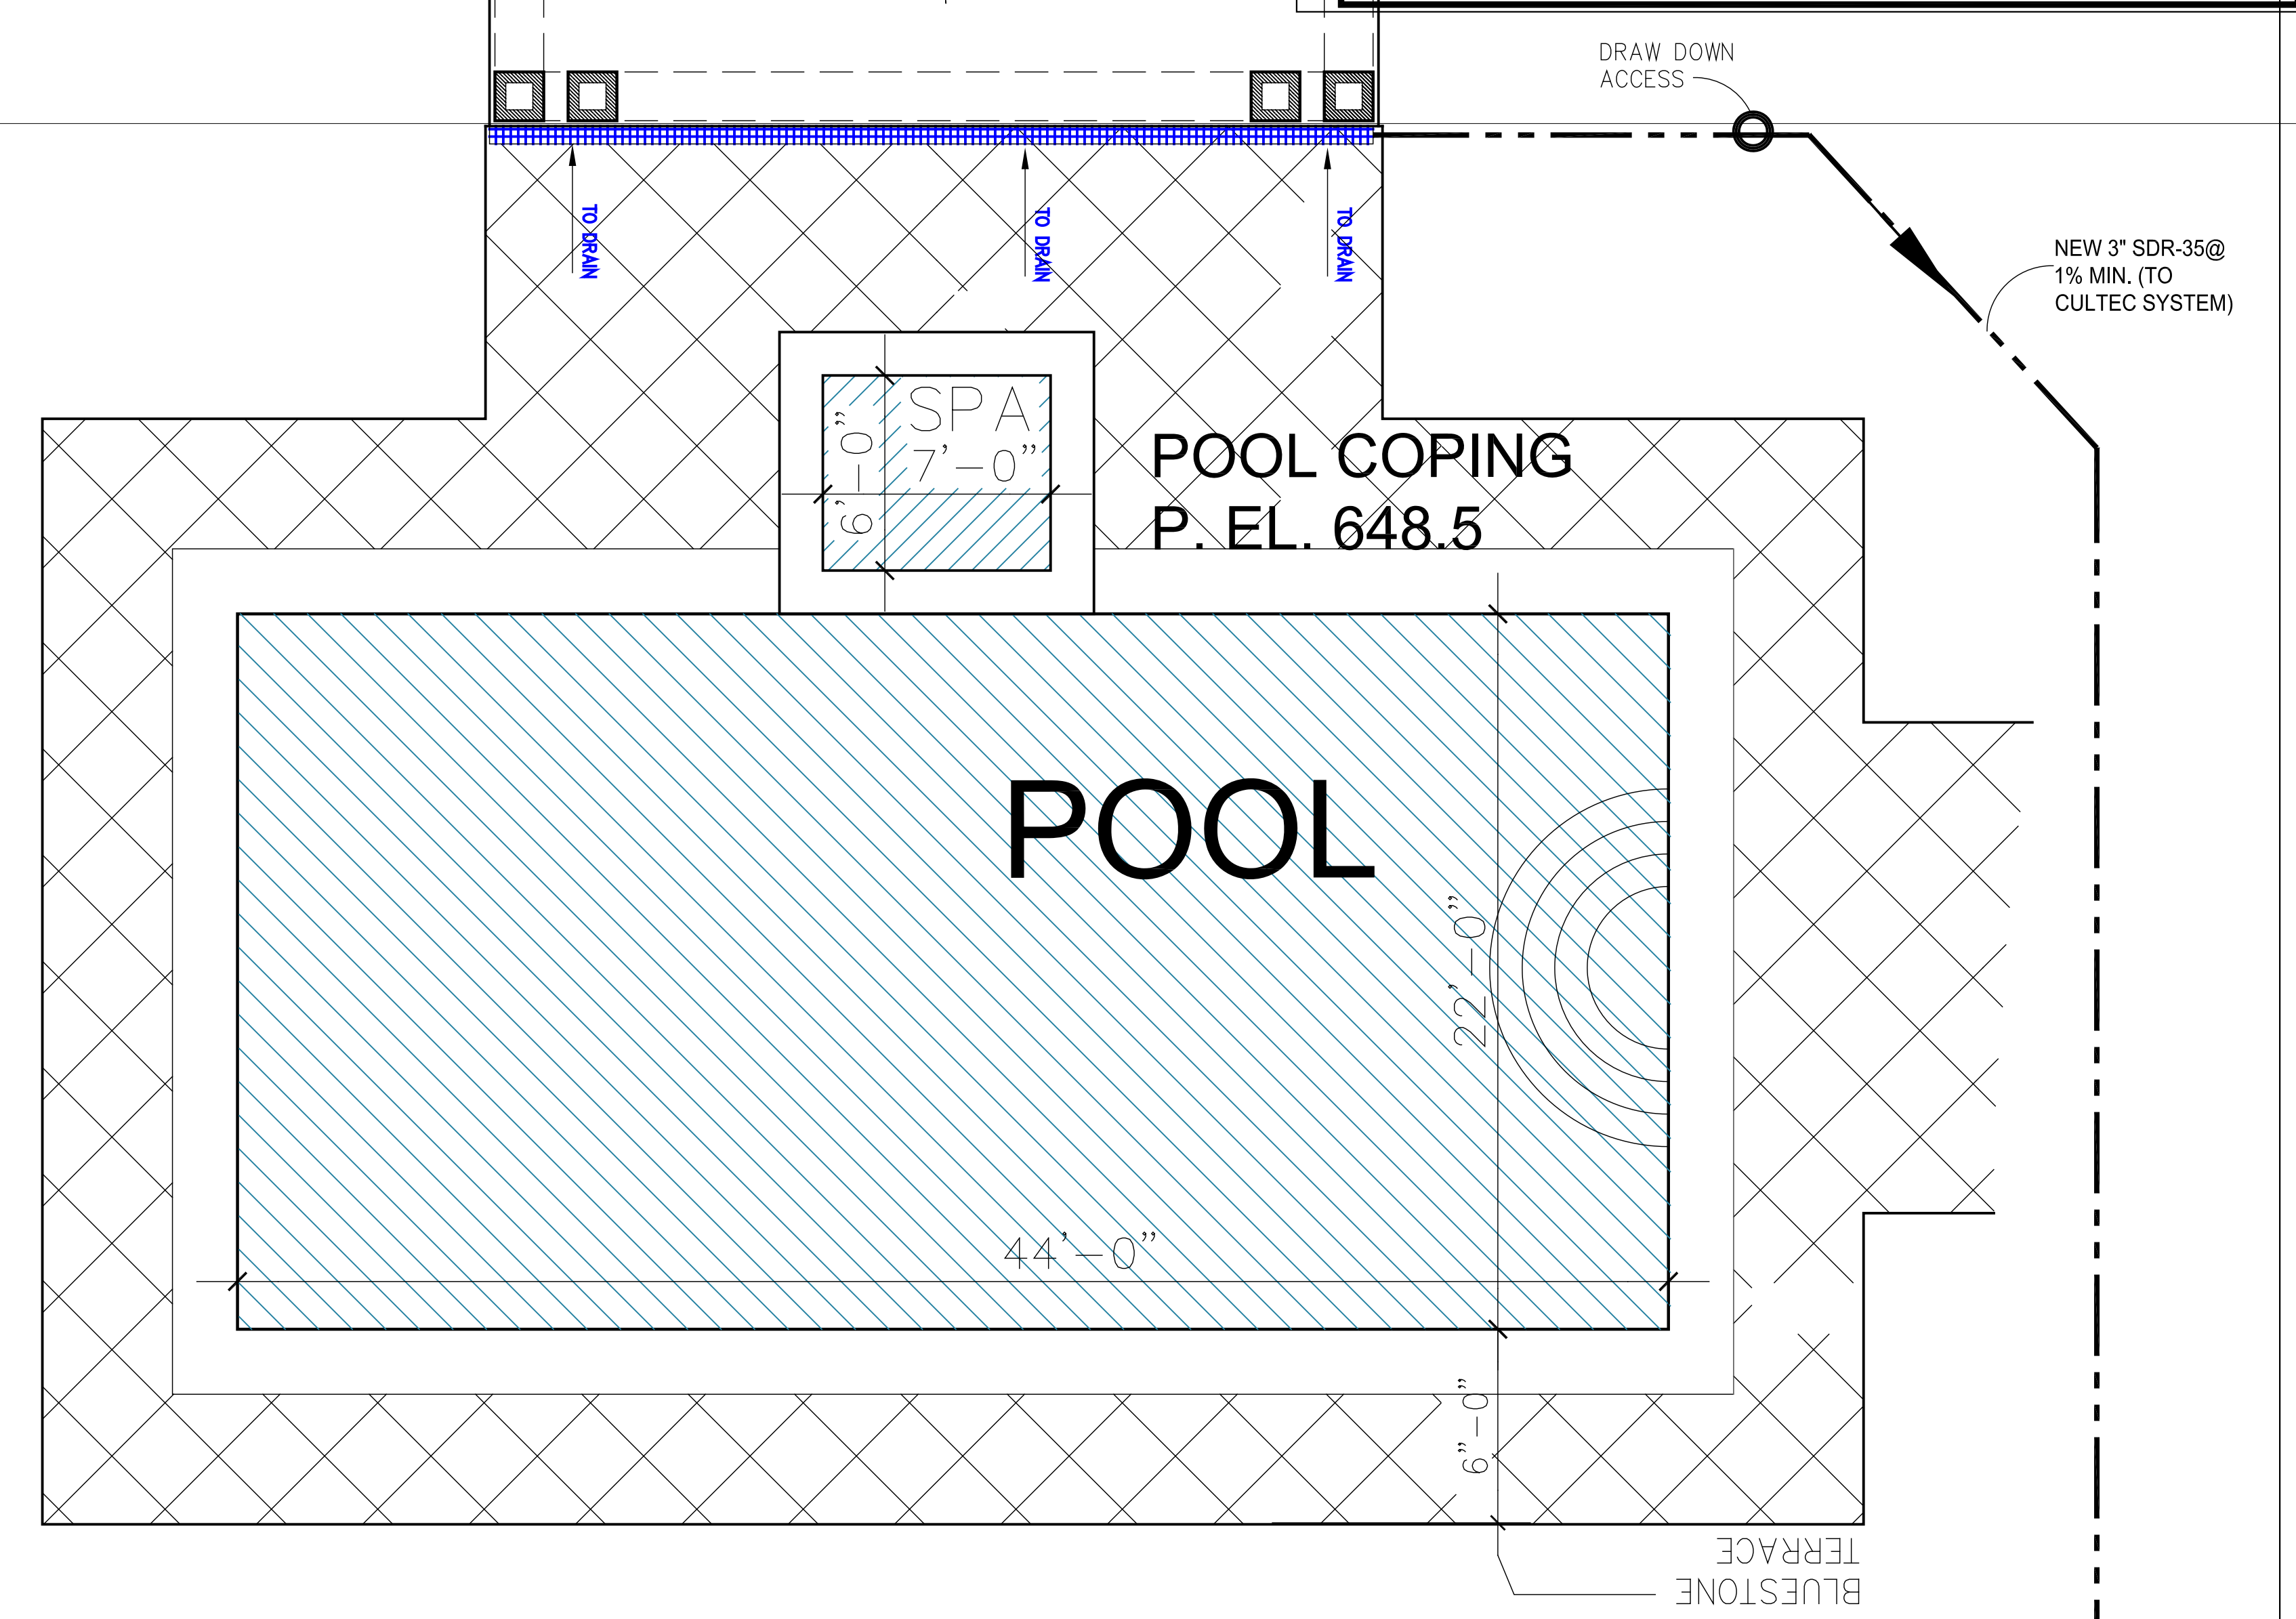


POOL AND SPA PLAN
 SCALE: 1/4" = 1'-0"

KIRSCHNER RESIDENCE
8 SPRUCE HILL RD.

TOTAL AREA SHOWN= 7,027.35 SQ. FT.
MAX. ALLOWABLE= 9,954.9 SQ. FT.

PROPOSED
POOL CABANA
650.35 SQ FT

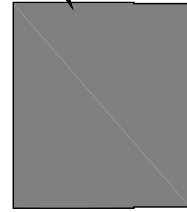


PORCH
159.53 SQ FT

PORCH
143.9 SQ FT

1ST. FLOOR
2,952.27 SQ. FT.

3 GARAGE
792.43 SQ. FT.

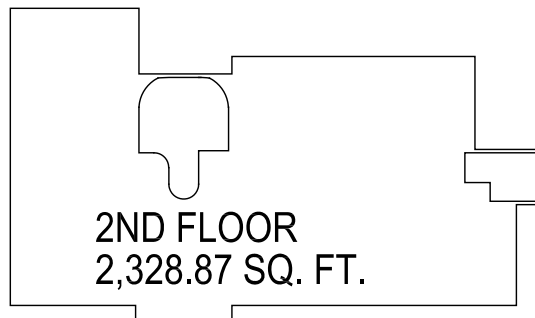


2ND FLOOR
2,328.87 SQ. FT.

FLOOR AREA DWG

KIRSCHNER RESIDENCE
8 SPRUCE HILL RD.

TOTAL COVERAGE SHOWN= 12,348.23 SQ. FT.
MAX. ALLOWABLE= 13,198 SQ. FT.

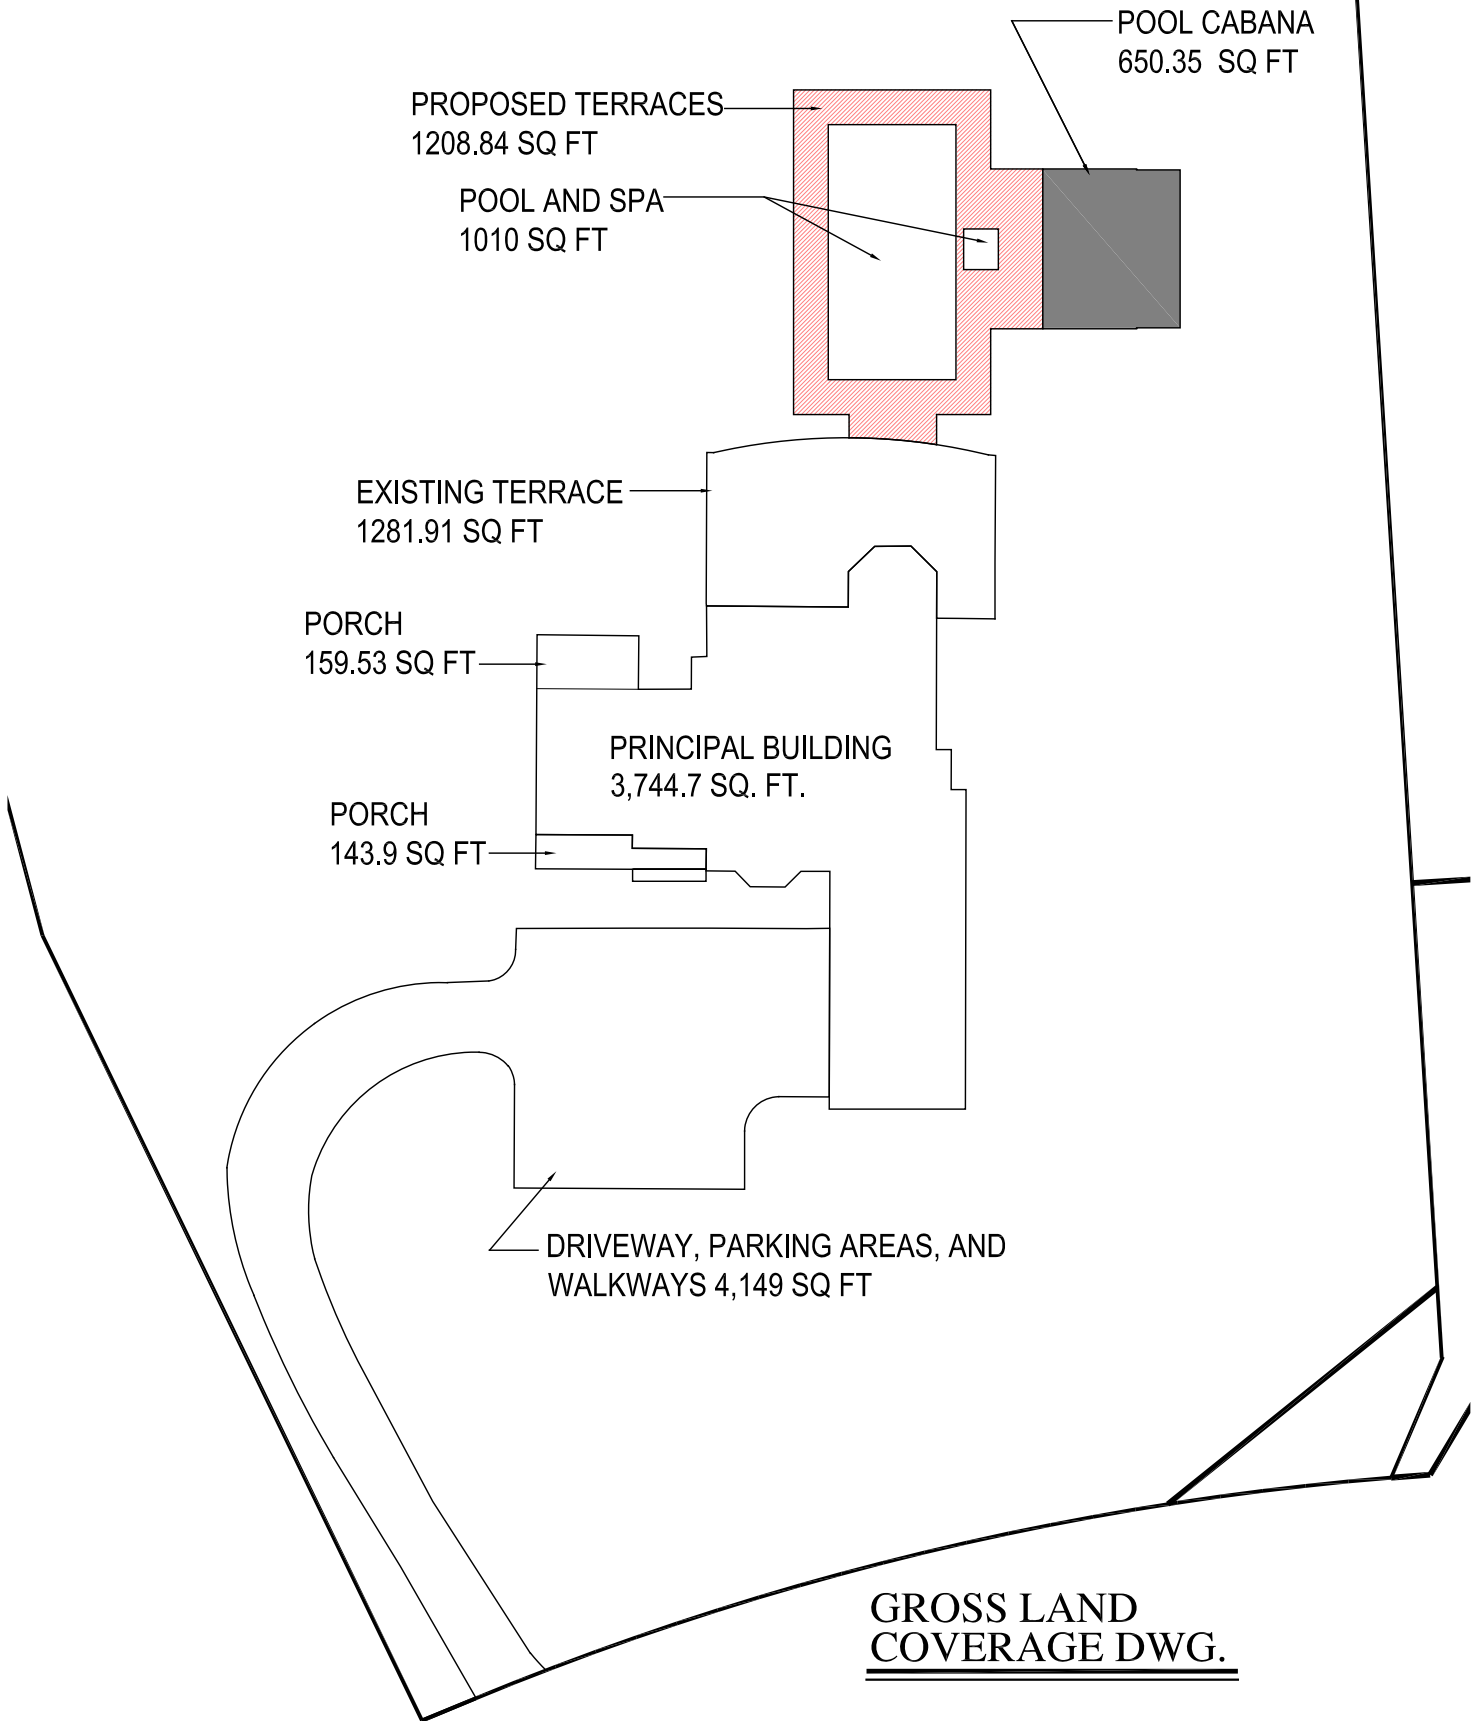



NADERMAN
LAND PLANNING AND ENGINEERING, P.C.

BARRY G. NADERMAN, P.E.

VIA HAND DELIVER

December 16, 2010

Planning Board
Town of North Castle
15 Bedford Road
Armonk, NY 10504

Attn: Mr. Richard Fon – Building Inspector

Re: Proposed Kirschner Residence
8 Spruce Hill Road
Town of North Castle
Sec. 1; Blk. 4; Lot 10-2

Dear Mr. Fon:

Enclosed find three (3) copies of the following for a submission for review by the Residential Project Review Committee for the tears down and construction of a new residence at the above referenced property:

- Partially Completed Building Permit Application
- RPRC Review Form
- Dwg SP-1 "Residential Site Plan" dated 12/14/10
- Dwg SP-2 "Profile/ Details" dated 12/14/10
- Dwg L-1 "Landscape Plan" dated December 14, 2010 prepared by Pouder Design Group
- Architectural Plans prepared by RAI Studio
- Gross Land Coverage Calculation Worksheet and Exhibit dated 12/14/10
- Floor Area Calculation Worksheet and exhibit prepared by Studio RAI
- Infiltration Design Computations dated December 2010

We are filing at this time as requested for review by the Residential Project Review Committee for the tear down and construction of a single family residence with associated driveway improvements, drainage and landscaping.

We have also provided the Stormwater Calculations for the infiltration system provided which also include the pool drawdown requirements. Be advised the deep hole and percolation testing for the infiltration bed has already been witnessed by the Town Engineer's office.

Town of North Castle
Building Department
October 13, 2010
Page 2

The residence is served by municipal water and an individual septic system. As such, a new septic is proposed to serve the residence. All testing for the septic has also been completed and witnessed by the Westchester County Department of Health and a full application and design will be submitted shortly.

Upon review, should you require any additional information, or have any questions, please feel free to call.

Respectfully,

A handwritten signature in black ink, appearing to read 'Barry G. Naderman', with a long horizontal flourish extending to the right.

Barry G. Naderman, P.E.
Naderman Land Planning & Engineering, P.C.

cc: Sam Kirschner w/ enc.

5555RPPRCsubm



TOWN OF NORTH CASTLE

WESTCHESTER COUNTY
17 Bedford Road
Armonk, New York 10504-1898

PLANNING BOARD
Peg Michelman, Chair

Telephone: (914) 273-3542
Fax: (914) 273-3554
www.northcastleny.com

GROSS LAND COVERAGE CALCULATIONS WORKSHEET


Application Name or Identifying Title: Kirshner Residence Date: 12/15/10

Tax Map Designation or Proposed Lot No.: Sec 1, Blk. 4, Lot 10-2


Gross Lot Coverage

- 1. Total lot Area (Net Lot Area for Lots Created After 12/13/06): 83,759
- 2. Maximum permitted gross land coverage (per Section 213-22.2C): 12,968
- 3. BONUS maximum gross land cover (per Section 213-22.2C):
- Distance principal home is beyond minimum front yard setback
23 x 10 = 230
- 4. TOTAL Maximum Permitted gross land coverage = Sum of lines 2 and 3 13,198
- 5. Amount of lot area covered by principal building:
0 existing + 4175 proposed = 4,175
- 6. Amount of lot area covered by accessory buildings:
0 existing + 0 proposed = —
- 7. Amount of lot area covered by decks:
0 existing + 0 proposed = —
- 8. Amount of lot area covered by porches:
0 existing + 100 proposed = 100
- 9. Amount of lot area covered by driveway, parking areas and walkways:
0 existing + 4149 proposed = 4,149
- 10. Amount of lot area covered by terraces:
0 existing + 2391 proposed = 2,391
- 11. Amount of lot area covered by tennis court, pool and mechanical equip:
0 existing + 799 proposed = 799
- 12. Amount of lot area covered by all other structures:
0 existing + 0 proposed = —
- 13. Proposed gross land coverage: Total of Lines 5 – 12 = 11,614

If Line 13 is less than or equal to Line 4, your proposal complies with the Town's maximum gross land coverage regulations and the project may proceed to the Residential Project Review Committee for review. If Line 13 is greater than Line 4 your proposal does not comply with the Town's regulations.

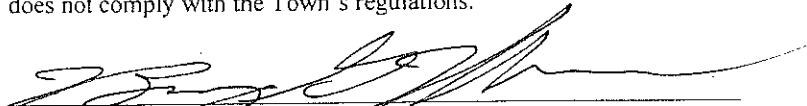
Signature and Seal of Professional Preparing Worksheet

12/15/10
Date


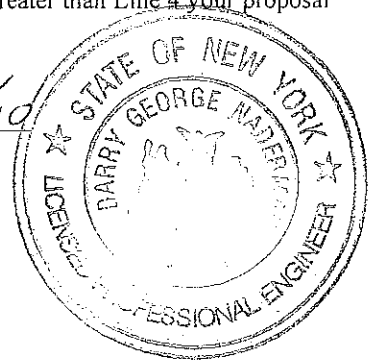


(8P) - INDICATES ITEM # ON
COVERGE CALCULATION
WORKSHEET

Total Coverage Shown = 11,644 sf
(Max. Allowable = 13,198 sf)

12/15/10
Scale 1"=40'


COVERGE EXHIBIT
with Pool
KIRSCHNER RESIDENCE
8 SPRUCE HILL ROAD
Town of North Castle

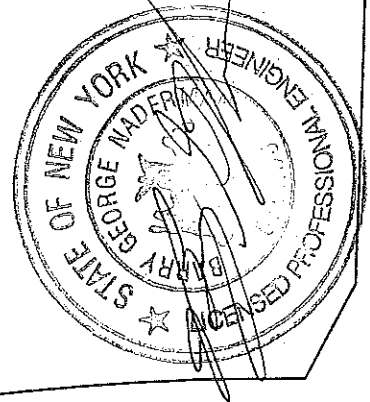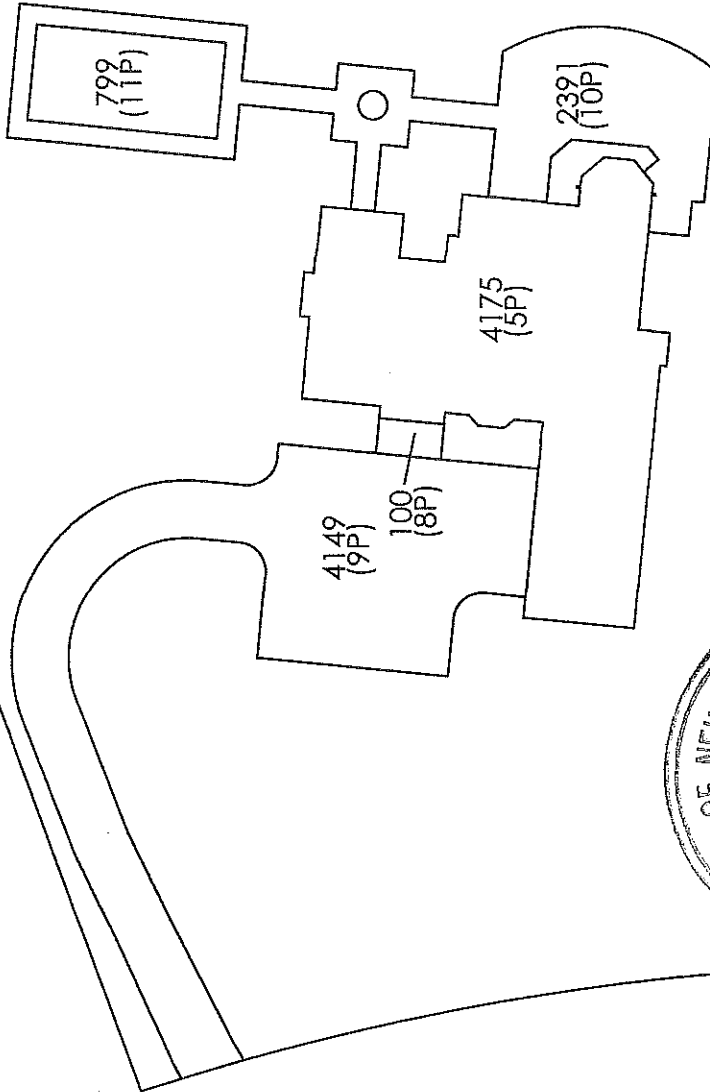

CULTEC Recharger® 330 XL Chamber Specification Information

Length	feet	8.5
	meters	2.59
Installed Length	feet	7 *
	meters	2.13
Length Adjustment	feet	1.5
	meters	.46
Width	inches	52
	mm	1321
Height	inches	30.5
	mm	775
Chamber Storage Capacity	ft ³ /ft	7.459
	m ³ /m	.69
	ft ³ /unit	52.21
	m ³ /unit	1.48
Min. Storage Capacity Surrounded in Stone ¹	ft ³ /ft	11.32 *
	m ³ /m	1.05
	ft ³ /unit	79.26
	m ³ /unit	2.24
Max. Inlet Opening ²	inches	24
	mm	600


¹ Based on installed length. Stone void is calculated at 40%. Includes 6" stone base, 6" above chamber crown and stone around units based on typical minimum center to center spacing. ² Based on HDPE pipe.

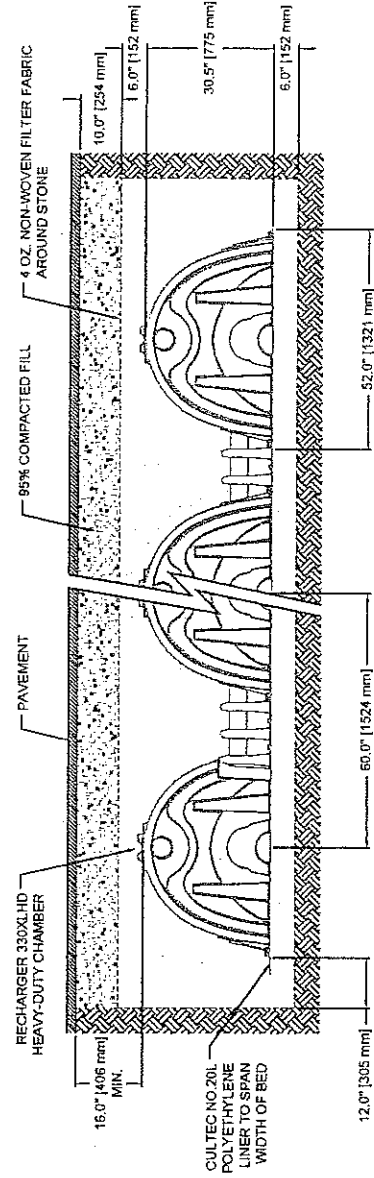

The Chamber with the Stripe®

CULTEC, Inc. • 878 Federal Road • P.O. Box 280 • Brookfield, CT 06804

Phone: 203-775-4416 • Toll Free: 800-4-CULTEC • Fax: 203-775-1462 • Web: www.cultec.com

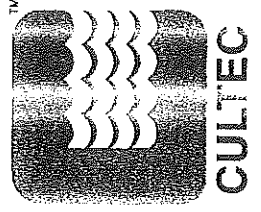




Infiltration Design Computations

Kirschner

8 Spruce Hill Road
Town of North Castle, New York

December 2010

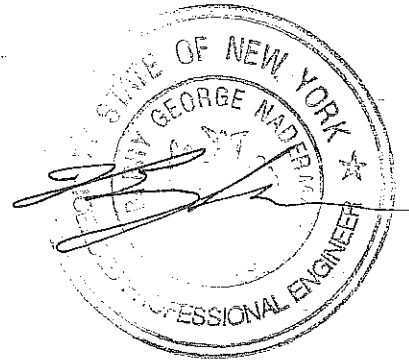

Methodology:

In accordance with Westchester County Stormwater Management Best Management Practices, the total volume of mitigation provided by the infiltration practice is the sum of the volume of runoff expected to infiltrate into the soil during a 24 hour period combined with the actual volume provided within the infiltration structure. The infiltration system is designed to mitigate the full volume of the increase in runoff depth from the new impervious surfaces during a 25-year storm event, which is 3.58 inches or 0.30'.

Also included are the calculations for the annual pool drawdown of the future pool.

Determine Increase in Runoff

Increase in impervious surfaces= **11,614 sf**

Therefore, the increase in runoff volume from impervious surfaces is as follows:

0.30' runoff depth x 11,614 sf = **3484 cf storage required**

Infiltration Trench Design:

Determine Percolation Rate into Soil

$$\text{Area of cylinder (Ac)} = \Pi \times \text{Ø} \times h = 3.14 \times 1 \times 8.5/12 = 2.33 \text{ sf}$$

$$\text{Area of bottom (Ab)} = \Pi \times (R)^2 = 3.14 \times (0.5)^2 = 0.785 \text{ sf}$$

$$\text{Area of a perc hole (Ap)} = \text{Ab} + \text{Ac} = 0.785 + 2.33 = 3.01 \text{ sf}$$

$$\text{Volume of a perc test: 3" drop (Vp)} = \text{Ab} \times h = 0.785 \times 3/12 = 0.196 \text{ cf}$$

$$\text{Soil Percolation Rate (Sr)} = \text{Volume} / \text{Area} / \text{Time}$$

Percolation rate from testing is 12 min/in.

$$\text{Sr} = 0.196 \text{ cf} / 3.01 \text{ sf} / 36 \text{ min.} = 0.0018 \text{ cf/sf/min.}$$

$$0.0018 \text{ cf/sf/min.} \times 60 \text{ min./hr} \times 24 \text{ hr./day} = 2.60 \text{ cf/sf/day}$$

$$\text{Assuming 25\% clogging } \text{Sr} = 0.75 \times 2.60 = \underline{\underline{1.95 \text{ cf/sf/day into soil}}}$$

Determine Infiltration System Units

Using **Cultec Model 330XLHD Recharger** chambers

$$\text{Effective surface area of infiltrator for absorption} = 10.3 \text{ sf/lf}$$

$$\text{24 hour percolation volume} = \text{effective area of infiltrator} \times \text{Sr}$$

$$= 10.3 \text{ sf/lf} \times 1.95 \text{ cf/sf/day} = \underline{\underline{20.10 \text{ cf/lf infiltration in 24 hrs.}}}$$

Total 24-hour volume of infiltrator system

$$= \text{Volume of infiltrator} + \text{24 hour volume of infiltration}$$

$$= 11.32 \text{ cf/lf} + 20.10 \text{ cf/lf} = \underline{\underline{31.42 \text{ cf/lf total volume}}}$$

Infiltrator units are 7.0' in length each. Therefore, the total volume per infiltrator unit 31.42 cf/lf total volume x 7.0 lf per unit = 219.94 cf/unit

$$\underline{\underline{\text{Total Storage required } 3484 \text{ cf} / 219.94 \text{ cf/unit} = 15.84 \text{ units}}}$$

$$\text{Say 16 units provided} = 3519 \text{ cf}$$

ANNUAL DRAWDOWN COMPUTATIONS FOR POOL

Determine Volume of Annual Pool Drawdown

The volume of the infiltration required for the annual pool drawdown is based upon an 8" drawdown for an 800 sf pool/spa. Therefore, the volume of pool drawdown is calculated as follows:

$$800 \text{ sf} \times 8" / 12" / \text{ft} = \underline{\mathbf{533 \text{ cf drawdown}}}$$

Determine Required Infiltration System Units


Using Cultec Model 330XL Recharger chambers, each unit in stone provides 79.26 cf/unit installed (ref. attached cut sheet).

Therefore, the required number of units to accommodate the pool drawdown is calculated as follows:

$$533 \text{ cf drawdown} \div 79.26 \text{ cf/unit} = \underline{\mathbf{6.7 \text{ units required- 16 units provided}}}$$

Sixteen (16) Cultec 330XL units provide 3519 cf of storage (533 cf required).

Note: infiltration is not accounted for in design of system.

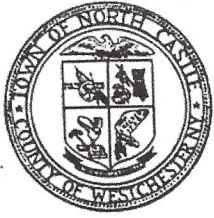

Town of North Castle
Residential Project Review Committee
17 Bedford Road Armonk, New York 10504
(914) 273-3542 (914) 273-3554 (fax)

RPRC COMPLETENESS REVIEW FORM

This form represents the standard requirements for a completeness review for all Residential Project Review Committee submissions. Failure to provide all of the information requested will result in a determination that the application is incomplete.

Project Name on Plan: KIRSCHNER RESIDENCE - POOL & CABANA

Initial Submittal Revised Preliminary

Street Location: 8 SPRUCE HILL RD.

Zoning District: _____ Property Acreage: 1.9229 Tax Map Parcel ID: SEC. 1, BLK 4, LOT 10-2

Date: 10-29-20

DEPARTMENTAL USE ONLY

Date Filed: _____ Staff Name: _____

Preliminary Plan Completeness Review Checklist

Items marked with a are complete, items left blank are incomplete and must be completed, "NA" means not applicable.

1. Plan prepared by a registered architect or professional engineer
2. Aerial photo (Google Earth) showing the applicant's entire property and adjacent properties and streets
3. Map showing the applicant's entire property and adjacent properties and streets
4. A locator map at a convenient scale
5. The proposed location, use and design of all buildings and structures
6. Existing topography and proposed grade elevations
7. Location of drives
8. Location of all existing and proposed site improvements, including drains, culverts, retaining walls and fences


RPRC COMPLETENESS REVIEW FORM

Page 2

- 9. Description of method of water supply and sewage disposal and location of such facilities
- 10. The name and address of the applicant, property owner(s) if other than the applicant and of the planner, engineer, architect, surveyor and/or other professionals engaged to work
- 11. Submission of a Zoning Conformance Table depicting the plan's compliance with the minimum requirements of the Zoning District
- 12. If a tree removal permit is being sought, submission of a plan depicting the location and graphical removal status of all Town-regulated trees within the proposed area of disturbance. In addition, the tree plan shall be accompanied by a tree inventory includes a unique ID number, the species, size, health condition and removal status of each tree.
- 13. If a wetlands permit is being sought, identification of the wetland and the 100-foot wetland buffer.

More information about the items required herein can be obtained from the North Castle Planning Department. A copy of the Town Code can be obtained from Town Clerk or on the North Castle homepage: <http://www.northcastleny.com/townhall.html>

_____ On this date, all items necessary for a technical review of the proposed site plan have been submitted and constitute a COMPLETE APPLICATION.

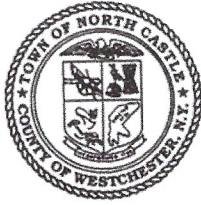

TOWN OF NORTH CASTLE
 WESTCHESTER COUNTY
 17 Bedford Road
 Armonk, New York 10504-1898

PLANNING DEPARTMENT
 Adam R. Kaufman, AICP
 Director of Planning

Telephone: (914) 273-3542
 Fax: (914) 273-3554
www.northcastleny.com

GROSS LAND COVERAGE CALCULATIONS WORKSHEET

Application Name or Identifying Title: KIRSHNER RESIDENCE Date: 10-29-20

Tax Map Designation or Proposed Lot No.: SEC. 1, BLK. 4, LOT 10-2

Gross Lot Coverage


- | | | |
|-----|--|------------------|
| 1. | Total lot Area (Net Lot Area for Lots Created After 12/13/06): | <u>83,759.48</u> |
| 2. | Maximum permitted gross land coverage (per Section 355-26.C(1)(b)): | <u>12,968</u> |
| 3. | BONUS maximum gross land cover (per Section 355-26.C(1)(b)): | |
| | Distance principal home is beyond minimum front yard setback | <u>230</u> |
| | <u>23'</u> x 10 = _____ | |
| 4. | TOTAL Maximum Permitted gross land coverage = Sum of lines 2 and 3 | <u>13,198</u> |
| 5. | Amount of lot area covered by principal building: | |
| | <u>3,744.7</u> existing + _____ proposed = | <u>3,744.7</u> |
| 6. | Amount of lot area covered by accessory buildings: | |
| | _____ existing + <u>650.35</u> proposed = | <u>650.35</u> |
| 7. | Amount of lot area covered by decks: | |
| | _____ existing + _____ proposed = | <u>_____</u> |
| 8. | Amount of lot area covered by porches: | |
| | <u>303.43</u> existing + _____ proposed = | <u>303.43</u> |
| 9. | Amount of lot area covered by driveway, parking areas and walkways: | |
| | <u>4,149</u> existing + _____ proposed = | <u>4,149</u> |
| 10. | Amount of lot area covered by terraces: | |
| | <u>1,281.91</u> existing + <u>1,208.84</u> proposed = | <u>2,490.75</u> |
| 11. | Amount of lot area covered by tennis court, pool and mechanical equip: | |
| | _____ existing + <u>1,010</u> proposed = | <u>1,010.0</u> |
| 12. | Amount of lot area covered by all other structures: | |
| | _____ existing + _____ proposed = | <u>_____</u> |
| 13. | Proposed gross land coverage: Total of Lines 5 – 12 = | <u>12,348.23</u> |

If Line 13 is less than or equal to Line 4, your proposal complies with the Town's maximum gross land coverage regulations and the project may proceed to the Residential Project Review Committee for review. If Line 13 is greater than Line 4, your proposal does not comply with the Town's regulations.

Lucio Dileo
 Signature and Seal of Professional Preparing Worksheet

10-29-20
 Date



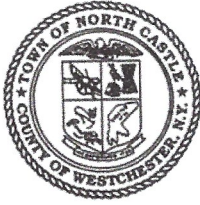

TOWN OF NORTH CASTLE
 WESTCHESTER COUNTY
 17 Bedford Road
 Armonk, New York 10504-1898

January 29, 2019
 Telephone: (914) 273-3542
 Fax: (914) 273-3554
www.northcastleny.com

PLANNING DEPARTMENT
 Adam R. Kaufman, AICP
 Director of Planning

FLOOR AREA CALCULATIONS WORKSHEET

Application Name or Identifying Title: HIRSHNER RESIDENCE Date: 10-29-20

Tax Map Designation or Proposed Lot No.: SEC. 1, BLK. 4, LOT 10-2

Floor Area


- | | | |
|-----|---|--------------------|
| 1. | Total Lot Area (Net Lot Area for Lots Created After 12/13/06): | <u>83,759.4886</u> |
| 2. | Maximum permitted floor area (per Section 355-26.B(4)): $+ 920.9 + 9,034 =$ | <u>9,954.9</u> |
| 3. | Amount of floor area contained within first floor:
$2,952.27$ existing + _____ proposed = | <u>2,952.27</u> |
| 4. | Amount of floor area contained within second floor:
$2,328.87$ existing + _____ proposed = | <u>2,328.87</u> |
| 5. | Amount of floor area contained within garage:
792.43 existing + _____ proposed = | <u>792.43</u> |
| 6. | Amount of floor area contained within porches capable of being enclosed:
303.43 existing + _____ proposed = | <u>303.43</u> |
| 7. | Amount of floor area contained within basement (if applicable – see definition):
_____ existing + _____ proposed = | <u>0</u> |
| 8. | Amount of floor area contained within attic (if applicable – see definition):
_____ existing + _____ proposed = | <u>0</u> |
| 9. | Amount of floor area contained within all accessory buildings:
0 existing + 650.35 proposed = | <u>650.35</u> |
| 10. | Proposed floor area: Total of Lines 3 – 9 = | <u>7,027.35</u> |

If Line 10 is less than or equal to Line 2, your proposal **complies** with the Town's maximum floor area regulations and the project may proceed to the Residential Project Review Committee for review. If Line 10 is greater than Line 2 your proposal does not comply with the Town's regulations.


 Signature and Seal of Professional Preparing Worksheet



10-29-20
 Date

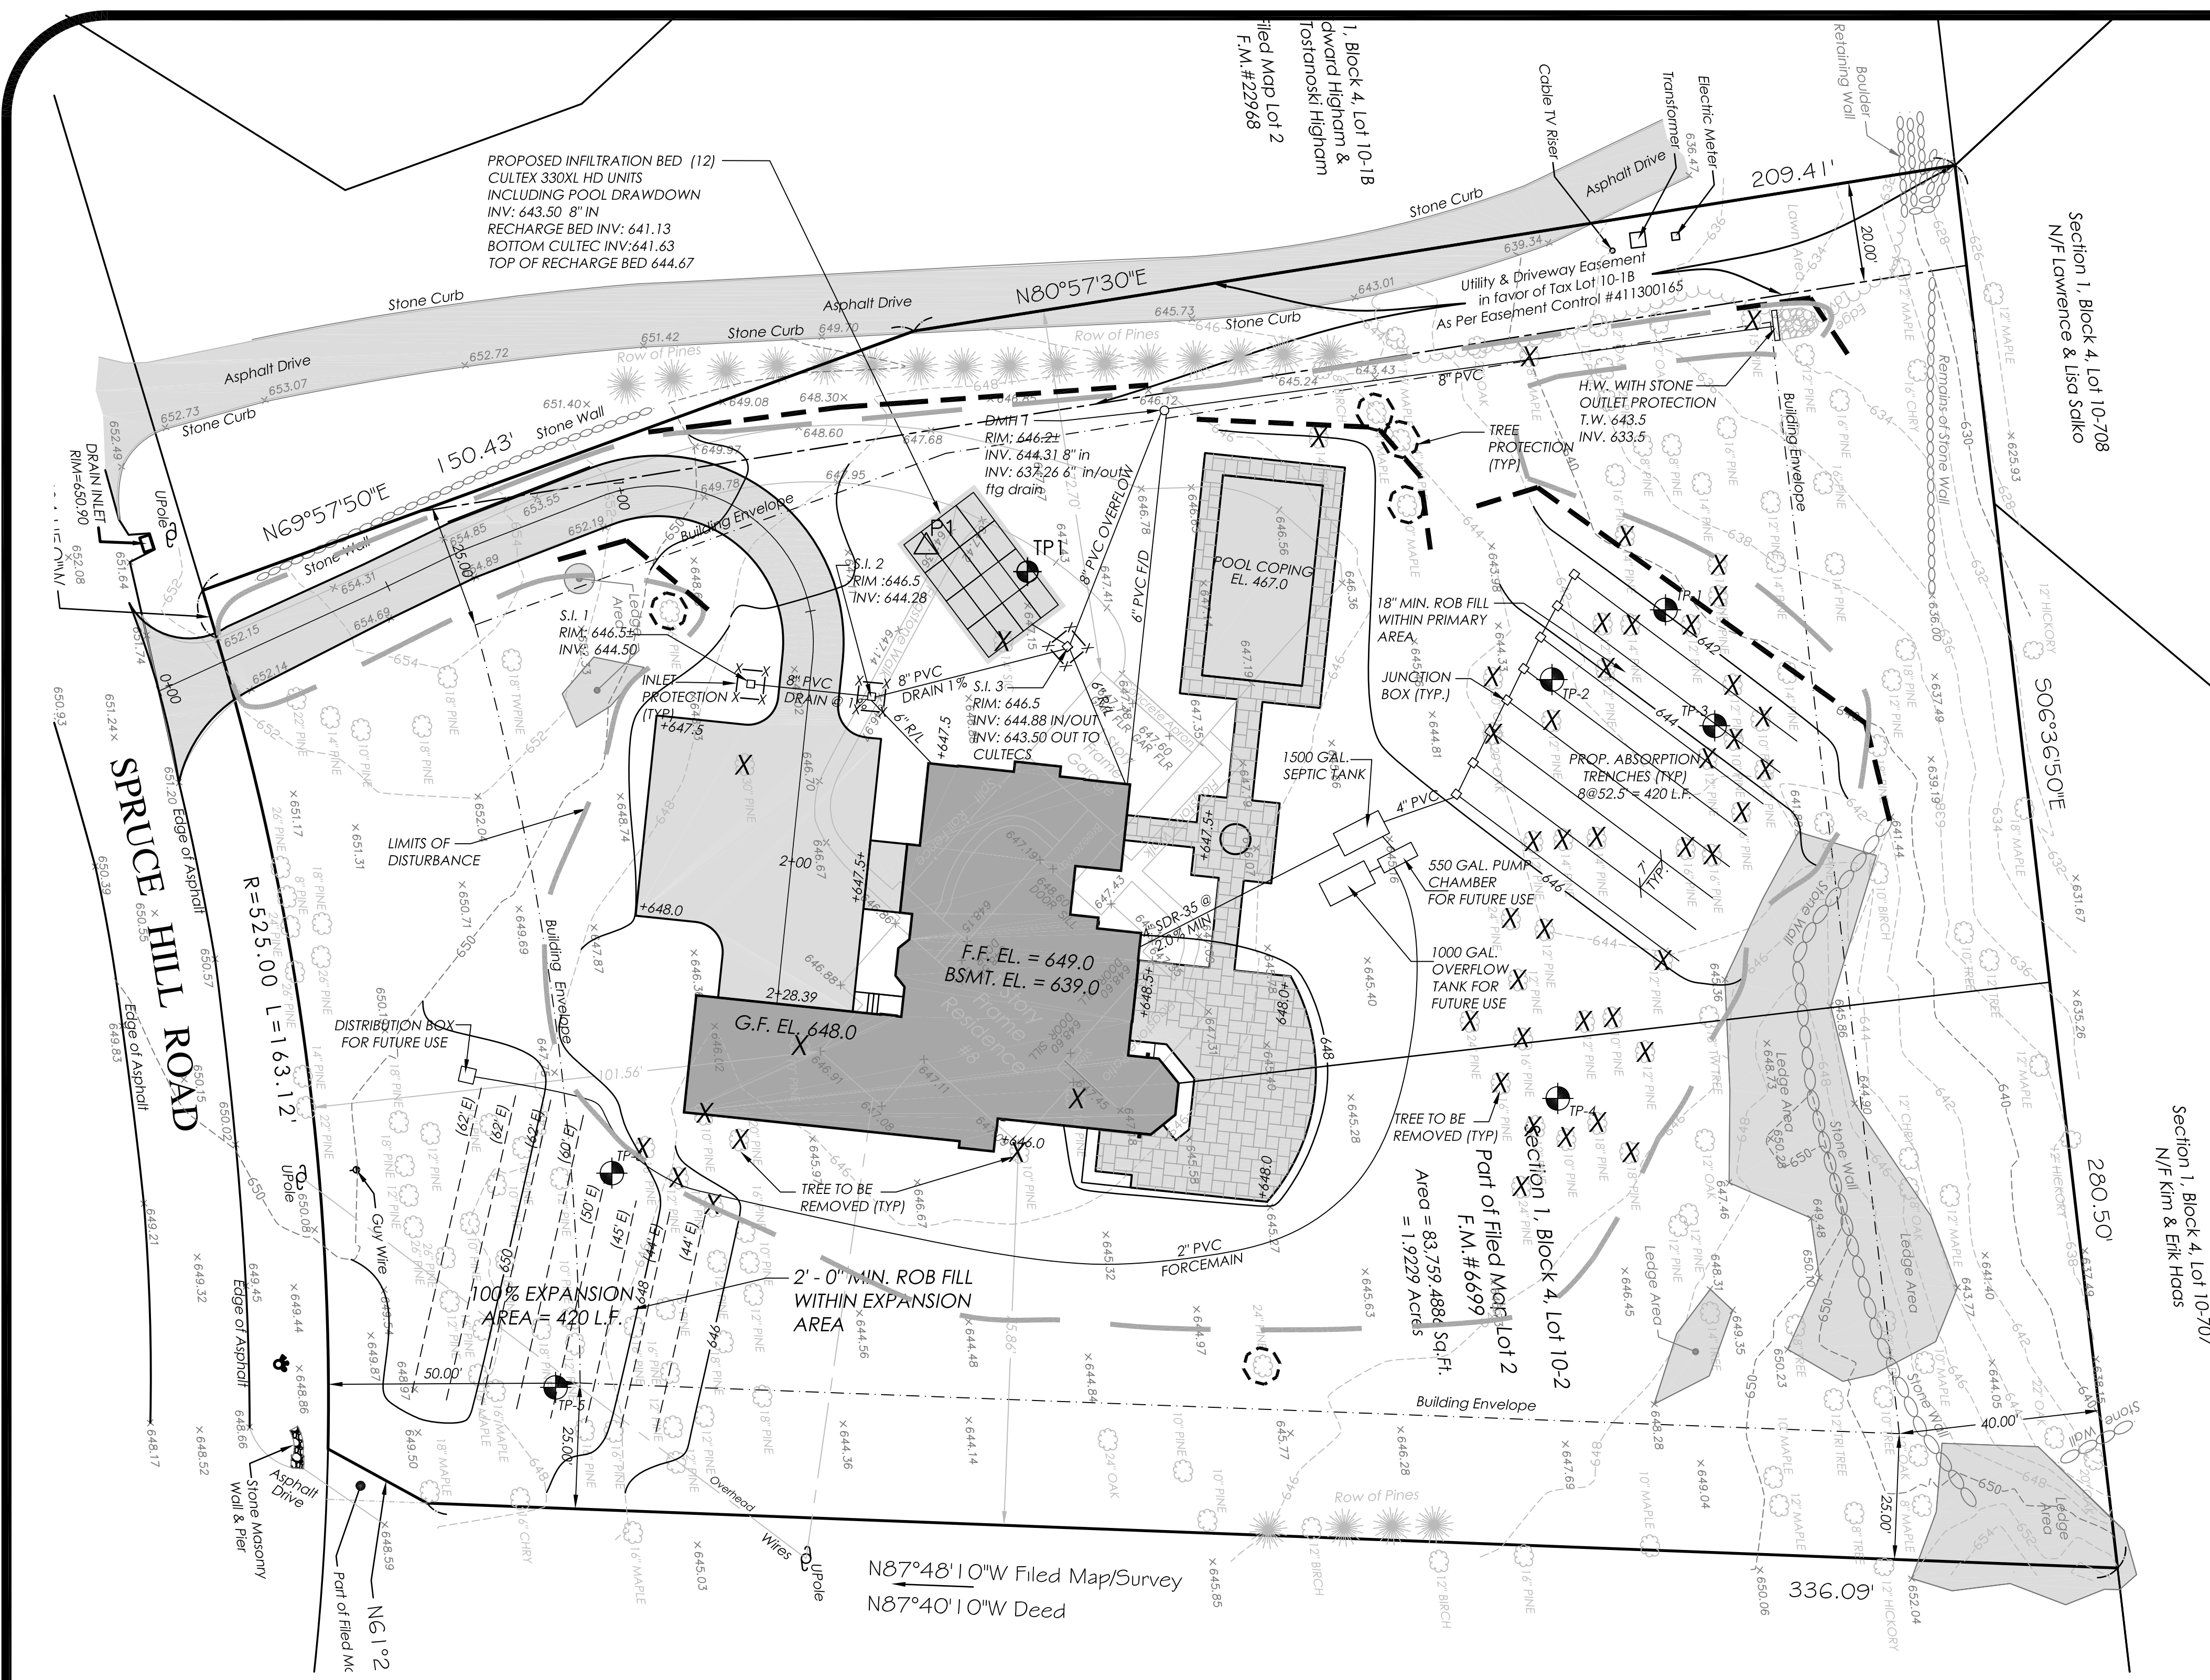

SITE DATA

Owner/Applicant: Samuel and Cathy Kirschner
424 West End Ave., Apt 3F
New York, NY 10024

Location: 8 Spruce Hill Road
Town of North Castle

Designation: Sec: 1 Blk: 4 Lot: 10-2

Site Area: 1.9229 acres

Existing property, topography and site features based upon a survey entitled "Survey Prepared for Samuel Kirschner and Cathy Kirschner" prepared by Thomas C. Merritts, Land Surveyors dated March 22, 2010.

The subject property is located within the Mianus River watershed basin.

SEDIMENT & EROSION CONTROL NOTES

ALL EROSION AND SEDIMENT CONTROL MEASURES SHALL BE IN CONFORMANCE WITH THE NEW YORK STATE MANUAL FOR EROSION CONTROL.

THE TOWN MAY REQUIRE ADDITIONAL EROSION CONTROL MEASURES IF DEEMED APPROPRIATE TO MITIGATE SILTATION OR EROSION OF DISTURBED SOILS.

EROSION CONTROL MEASURES SHALL BE INSTALLED PRIOR TO THE START OF CONSTRUCTION WITHIN A SPECIFIC WORK AREA. THE CONTRACTOR SHALL BE RESPONSIBLE FOR THE MAINTENANCE AND/OR REPLACEMENT OF CONTROL MEASURES AS REQUIRED THROUGHOUT THE DURATION OF CONSTRUCTION.

ALL EROSION CONTROLS SHALL BE INSPECTED IMMEDIATELY AFTER A RAINFALL EVENT AND ON A WEEKLY BASIS. ANY DAMAGED CONTROLS SHALL BE IMMEDIATELY REPAIRED OR REPLACED AS REQUIRED.

IF ANY DISTURBED AREAS ARE TO REMAIN IDLE FOR A PERIOD OF SEVEN (7) DAYS OR MORE, THE AREA SHALL BE TEMPORARILY STABILIZED WITH TEMPORARY SEEDING AND MULCHING.

UPON COMPLETION OF CONSTRUCTION, ALL TEMPORARY EROSION CONTROL MEASURES SHALL BE REMOVED AND THE DRAINAGE FACILITIES SHALL BE COMPLETELY CLEANED OF SEDIMENTS AND DEBRIS.

TREE PROTECTION SHALL BE PROVIDED FOR ANY SIGNIFICANT TREE TO REMAIN WITHIN 15' OF THE WORK AREA. THE TREE PROTECTION SHALL BE INSTALLED GENERALLY AT THE DRIP LINE OF THE TREE.

Construction Sequence
The following describes the construction sequence for the proposed construction.

1. Install silt fencing and other erosion control measures for the construction of the House and driveway as shown on the plan.
2. Provide an anti-tracking pad ("stabilized construction entrance") in the location shown on the plan and maintain it through the course of construction.
3. Clear existing vegetation within the limits of disturbance for the property. Chip all ed brush and trees that are removed for later use as mulch or haul off site and dispose of properly. Grub the root system and stumps of the cleared vegetation and dispose of off-site.
4. Install the infiltration chambers in accordance with the details on the design plan and the manufacturer's specifications.
5. Strip topsoil from the work area and stockpile for later use. Install silt fence around perimeter of soil stockpile in accordance with the design plans.
6. Rough grade within the limits of disturbance of the to establish the subbase grade. Place crushed stone base layer for the driveway. Proceed with the construction of the residence, patio, utilities and drainage structures.
7. Install the storm drainage system that is to discharge into stormwater management facilities (Deep sump Drain Inlets, and infiltration systems) from the lowest to the highest grade. At each field inlet, install the inlet protection controls as designated on the plans and maintain them until finished grades have been established and stabilized.
8. Excavated material from trenching for the stormwater drainage system shall be temporarily stockpiled on the high side of excavation so runoff is directed away from the trenches.
9. When the finished grade is achieved in the trench, place crushed aggregate to achieve subbase grade for the proposed driveway, followed by top course of pavement.
10. Remove temporary erosion control measures only after site stabilization takes place.

Inspection and Maintenance Schedule during Construction
The following delineates the maintenance that is required for the temporary erosion and sediment control measures and permanent measures specified on the design plans. For the purpose of this section, immediately shall be by end of working day.


Silt Fence
Inspect silt fence immediately prior to any major storms and after each significant rainfall event, and at least daily during a prolonged rainfall event. All necessary repairs are to be made immediately. Inspection for physical damage shall be made weekly. If filter fabric shows signs of decomposing or is damaged, it shall be repaired/replaced immediately.

Inlet Protection
Inspection shall occur prior to any major storms and after each significant rainfall event, and on a regular weekly basis. Maintenance shall include replacement of gravel and the side slopes around the basin. Sediment shall be removed when the accumulations equals a depth of 12" inside of the basin.

Soil Stockpiling
Stockpiles and fill areas shall be inspected at least weekly for signs of erosion. Re-seed and mulch as necessary to maintain a vegetative cover.

Stabilized Construction Entrance
Maintenance includes periodic top dressing with additional stone. All sediment spilled, dropped or washed into the public right-of-way must be removed immediately. Regular inspection after significant rainfall events and heavy traffic use of the entrance shall be performed.

UNAUTHORIZED ALTERATIONS AND ADDITIONS TO THIS DRAWING IS A VIOLATION OF SECTION 7209(2) OF THE NEW YORK STATE EDUCATION LAW.

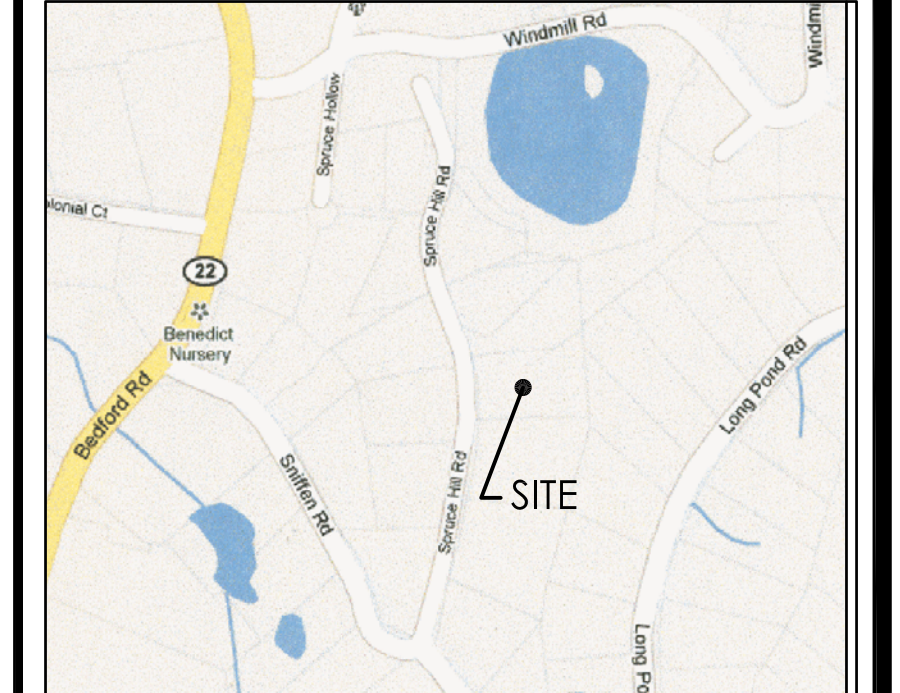

LOCATION PLAN

No.	Revision/Issue	Date

NADERMAN
LAND PLANNING AND ENGINEERING, P.C.

3799 Nelson Ave.
Jefferson Valley, NY 10535

tel: 914.245.5403
fax: 914.962.5963
e: bgn@naderman.com

PROPOSED RESIDENCE KIRSCHNER

8 SPRUCE HILL ROAD
TOWN OF NORTH CASTLE WESTCHESTER CO., NY

SITE PLAN

Project	5555	Sheet	SP-1
Date	12/14/10		
Scale	1" = 20'		

ZONING TABLE R2.0

	REQUIRED	PROPOSED
MIN. LOT AREA	2.0 ACRES	1.9229 ACRES
MIN. FRONTAGE	150'	163'±
MIN. DEPTH	150'	346'±
MIN. WIDTH	150'	246'±
MIN. FRONT YARD	50'	73'±
MIN. SIDE YARD	30'	74'/82'±
MIN. REAR YARD	50'	174'±
MAX. STORIES	2 1/2	
MAX BUILDING HEIGHT	30'	
MAX. EXTERIOR WALL HEIGHT	38'	
GROSS LAND COVERAGE	13,198 S.F.	11,614 S.F.
GROSS BLDG. COVERAGE		

PLAN
SCALE: 1"=20'



Town of North Castle Building Department

17 Bedford Road

Armonk, New York 10504-1898

Telephone: (914) 273-3000 ext. 44 Fax: (914) 273-3554

www.northcastleny.com

Residential Building Permit Application

NOTE: TWO (2) SETS OF ALL REQUIRED DOCUMENTS MUST BE SUBMITTED WITH THIS APPLICATION

Section I- PROJECT ADDRESS: 8 Spruce Hill DATE: 10-29-20

Section II- CONTACT INFORMATION: (Please print clearly. All information must be current.)

APPLICANT: Lucio Di Leo, Studio RAI, Architects

ADDRESS: 290 Salem Rd. Pound Ridge, NY 10576

PHONE: 914-273-6843 MOBILE: 914-760-9740 EMAIL: lucio@studiorai.com

PROPERTY OWNER: Sam Kirschner

ADDRESS: 8 Spruce Hill Rd. Armonk, NY

PHONE: _____ MOBILE: 917-754-7902 EMAIL: samkirschner@mac.com

Section III- DESCRIPTION OF WORK: (Any work conducted outside of the house requires approval from the RPRC unless the proposed action is minor in nature and complies with 355-26 C (3) of the Town of North Castle code.)

Inground swimming pool, Terrace and open Cabana.

Section IV- USE AND OCCUPANCY:

EXISTING/ CURRENT USE: Single Family Residence

PROPOSED RESIDENTIAL:

- One Family Dwelling
- Two Family Dwelling
- Townhouse
- Detached Accessory Structure

Section V- PERMIT FEES: (\$100 app fee plus \$14 per \$1000, cost of construction and a \$75 CO fee.)

ESTIMATED COST OF CONSTRUCTION (Based on fair market value labor & material) \$ 250,000.00


AFFIDAVIT OF CONSTRUCTION COST: This affidavit must be completed by the Design Professional if the estimated cost is \$20,000 or more.

Town of North Castle Building Department

Section V- (Continued)

I Lucio Di Leo do hereby affirm and certify as follows: (i) I am the architect/engineer (circle one) licensed by the State of New York; (ii) I have reviewed the plans, drawings and specifications for this application and am fully familiar with the proposed construction; (iii) based on my experience, I estimate the total cost of construction including all labor, all materials, all professional fees and all associated costs to be approximately \$ 250,000, and (iv) pursuant to Penal Law 210.45, I acknowledge that a false statement made knowingly is a Class A misdemeanor.

Signature: _____

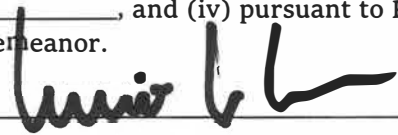

Date: _____

10-29-20



Section VI- CONTACT INFORMATION: (Please print clearly. All information must be current)

ARCHITECT/ ENG: Lucio Di Leo, r.a., AIA

ADDRESS: 290 Salem Rd. Pound Ridge, NY 10576

PHONE: 914-273-6843 MOBILE: 914-760-9740

EMAIL: lucio@studiorai.com

CONTRACTOR: _____

ADDRESS: _____

PHONE: _____ MOBILE: _____ EMAIL: _____

PLUMBER: _____

ADDRESS: _____

PHONE: _____ MOBILE: _____ EMAIL: _____

ELECTRICIAN: _____


ADDRESS: _____

PHONE: _____ MOBILE: _____ EMAIL: _____

Section VII- APPLICANT CERTIFICATION

I hereby certify that I have read the instructions & examined this application and know the same to be true & correct. All provisions of laws & ordinances covering this type of work will be complied with whether specified herein or not. The granting of a permit does not presume to give authority to violate or cancel the provisions of any other state or local law regulating construction or land use or the performance of construction.

Signature: _____

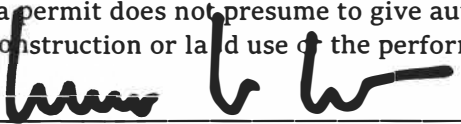

Date: _____

10-29-20

Town of North Castle Building Department

Section VIII- AFFIDAVIT OF OWNER AUTHORIZATION IF APPLICABLE: (To be notarized)

STATE OF NEW YORK }
COUNTY OF WESTCHESTER } SS:

The applicant _____ has proper consent from said owner to make this application as submitted and said owner agrees to all terms and conditions placed upon same.

Owner's Name (PRINT) _____ Owner's Signature _____

Sworn to before me this _____ day of _____, 20 _____

Notary Signature _____



Notary Stamp Here

OFFICE USE ONLY - DO NOT WRITE BELOW THIS LINE

Zone: _____ Section: _____ Block: _____ Lot: _____

Building Department Checklist:

Does this permit require RPRC approval? Yes No

GC License Work. Comp. Liability. Ins. Disability Two sets of documents

Permit Fee _____ Payment: Check #: _____ Cash Credit Card

Name on check: _____

Received By: _____ Application No.: _____

BUILDING INSPECTOR APPROVAL

Has all the conditions of the RPRC been met? Yes NA

Is a Flood Development permit required? Yes No

Reviewed By: _____ Date: _____

Building Inspector Approval: _____ Date: _____

Conditions: _____
