DRAWING LIST	
ARCHITECTURAL DRAWINGS	
COVER SHEET	A.001
GENERAL NOTES	A.002
EXISTING SITE PLAN	A.003
EROSION CONTROL PLAN	A.004
PROPOSED SITE PLAN	A.005
EXISTING FLOOR PLANS	A.006
EXISTING FLOOR PLANS	A.007
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ELEVATIONS	A.011
SECTIONS AND DETAILS	A.012
ELECTRICAL PLANS	A.013

ADDITIONS AND ALTERATIONS TO AN EXISTING ONE-FAMILY DWELLING DOUGLAS RESIDENCE 15 LAKEVIEW DRIVE NORTH WHITE PLAINS, NY, 10603

- ELECTRICAL WORK TO BE FILED UNDER SEPARATE APPLICATION.
- PLUMBING WORKTO BE FILED UNDER SEPARATE APPLICATION.

NOTE:

MEP CONTRACTORS WILL BE REQUIRED TO PREPARE AND SUBMIT MECHANICAL DRAWINGS, SPECIFICATIONS AND EQUIPMENT DATA TO DEMONSTRATE FULL ENERGY CODE COMPLIANCE.



LOCATION

GENERAL CONDITIONS:

GOOD PRACTICE.

- 1. THE GENERAL CONDITIONS ARE HEREBY MADE AN ADMINISTRATIVE PART OF THESE DRAWINGS, AS IF HEREIN WRITTEN IN FULL.
- 2. WRITTEN DIMENSIONS SHALL HAVE PRECEDENCE OVER SCALED DIMENSIONS.
- 3. LARGER SCALE DETAILS SHALL HAVE PRECEDENCE OVER SMALLER SCALE DRAWINGS. IT IS THE INTENTION OF THE DRAWINGS TO PROVIDE FOR A COMPLETE JOB IN ALL RESPECTS AND NO EXTRAS WILL BE ALLOWED FOR MATERIALS AND/OR LABOR REQUIRED TO COMPLETE THE WORK AS INDICATED.
- 4. CONTRACTOR SHALL VERIFY ALL DIMENSIONS AND CONDITIONS ON THE JOB AND THE ENGINEER'S OFFICE MUST BE NOTIFIED OF ANY VARIATIONS FROM THE DIMENSIONS AND CONDITIONS SHOWN ON THE DRAWINGS. PROVIDE DIMENSIONS SUBJECT TO ACTUAL FIELD CONDITIONS AND NO CREDITS OR EXTRAS WILL BE ALLOWED FOR DISCREPANCIES UP TO 1'-0" IN ANY MEASUREMENT.
- CONSTRUCTION SHALL COMPLY WITH ALL FEDERAL, STATE AND LOCAL CODES,
 ORDINANCES, RULES AND REGULATIONS. CONTRACTOR SHALL ARRANGE FOR ALL
 NECESSARY PERMITS AND INSPECTIONS INCLUDING THE OCCUPANCY CERTIFICATE.
 CONTRACTOR SHALL BE RESPONSIBLE FOR ADEQUATELY BRACING AND PROTECTING
 ALL WORK DURING CONSTRUCTION AGAINST DAMAGE, BREAKAGE, COLLAPSE,
 DISTORTION AND MISALIGNMENT ACCORDING TO APPLICABLE CODES, STANDARDS AND
- 7. IF NECESSARY CONTRACTOR SHALL DISCONNECT, CAP AND REROUTE ANY EXISTING WATERLINES, SANITARY OR UTILITY LINES IN AREA OF NEW FOUNDATIONS AND SHALL USE HAND EXCAVATION IN AREAS OF SUSPECTED UNDER GROUND UTILITIES AND SERVICES. IF ANY LINES ARE BROKEN OR DAMAGED, THE CONTRACTOR WILL REPAIR AND REPLACE SAME AT HIS OWN EXPENSE AND ARRANGE FOR PROPER INSPECTION OF HIS WORK.
- 8. THE INSTALLATION OF ALL MATERIALS AND PRODUCTS SHALL MEET ALL LOCAL FIRE DEPARTMENT'S REQUIREMENTS AND REGULATIONS, PROOF OF WHICH SHALL BE FURNISHED TO THE LOCAL MUNICIPALITY PRIOR TO THE INSTALLATION OF SUCH MATERIALS.
- 9. ALL ELECTRIC WORK SHALL CONFORM TO RULES AND REGULATIONS OF THE 2020 RESIDENTIAL BUILDING CODE OF NYS. THE 2014 NATIONAL ELECTRIC CODE AND N.Y. STATE BOARD OF FIRE UNDERWRITERS. THE FINAL CERTIFICATE OF APPROVAL MUST BE PRESENTED TO THE OWNER PRIOR TO FINAL PAYMENT.
- 10. ALL PLUMBING WORK SHALL CONFORM TO RULES AND REGULATIONS OF THE 2020 RESIDENTIAL BUILDING CODE OF NYS. THE FINAL CERTIFICATE OF APPROVAL MUST BE PRESENTED TO THE OWNER PRIOR TO FINAL PAYMENT.
- 11. THE ENTIRE PREMISES, INSIDE AND OUT, SHALL BE CLEANED OF ALL DEBRIS AND EXCESS MATERIALS, TO THE SATISFACTION OF THE OWNER, INCLUDING LABELS AND PROTECTIVE COATINGS ON ALL MATERIALS.
- 12. REQUEST FOR FINAL PAYMENT MUST BE ACCOMPANIED WITH A WAIVER OF LIENS, SIGNED BY ALL SUBCONTRACTORS AND MATERIAL SUPPLIERS, IN ADDITION TO THE GENERAL CONTRACTOR.

- 13. ALL REQUIRED AND NECESSARY PERMITS SHALL BE SECURED FROM ALL MUNICIPAL AGENCIES HAVING JURISDICTION AT THE COST AND EXPENSE OF THE CONTRACTOR AND PRIOR TO START OF WORK AND SHALL OBTAIN APPROVAL OF ALL COMPLETED WORK AS REQUIRED BY ADMINISTRATIVE CODE AND ALL REQUIRED AGENCIES.
- 14. EACH CONTRACTOR WILL BE HELD RESPONSIBLE FOR HIS/HER WORK. THE GENERAL CONTRACTOR SHALL VERIFY ALL DIMENSIONS AND CONDITIONS OF THE BUILDINGS AND WILL BE RESPONSIBLE FOR THE JOINING OF WORK OF ALL TRADES.
- 15. THE CONTRACTOR SHALL FAMILIARIZE HIMSELF/HERSELF WITH THE REQUIREMENTS OF "SAFETY OF PUBLIC AND PROPERTY DURING CONSTRUCTION OPERATIONS" AND SHALL BE HELD RESPONSIBLE FOR THE SAFE MAINTENANCE AS PRESCRIBED THEREIN UNTIL COMPLETION OF WORK.
- 16. THE CONTRACTOR OR PERSON WHO SUPERVISED THE WORK IS REQUIRED TO BE PRESENT AT FINAL INSPECTION WITH THE BUILDING DEPARTMENT INSPECTOR.

 17. THE ARCHITECT/ENGINEER HAS NOT BEEN RETAINED TO SUPERVISE ANY
- CONSTRUCTION OR INSTALLATION OF ANY EQUIPMENT.

 18. THE OWNER SHALL BE RESPONSIBLE FOR THE SAFE MAINTENANCE OF THE BUILDING AND IT'S FACILITIES.
- 19. ALL MATERIALS AND METHODS OF CONSTRUCTION SHALL CONFORM TO NEW YORK STATE FIRE PREVENTION AND 2015 INTERNATIONAL BUILDING CODE.
- 20. IT SHALL BE THE CONTRACTORS RESPONSIBILITY TO COMPLY WITH THE REQUIREMENTS AND STANDARDS OF THE BUILDING CODE ZONING RESOLUTION. IT SHALL ALSO BE THE CONTRACTORS RESPONSIBILITY TO SEEK CERTIFICATION OF THE AFOREMENTIONED SECTIONS, REQUIREMENTS AND STANDARDS.
- 21. CONTRACTOR SHALL VISIT THE SITE, CHECK AND VERIFY CONDITIONS, FAMILIARIZE HIMSELF/HERSELF WITH EXISTING CONDITIONS UNDER WHICH WORK IS TO BE PERFORMED AND CORRELATE HIS/HER OBSERVATIONS WITH THE REQUIREMENTS OF THE PLANS. ANY DISCREPANCIES SHALL BE REPORTED TO THE OWNER IMMEDIATELY.

 22. CONTRACTOR SHALL BE RESPONSIBLE TO THE OWNER FOR ALL THE ACTS AND OMISSIONS OF ALL HIS EMPLOYEES AND SUB-CONTRACTORS, THEIR AGENTS AND ALL OTHER PERSONS PERFORMING ANY OF THE WORK TO BE DONE.
- 23. CONTRACTOR SHALL PURCHASE AND MAINTAIN SUCH INSURANCE AS WILL PROTECT HIM/HER RESULT FROM THE CONTRACTORS OPERATIONS, WHETHER BE HIMSELF/HERSELF, SUB-CONTRACTOR, OR BY ANY OF THEM FOR WHOSE ACTS ANY OF THEM MAY BE LIABLE.
- 24. CONTRACTOR SHALL COMPLY WITH ALL APPLICABLE LAWS, ORDINANCES, RULES AND REGULATIONS OF PUBLIC AUTHORITY HAVNG JURISDICTION FOR THE SAFETY OF PERSONS OR PROPERTY & TO PROTECT THEM FROM DAMAGE, INJURY OR LOSS.

 25. CONTRACTOR SHALL PROPERLY CLEAN UP DURING PROCESS OF WORK.

 CONTRACTOR, UPON COMPLETION OF WORK, SHALL LEAVE PREMISES CLEAN, NEAT AND ORDERLY.
- 26. CONTRACTOR SHALL GIVE ALL NOTICES.
- 27. UTILITY CONNECTIONS TO BE FILED UNDER SEPARATE APPLICATION.

ADDRESS: 15 Lakeview Drive N

White Plains, NY 10603

ZONE : R-5 BLOCK : 4 SECTION : 122.16 LOT : 16


ZONING & BUILDING CODES:

1. ZONING: R-5, CONSTRUCTION CLASSIFICATION IS VB.

2. THIS STRUCTURE IS DESIGNED TO CONFORM TO THE 2020 RESIDENTIAL BUILDING CODE OF NYS, 2020 EBC ALTERATION LEVEL 2, 2020 IEC AND THE 2014 NEC.
3. THIS STRUCTURE IS DESIGNED TO MEET OR EXCEED THE CURRENT MINIMUM

ENERGY AND MECHANICAL CODES.

4. ALL MECHANICAL, ELECTRICAL, PLUMBING, AND FIRE PROTECTION WORK TO BE INSTALLED BY LICENSED CONTRACTORS. CONTRACTORS TO REVIEW DRAWINGS, NOTES. SHEETS AND ATTACHED DETAILS.

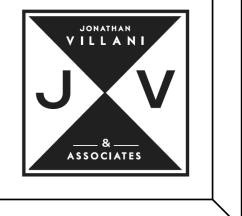

Jonathan Villani & Assoc. Inc 15 Independence Street White Plains, N.Y., 10606 P 914-575-1071 jmvarch@gmail.com

Annunziata & Villani
Design Consultants. Inc.
15 Independence Street
White Plains, N.Y., 10606
P 914-575-1071
jmvarch@gmail.com

DOUGLAS RESIDENCE
ADDITION AND ALTERATIONS TO EXISTI
STRUCTURE
15 LAKEVIEW DRIVE N
WHITE PLAINS, NEW YORK, 10603

 NO.
 ISSUE
 DATE

 1.
 ORIGINAL
 9/16/20

 2.
 REVISION
 9/30/20

 4.
 REVISION
 6.

 6.
 REVISION
 6.

 8.
 REVISION
 6.

 8.
 REVISION
 6.

IN ASSOCIATION WITH:

John J. Annunziata, P.E.

24 Chesley Road

White Plains, N.Y., 10605

P-914-949-0270

F-914-428-6235

SCALE: DATE: PROJECT NO
AS NOTED 9/30/20

DRAWN BY: CHECKED BY: APPROVED I

DRAWING TITLE:

COVER SHEET

A.001

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GENERAL CONSTRUCTION NOTES ADMINISTRATION 1. THE GENERAL NOTES CONTAINED HEREIN ARE PART OF THE PLANS AND SPECIFICATIONS, AND ARE TO BE COMPLIED WITH IN ALL RESPECTS. MORE RESTRICTIVE NOTES SPECIFIED ELSWHERE ARE TO TAKE PRECEDENCE OVER THOSE LISTED BELOW 2. ALL NOTES, DIMENSONS, DETAILS AND JOB CONDITIONS WERE CHECKED AND VERIFIED, ANY DISCREPANCY SHALL BE BROUGHT TO THE ATTENTION OF THE ARCHITECT/ENGINEER 3. ALL REQUIRED AND NECESSARY PERMITS SHALL BE SECURED FROM ALI MUNICIPAL AGENCIES HAVING JURISDICTION AT THE COST AND EXPENSE OF THE CONTRACTOR AND PRIOR TO START OF WORK AND SHALL OBTAIN APPROVAL OF ALL COMPLETED WORK AS REQUIRED BY ADMINISTRATIVE CODE AND ALL REQUIRED AGENCIES 4. EACH CONTRACTOR WILL BE HELD RESPONSIBLE FOR HIS/HER WORK. THE GENERAL CONTRACTOR SHALL VERIFY ALL DIMENSIONS AND CONDITONS OF THE BUILDINGS AND WILL BE RESPONSIBLE FOR THE JOINING OF WORK OF ALL TRADES 5. THE CONTRACTOR SHALL FAMILIARIZE HIMSELF/HERSELF WITH THE REQUIREMENTS OF "SAFETY OF PUBLIC AND PROPERTY DURING CONSTRUCTION OPERATIONS" AND SHALL BE HELD RESPONSIBLE FOR THE SAFE MAINTENANCE AS PRESCRIBED THEREIN UNTIL COMPLETION OF WORK. 6. NO DRAWINGS TO BE SCALED, DIMENSIONS ARE TO BE USED. 7. THE CONTRACTOR OR PERSON WHO SUPERVISED THE WORK IS REQUIRED TO BE PRESENT AT FINAL INSPECTION WITH THE BUILDING DEPARTMENT **INSPECTOR** 8. THE ARCHITECT/ENGINEER WAS NOT RETAINED TO SUPERVISE ANY CONSTRUCTION OR INSTALLATION OF ANY EQUIPMENT. 9. THE OWNER SHALL BE RESPONSIBLE FOR THE SAFE MAINTENANCE OF THE BUILDING AND IT'S FACILITIES. 10. ALL WORK SHALL COMPLY WITH THE 2020 RESIDENTIAL BUILDING CODE OF NYS AND ALL OTHER APPLICABLE LAWS AND ORDINANCES NOT HEREIN 11. ALL MATERIALS AND METHODS OF CONSTRUCTION SHALL CONFORM TO NEW YORK STATE FIRE PREVENTION AND BUILDING CODE. 12. IT SHALL BE THE CONTRACTORS RESPONSIBILITY TO COMPLY WITH THE REQUIREMENTS AND STANDARDS OF THE BUILDING CODE ZONING RESOLUTION. IT SHALL ALSO BE THE CONTRACTORS RESPONSIBILITY TO SEEK CERTIFICATION OF THE AFOREMENTIONED SECTIONS, REQUIREMENTS AND STANDARDS. 13. CONTRACTOR SHALL VISIT THE SITE, CHECK AND VERIFY CONDITIONS, FAMILIARIZE HIMSELF/HERSELF WITH EXISTING CONDITIONS UNDER WHICH WORK IS TO BE PERFORMED AND CORRELATE HIS/HER OBSERVATIONS WITH THE REQUIREMENTS OF THE PLANS. ANY DISCREPANCIES SHALL BE REPORTED TO THE OWNER IMMEDIATELY. 14. CONTRACTOR SHALL BE RESPONSIBLE TO THE OWNER FOR ALL THE ACTS AND OMISSIONS OF ALL HIS EMPLOYEES AND SUB-CONTRACTORS. THEIR AGENTS AND ALL OTHER PERSONS PERFORMING ANY OF THE WORK TO BE 15. CONTRACTOR SHALL PURCHASE AND MAINTAIN SUCH INSURANCE AS WILL PROTECT HIM/HER RESULT FROM THE CONTRACTORS OPERATIONS, WHETHER BE HIMSELF/HERSELF, SUB-CONTRACTOR, OR BY ANY OF THEM FOR WHOSE ACTS ANY OF THEM MAY BE LIABLE. 16. CONTRACTOR SHALL COMPLY WITH ALL APPLICABLE LAWS, ORDINANCES RULES AND REGULATIONS OF PUBLIC AUTHORITY HAVNG JURISDICTON FOR THE SAFETY OF PERSONS OR PROPERTY & TO PROTECT THEM FROM DAMAGE. INJURY OR LOSS. 17. CONTRACTOR SHALL PROPERLY CLEAN UP DURING PROCESS OF WORK. CONTRACTOR, UPON COMPLETION OF WORK, SHALL LEAVE PREMISES CLEAN. NEAT AND ORDERLY. DESIGN LOADS FIRST FLOOR 40 PSF L.L. 40 PSF L.L. SECOND FLOOR ROOF 40 PSF L.L. 20 PSF D.L.

2020 ECC - GENERAL NOTES

1. THE PROJECT CONSISTS OF AN ADDITION TO AN EXISTING RESIDENCE. THE RESIDENCE HAS APPROXIMATELY 700 SF OF CONDITIONED FLOOR AREA 2. THE STRUCTURE IS CLASSIFIED AS A RESIDENTIAL BUILDING AND IS THEREFORE REGULATED BY CHAPTER 4 OF THE 2020 ECC RESIDENTIAL PROVISIONS AS AMENDED.

3. A PERMANENT CERTIFICATE SHALL BE COMPLETED BY ANNUNZIATA AND VILLANI DESIGN CONSULTANTS AND POSTED ON SITE AS REQUIRED BY SECTION 401.3 OF THE 2020 ECC

4. INTERIOR DESIGN TEMPERATURES FOR HEATING AND COOLING LOAD CALCULATIONS SHALL BE A MAXIMUM OF 72 DEGREES FOR HEATING AND A MINIMUM OF 75 DEGREES FOR COOLING.

5. ALL INSULATION WHICH IS CAPABLE OF ABSORBING WATER SHALL BE PROTECTED BY A VAPOR BARRIER LOCATED ON THE WINTER WARM SIDE OF THE INSULATION. INSULATION SHALL BE INSTALLED IN A MANNER THAT PROVIDES CONTINUITY OF INSTALLATION AT PLATE LINES, SILL LINES AND CORNERS.

6. LOCAL ENERGY CONSERVATION CONSTRUCTION CODE ENERGY CONSERVATION CNSTRUCTION CODES THAT ARE MORE STRINGENT IN THEIR REQUIREMENTS THAN THE 2020 ENERGY CONSERVATION CODE

SHALL APPLY AND BE IMPLEMENTED WHEREVER REQUIRED. 7. EXTERIOR JOINTS AROUND WINDOWS AND DOOR FRAME, OPENINGS BETWEEN WALL AND ROOF/CEILING, FLOORS AND ROOFS, AND ALL OTHER SUCH OPENINGS IN THE BUILDING ENVELOPE SHALL BE CAULKED. GASKETED, WEATHERSTRIPPED OR OTHERWISE SEALED.

8. DESIGN PROFESSIONAL STATES THAT TO THE BEST OF HIS KNOWLEDGE AND PROFESSIONAL JUDGEMENT, THE DESIGN HAS BEEN MADE IN CONFORMANCE WITH THE ENERGY CODE. THE DESIGN PROFESSIONAL MUST PROVIDE SUPPORTING DATA AS REQUIRED IN THE ENERGY CONSERVATION CODE SECTION 104.1.

9. THIS DESIGN ANALYSIS IS NOT TO BE USED AS THE DETERMINING FACTOR IN COMPUTING THE DESIGN OF THE HEATING AND/OR VENTILATING EQUIPMENT TO BE INSTALLED IN THE BUILDING. TO DO SO WILL BE AT THE BUILDER AND/OR CONTRACTOR'S RISK. THE ENGINEER SHALL BE HELD BLAMELESS FOR ANY HEATING OR VENTILATING EQUIPMENT INSTALLED AT THE JOB SITE.

ELECTRICAL WORK TO BE PERFORMED BY AN ELECTRICIAN LICENSED IN

NY. PERMIT SHALL BE FILED UNDER SEPARATE APPLICATION.

WESTCHESTER COUNTY & SHALL COMPLY WITH NFPA 70, THE 2014 NATIONAL

ALL MECHANICAL WORK TO BE PERFORMED BY A LICENSED MECHANICAL

ALL MECHANICAL WORK SHALL COMPLY WITH THE 2020 RESIDENTIAL

ELECTRIC CODE & THE ELECTRICAL CODE FOR THE TOWN OF NORTH CASTLE,

PLUMBING

ELECTRICAL

MECHANICAL

BUILDING CODE OF NYS.

CONTRACTOR IN WESTCHESTER COUNTY.

NO PROPOSED PLUMBING WORK

GEOGRAPHIC, CLIMATIC & STRUCTURAL DESIGN CRITERIA

CLIMATIC AND GEOGRAPHIC DESIGN CRITERIA

GROUND SNOW LOAD	WIND SPEED	SEISMIC DESIGN CRITERIA	SU	BJECT TO D	AMAGE FRO	OM	WINTER DESIGN	ICE SHEILDS UNDER-	FLOOD HAZARDS
			WEATHERING	FROST LINE DEPTH	TERMITE	DECAY	ТЕМР.	LAYMENT REQUIRED	
30	100/110	С	SEVERE	42"	MODERATE TO HEAVY	SLIGHT TO MODERATE	7	YES	F.I.R.M. 360922 09/28/2007

CODE INSULATION

EXTERIOR DESIGN CONDITIONS - NEW YORK STATE

COUNTY		SUMMER DESIGN DRY-BULB TEMP.	COINCIDENT DESIGN WET-BULB TEMP.	HEATING DEGREE DAYS	ZONE
WESTCHESTER	7	84	73	5750	4

SIMPLIFIED PRESCRIPTIVE BUILDING ENVELOPE THERMAL COMPONENT CRITERIA MINIMUM REQUIRED THERMAL PERFORMANCE (U-FACTOR AND R-FACTOR)

CLIMATE ZONE: WESTCHESTER	MAXIMUM		MINIMUM					
	GLAZING SHGC	CEILING R-VALUE	WALL R-VALUE	FLOOR R-VALUE	BASEMENT WALL R-VALUE	SLAB PERIMETER R-VALUE	CRAWL SPACE WALL R-	
						AND DEPTH	VALUE	
ZONE: 4	0.40	R-49	R-21	R-19	R-10/13	R-10, 2'-0"	R-10/13	

BUILDING CODE ANALYSIS

RESIDENTIAL GROUP R-3	
EXISTING CONSTRUCTION CLASS	TYPE V-B

FIRE RESISTANCE RATING REQUIREMENTS FOR BUILDING ELEMENTS (HOURS) CONSTRUCTION CLASS TYPE V-B

BUILDING ELEMENT	REQUIRED RATING	EXIST. RATING	MATERIALS
STRUCTURAL FRAME	0	0	WOOD AND SHEETROCK
BEARING EXTERIOR WALL	0	0	WOOD AND SHEETROCK
BEARING INTERIOR WALL	0	0	WOOD AND SHEETROCK
NON-BEARING INTERIOR WALL	0	0	WOOD AND SHEETROCK
FLOOR CONSTRUCTION	0	0	WOOD AND SHEETROCK
ROOF CONSTRUCTION	0	0	WOOD AND SHEETROCK

GENERAL STRUCTURAL NOTES

1. ALL STRUCTURAL WORK SHALL COMPLY WITH THE BUILDING CODE OF N.Y.S.. STRUCTURAL DRAWINGS SUPERCEDE ARCH. DWGS. WHEN SPECIFYING ANY STRUCTURAL MEMBERS

2. ALL STRUCTURAL WORK SHALL BE COORDINATED WITH THE ARCHITECTURAL DRAWINGS, STRUCTURAL DRAWINGS AS WELL AS

SPECIFICATIONS. 3. ALL FRAMING LUMBER AND DETAILS OF WOOD CONSTRUCTION SHALL

CONFORM TO THE NATIONAL DESIGN SPECIFICATION FOR STRESS GRADE LUMBER AND ITS FASTENINGS

RAFTERS AND JOISTS: DOUGLAS FIR, LARCH #2 BEAMS, GRDRS. & HDRS: DOUGLAS FIR, LARCH #2

STUDS AND PLATE: DOUGLAS FIR, LARCH #2 4. ALL FACTORY MANUFACTURED GLUE LAMINATED WOOD FRAMING MEMBERS (LVL) SHALL BE TJI JOISTS AND MICRO-LAM BEAMS AS MANUFACTURED BY TRUS JOIST CORPORATION, OR APPROVED.

5. ALL FLUSH FRAMED CONNECTIONS SHALL BE MADE WITH APPROVED GALVANIZED DOUBLE SHEAR JOIST OR BEAM HANGERS, MINIMUM 18 GAUGE, INSTALLED ACCORDING TO MANUFACTURER'S RECOMMENDATIONS.


6. ALL RAFTERS AND JOISTS SHALL ALIGN DIRECTLY WITH STUDS BELOW; WHERE REQUIRED INSTALL ADDITIONAL STUDS. USE DOUBLE STUDS AT ENDS OF WALLS AND ENDS OF OPENINGS. USE DOUBLE TRIMMERS AND HEADERS AT ALL FLOOR OPENINGS WHERE BEAMS ARE NOT DESIGNATED. LAP ALL PLATES AT CORNERS AND AT INTERSECTION OF PARTITIONS. 7. BUILT-UP BEAMS SHALL BE SPIKED TOGETHER WITH (2) 16D NAILS @ 16" O.C. AS PER RCNYS.

8. AT THE END OF ALL BEAMS, HEADERS AND GIRDERS PROVIDE A BUILT UP OR SOLID POST WHOSE WIDTH IS AT LEAST EQUAL TO THE WIDTH OF THE MEMBER IT IS SUPPORTING.

9. STAGGER ALL SPLICES A MINIMUM OF 32 INCHES. 10. PLYWOOD SHALL BE APA GRADE STAMPED AND SHALL NOT EXCEED THE SPANS INTENDED FOR USE ON THE GRADE STAMP. ALL PLYWOOD PLYWOOD SHALL BE MADE WITH EXTERIOR GLUE. ALL PLYWOOD SHALL BE GLUED AND SCREWED TO FLOOR JOISTS USING AN APA APPROVED ADHESIVE (B.F. GOODRICH PL400 OR EQUAL).

GIS MAPPING

15 LAKEVIEW DR N. ID: 122.16-4-16 (North Castle)

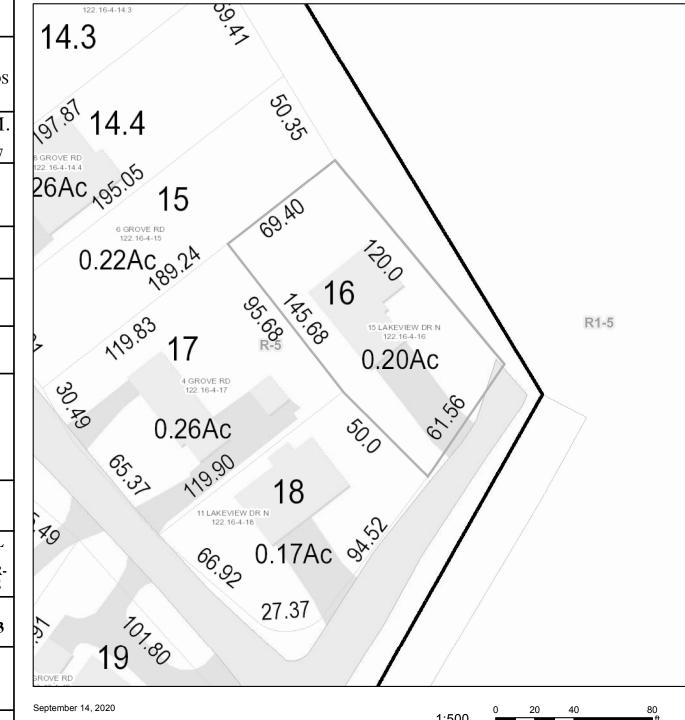

Tax parcel data was provided by local municipality. This map is generated as a public service to

ADDRESS: 15 Lakeview Drive N White Plains, N.Y, 10603

SECTION: 122.16 BLOCK: 4 LOT: 16

INSTALLATION AND MAINTENANCE OF **EROSION CONTROL**

CONSTRUCTION SCHEDULE

NOTIFY APPROPRIATE MUNICIPAL AGENCY HAVING JURISDICTION AT LEAST 5 DAYS PRIOR TO START

EROSION CONTROL MEASURES

Install all erosion control measures prior to start of construction. Call for inspection from the appropriate Municipal Agency having jurisdiction at least 2 days prior to finish.

INSPECTION BY MUNICIPALITY

MAINTENANCE (TO BE PERFORMED DURING ALL PHASES OF CONSTRUCTION)

After any rain causing runoff Contractor to inspect haybales, etc. and remove any excessive sediment, and inspect stockpiles and correct any problems with seed establishment

Inspections shall be documented in writing and submitted to the appropriate Municipal Agency having jurisdiction.

STOCK PILING OF EXCAVATED MATERIAL

Strip Topsoil and Stockpile.

Stockpile Excavation Subgrade. Seed piles with 1 lb. total annual rye or remove from site within 2 days.

FINAL GRADING

Remove unneeded subgrade from site.

Call for inspection from the appropriate Municipal Agency having jurisdiction at at least 2 days prior to finish.

LANDSCAPING

Spread topsoil evenly over areas to be seeded. Hand rake level. Broadcast 1:25 lb. Bag of Jonathan Green "Fastgrow" mix or equal over areas to be seeded. Apply straw mulch and water within 2 days of completion of topsoiling

Call for inspection from the appropriate Municipal Agency having jurisdiction at least 2 days prior to finish.

FINAL LANDSCAPING

Grass established.

Call for inspection from the appropriate Municipal Agency having jurisdiction at least 2 days prior to finish.

FINAL INSPECTION

1. All erosion control measures removed and grass established.

2. Call for inspection from the appropriate Municipal Agency having jurisdiction at least 2 days prior to finish.



Westchester County GIS

Michaelian Office Building 148 Martine Avenue Rm 214 White Plains, New York 10601

A.002

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NO D D

JONATHAN
VILLANI

ASSOCIATES

Jonathan Villani & Assoc. Inc.

15 Independence Street

White Plains, N.Y., 10606

P 914-575-1071

jmvarch@gmail.com

Annunziata & Villani

Design Consultants. Inc.

15 Independence Street

White Plains, N.Y., 10606

P 914-575-1071

jmvarch@gmail.com

IN ASSOCIATION WITH:


John J. Annunziata, P.E. 24 Chesley Road White Plains, N.Y., 10605 P-914-949-0270 F-914-428-6235

AS NOTED 9/30/20 CHECKED BY: DRAWING TITLE:

GENERAL NOTES

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EXISTING ZONING ANALYSIS


7015 5 5		SCHEDULE OF	REQUIREMEN	ITS		
ZONE: R-5	BUILDING HEIGHT	MIN. LOT SIZE	LOT WIDTH	LOT DEPTH	BUILDING COVERAGE	IMPERVIOUS SURFACE
	FEET	AREA (MIN.)	FEET	FEET	%/sf	%
REQUIRED	2 ^{1/2} / 30'	5,000 SF	50 FT	100 FT	30%	
EXISTING	1 ^{1/2} / 25'	8,712 SF	61.56 FT	105 FT	19%	
		MINIMUM YARD	DIMENSIONS	(FT.)		
	MINIMUM FRONT SETBACK (DEPTH)	SIDE YARD	SIDE Y (COMB		_	M REAR DEPTH)
REQUIRED	30'	8'	18	,1	30'	
EXISTING	29.30'	10.40'	22.11'		45.	67'
PROPOSED						

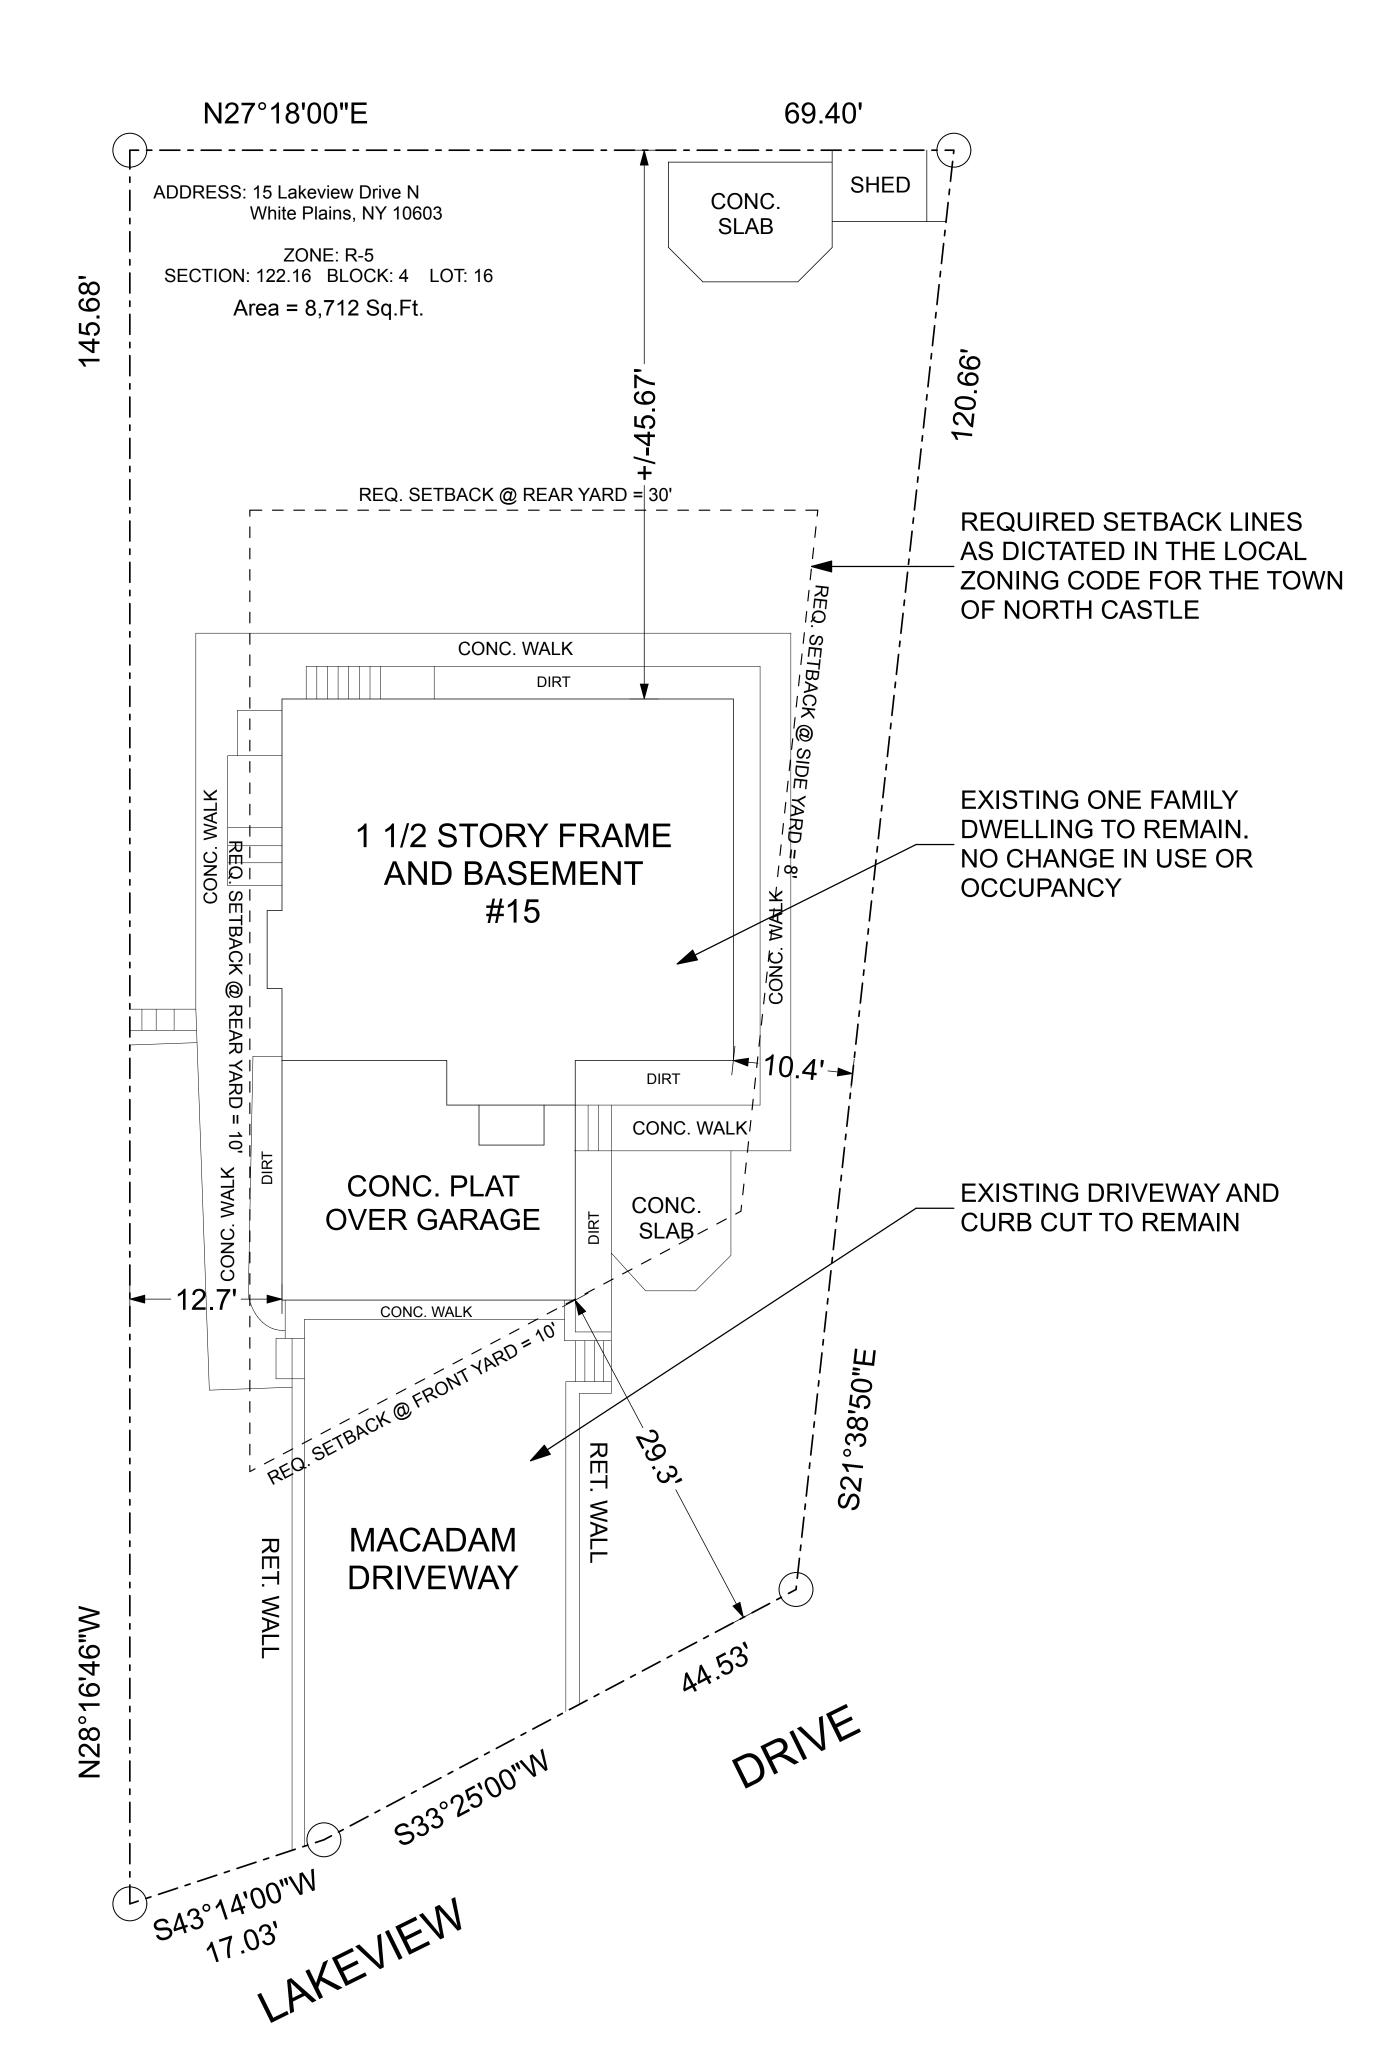

Jonathan Villani & Assoc. Inc. 15 Independence Street White Plains, N.Y., 10606 P 914-575-1071 jmvarch@gmail.com

Annunziata & Villani Design Consultants. Inc. 15 Independence Street White Plains, N.Y., 10606 P 914-575-1071 jmvarch@gmail.com

10603 V DRIVE IS, NEW

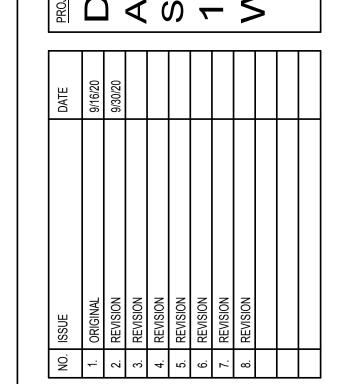

IN ASSOCIATION WITH:

John J. Annunziata, P.E. 24 Chesley Road White Plains, N.Y., 10605 P-914-949-0270 F-914-428-6235

SCALE: AS NOTED


EXISTING SITE PLAN

A.003

8,712 SF

EXISTING SITE PLAN



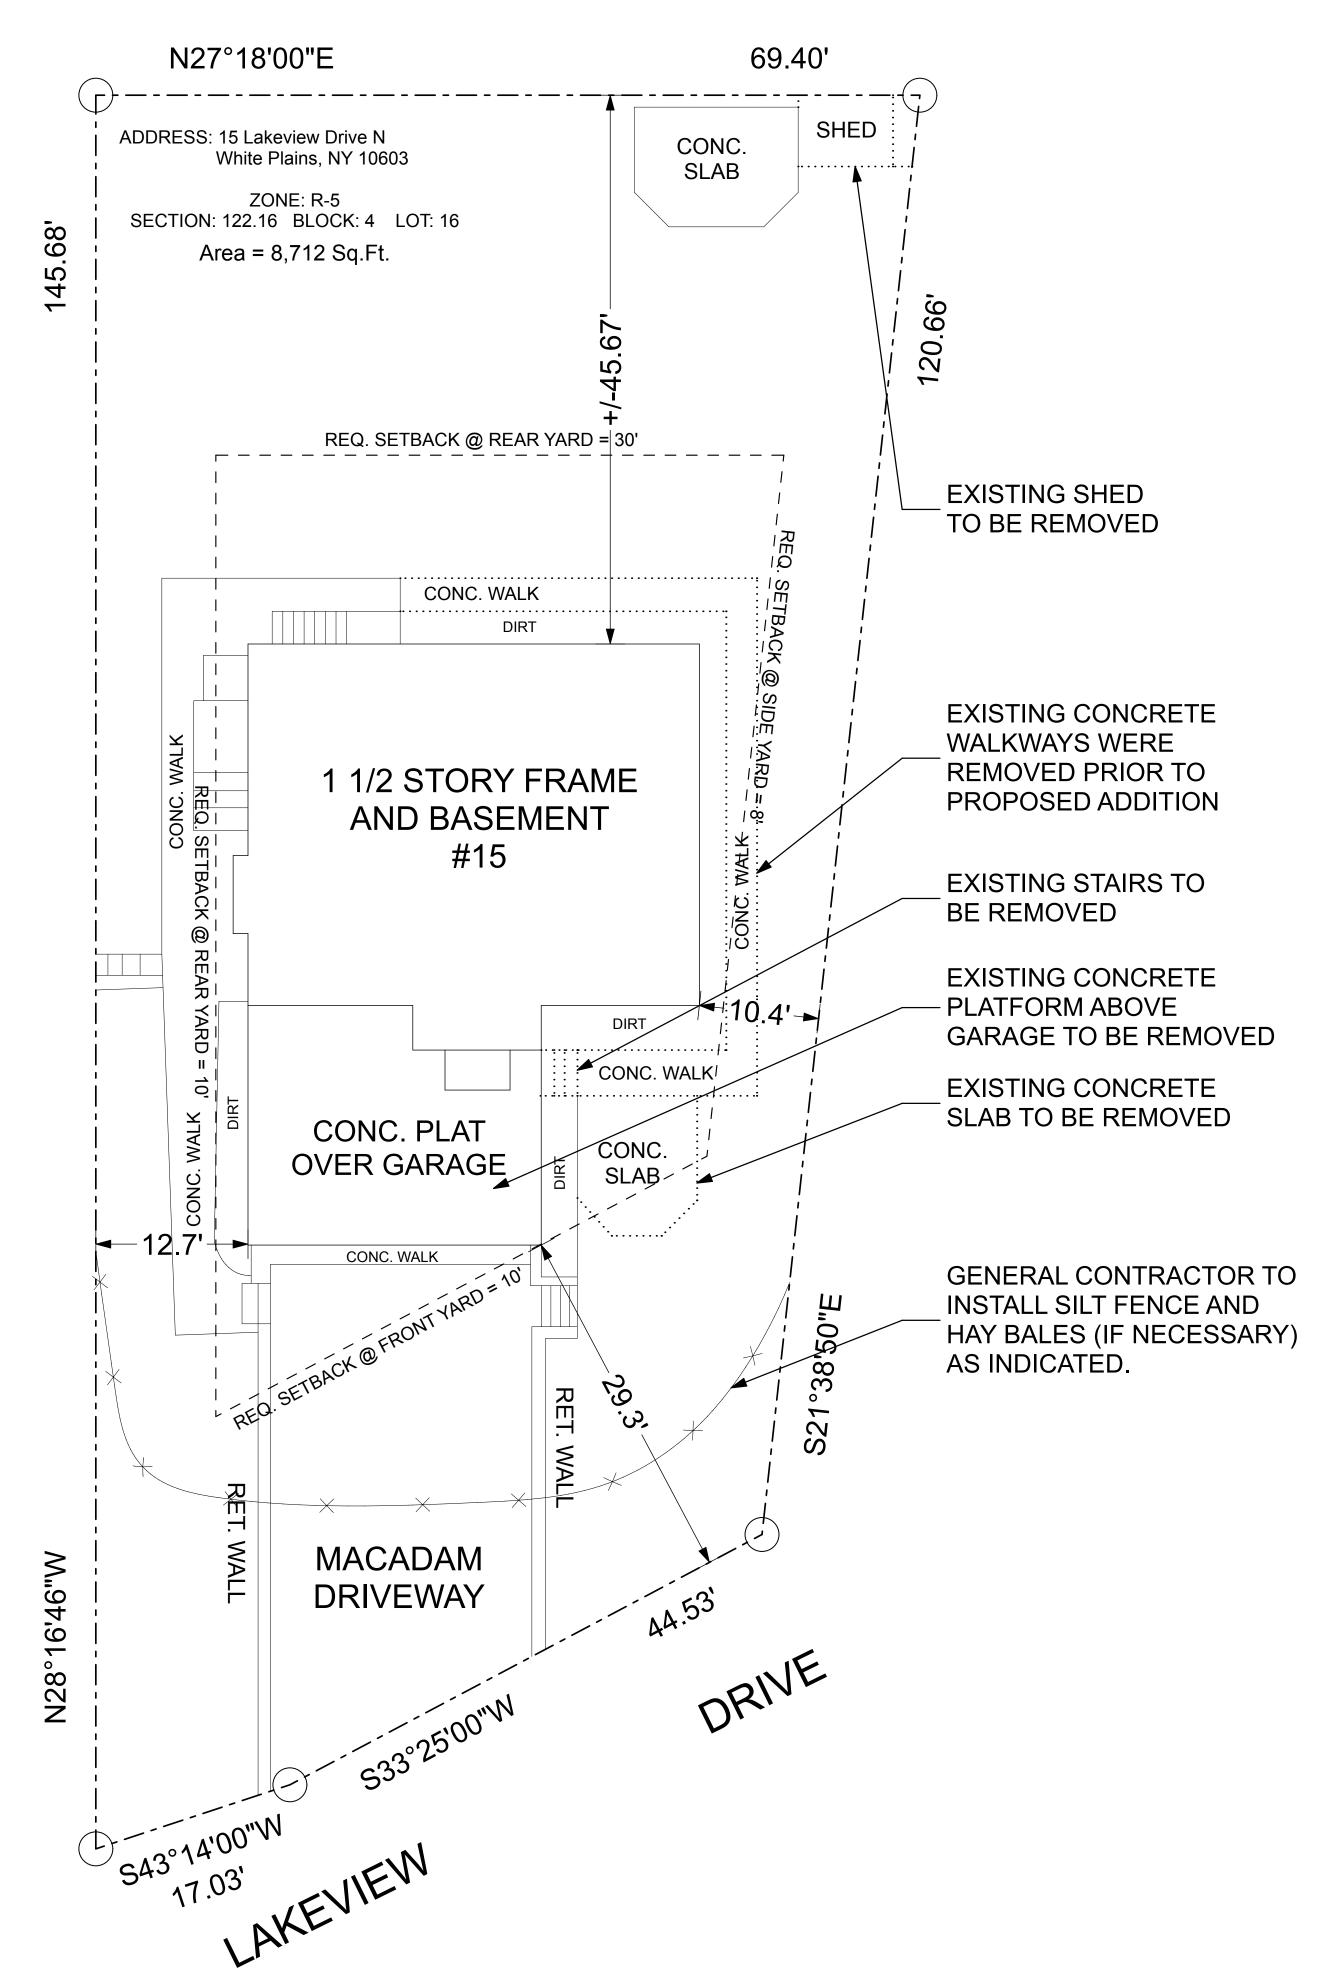

EXISTING IMPERVIOUS SURFACE

EXISTING BUILDING FOOTPRINT: 1,620 SF
EXISTING DRIVEWAY: 872 SF
EXISTING WALKWAYS: 585 SF
EXISTING WALLS, STEPS AND PLATS: 339 SF
EXISTING IMPERVIOUS SURFACE TOTAL: 3,416 SF

AREA OF LAND: 8,712 SF EXISTING IMPERVIOUS SURFACE EQUALS = 39%

SANITARY AND WATER:

NO CHANGE TO EXISTING SERVICES

EXISTING ZONING ANALYSIS

70.15 5 5		SCHEDULE OF	REQUIREMEN	ITS					
ZONE: R-5	BUILDING HEIGHT	MIN. LOT SIZE	LOT WIDTH LOT DEPTH		BUILDING COVERAGE	IMPERVIOUS SURFACE			
	FEET	AREA (MIN.)	FEET	FEET	%/sf	%			
REQUIRED	2 ^{1/2} / 30'	5,000 SF	50 FT	100 FT	30%				
EXISTING	1 ^{1/2} / 25'	8,712 SF	61.56 FT	61.56 FT 145.68 FT		39%			
		MINIMUM YARD DIMENSIONS (FT.)							
	MINIMUM FRONT SETBACK (DEPTH)	SIDE YARD	SIDE Y (COMB		MINIMU YARD (
REQUIRED	30'	8'	18	,1	30'				
EXISTING	29.30'	10.40'	22.11'		45.	67'			
PROPOSED									

STAGING AND EROSION CONTROL

1. INSTALL SEDIMENTATION AND EROSION CONTROLS AND TREE PROTECTION AS NEEDED THROUGHOUT.

2. PRIOR TO DEMOLITION THE GENERAL CONTRACTOR SHALL OBTAIN

A DEMOLITON PERMIT.

BACKFILL WITH CLEAN COMPACTED SOIL FILL AS DIRECTED.
 MARK AND CUT TREES TO BE REMOVED IF NECESSARY.


5. STRIP TOP SOIL AND STOCK PILE IT WIT APPROPRIATE

SEDIMENTATION CONTROL MEASURES.

6. EXCAVATE FOR PROPOSED FOUNDATION.7. CONSTRUCT FOUNDATION.

8. BACKFILL AND ROUGH GRADE AROUND BUILDING FOUNDATION

AND STABILIZE ALL SLOPES.

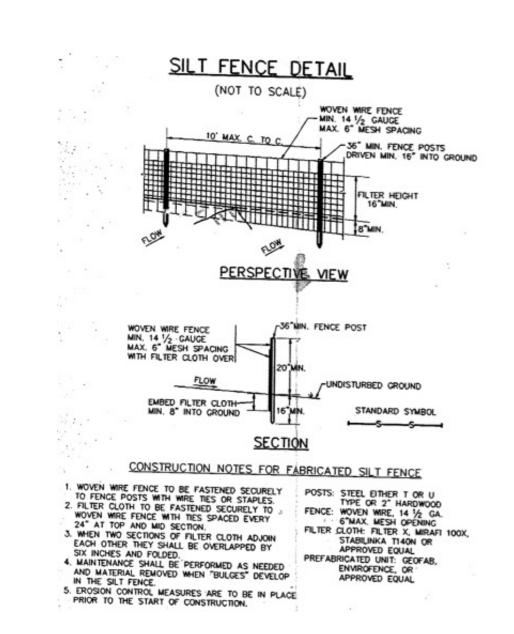

B A-004

EROSION CONTROL DETAIL

SCALE: NTS





Jonathan Villani & Assoc. Inc. 15 Independence Street White Plains, N.Y., 10606 P 914-575-1071 jmvarch@gmail.com

Annunziata & Villani
Design Consultants. Inc.
15 Independence Street
White Plains, N.Y., 10606
P 914-575-1071
jmvarch@gmail.com

OOUGLAS RESIDENCE
DDITION AND ALTERATIONS TO EXISTING
TRUCTURE
STRUCTURE
STRUCTURE
WHITE PLAINS, NEW YORK, 10603

 NO. ISSUE
 DATE

 1. ORIGINAL
 9/16/20

 2. REVISION
 9/30/20

 3. REVISION
 6. REVISION

 6. REVISION
 7. REVISION

 8. REVISION
 8. REVISION

IN ASSOCIATION WITH:

John J. Annunziata, P.E. 24 Chesley Road White Plains, N.Y., 10605 P-914-949-0270 F-914-428-6235

SCALE: DATE: PROJECT NO 9/30/20


DRAWN BY: CHECKED BY: APPROVED IN JV

EROSION CONTROL PLAN

A.004

EROSION CONTROL PLAN



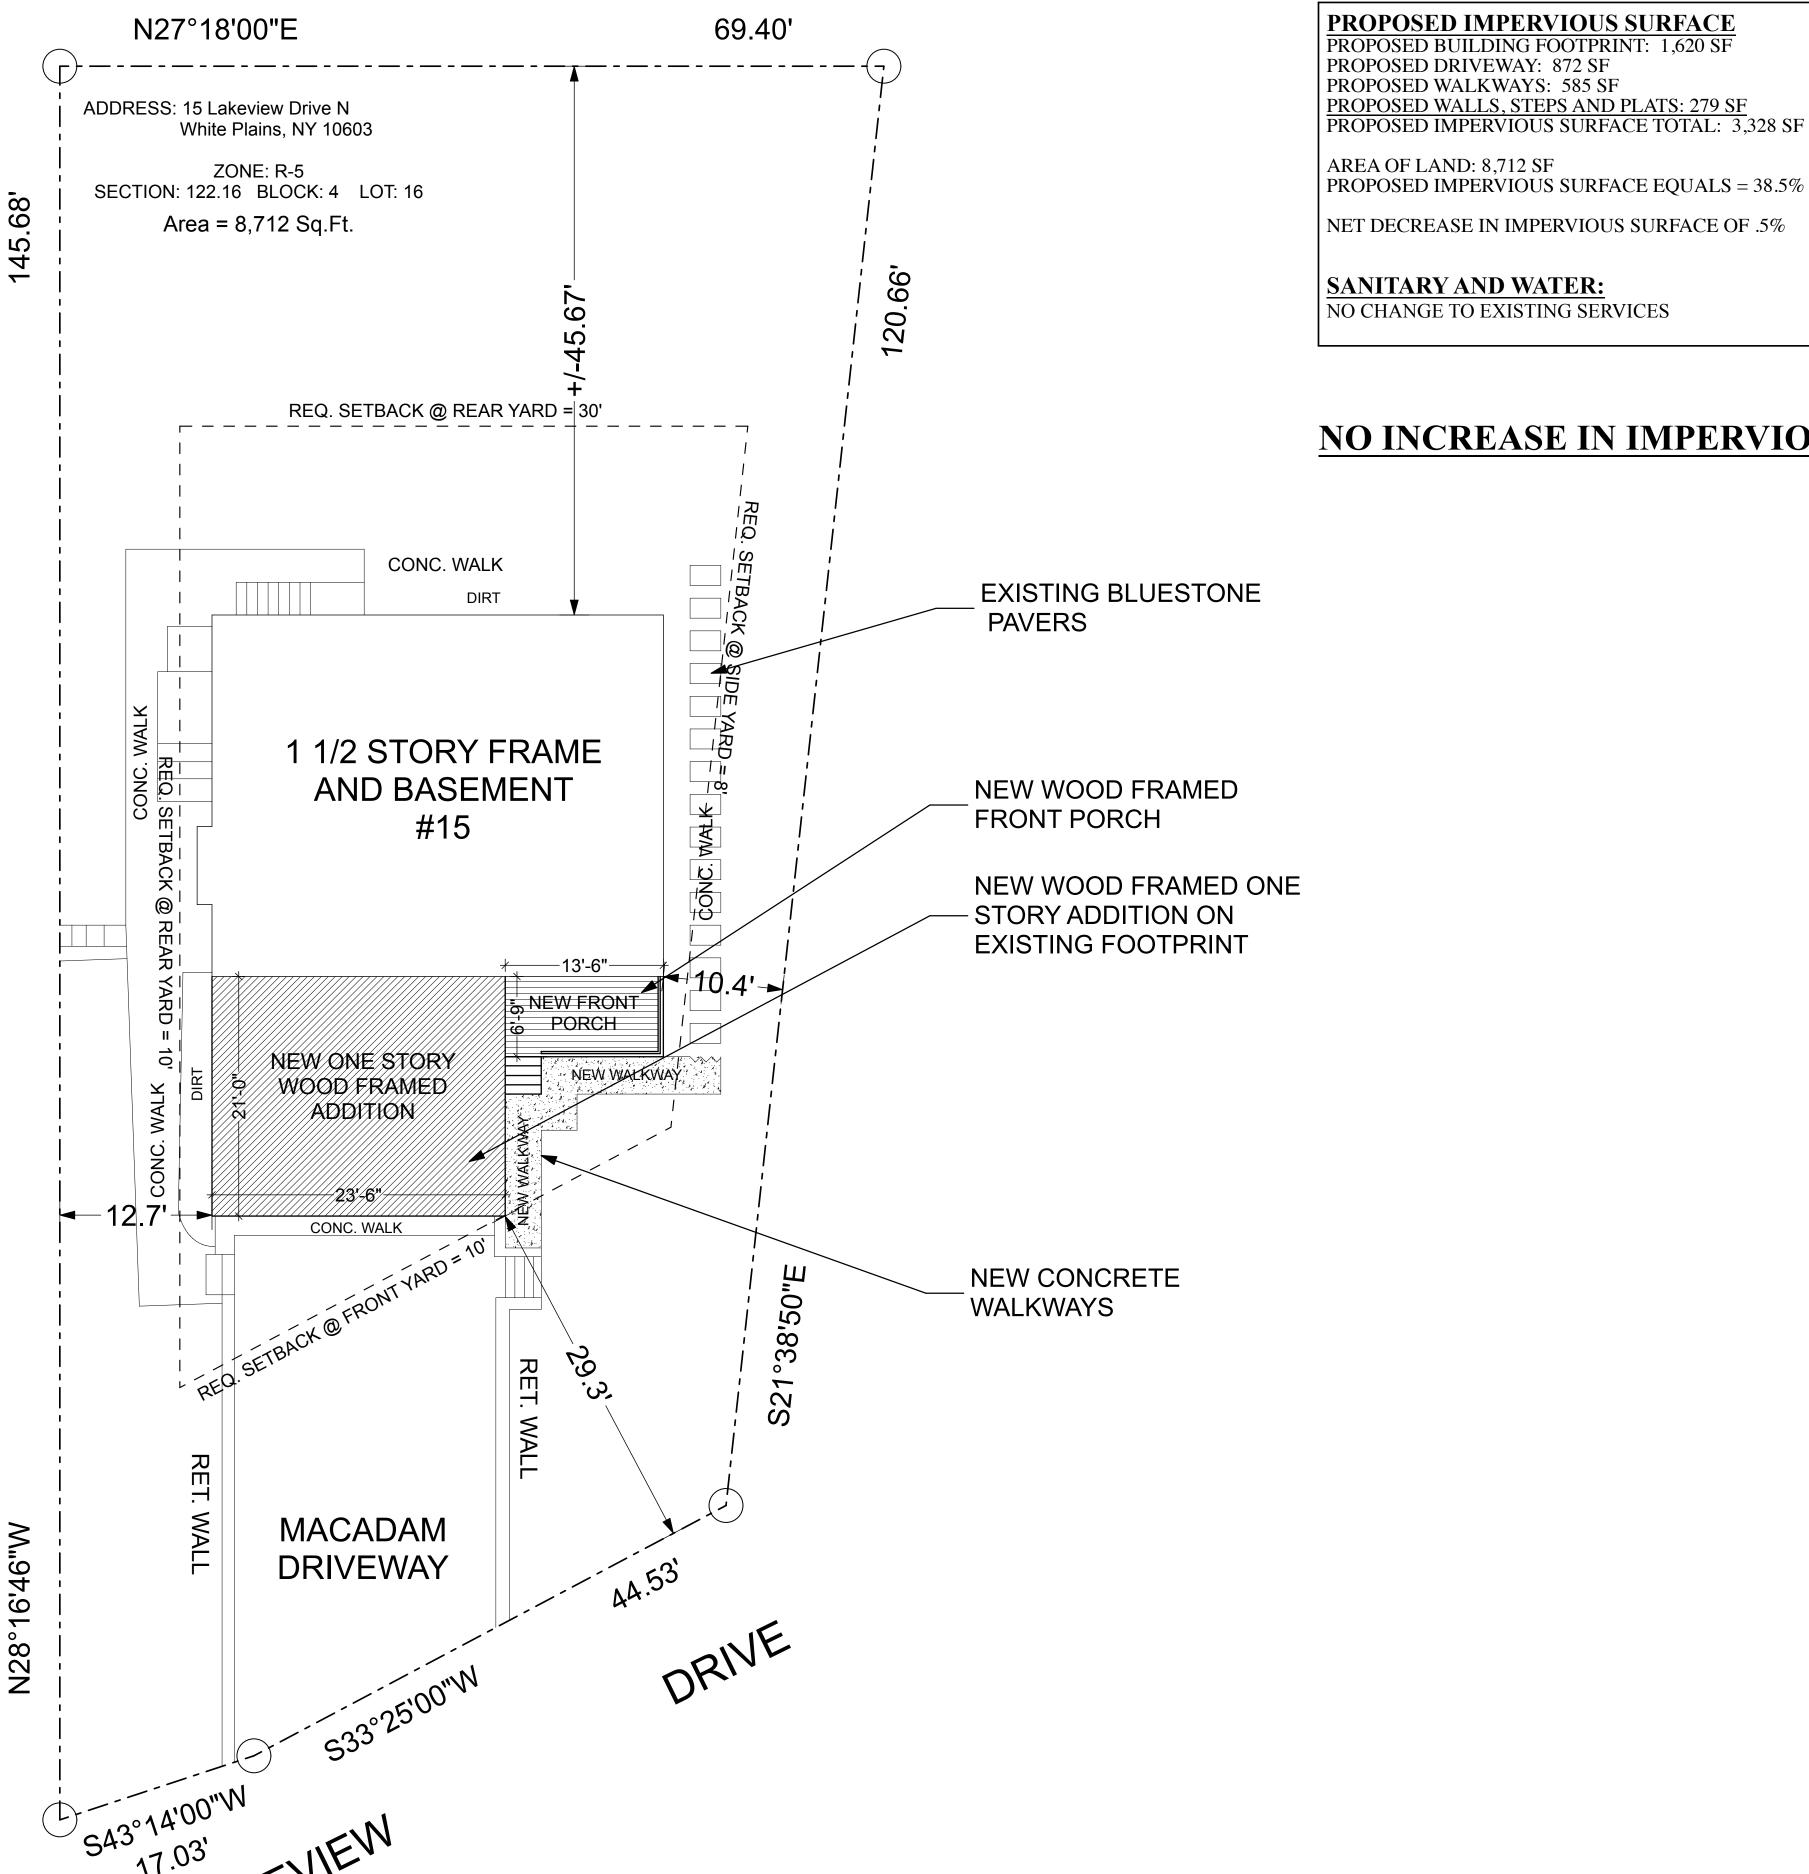


PROPOSED ZONING ANALYSIS

		SCHEDULE OF	REQUIREMEN	ITS				
ZONE: R-5	BUILDING HEIGHT	MIN. LOT SIZE	. LOT SIZE LOT WIDTH		BUILDING COVERAGE	IMPERVIOUS SURFACE		
	FEET	AREA (MIN.)	FEET	FEET	%/sf	%		
REQUIRED	2 ^{1/2} / 30'	5,000 SF	50 FT	100 FT	30%			
EXISTING	1 1/2 / 25'	8,712 SF	61.56 FT	145.68 FT	18.6%	39%		
PROPOSED	2 / 25'	NO CHANGE	NO CHANGE	NO CHANGE	NO CHANGE	38.5%		
	MINIMUM YARD DIMENSIONS (FT.)							
		MINIMUM YARD I	DIMENSIONS	(FI.)				
	MINIMUM FRONT SETBACK (DEPTH)	SIDE YARD	SIDE Y (COMB	ARD	I -	M REAR DEPTH)		
REQUIRED			SIDE Y	(ARD INED)	YARD (
REQUIRED EXISTING	SETBACK (DEPTH)	SIDE YARD	SIDE Y (COMB	(ARD INED)	YARD (DEPTH)		

NO INCREASE IN IMPERVIOUS SURFACE

AREA OF LAND: 8,712 SF

NO CHANGE TO EXISTING SERVICES

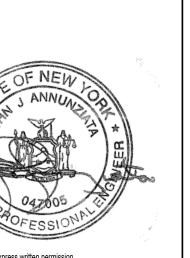

JONATHAN VILLANI ASSOCIATES

Jonathan Villani & Assoc. Inc. 15 Independence Street White Plains, N.Y., 10606 P 914-575-1071 jmvarch@gmail.com

Annunziata & Villani Design Consultants. Inc. 15 Independence Street White Plains, N.Y., 10606 P 914-575-1071 jmvarch@gmail.com

10603

										_
DATE	9/16/20	9/30/20								
NO. ISSUE	ORIGINAL	REVISION								
Ö	1	2.	3.	4.	5.	6.	7.	8.		

IN ASSOCIATION WITH:


John J. Annunziata, P.E. 24 Chesley Road White Plains, N.Y., 10605 P-914-949-0270 F-914-428-6235


SCALE: AS NOTED

PROPOSED SITE PLAN

A.005

PROPOSED SITE PLAN

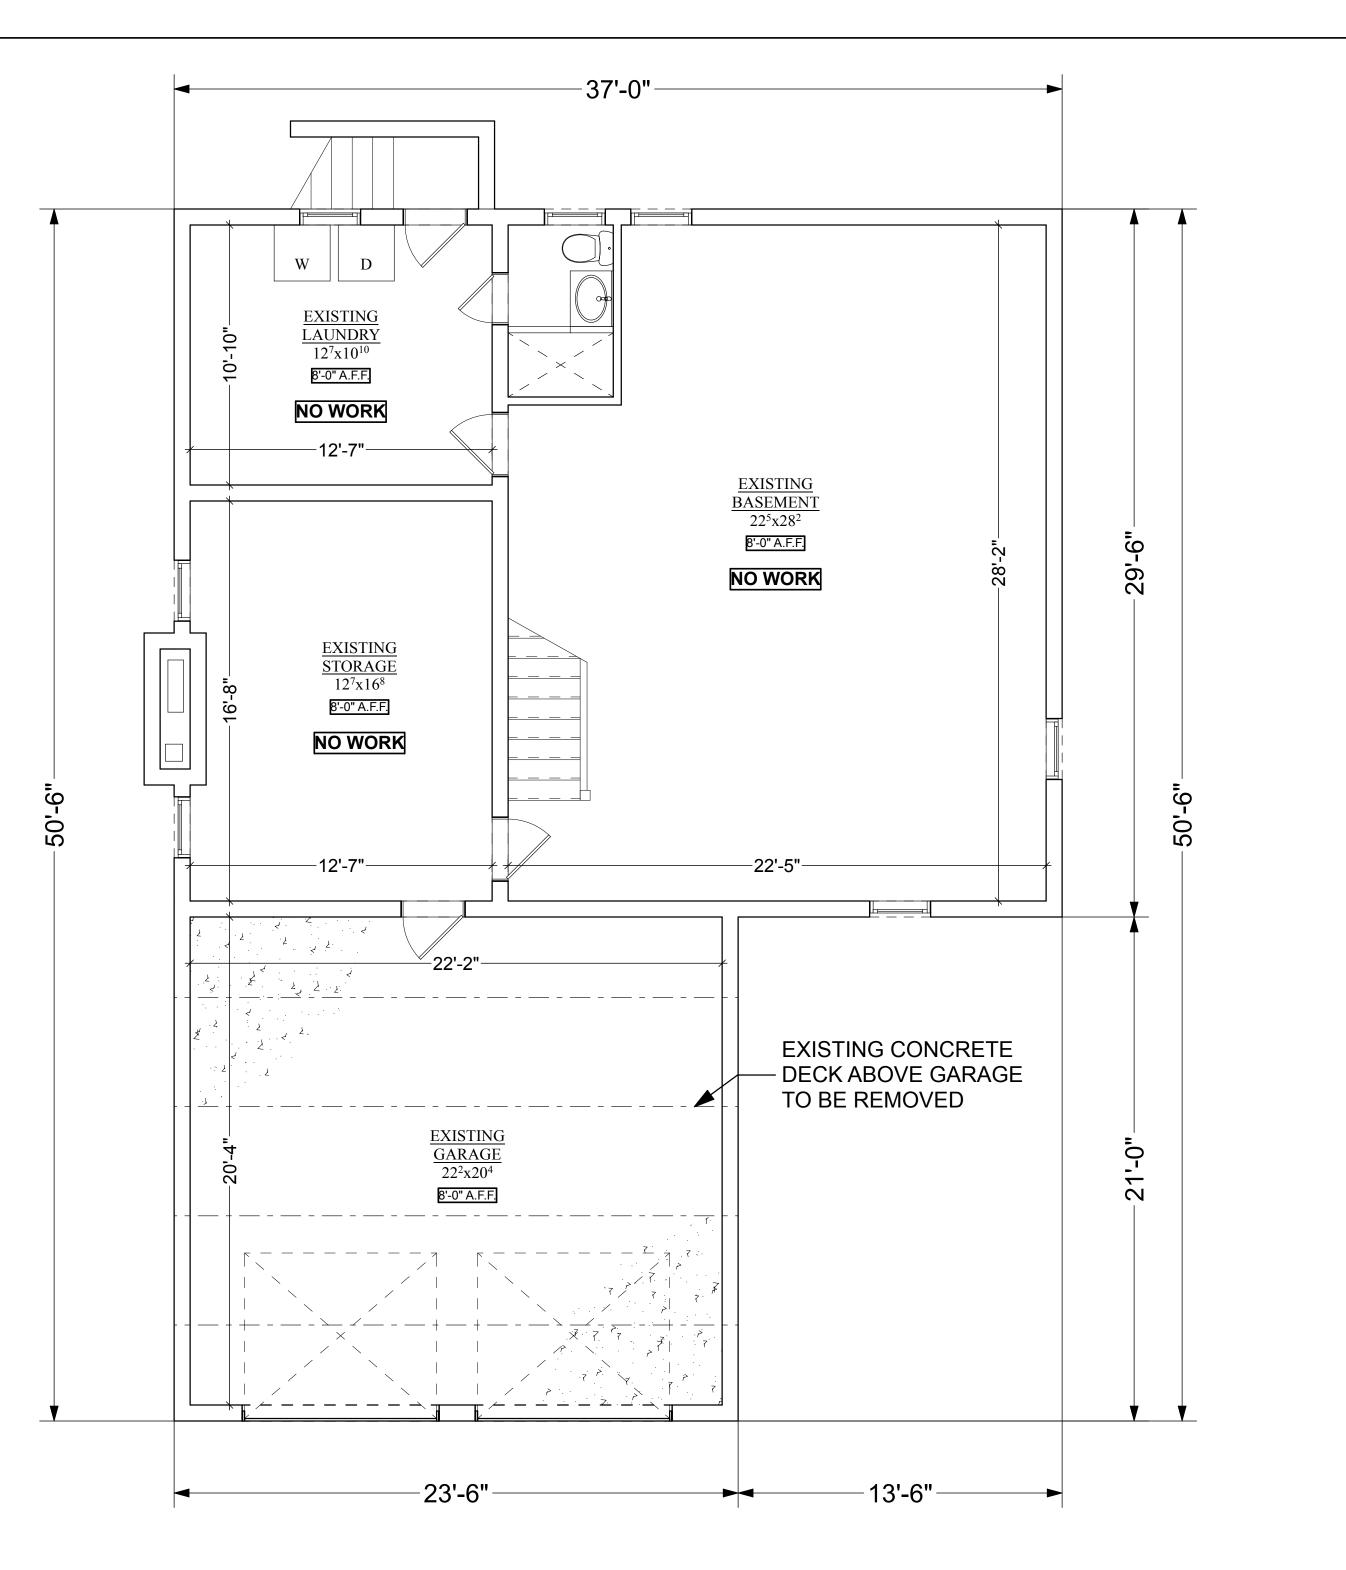

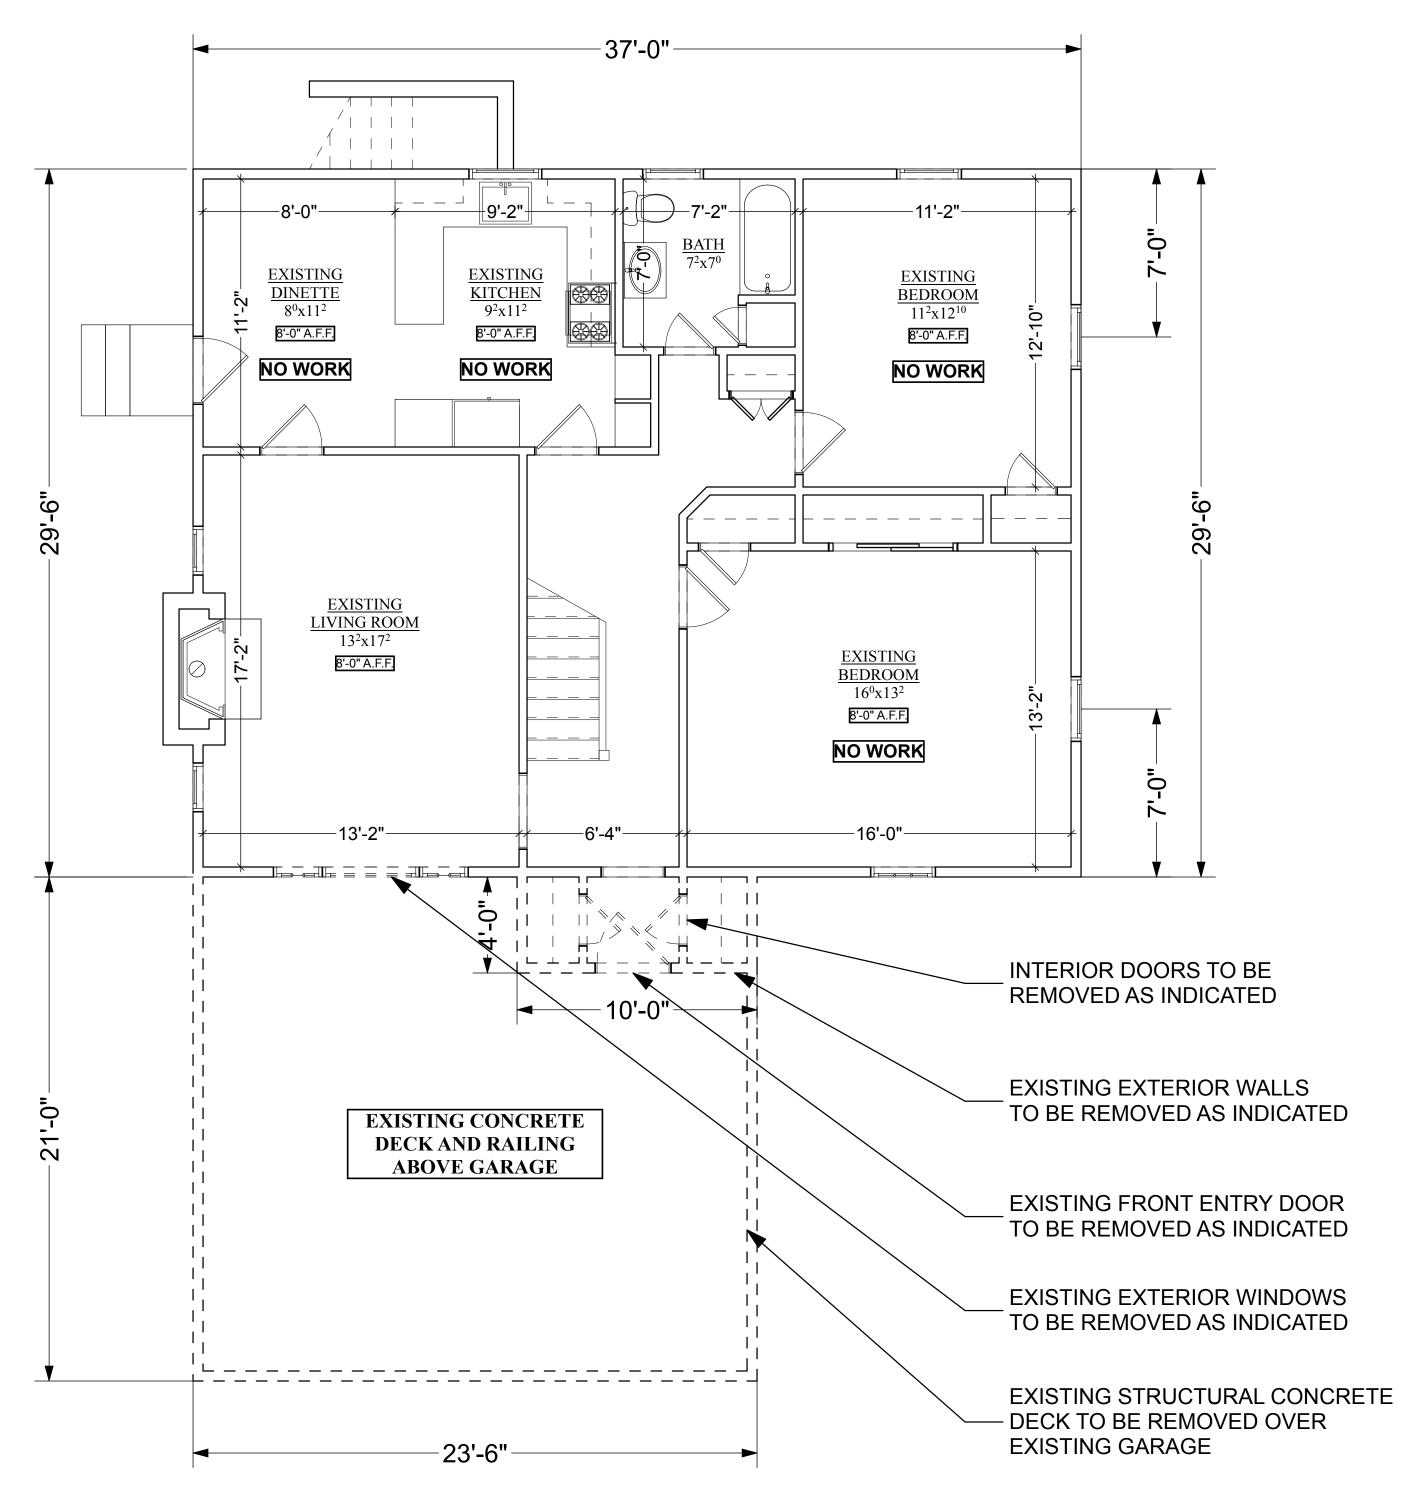



EXISTING BASEMENT PLAN

SCALE: 1/4" = 1' - 0"

EXISTING SF @ BASEMENT 1,091 SF BELOW GRADE

EXISTING FIRST FLOOR PLAN

EXISTING SF @ 1ST FLOOR

1,131 SF

DEMOLITION NOTES


- 1. G.C. TO REMOVE ITEMS AS INDICATED ON DEMOLITION PLAN UNLESS OTHERWISE NOTED.
- 2. G.C. TO PROTECT ANY AND ALL ITEMS TO BE REUSED TROUGHOUT CONSTRUCTION PHASE.
- 3. G.C. TO REMOVE ALL PLUMBING FIXTURES AND ASSOCIATED PIPING AS NECESSARY.
- RADIATORS TO BE REPLACED IN SAME LOCATIONS. 4. G.C. TO REPLACE MECHANICAL SYSTEMS TO ACCOMODATE
- REPAIRS. 5. G.C. TO PROVIDE ALL TEMPORARY WATERPROOFING DUE TO REMOVAL OF VENTS AND EXHAUST FANS FROM EXISTING ROOF
- THROUGHOUT CONSTRUCTION PHASE. 6. G.C. TO HAVE FIRE EXTINGUISHERS ON PREMISES
- THOUGHOUT CONSTRUCTION PHASE AS SAFETY PRECAUTION. 7. G.C. TO PROVIDE HARD HATS AND GOGGLES TO ALL WORKERS THROUGHOUT DEMOLITION AS WELL CONSTRUCTION.
- 8. G.C. TO PROVIDE ALL PROTECTIVE BARRIERS TO LIMIT ACCESS THROUGHOUT CONSTRUCTION PHASE.
- 9. G.C. TO MAINTAIN A SAFE AND CLEAR PEDESTRIAN PATH THROUGH CONSTRUCTION AREA THROUGHOUT DURATION OF PROJECT.

CLEANING:

1. MAINTAIN PREMISES AND PUBLIC PROPERTIES FREE FROM ACCUMULATIONS OF WASTE, DEBRIS AND RUBBISH CAUSED BY OPERATIONS. 2. AT COMPLETION OF WORK, REMOVE WASTE

MATERIALS, RUBBISH, TOOLS, EQUIPMENT, MACHINERY AND SURPLUS MATERIALS, AND CLEAN ALL SIGHT EXPOSED SURFACES; LEAVE PROJECT CLEAN AND READY FOR FOR OCCUPANCY.



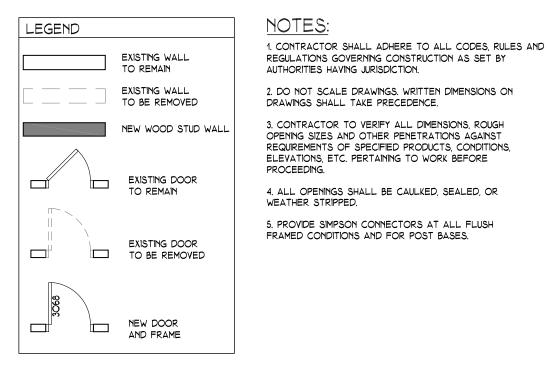

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IN ASSOCIATION WITH:

| John J. Annunziata, P.E. 24 Chesley Road White Plains, N.Y., 10605 P-914-949-0270 F-914-428-6235

JONATHAN
VILLANI

ASSOCIATES

Jonathan Villani & Assoc. Inc.

15 Independence Street

White Plains, N.Y., 10606

P 914-575-1071

jmvarch@gmail.com

Annunziata & Villani

Design Consultants. Inc.

15 Independence Street White Plains, N.Y., 10606


P 914-575-1071

jmvarch@gmail.com

AS NOTED 9/30/20 DRAWING TITLE:

> **EXISTING FLOOR PLANS**

A.006

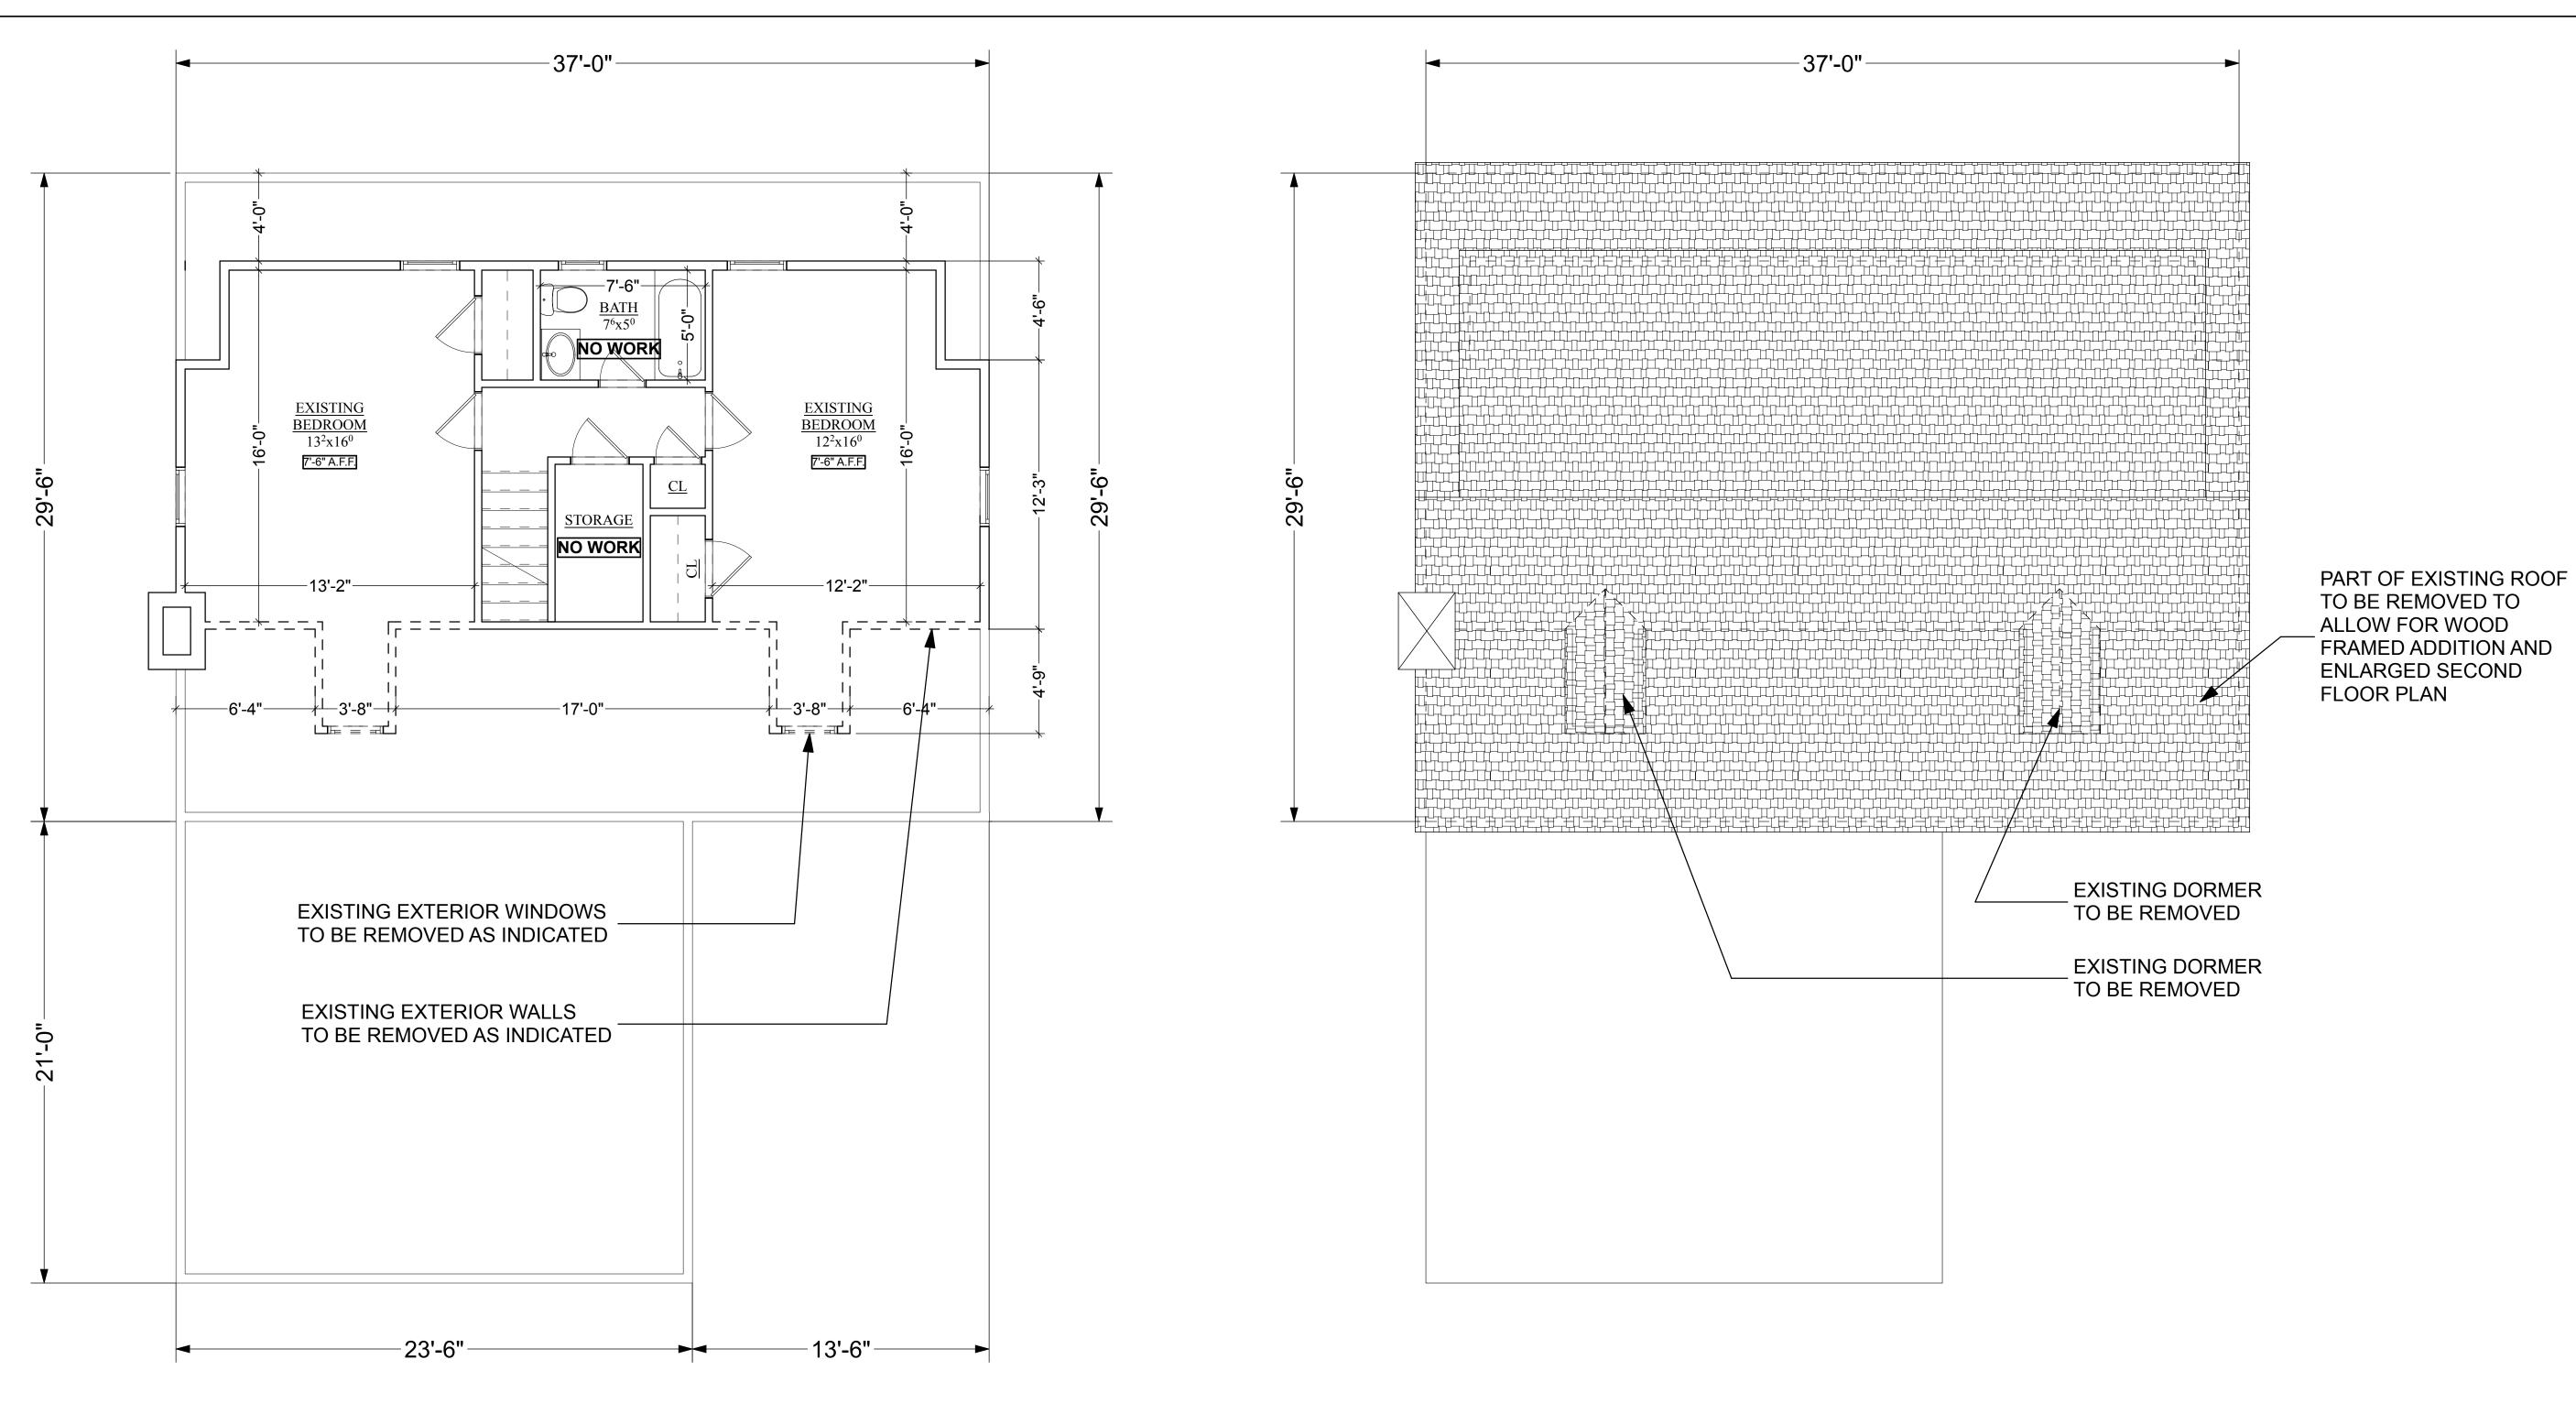

A EXISTING

A.007 SCALE: 1/4" = 1' - 0"

EXISTING SECOND FLOOR PLAN

EXISTING SF @ SECOND FLOOR

634 SF

DEMOLITION NOTES

1. G.C. TO REMOVE ITEMS AS INDICATED ON DEMOLITION PLAN UNLESS OTHERWISE NOTED.

2. G.C. TO PROTECT ANY AND ALL ITEMS TO BE REUSED TROUGHOUT CONSTRUCTION PHASE.

3. G.C. TO REMOVE ALL PLUMBING FIXTURES AND ASSOCIATED PIPING AS NECESSARY.

RADIATORS TO BE REPLACED IN SAME LOCATIONS.
4. G.C. TO REPLACE MECHANICAL SYSTEMS TO ACCOMODATE

REPAIRS.
5. G.C. TO PROVIDE ALL TEMPORARY WATERPROOFING DUE TO REMOVAL OF VENTS AND EXHAUST FANS FROM EXISTING ROOF THROUGHOUT CONSTRUCTION PHASE.

6. G.C. TO HAVE FIRE EXTINGUISHERS ON PREMISES
THOUGHOUT CONSTRUCTION PHASE AS SAFETY PRECAUTION.
7. G.C. TO PROVIDE HARD HATS AND GOGGLES TO ALL WORKERS

THROUGHOUT DEMOLITION AS WELL CONSTRUCTION.
8. G.C. TO PROVIDE ALL PROTECTIVE BARRIERS TO LIMIT ACCESS THROUGHOUT CONSTRUCTION PHASE.


9. G.C. TO MAINTAIN A SAFE AND CLEAR PEDESTRIAN PATH THROUGH CONSTRUCTION AREA THROUGHOUT DURATION OF PROJECT.

CLEANING:

MAINTAIN PREMISES AND PUBLIC PROPERTIES
FREE FROM ACCUMULATIONS OF WASTE, DEBRIS AND
RUBBISH CAUSED BY OPERATIONS.
 AT COMPLETION OF WORK, REMOVE WASTE
MATERIALS, RUBBISH, TOOLS, EQUIPMENT,

MACHINERY AND SURPLUS MATERIALS, AND CLEAN ALL SIGHT EXPOSED SURFACES; LEAVE PROJECT CLEAN AND READY FOR FOR OCCUPANCY.

B EXISTING ROOF PLAN SCALE: 1/4" = 1' - 0"

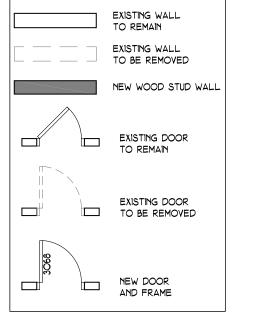

NOTES:

1. CONTRACTOR SHALL ADHERE TO ALL CODES, RULES AND REGULATIONS GOVERNING CONSTRUCTION AS SET BY AUTHORITIES HAVING JURISDICTION.

2. DO NOT SCALE DRAWINGS. WRITTEN DIMENSIONS ON

DRAWINGS SHALL TAKE PRECEDENCE.

3. CONTRACTOR TO VERIFY ALL DIMENSIONS, ROUGH OPENING SIZES AND OTHER PENETRATIONS AGAINST REQUIREMENTS OF SPECIFIED PRODUCTS, CONDITIONS, ELEVATIONS, ETC. PERTAINING TO WORK BEFORE PROCEEDING.

4. ALL OPENINGS SHALL BE CAULKED, SEALED, OR WEATHER STRIPPED.

5. PROVIDE SIMPSON CONNECTORS AT ALL FLUSH FRAMED CONDITIONS AND FOR POST BASES.



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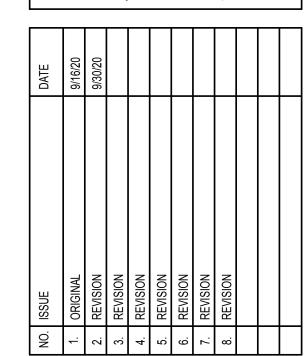
Annunziata & Villani
Design Consultants. Inc.
15 Independence Street
White Plains, N.Y., 10606
P 914-575-1071
imvarch@gmail.com

jmvarch@gmail.com

S TO EXISTING

K 10603

ADDITION AND ALTERATIONS TO EX
STRUCTURE
15 LAKEVIEW DRIVE N
WHITE PLAINS, NEW YORK, 106



IN ASSOCIATION WITH:

John J. Annunziata, P.E.

24 Chesley Road

White Plains, N.Y., 10605

P-914-949-0270

F-914-428-6235


SCALE: DATE: PROJECT NO.:
AS NOTED 9/30/20


DRAWN BY: CHECKED BY: APPROVED BY:
JV

DRAWING TITLE:

EXISTING FLOOR PLANS

A.007

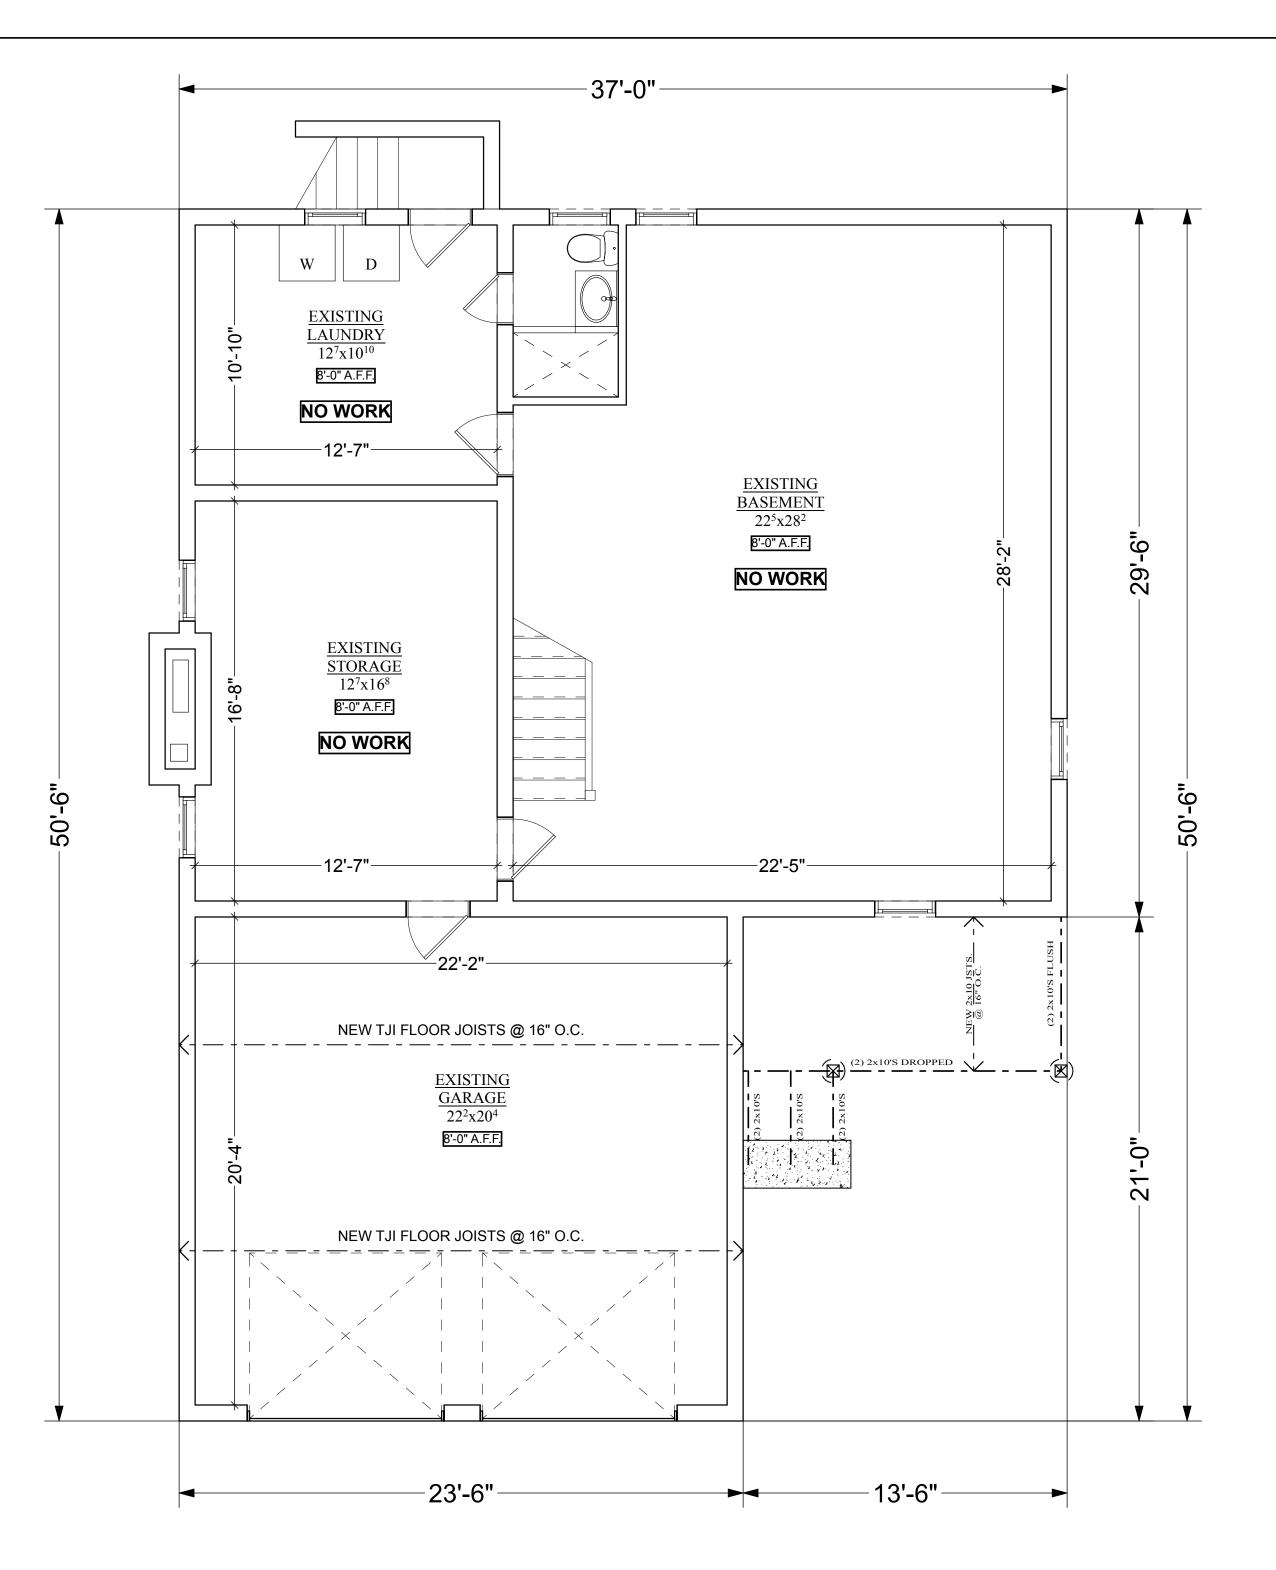

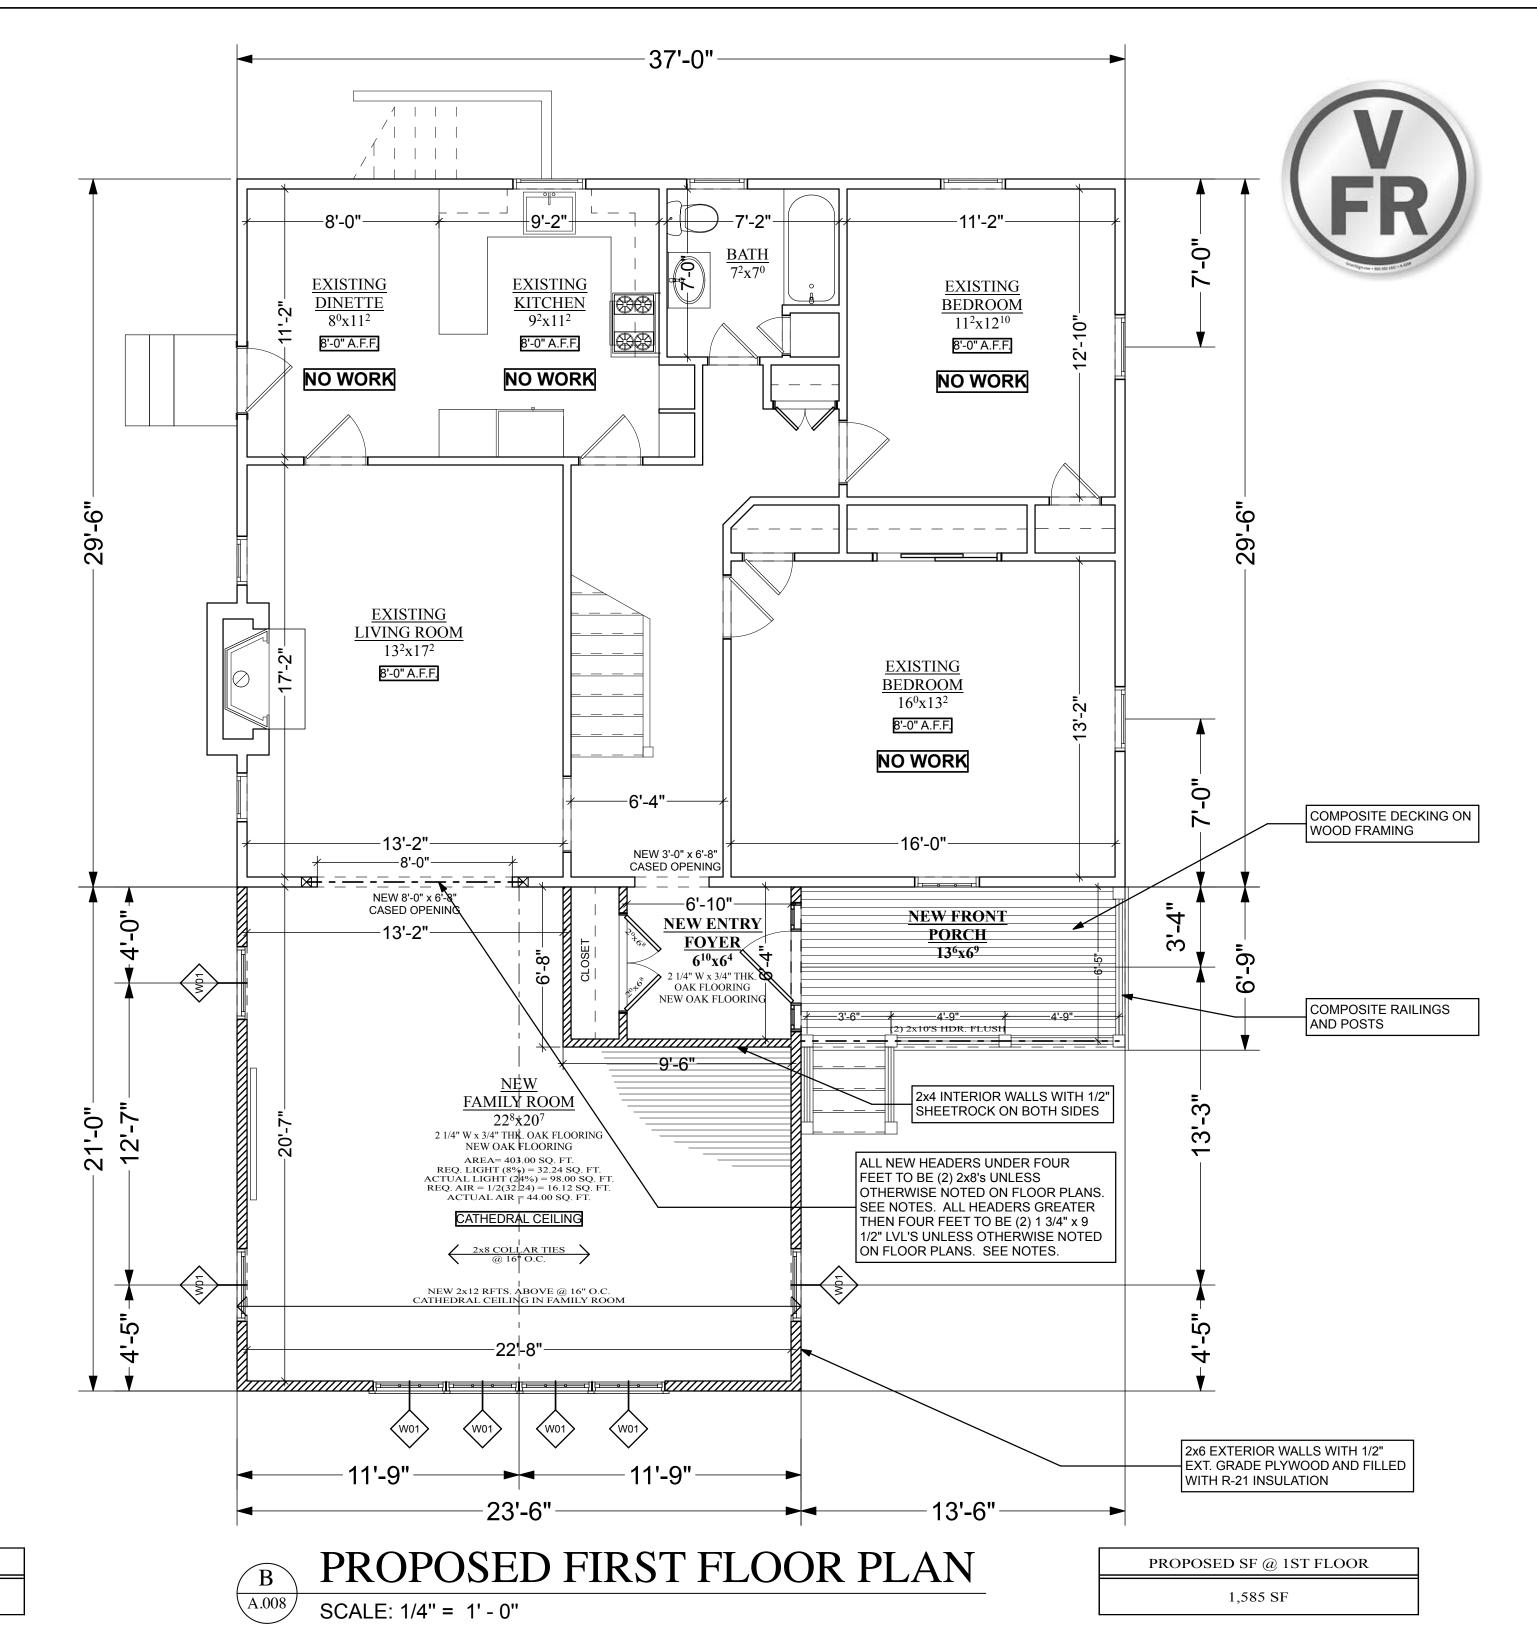

PROPOSED BASEMENT PLAN

SCALE: 1/4" = 1' - 0"

1,091 SF BELOW GRADE

PROPOSED SF @ BASEMENT

FIRST FLOOR NOTES:

1. ALL WINDOWS TO BE ANDERSON 100 SERIES OR APPROVED EQUAL. ROUGH OPENING DIMENSIONS TO BE DETERMINED. INSURE EGRESS AND TEMPERED UNITS WHERE REQUIRED. ANY SUBSTITUTIONS TO BE EQUAL TO, OR GREATER THAN, UNIT SHOWN ON PLAN.


2. PROVIDE SMOKE/HEAT DETECTORS (S.D.) AND CARBON MONOXIDE DETECTORS WHERE INDICATED. ALL SMOKE ALARMS TO BE HARD-WIRED, INTERCONNECTED, WITH BATTERY BACK-UP. LOCATE SMOKE/ HEAT DETECTORS AT THE TOP OF EACH STAIR THROUGHOUT THE HOUSE.

- 3. ALL HANDRAILS TO BE 3'-0" (MIN.) HIGH W/ 4" (MAX.) CLEARANCE BETWEEN VERTICAL OR HORIZONTAL MEMBERS (TYP.).
- 4. ALL NEW HEADERS UNDER FOUR FEET TO BE (2) 2x8's UNLESS OTHERWISE NOTED ON FLOOR PLANS.
- 5. ALL HEADERS GREATER THEN FOUR FEET TO BE (2) 1 3/4" x 9 1/2" LVL'S UNLESS OTHERWISE NOTED ON FLOOR PLANS.
- 6. ALL INTERIOR WALLS SHALL BE 2"x4" WOOD STUDS @ 16" O.C., UNLESS OTHERWISE INDICATED ON DRAWINGS.

- 7. PROVIDED MIN. 2" AIR SPACE BETWEEN MASONRY FIREPLACES AND COMBUSTABLE STUDS ON SIDES AND 4" IN REAR, ETC. OR USE METAL LOAD BEARING STUDS.
- 8. ALL INTERIOR WALLS TO BE INSULATED WITH R-13 INSULATION 9. NEW 1/2" SHEETROCK TO BE APPLIED TO ALL INTERIOR AND EXTERIOR WALLS.
- 10. ALL INTERIOR DOORS TO BE TRADITIONAL 6 PANEL SOLID MDF DOORS. FOR SIZES SEE PROPOSED FLOOR PAN.
- 11. ALL EXTERIOR WALLS TO BE 2x6 AND INSULATED WITH R-21 INSULATION.
- 13. PROVIDE DRAFT STOPPING WITHIN FLOOR SYSTEM EVERY 500 SQ. 14. PROVIDE 2 - 2"x6" WOOD POSTS DOWN DIRECTLY TO FOUNDATION
- WALL OR MAIN GIRDERS WHERE INDICATED. CONTRACTOR TO POST ALL CORNERS AND WALL INTERSECTIONS.
- 15. DOUBLE JOISTS UNDER ALL PARALLEL PARTITIONS. DOUBLE EVERY THIRD JOIST UNDER KITCHEN, BATHROOMS, FOYERS, AND ANY OTHER SPACES WITH A STONE OR TILED FLOOR FINISHES. 16. PROVIDE 3/4" T&G SUB-FLOORING GLUED & SCREWED.

WINDOW SCHEDULE (SECOND FLOOR)

TYPE	SPECIFICATION/	WINDOW FRAME (ACTUAL UNIT SIZE)	ROUGH OPNG. ROUGH OPNG. HEAD HEIGHT ABOVE FINISHED FLOOR	CHANT	
ITPE	MANUFACTURER	SIZE (WxH)	SIZE (WxH)		QUANT
W01)	ANDERSON 100 SERIES CASEMENT WINDOWS: 3046	2'-11 ^{1/2} " x 4'-5 ^{1/2} "	3'-0" x 4'-6"	6'-9"	7

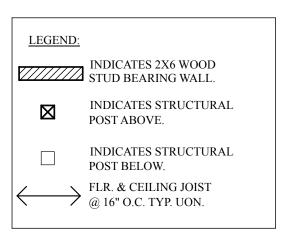




JONATHAN
VILLANI ASSOCIATES

Jonathan Villani & Assoc. Inc. 15 Independence Street White Plains, N.Y., 10606 P 914-575-1071 jmvarch@gmail.com

Annunziata & Villani Design Consultants. Inc. 15 Independence Street White Plains, N.Y., 10606 P 914-575-1071

jmvarch@gmail.com

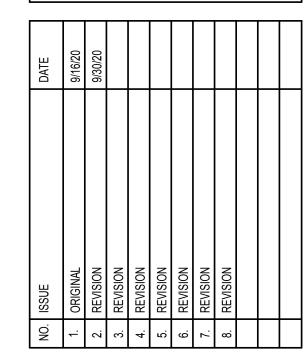

IN ASSOCIATION WITH: | John J. Annunziata, P.E. 24 Chesley Road White Plains, N.Y., 10605 P-914-949-0270 F-914-428-6235


AS NOTED 9/30/20 DRAWN BY: DRAWING TITLE:

> PROPOSED FLOOR **PLANS**

A.008

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SCALE: 1/4" = 1' - 0"

PROPOSED SF @ SECOND FLOOR 890 SF

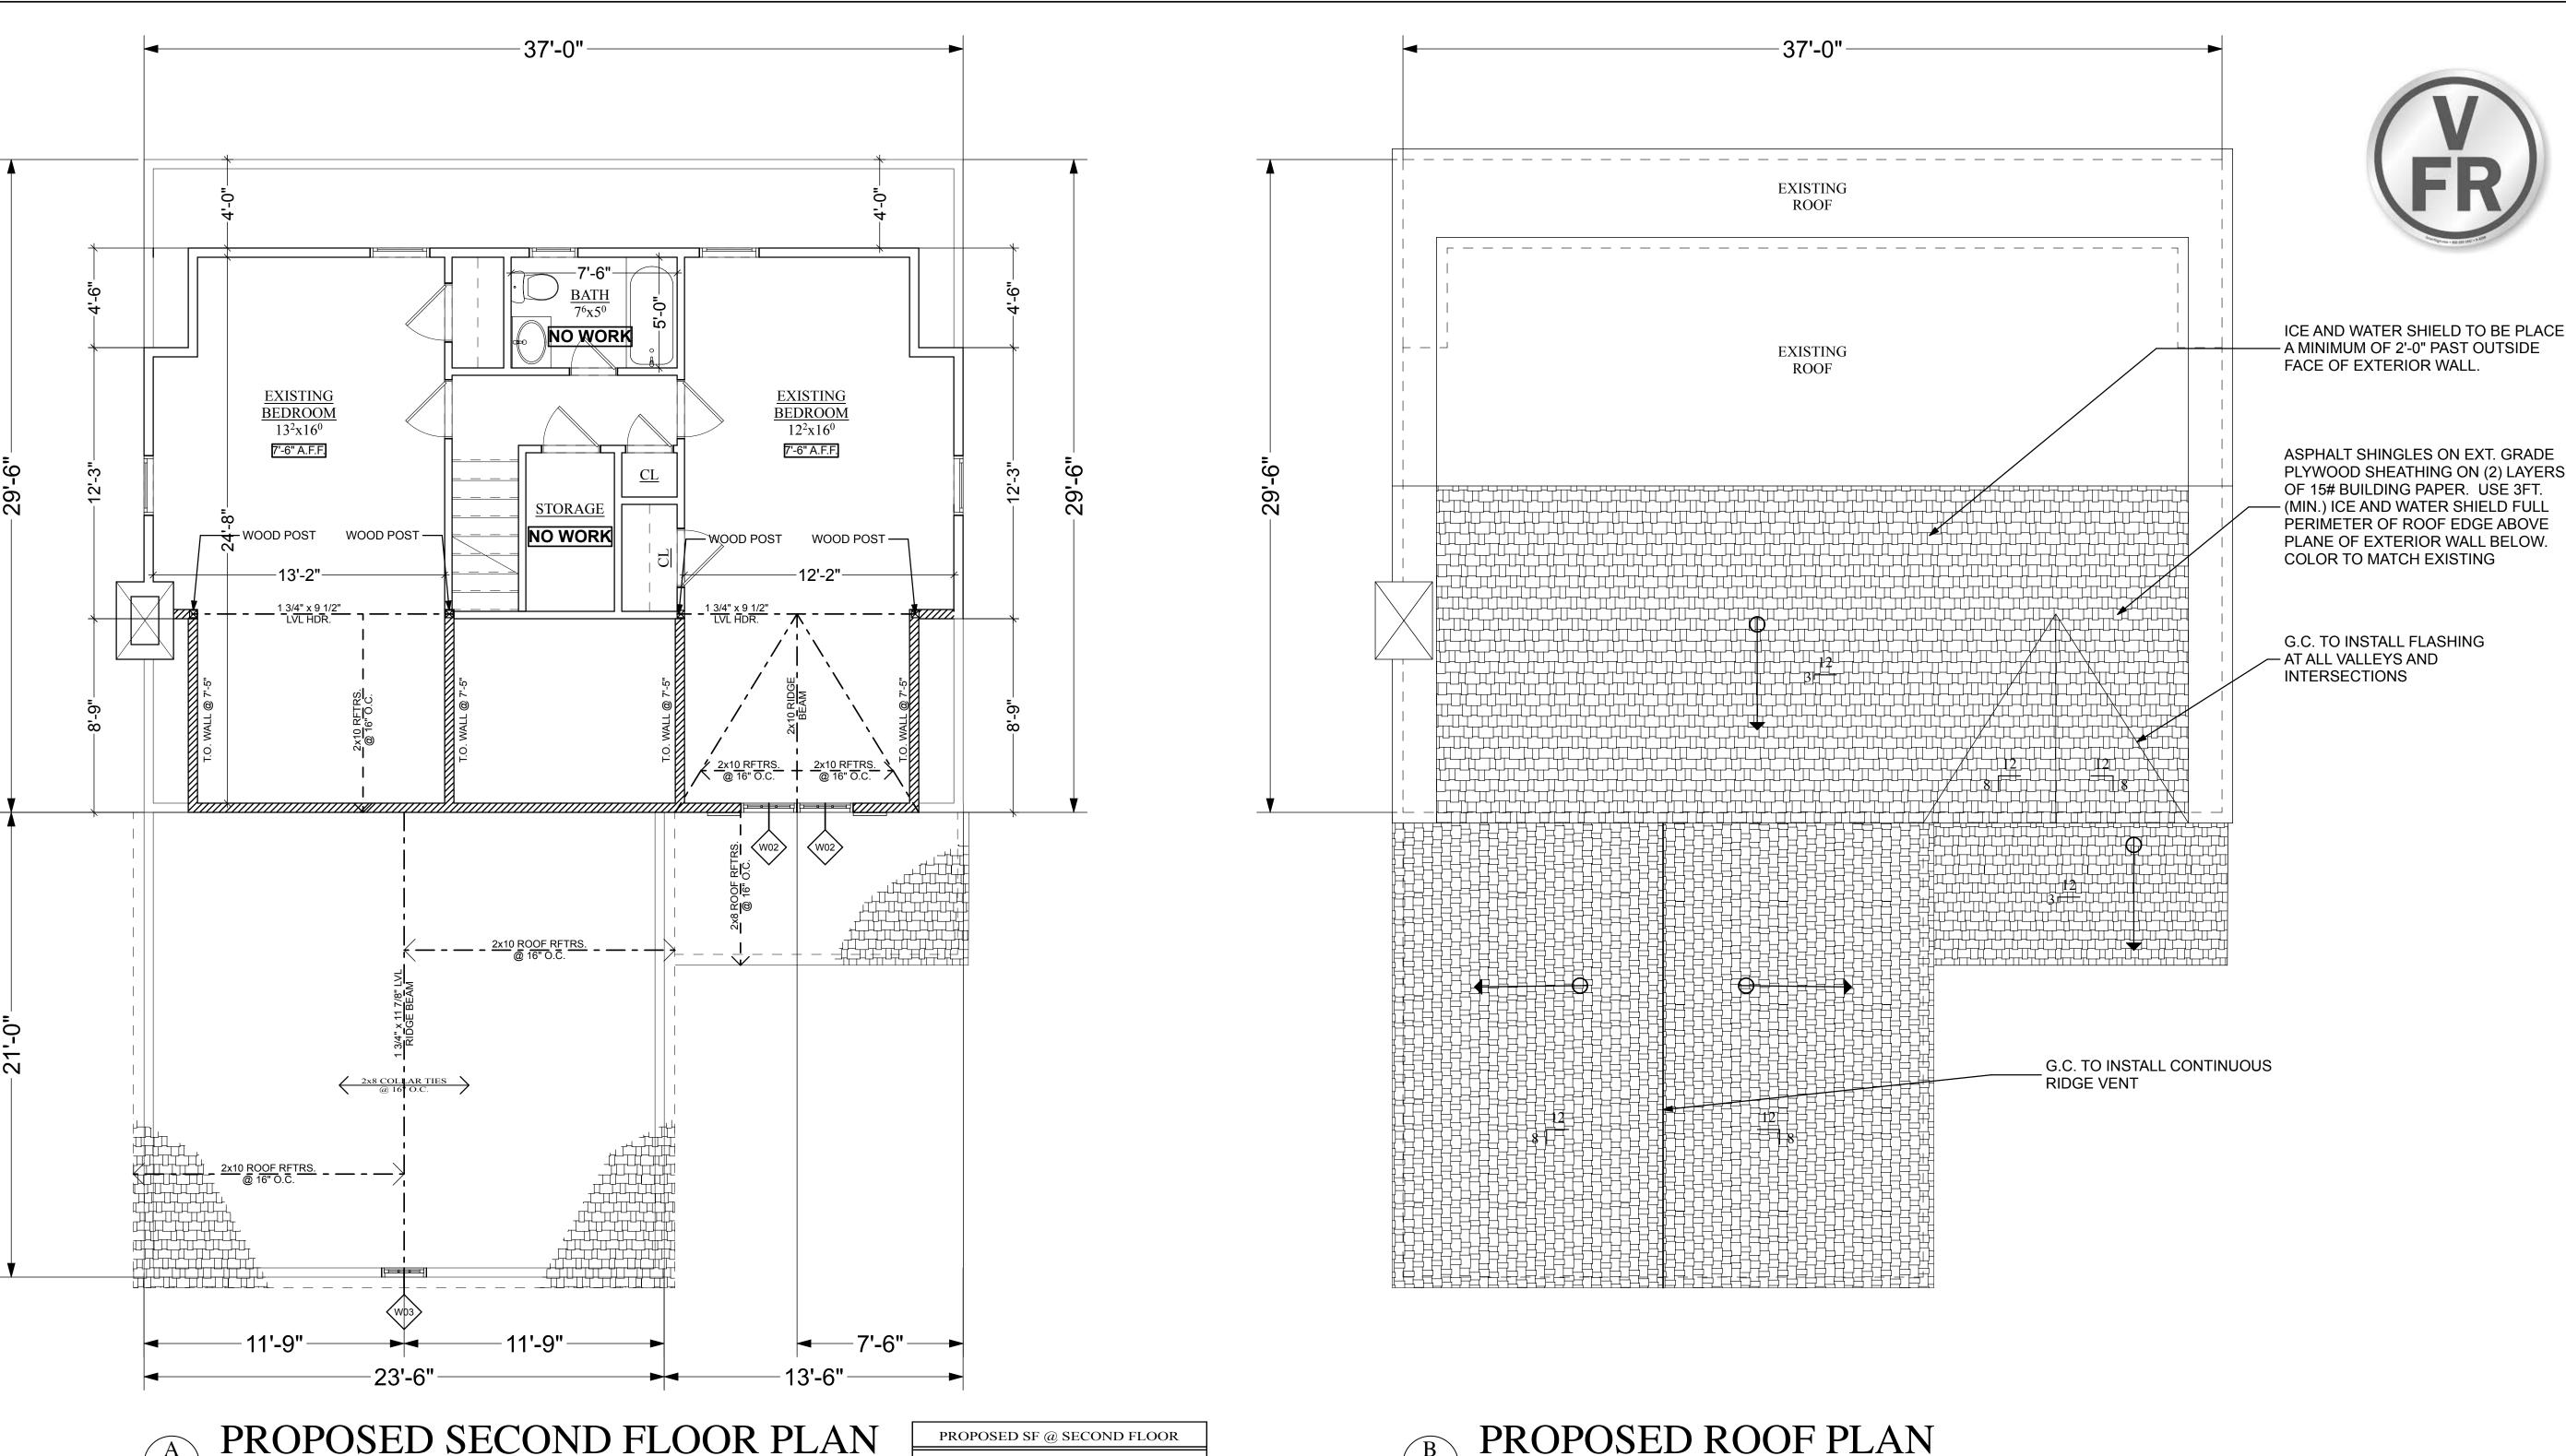SECOND FLOOR NOTES:

1. ALL WINDOWS TO BE ANDERSON 100 SERIES OR APPROVED EQUAL. ROUGH OPENING DIMENSIONS TO BE DETERMINED. INSURE EGRESS AND TEMPERED UNITS WHERE REQUIRED. ANY SUBSTITUTIONS TO BE EQUAL TO, OR GREATER THAN, UNIT SHOWN ON PLAN.

2. PROVIDE SMOKE/HEAT DETECTORS (S.D.) AND CARBON MONOXIDE DETECTORS WHERE INDICATED. ALL SMOKE ALARMS TO BE HARD-WIRED, INTERCONNECTED, WITH BATTERY BACK-UP. LOCATE SMOKE/ HEAT DETECTORS AT THE TOP OF EACH STAIR THROUGHOUT THE HOUSE.

- 3. ALL HANDRAILS TO BE 3'-0" (MIN.) HIGH W/ 4" (MAX.) CLEARANCE BETWEEN VERTICAL OR HORIZONTAL MEMBERS (TYP.).
- 4. ALL NEW HEADERS UNDER FOUR FEET TO BE (2) 2x8's UNLESS OTHERWISE NOTED ON FLOOR PLANS.
- 5. ALL HEADERS GREATER THEN FOUR FEET TO BE (2) 1 3/4" x 9 1/2" LVL'S UNLESS OTHERWISE NOTED ON FLOOR PLANS.
- 6. ALL INTERIOR WALLS SHALL BE 2"x4" WOOD STUDS @ 16" O.C., UNLESS OTHERWISE INDICATED ON DRAWINGS.

- 7. PROVIDED MIN. 2" AIR SPACE BETWEEN MASONRY FIREPLACES AND COMBUSTABLE STUDS ON SIDES AND 4" IN REAR, ETC. OR USE METAL LOAD BEARING STUDS.
- 8. ALL INTERIOR WALLS TO BE INSULATED WITH R-13 INSULATION 9. NEW 1/2" SHEETROCK TO BE APPLIED TO ALL INTERIOR AND EXTERIOR WALLS.
- 10. ALL INTERIOR DOORS TO BE TRADITIONAL 6 PANEL SOLID MDF DOORS. FOR SIZES SEE PROPOSED FLOOR PAN.
- 11. ALL EXTERIOR WALLS TO BE 2x6 AND INSULATED WITH R-21 INSULATION.
- 13. PROVIDE DRAFT STOPPING WITHIN FLOOR SYSTEM EVERY 500 SQ. 14. PROVIDE 2 - 2"x6" WOOD POSTS DOWN DIRECTLY TO FOUNDATION
- WALL OR MAIN GIRDERS WHERE INDICATED. CONTRACTOR TO POST ALL CORNERS AND WALL INTERSECTIONS. 15. DOUBLE JOISTS UNDER ALL PARALLEL PARTITIONS. DOUBLE
- EVERY THIRD JOIST UNDER KITCHEN, BATHROOMS, FOYERS, AND ANY OTHER SPACES WITH A STONE OR TILED FLOOR FINISHES.
- 16. PROVIDE 3/4" T&G SUB-FLOORING GLUED & SCREWED.

PROPOSED ROOF PLAN SCALE: 1/4" = 1' - 0"

ROOF NOTES


9. ALL KNEEWALLS TO BE 2x6.

1. PROVIDE RIDGE VENTS AND CONTINUOUS SOFFIT VENTS. IF SPRAY INSULATION IS USED G.C. TO PLACE VENTED BARRIER BETWEEN INSULATION AND SHEATHING TO ALLOW FOR CIRCULATION OF AIR THROUGH ROOF RAFTERS.

- 2. ROOF TO BE ASPHALT SHINGLES ON 15# BUILDING PAPER OVER 5/8" PLYWOOD SHEATHING GLUED AND NAILED TO RAFTERS. UNLESS OTHERWISE SPECIFIED BY OWNER.
- 3. USE "ICE AND WATER" SHIELD. FULL COVERAGE OVER CATHEDRAL SPACES ON 1/2" PLYWOOD SHEATHING ON RAFTERS 4. SEE PLANS FOR RIDGE SIZES.
- 5. PROVIDE COPPER FLASHING AND COUNTER FLASHING AT ALL VALLEYS/ CHIMNEYS/ DORMERS AND ALL ROOF-WALL INTERSECTIONS UNLESS OTHERWISE NOTED.
- 6. EXTERIOR SILL PLATE TO BE (2) 2x6 DOUG FIR
- 7. ALL REQUIRED HURRICANE STRAPS AND/OR TIE-DOWNS WILL BE PLACED AT EVERY RAFTER AS WELL AS ALL ROOF AND WALL INTERSECTIONS.
- 8. PROVIDED MIN. 2" AIR SPACE BETWEEN MASONRY FIREPLACES AND COMBUSTABLE STUDS ON SIDES AND 4" IN REAR, ETC. OR USE METAL LOAD BEARING STUDS

WINDOW SCHEDULE (SECOND FLOOR)

TYPE	SPECIFICATION/	WINDOW FRAME (ACTUAL UNIT SIZE)	ROUGH OPNG.	ROUGH OPNG. HEAD HEIGHT ABOVE	OLIANIT.
	MANUFACTURER	SIZE (WxH)	SIZE (WxH)	FINISHED FLOOR.	QUANT
(W02)	ANDERSON 100 SERIES CASEMENT WINDOWS: 2640	2'-5 ^{1/2} " x 3'-11 ^{1/2} "	2'-6" x 4'-0"	6'-9"	2
(W03)	ANDERSON 100 SERIES CASEMENT WINDOWS: 2030	1'-11 ^{1/2} " x 2'-11 ^{1/2} "	2'-0" x 3'-0"	13'-0"	1

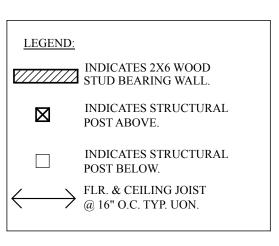



A.009

IN ASSOCIATION WITH:

AS NOTED

DRAWN BY:

DRAWING TITLE:

| John J. Annunziata, P.E.

24 Chesley Road

White Plains, N.Y., 10605

P-914-949-0270

F-914-428-6235

PROPOSED FLOOR

PLANS

9/30/20

JONATHAN
VILLANI

ASSOCIATES

Jonathan Villani & Assoc. Inc.

15 Independence Street White Plains, N.Y., 10606

P 914-575-1071

jmvarch@gmail.com

Annunziata & Villani

Design Consultants. Inc.


15 Independence Street

White Plains, N.Y., 10606

P 914-575-1071


jmvarch@gmail.com

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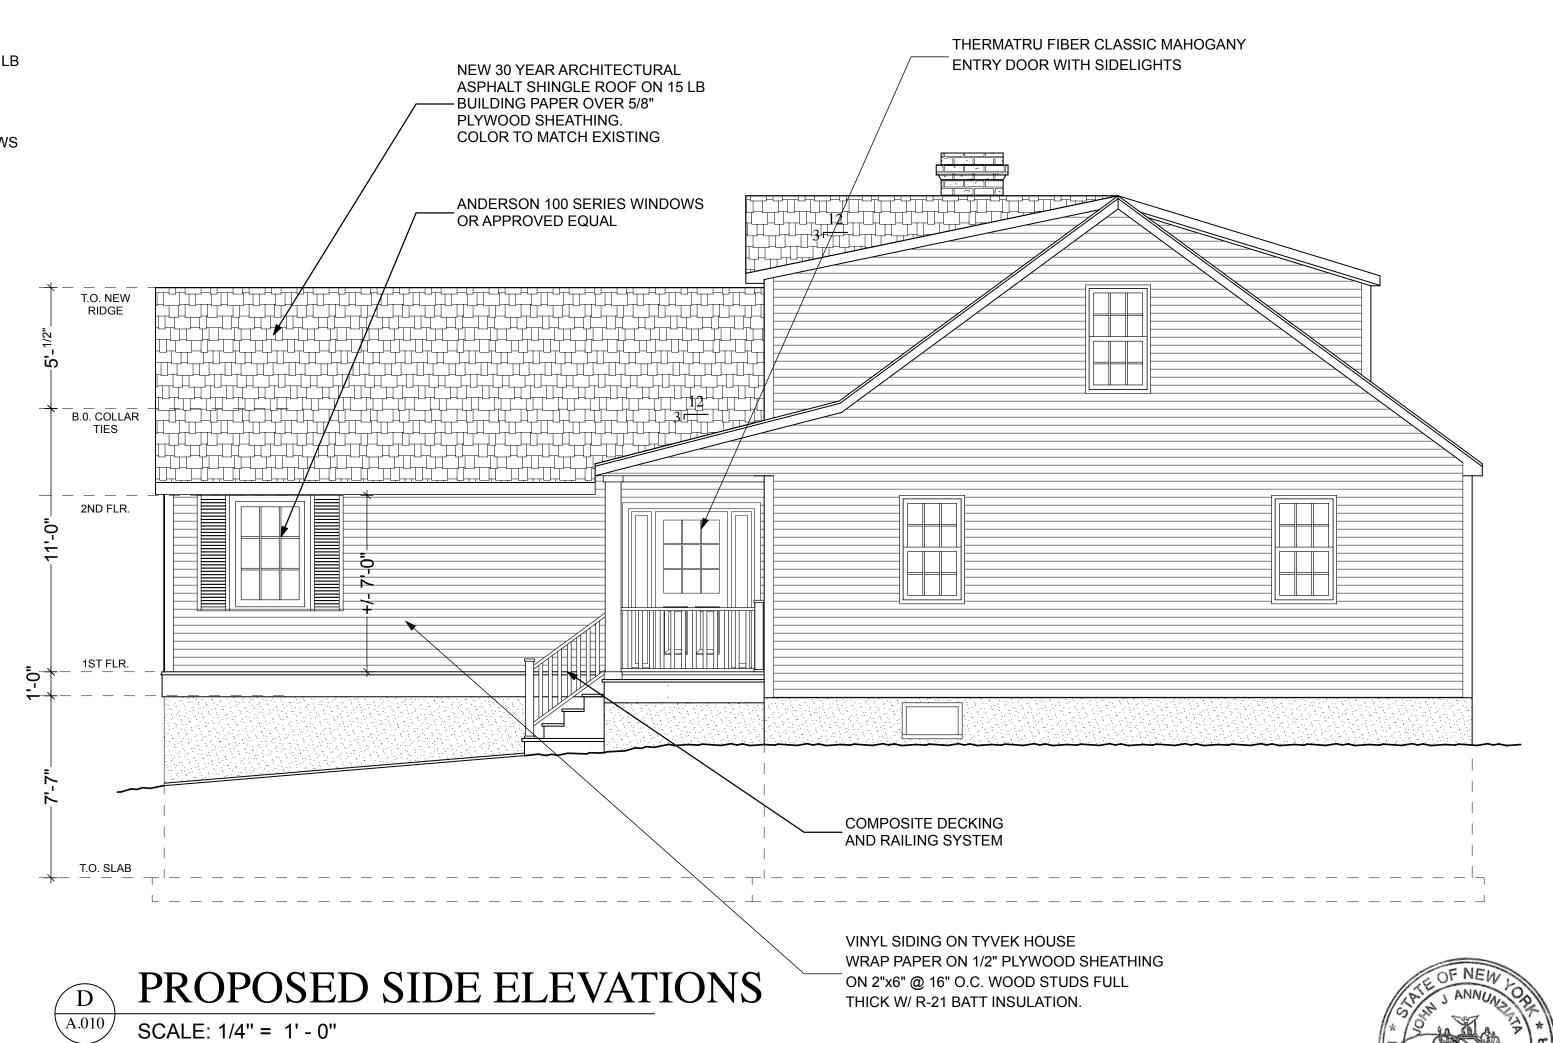


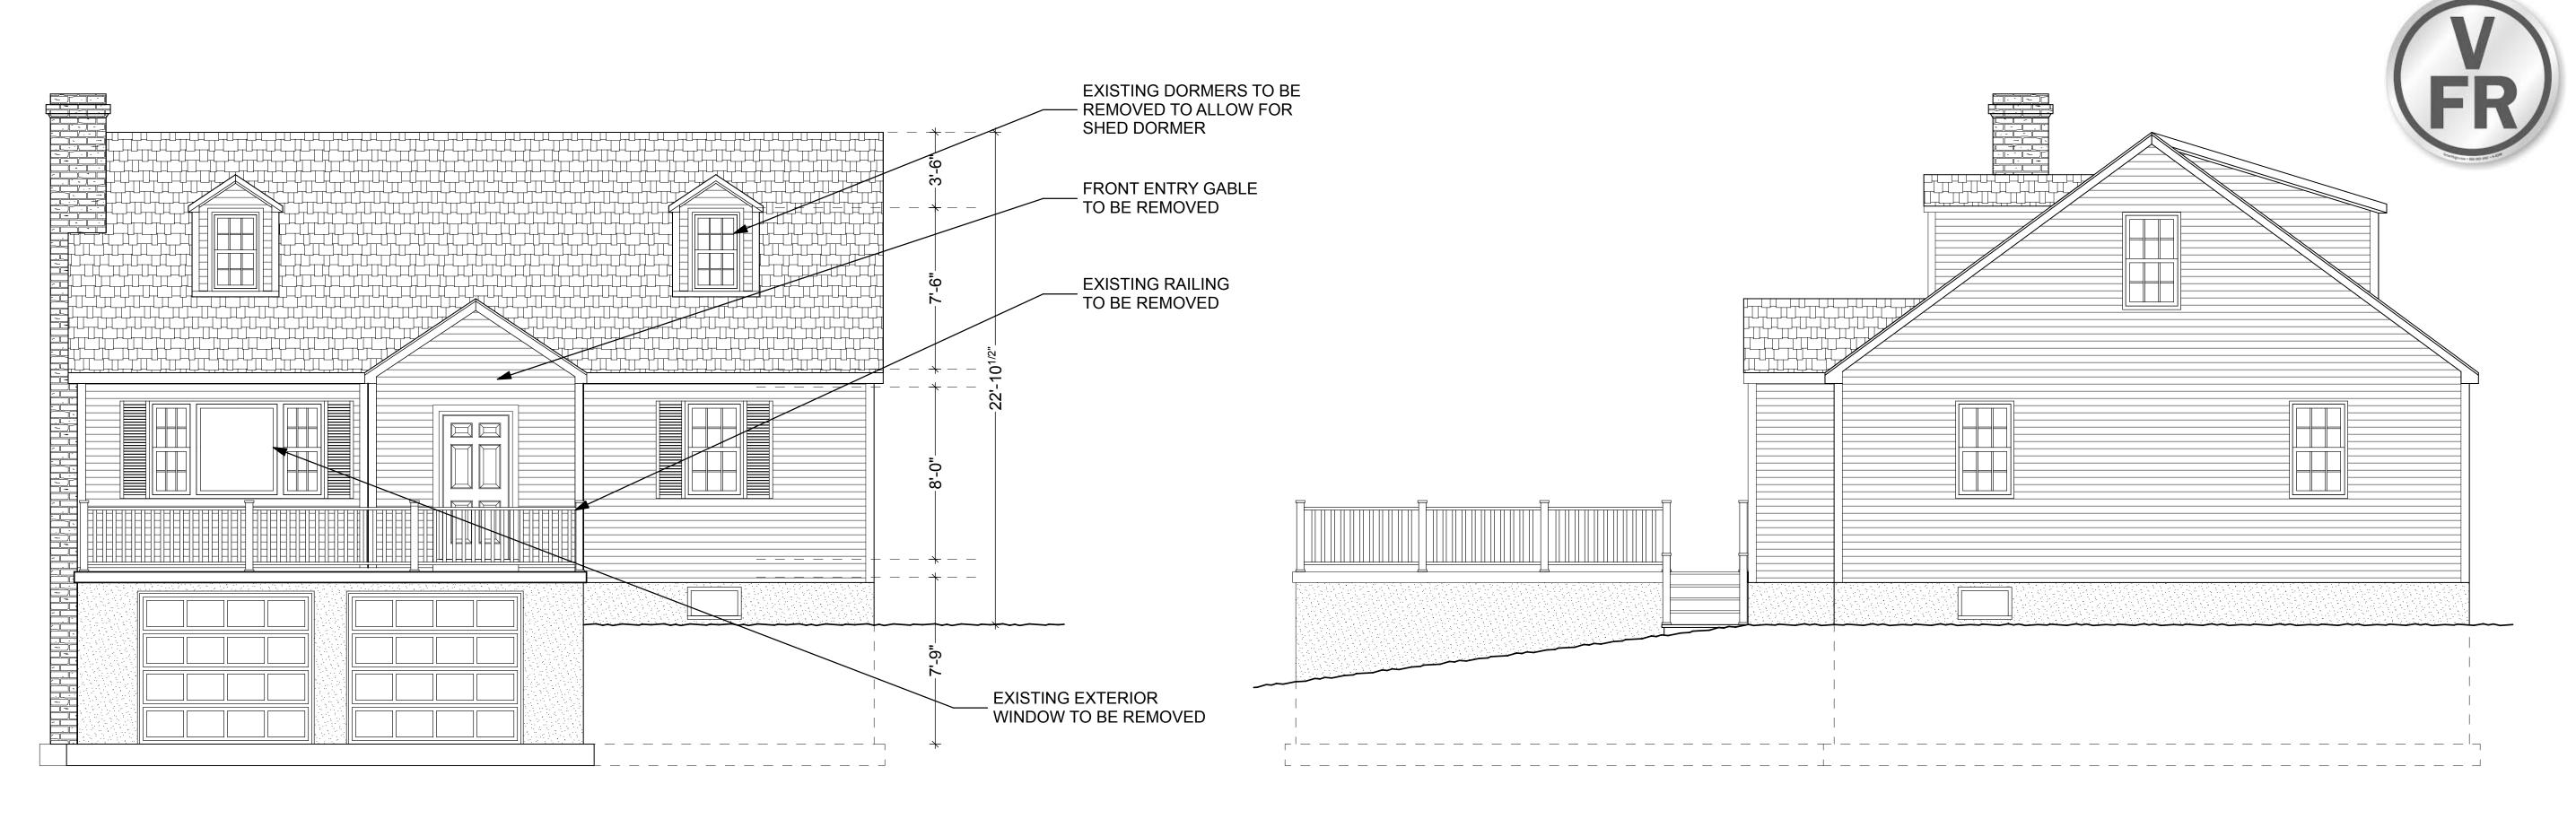A EXISTING FRONT ELEVATION

SCALE: 1/4" = 1' - 0"

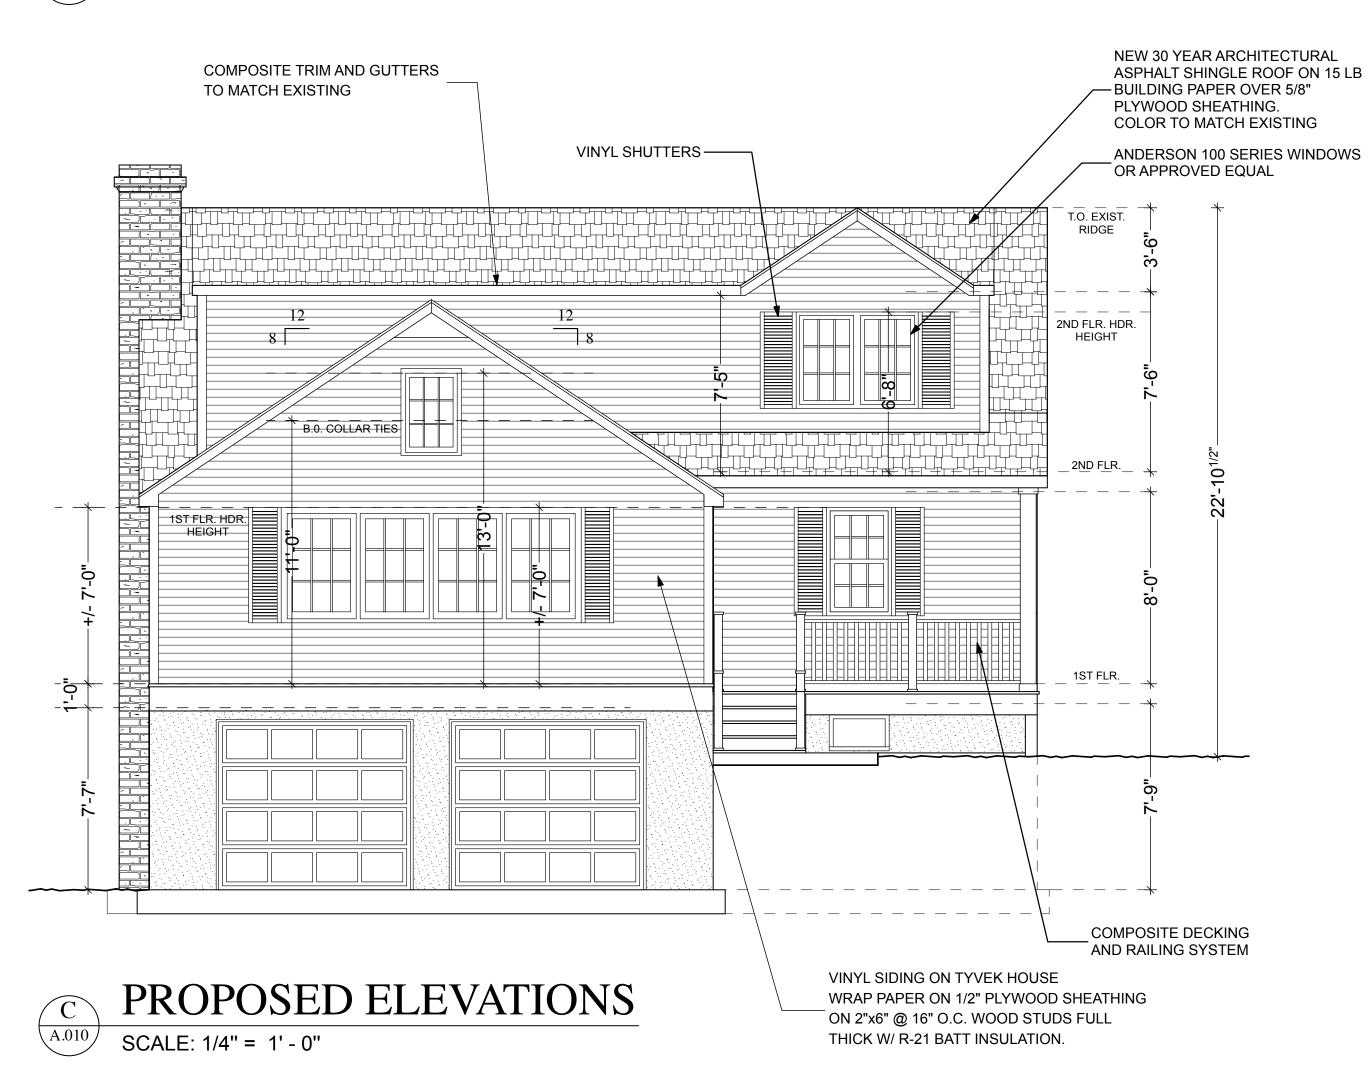

EXISTING SIDE ELEVATION SCALE: 1/4" = 1' - 0"




Jonathan Villani & Assoc. Inc. 15 Independence Street White Plains, N.Y., 10606 P 914-575-1071 jmvarch@gmail.com

Annunziata & Villani Design Consultants. Inc. 15 Independence Street White Plains, N.Y., 10606 P 914-575-1071 jmvarch@gmail.com

AND ALTERATIONS TO EXISTING

RE
IEW DRIVE N

AINS NEW YORK 10603

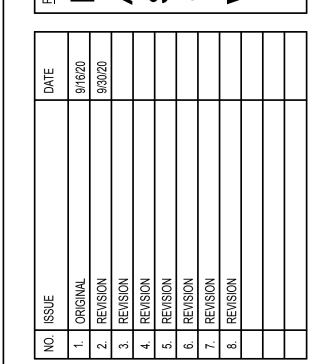

IN ASSOCIATION WITH:

John J. Annunziata, P.E. 24 Chesley Road White Plains, N.Y., 10605 P-914-949-0270 F-914-428-6235

SCALE: DATE: PROJECT NO.
AS NOTED 9/30/20

DRAWN BY: CHECKED BY: APPROVED B'

JV

DRAWING TITLE:

ELEVATIONS


A.010

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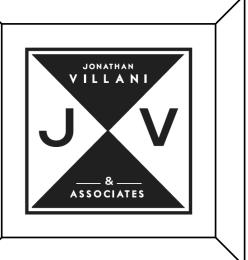
VINYL SIDING ON TYVEK HOUSE WRAP PAPER ON 1/2" PLYWOOD SHEATHING ON 2"x6" @ 16" O.C. WOOD STUDS FULL THICK W/ R-21 BATT INSULATION. ANDERSON 100 SERIES WINDOWS OR APPROVED EQUAL T.O. NEW RIDGE B.0. COLLAR TIES 2ND FLR. 1ST FLR.



PROPOSED WALL SECTION SCALE: 1" = 1' - 0"


EXISTING FOUNDATION

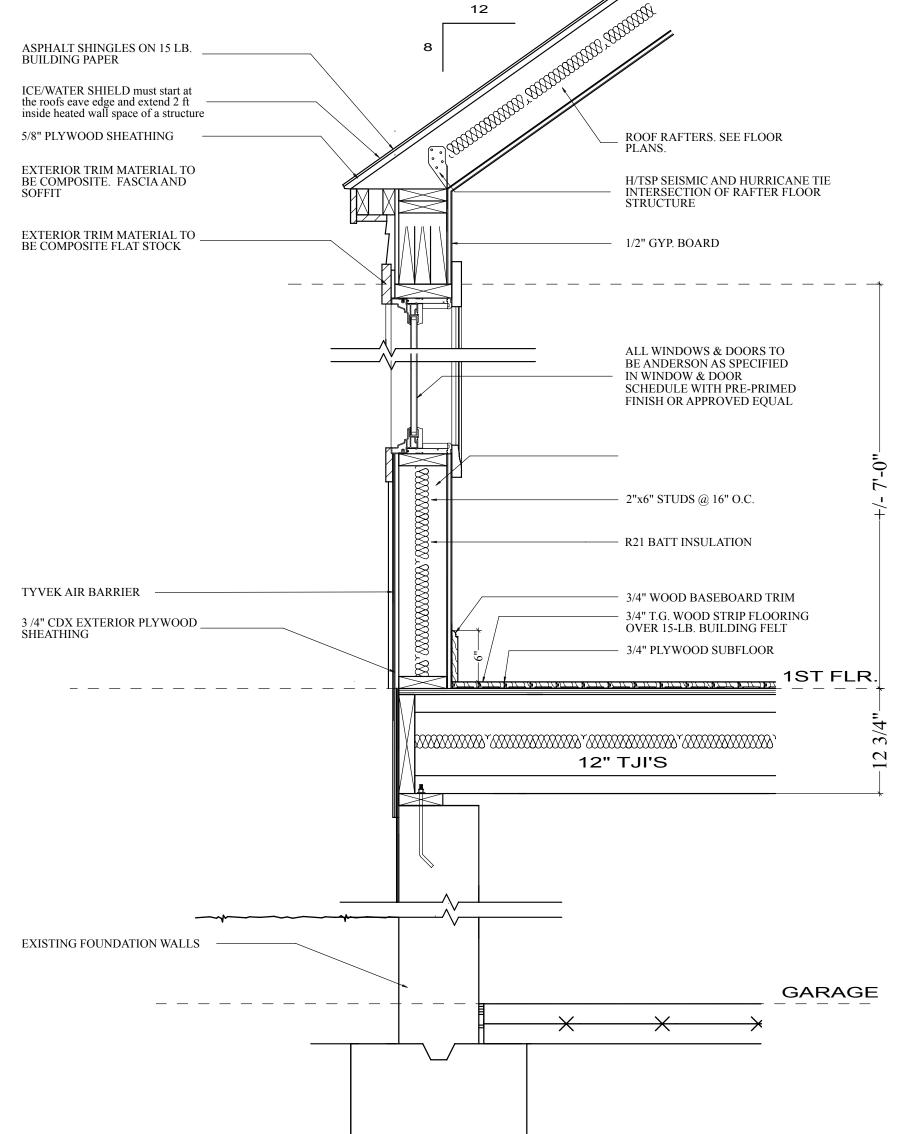



Jonathan Villani & Assoc. Inc. 15 Independence Street White Plains, N.Y., 10606 P 914-575-1071 jmvarch@gmail.com

Annunziata & Villani Design Consultants. Inc. 15 Independence Street White Plains, N.Y., 10606 P 914-575-1071 jmvarch@gmail.com

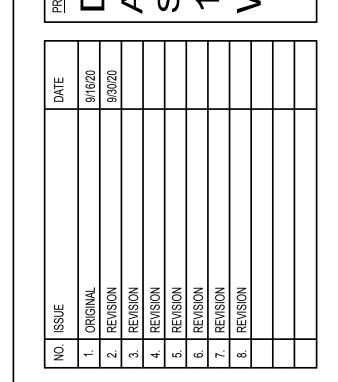

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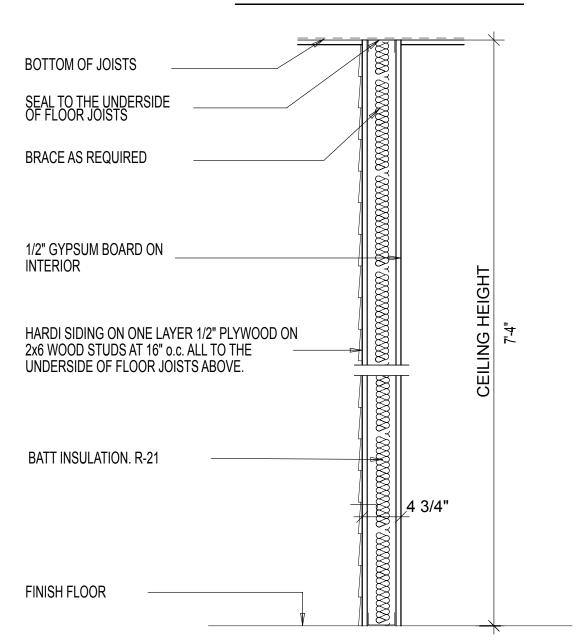
AS NOTED

ELEVATIONS


A.011

BOTTOM OF JOISTS SEAL TO THE UNDERSIDE OF FLOOR JOISTS BRACE AS REQUIRED ONE LAYER 1/2" GYPSUM WALLBOARD ON EACH SIDE OF 2x4 WOOD STUDS AT 16" o.c. ALL TO THE UNDERSIDE OF FLOOR JOISTS ABOVE. BATT INSULATION UPON OWNER'S REQUEST 4 3/4" FINISH FLOOR

EXTERIOR PARTITION





ROOF SHEATHING INSTALLATION

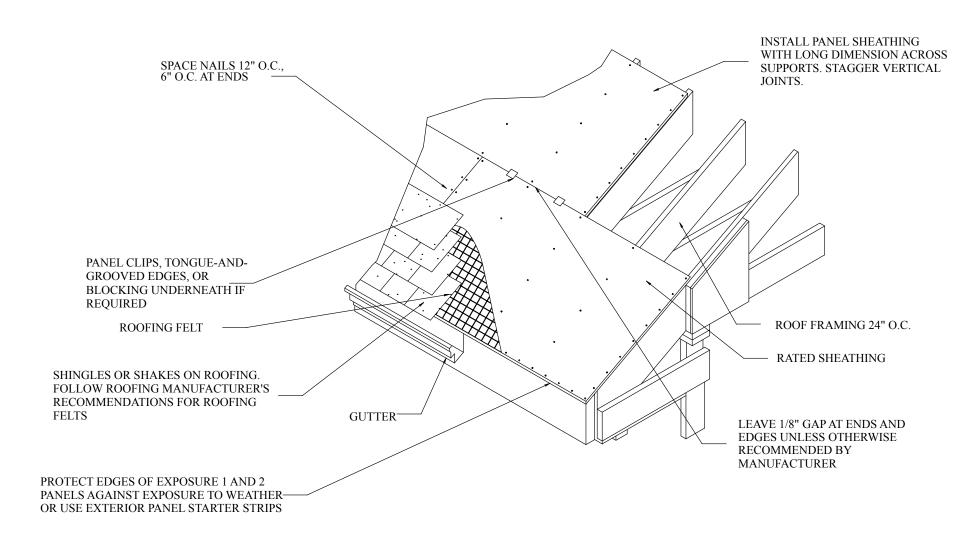




A TYPICAL WALL PARTITIONS SCALE: 1" = 1' - 0"

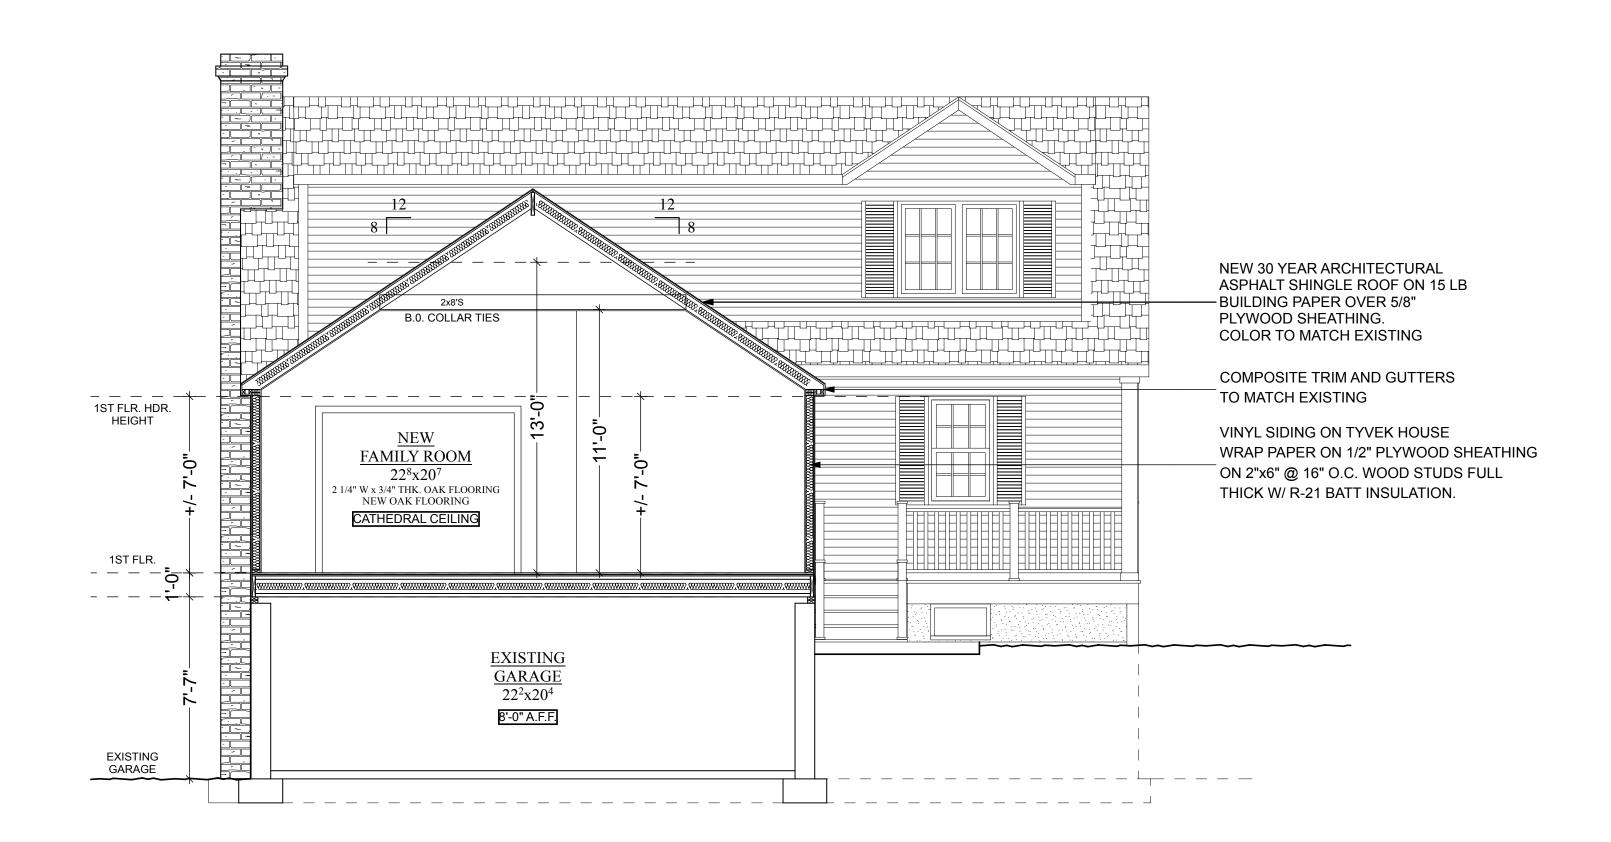

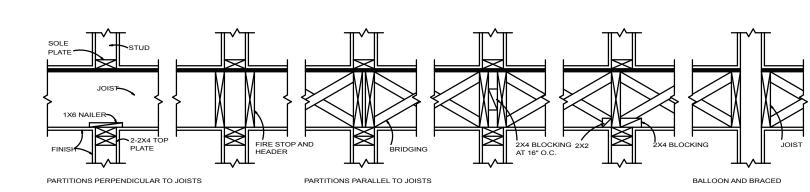

BEARING PARTITIONS
SCALE: N.T.S.

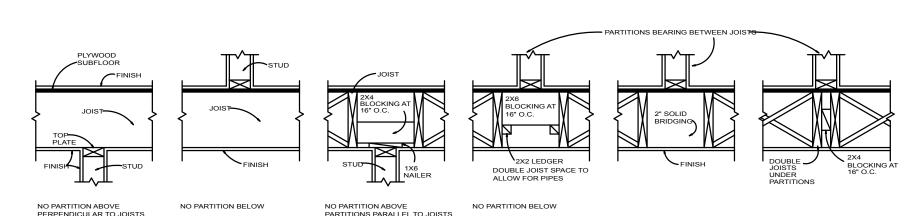

NON-BEARING PARTITIONS
SCALE: N.T.S.










Jonathan Villani & Assoc. Inc. 15 Independence Street White Plains, N.Y., 10606 P 914-575-1071 jmvarch@gmail.com

Annunziata & Villani Design Consultants. Inc. 15 Independence Street White Plains, N.Y., 10606 P 914-575-1071 jmvarch@gmail.com

DOUGLAS RESIDENCE
ADDITION AND ALTERATIONS TO EXISTINA
STRUCTURE
15 LAKEVIEW DRIVE N
WHITE PLAINS, NEW YORK, 10603

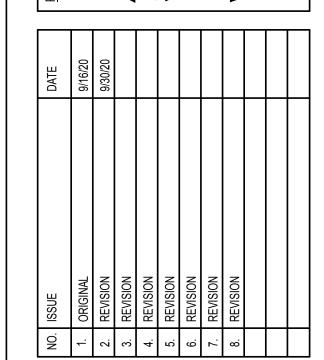

IN ASSOCIATION WITH:

John J. Annunziata, P.E.

24 Chesley Road

White Plains, N.Y., 10605

P-914-949-0270


SCALE: DATE: PROJECT N
AS NOTED 9/30/20


DRAWN BY: CHECKED BY: APPROVED
JV

F-914-428-6235

SECTIONS AND DETAILS

A.012

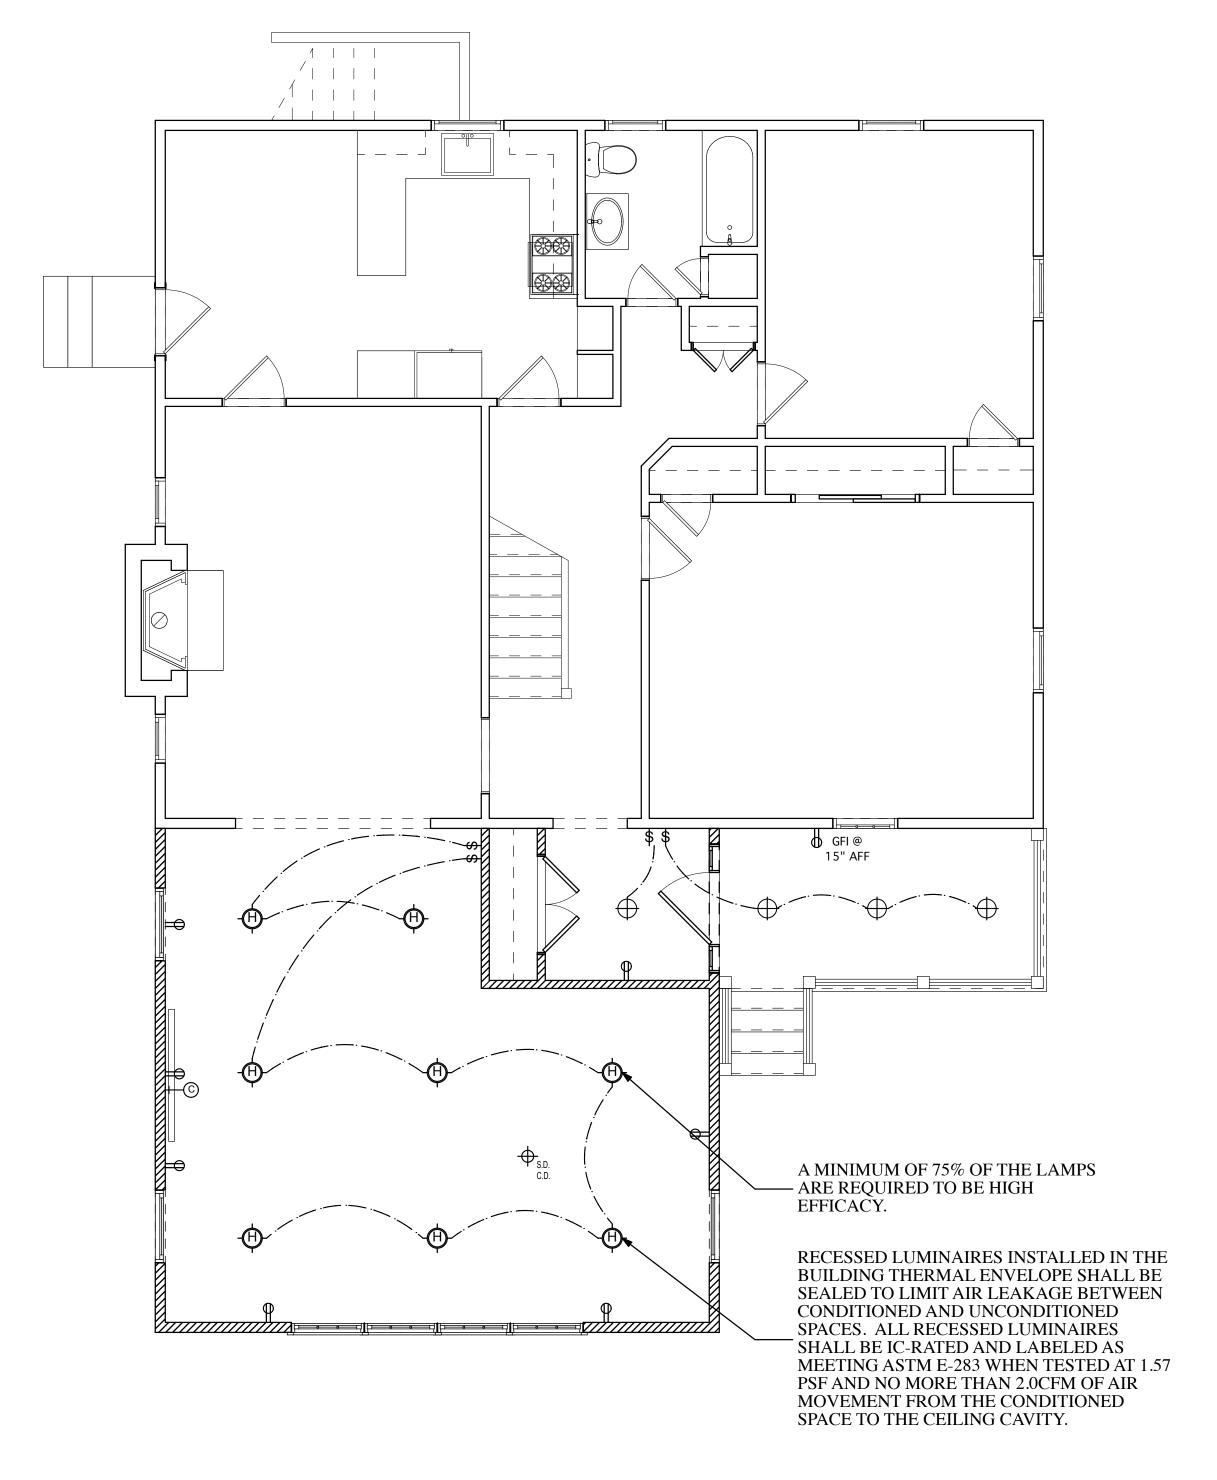

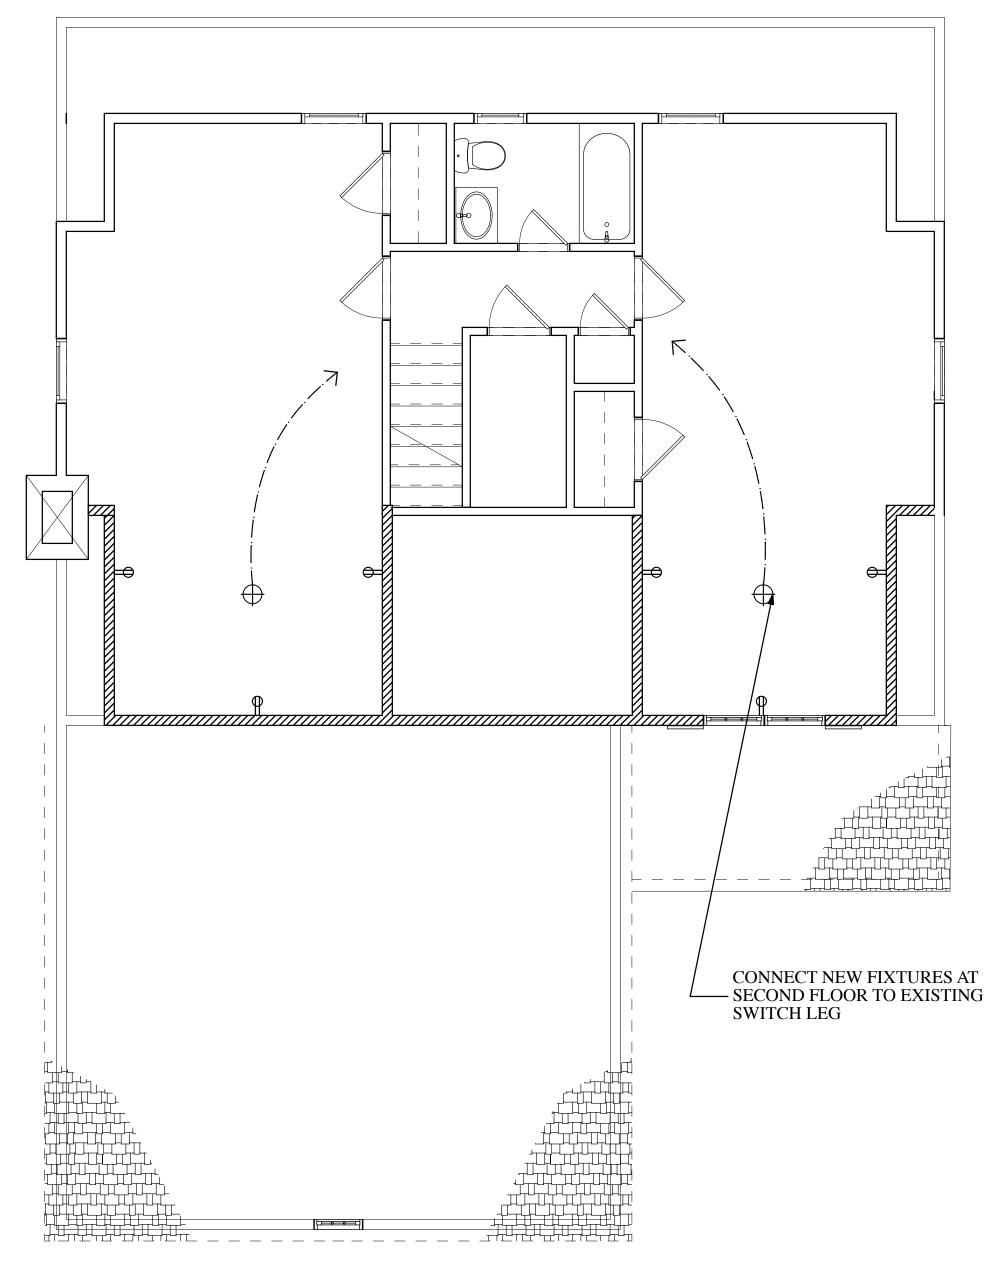

FIRST FLOOR ELECTRICAL PLAN

SCALE: 1/4" = 1' - 0"

SECOND FLOOR ELECTRICAL PLAN

SCALE: 1/4" = 1' - 0"

ELECTRICAL NOTES:

1. ALL ELECTRICAL WORK TO BE PERFORMED BY A LICENSED ELECTRICIAN.

2. ELECTRICAL CONTRACTOR TO FINALIZE LAYOUT WITH ARCHITECT/ENGINEER PRIOR TO INSTALLATION.

3. ELECTRICAL CONTRACTOR LAYOUT FIXTURES WITH STRINGLINES AND NOTIFY ARCHITECT/ENGINEER OF ANY OBSTRUCTIONS PRIOR TO INSTALLATION TO MINIMIZE DAMAGE TO FRAMING AND/OR BLOCKING.

4. ALL ELECTRICAL OUTLETS, SWITCHES AND COVER PLATES TO BE COLOR WHITE. UNLESS OTHERWISE NOTED.

5. ALL LIGHT SWITCHES TO BE MOUNTED AT 44" ABOVE FINISHED FLOOR TO CENTERLINE OF THE ELECTRICAL BOX.

6. ALL ELECTRICAL OUTLETS TO BE MOUNTED AT 15" ABOVE FINISHED FLOOR TO THE CENTERLINE OF THE ELECTRICAL BOX. UNLESS OTHERWISE NOTED ON ELECTRICAL PLAN.

7. ALL ELECTRICAL WIRING AND ASSOCIATED ACCESSORIES TO BE INSTALLED AS PER LOCAL AND STATE CODES.

8. ELECTRICAL CONTRACTOR SHALL PROVIDE WIRING FOR

MECHANICAL SYSTEMS CONDENSER UNITS. G.C. & ELECTRICIAN SHALL COORDINATE WITH MECHANICAL CONTRACTOR.


9. ELECTRICAL CONTRACTOR SHALL PROVIDE POWER AND FIXTURES

TO BASEMENT AREA AS PER CODE.

10. ELECTRICAL CONTRACTOR SHALL INSTALL REQUIRED WIRING AND SMOKE DETECTORS AND CARBON MONOXIDE DEVICES THROUGH OUT

HOUSE AS REQUIRED PER CODE.

11. ELECTRICAL CONTRACTOR TO DETERMINE AND VERIFY ANY LOCATIONS FOR COMMUNICATIONS AND/OR INTERNET ACCESS.

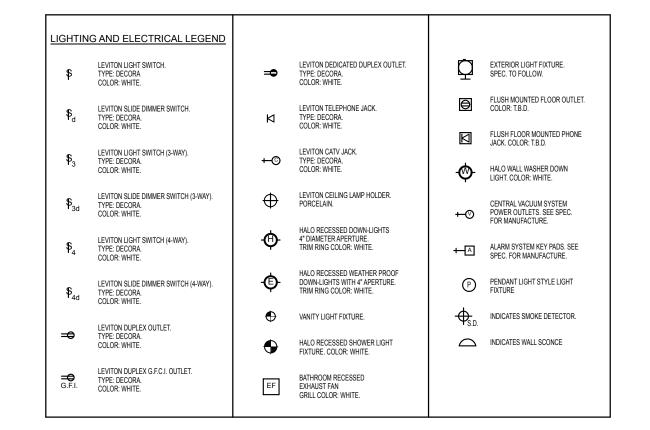




Jonathan Villani & Assoc. Inc. 15 Independence Street White Plains, N.Y., 10606 P 914-575-1071 jmvarch@gmail.com

Annunziata & Villani
Design Consultants. Inc.
15 Independence Street
White Plains, N.Y., 10606
P 914-575-1071
jmvarch@gmail.com

DOUGLAS RESIDENCE ADDITION AND ALTERATIONS TO EXISTING STRUCTURE 15 LAKEVIEW DRIVE N WHITE PLAINS, NEW YORK, 10603

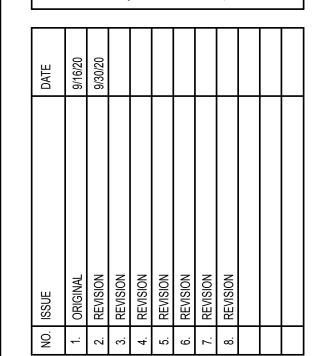

IN ASSOCIATION WITH:

John J. Annunziata, P.E. 24 Chesley Road White Plains, N.Y., 10605 P-914-949-0270 F-914-428-6235

SCALE: DATE:
AS NOTED 9/30/2

DRAWN BY: CHECKED

ELECTRICAL PLANS

A.013

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Section I- PROJECT

TOWN OF NORTH CASTLE

WESTCHESTER COUNTY 17 Bedford Road Armonk, New York 10504-1898

RESIDENTIAL PROJECT REVIEW COMMITTEE Adam R. Kaufman AICP, Chair

Section III- DESCRIPTION OF WORK:

charge in use on occupancy

Telephone: (914) 273-3000 x 43 Fax: (914) 273-3554 www.nortcastleny.com

RESIDENTIAL PROJECT REVIEW COMMITTEE (RPRC) APPLICATION

15 LAKEVIEW DR. W, white Plains NY 10603

One Story addition to existing one-family swelling. No

Section III- CONTACT INFORMATION:
APPLICANT: JOAHTHAN V. UAM
ADDRESS: 15 Independence Str., White Plans Ny 10606
PHONE: 914-875-1071 MOBILE: 914-437-8729 EMAIL: jmvarch@gmaid.com
PROPERTY OWNER: De borgh Borglass
ADDRESS: 15 CAMERIEW DR. N, White Plans, 14 10603
PHONE: 914-473-0545 MOBILE: W/r EMAIL: jnvarch@gmail.com
PROFESSIONAL: John J. Annonziara P.E.
ADDRESS: 24 Chestey Rd, while Plains NY 10605
PHONE: 914-949-0270 MOBILE: 918-575-1071
EMAIL: jmvarch@gmail: com
Section IV- PROPERTY INFORMATION:
Zone: $R-5$ Tax ID (lot designation) $122/16-4-16$



Town of North Castle Residential Project Review Committee

17 Bedford Road Armonk, New York 10504 (914) 273-3542 (914) 273-3554 (fax)

RPRC COMPLETENESS REVIEW FORM

This form represents the standard requirements for a completeness review for all Residential Project Review Committee submissions. Failure to provide all of the information requested will result in a determination that the application is incomplete.

Project Name on Plan:					
Douglass Residence ☐Initial Submittal ☐Revised Preliminary					
Street Location: 15 LAKENIEW Dr. W, White Plains RY 10603					
Zoning District: <u>R-S</u> Property Acreage: <u>8,7/2 SF</u> Tax Map Parcel ID: <u>/22,16 - 4 - 16</u>					
Date: 1/23/20					
DEPARTMENTAL USE ONLY					
Date Filed: Staff Name:					
Preliminary Plan Completeness Review Checklist Items marked with a are complete, items left blank are incomplete and must be completed, "NA" means not applicable.					
1. Plan prepared by a registered architect or professional engineer					
2. Aerial photo (Google Earth) showing the applicant's entire property and adjacent properties and streets					
3. Map showing the applicant's entire property and adjacent properties and streets					
A locator map at a convenient scale					
5. The proposed location, use and design of all buildings and structures					
3. Existing topography and proposed grade elevations					
7. Location of drives					
Location of all existing and proposed site improvements, including drains, culverts, retaining walls and fences					

RPRC COMPLETENESS REVIEW FORM

Page 2

Description of method of water supply and sewage disposal and location of such facilities				
10. The name and address of the applicant, property owner(s) if other than the applicant and of the planner, engineer, architect, surveyor and/or other professionals engaged to work				
Submission of a Zoning Conformance Table depicting the plan's compliance with the minimum requirements of the Zoning District				
2. If a tree removal permit is being sought, submission of a plan depicting the location and graphical removal status of all Town-regulated trees within the proposed area of disturbance. In addition, the tree plan shall be accompanied by a tree inventory includes a unique ID number, the species, size, health condition and removal status of each tree.				
3. If a wetlands permit is being sought, identification of the wetland and the 100-foot wetland buffer.				
More information about the items required herein can be obtained from the North Castle Planning Department. A copy of the Town Code can be obtained from Town Clerk or on the North Castle homepage: http://www.northcastleny.com/townhall.html				
On this date, all items necessary for a technical review of the proposed site plan have been submitted and constitute a COMPLETE APPLICATION.				



TOWN OF NORTH CASTLE

WESTCHESTER COUNTY 17 Bedford Road Armonk, New York 10504-1898

PLANNING DEPARTMENT Adam R. Kaufman, AICP Director of Planning

Telephone: (914) 273-3542 Fax: (914) 273-3554 www.northcastleny.com

GROSS LAND COVERAGE CALCULATIONS WORKSHEET

Applicat	tion Name or Identifying Title: Douglass Residence Date	11/23/20
Тах Мај	Date of Designation or Proposed Lot No.: 122.16 - 4-16	7 - 1
	ot Coverage	
1.	Total lot Area (Net Lot Area for Lots Created After 12/13/06):	8,712 SF
2.	Maximum permitted gross land coverage (per Section 355-26.C(1)(b)):	2,500 55
3.	BONUS maximum gross land cover (per Section 355-26.C(1)(b)):	1,113.65F
.7	Distance principal home is beyond minimum front yard setback $x 10 = 7$	
4.	TOTAL Maximum Permitted gross land coverage = Sum of lines 2 and 3	3,613.6SF
5.	Amount of lot area covered by principal building: 1 6 205 existing + proposed =	3,613.6SF
6.	Amount of lot area covered by accessory buildings: $475E \text{ existing} + -475E \text{ proposed} =$	OSF
7.	Amount of lot area covered by decks : OSF existing + SISF proposed =	81SF
8.	Amount of lot area covered by porches: OSF existing + OSF proposed =	0 S F
9.	Amount of lot area covered by driveway, parking areas and walkways: 1,7965F existing + -605F proposed =	1,736sF
10.	Amount of lot area covered by terraces: OSF existing + OSF proposed =	OSF
11.	Amount of lot area covered by tennis court, pool and mechanical equip: OSF existing + OSF proposed =	OSF
12.	Amount of lot area covered by all other structures: OSF proposed =	OFF
13. Prop	osed gross land coverage: Total of Lines $5-12=$	3,437SF
does not	3 is less than or equal to Line 4, your proposal complies with the Town's maximum gross act may proceed to the Residential Project Review Commined for review. If Line 13 is greated may be and Seal of Professional Preparing Worksheet 047005	ater than Line 4 your proposal



TOWN OF NORTH CASTLE

WESTCHESTER COUNTY 17 Bedford Road Armonk, New York 10504-1898


PLANNING DEPARTMENT Adam R. Kaufman, AICP Director of Planning

Telephone: (914) 273-3542 Fax: (914) 273-3554 www.northcastleny.com

GROSS LAND COVERAGE WORKSHEET

The following format is to be used for all applications for the purpose of demonstrating the gross land coverage of a property as necessary to show compliance with gross land coverage limitations of the Town Code.

- Scaled worksheets are to be prepared based upon a site plan which represents existing or
 proposed conditions as applicable to the particular circumstances of the approval being
 sought. All site plans and worksheets are required to be prepared by a licensed or
 registered professional in the State of New York.
- 2. Each component of the gross land coverage is to be divided into simple polygons (squares, rectangles, etc.) each being drawn on the plan. The area of each polygon is to be shown by providing the dimensions and resulting area measurement. Each polygon is to be assigned an identifying label for reference purposes.
- 3. A summary table for each component is to be completed. The area of each polygon is to be listed by reference label then added, resulting in the gross land coverage for the entire site.
- 4. Any exception of land coverage from the gross land coverage must be identified on the floor plans and summary tables. The rationale for any exception must accompany the floor area worksheets.
- 5. A schematic illustration of the format is shown below

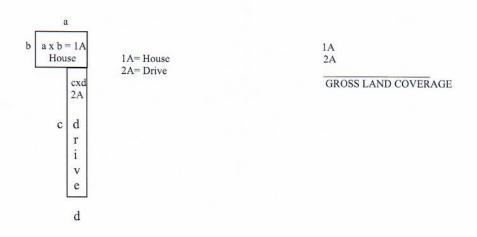

LOT AREA, NET – Lot area m inus seventy five (75) percent of the area of any wetlands, waterbodies and, watercourses, but excluding any adjacent areas, all as defined in C hapter 209 Wetlands and Drai nage, of the Tow n Code, and the area of any steep slopes, as defined Chapter 213, except that in the case of one-family lots, the deduction for steep slopes shall be only fifty (50) percent.

Lot Size	Maximum Permitted Gross Land	
	Coverage for One-Family	
	Dwelling Lots ¹	
	(square feet)	
Less than 5,000 square feet	50% of the lot area	
6000 . 0000		
5,000 to 9,999 square feet	2,500 plus 30% of the lot area in	
	excess of 5,000 square feet	
10,000 to 14,999 square	4,000 plus 24% of the lot area in	
feet	excess of 10,000 square feet	
15,000	•	
15,000 square feet to	5,200 plus 18% of the lot area in	
0.499 acres	excess of 15,000 square feet	
0.5 to 0.749 acres	6,420 plus 15% of the lot area in	
	excess of 0.5 acres	
0.75 / 0.000	The second of th	
0.75 to 0.999 acres	8,050 plus 12% of the lot area in	
	excess of 0.75 acres	
1.0 to 1.999 acres	9,350 plus 9% of the lot area in	
	excess of 1.0 acres	
	3114(1773) (2004) (2004) (2004) (2004) (2004)	
2.0 acres or more	13,270 plus 7.5% of the lot area	
	in excess of 2.0 acres	

^{*}Permitted g ross land co verage limitations for two-family dwelling lots in the R-2F District shall be twenty five (25) percent greater than that permitted for one-family dwelling lots.

NOTWITHSTANDING ABOVE LIMITATIONS, AN ADDITIONAL 1 0 SQUA RE FEET O F G ROSS LA ND COVERAGE SHALL BE PERMITTED FOR EACH ONE FOOT OF FRONT YARD SETBACK OF THE PRINCIPAL DWELLING IN EXCESS OF THE MINIMUM FRONT YARD SETBACK REQUIRED.

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TOWN OF NORTH CASTLE

WESTCHESTER COUNTY 17 Bedford Road Armonk, New York 10504-1898

PLANNING DEPARTMENT Adam R. Kaufman, AICP Director of Planning

January 29, 2019 Telephone: (914) 273-3542 Fax: (914) 273-3554 www.northcastleny.com

FLOOR AREA CALCULATIONS WORKSHEET

Application Name or Identifying Title: Tax Map Designation or Proposed Lot No.:	Douglass Residence	Date: 11/23/20
Tax Map Designation or Proposed Lot No.: _	122:16-4-16	/ /
Floor Area		
1. Total Lot Area (Net Lot Area for Lot	s Created After 12/13/06):	8,712SF
2. Maximum permitted floor area (per	Section 355-26.B(4)):	3,428SF
Amount of floor area contained within 1,1315F existing + 4545F	n first floor: proposed =	15853=
4. Amount of floor area contained within 6345F existing + 2565F	n second floor: proposed =	_890SF
5. Amount of floor area contained within 45/sf existing + Osf p	n garage: proposed =	_890SF _451sF
6. Amount of floor area contained within OSF existing + OSF p	n porches capable of being enclosed: proposed =	_OSF
7. Amount of floor area contained within OSF existing + OSF	n basement (if applicable – see definition) proposed =	018
8. Amount of floor area contained within OSF existing + OSF p		OSF
9. Amount of floor area contained within 475F existing + 475F	n all accessory buildings: proposed =	OSF
10. Pro posed floor area: Total of Lines 3	-9 = _	2,926SF
If Line 10 is less than or equal to Line 2, your and the project may proceed to the Residential P your proposal does not comply with the Town	roject Review Committee for review. If Li	imum floor area regulations ine 10 is greater than Line 2
		11/23/20
Signature and Seal of Professional Preparing V	Vorksheet	Date



TOWN OF NORTH CASTLE

WESTCHESTER COUNTY 17 Bedford Road Armonk, New York 10504-1898


PLANNING DEPARTMENT Adam R. Kaufman, AICP Director of Planning

Telephone: (914) 273-3542 Fax: (914) 273-3554 www.northcastleny.com

GROSS FLOOR AREA WORKSHEET

The following format is to be used for all applications for the purpose of demonstrating the gross floor area of a building or group of buildings as necessary to show compliance with a building or group of buildings as necessary to show compliance with floor area limitations of the Town Code or as otherwise necessary to illustrate the intended or potential use of a structure.

- 1. Scaled worksheets are to be pre pared base d upon floor plans which represent existing or proposed conditions as applicable to the particular circumstances of the approval being sought. All floor plans and worksheets are required to be prepared by a licensed or registered professional in the State of New York.
- 2. The floor area of each floor is to be divided int o s imple polygons (squares, rectangles, etc.) each being drawn on theplan. The area of each polygon is to be shown by providing the dimensions and resulting area measurement. Each polygon is to be assigned an identifying label for reference purposes.
- 3. A summary table for each floor is to be completed. The area of each polygon is to be listed by reference label then added, resulting in the floor area for the entire floor.
- 4. A similar summary table is to be provided listing the total floor a re of each floor within the resulting floor area of each building.
- 5. Any exception of floor area from the gross floor area must be identified on the floor plans and summary tables. The rationale for any exception must accompany the floor area worksheets.
- 6. A schematic illustration of the format is shown below.

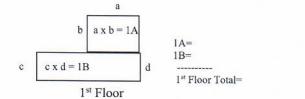

BASEMENT = 1st FLOOR = 2nd FLOOR = GROSS FLOOR AREA

LOT AREA, NET – Lot area minus seventy five (75) percent of the area of any wetlands, waterbodies and, watercourses, but excluding any adjacent areas, all as defined in Chapter 209 Wetlands and Drainage, of the Town Code, and the area of any steep slopes, as defined Chapter 213, except that in the case of one-family lots, the deduction for steep slopes shall be only fifty (50) percent.

FLOOR AREA, GROSS -- The sum of the horiz ontal areas of the several stories of the building or buildings, excluding any floor area used for one ff-street parking or loading purposes (except for one- and two-family residences), measured from the exterior walls or, in the case of a common wall separating two buildings, from the center line of such a common wall, and including any two-story or any enclosed porch, or one having a roof and capable of being enclosed. See the definition of "basement" for exclusion of basement/mechanical areas in nonresidential buildings from "floor area, gross." For one- and two-family residences, any attic space with a floor to ceiling height of 7.5 feet or greater shall be included as part of gross floor area, as shall those portions of any basement with a floor to ceiling height of 7.5 feet or greater if the basement is considered a "story" in accordance with one of the following three alternative measurements:

- A. Where the finished surface of the floor ab ove the basement is more than six feet above average grade.
- B. Where the finished surface of the floor ab ove the basement is more than six feet above the finished ground level for more than 50% of the total building perimeter.
- C. Where the finished surface of the floor above the basement is more than 12 feet above the finished ground level at any point along the building perimeter.

Lot Size	Maximum Permitted Gross Floor Area for One-Family Dwellings and Accessory Buildings ¹ (square feet)	
Less than 5,000 square feet	1,875 or 50% of the lot area, whichever is greater	
5,000 to 9,999 square feet	2,500 plus 25% of the lot area in excess of 5,000 square feet	
10,000 to 14,999 square feet	3,750 plus 20% of the lot area in excess of 10,000 square feet	
15,000 square feet to 0.499 acres	4,750 plus 15% of the lot area in excess of 15,000 square feet	
0.5 to 0.749 acres	5,768 plus 10% of the lot area in excess of 0.5 acres	
0.75 to 0.999 acres	6,856 plus 8% of the lot area in excess of 0.75 acres	
1.0 to 1.499 acres	7,727 plus 6% of the lot area in excess of 1.0 acres	
1.5 to 1.999 acres	9,034 plus 5% of the lot area in excess of 1.5 acres	
2.0 to 3.999 acres	10,122 plus 4% of the lot area in excess of 2.0 acres	
4.0 acres or more	13,607 plus 3% of the lot area in excess of 4.0 acres	

^{*}Permitted gross floor area for tw o-family dwellings in the R-2F District shall be one-third (1/3) greater than that permitted for one-family dwellings.

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