

TOWN OF NORTH CASTLE

WESTCHESTER COUNTY 17 Bedford Road Armonk, New York 10504-1898

RESIDENTIAL PROJECT REVIEW COMMITTEE Adam R. Kaufman AICP, Chair Telephone: (914) 273-3000 x 43 Fax: (914) 273-3554 www.nortcastleny.com

RESIDENTIAL PROJECT REVIEW COMMITTEE (RPRC) APPLICATION

Section I- PROJECT

ADDRESS: 58 Whippoorwill Road East

Section III- DESCRIPTION OF WORK:

New rear terrace under existing permit

Section III- CONTACT INFORMATION:

APPLICANT: Patrick M. Cro	oke, Architect						
ADDRESS: 20 Woodsbridge	Road, Katonah, NY 105	36					
- PHONE: 914-234-6093	914-263-4850	EMAIL patrick@pmcarchitect.com					
PROPERTY OWNER: Qasir	<u>n LLC, Mohsan Zafir, Pre</u>	sident					
ADDRESS: 2322 Arthur Ave	, Suite 208, Bronx, NY 10	0458					
PHONE: (347 740-4432	_MOBILE:	EMAIL: rmzcontracting@aol.com					
PROFESSIONAL:: Patrick M.	Croke, Architect						
ADDRESS: 20 Woodsbridge	Road, Katonah, NY 105	36					
Address: Qasim LLC, Mohsan Zafir, President Address: 2322 Arthur Ave, Suite 208, Bronx, NY 10458 PHONE: (347 740-4432							
EMAIL: patrick@pmcarch	itect.com						
Section IV- PROPERTY IN	NFORMATION:						
Zone: R-10	Tax ID (lot designation)	07.02-3-29					



Town of North Castle Residential Project Review Committee 17 Bedford Road Armonk, New York 10504

(914) 273-3542 (914) 273-3554 (fax)

RPRC COMPLETENESS REVIEW FORM

This form represents the standard requirements for a completeness review for all Residential Project Review Committee submissions. Failure to provide all of the information requested will result in a determination that the application is incomplete.

Project Name on Plan:

□Initi	ial Submittal Revised Preliminary
Street	Location:
Zonin	g District: Property Acreage: Tax Map Parcel ID:
Date:_	
DEPA	RTMENTAL USE ONLY
Date F	Filed: Staff Name:
Items	ninary Plan Completeness Review Checklist marked with a "[]" are complete, items left blank "[]" are incomplete and must be eted, "NA" means not applicable.
□ 1.	Plan prepared by a registered architect or professional engineer
<u></u> 2.	Aerial photo (Google Earth) showing the applicant's entire property and adjacent properties and streets
□3.	Map showing the applicant's entire property and adjacent properties and streets
4 .	A locator map at a convenient scale
<u></u> 5.	The proposed location, use and design of all buildings and structures
<u>6</u> 6.	Existing topography and proposed grade elevations
7 .	Location of drives
8.	Location of all existing and proposed site improvements, including drains, culverts, retaining walls and fences

RPRC COMPLETENESS REVIEW FORM

Page 2

- 9. Description of method of water supply and sewage disposal and location of such facilities
- 10. The name and address of the applicant, property owner(s) if other than the applicant and of the planner, engineer, architect, surveyor and/or other professionals engaged to work
- 11. Submission of a Zoning Conformance Table depicting the plan's compliance with the minimum requirements of the Zoning District
- □12. If a tree removal permit is being sought, submission of a plan depicting the location and graphical removal status of all Town-regulated trees within the proposed area of disturbance. In addition, the tree plan shall be accompanied by a tree inventory includes a unique ID number, the species, size, health condition and removal status of each tree.
- 13. If a wetlands permit is being sought, identification of the wetland and the 100-foot wetland buffer.

More information about the items required herein can be obtained from the North Castle Planning Department. A copy of the Town Code can be obtained from Town Clerk or on the North Castle homepage: <u>http://www.northcastleny.com/townhall.html</u>

On this date, all items necessary for a technical review of the proposed site plan have been submitted and constitute a COMPLETE APPLICATION.



TOWN OF NORTH CASTLE

WESTCHESTER COUNTY 17 Bedford Road Armonk, New York 10504-1898

PLANNING DEPARTMENT Adam R. Kaufman, AICP Director of Planning Telephone: (914) 273-3542 Fax: (914) 273-3554 www.northcastleny.com

GROSS LAND COVERAGE CALCULATIONS WORKSHEET

Applic	ation Name or Identifying Title: 58 Whippoorwill Road East	Date:09/07/2021
Tax M	ap Designation or Proposed Lot No.: 107.02-3-29	
Gross]	Lot Coverage	
1.	Total lot Area (Net Lot Area for Lots Created After 12/13/06):	7,938 s.f.
2.	Maximum permitted gross land coverage (per Section 355-26.C(1)(b)):	3,381 s.f.
3.	BONUS maximum gross land cover (per Section 355-26.C(1)(b)):	
	Distance principal home is beyond minimum front yard setback 4.41 $\times 10 =$	44.1 s.f.
4.	TOTAL Maximum Permitted gross land coverage = Sum of lines 2 and 3	3,425 s.f.
5.	Amount of lot area covered by principal building: <u>937 s.f.</u> existing $+$ <u>o</u> proposed =	937.s.f
6.	Amount of lot area covered by accessory buildings: $_^{0}$ existing + $_^{0}$ proposed =	0
7.	Amount of lot area covered by decks: existing + <u>236</u> proposed =	236 s.f.
8.	Amount of lot area covered by porches: <u>185</u> existing + <u>0</u> proposed =	185 s.f.
9.	Amount of lot area covered by driveway, parking areas and walkways: <u>761</u> existing + <u>209</u> proposed =	970 s.f.
10.	Amount of lot area covered by terraces: <u>o</u> existing + $\frac{493}{}$ proposed =	493 s.f.
11.	Amount of lot area covered by tennis court, pool and mechanical equip: <u>\circ</u> existing + <u>\circ</u> proposed =	0
12.	Amount of lot area covered by all other structures: $_^{0}$ existing + $_^{0}$ proposed =	0
13. Pro	prosed gross land coverage: Total of Lines 5 – 12 =	2,821 s.f.

If Line 13 is less than or eq ual to Line 4, your proposal **complies** with the Town's maximum gross land coverage regulations and the project may proceed to the Residential Project Review Committee for review. If Line 13 is greater than Line 4 your proposal does not comply with the Town's regulations.

dots not comply with the rown's regulations.	THE ROKE TZ	9
Signature and Seat of Professional Preparing W	ALARIA COLUMNICHAELAN	Date

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TOWN OF NORTH CASTLE

WESTCHESTER COUNTY 17 Bedford Road Armonk, New York 10504-1898


PLANNING DEPARTMENT Adam R. Kaufman, AICP Director of Planning January 29, 2019 Telephone: (914) 273-3542 Fax: (914) 273-3554 www.northcastleny.com


FLOOR AREA CALCULATIONS WORKSHEET


x Map Designation or Proposed Lot No.: 107.02-3-29 por Area Total Lot Area (Net Lot Area for Lots Created After 12/13/06): Maximum permitted floor area (per Section 355-26.B(4)): Amount of floor area contained within first floor: 937 s.f. existing + 0 proposed = Amount of floor area contained within second floor: 437 s.f. existing + 0 proposed = Amount of floor area contained within garage: 0 existing + 0 proposed = Amount of floor area contained within garage: 0 existing + 0 proposed = Amount of floor area contained within porches capable of being enclosed: 185 existing + 0 proposed =	Date: 09/07/2021
x Map Designation or Proposed Lot No.: 107.02-3-29 Yes Total Lot Area (Net Lot Area for Lots Created After 12/13/06): Maximum permitted floor area (per Section 355-26.B(4)): Amount of floor area contained within first floor: 937 s.f. existing + 0 proposed = Amount of floor area contained within second floor: 437 s.f. existing + 0 437 s.f. existing + 0 proposed =	
Floor Area	
1. Total Lot Area (Net Lot Area for Lots Created After 12/13/06):	7,938 s.f.
 Total Lot Area (Net Lot Area for Lots Created After 12/13/06): Maximum permitted floor area (per Section 355-26.B(4)): Amount of floor area contained within first floor: 937 s.f. existing + 0 proposed = Amount of floor area contained within second floor: 437 s.f. existing + 0 proposed = Amount of floor area contained within garage: 0 existing + 0 proposed = Amount of floor area contained within porches capable of being enclosed 185 existing + 0 proposed = Amount of floor area contained within basement (if applicable – see definition 2000) Amount of floor area contained within attic (if applicable – see definition 2000) 	3,234.5s.f.
	937.s.f
	437 s.f.
	0
	185
 Amount of floor area contained within basement (if applicable – see definition <u>a</u> existing + <u>a</u> proposed = 	n):
	0
9. Amount of floor area contained within all accessory buildings: existing + proposed =	0
10. Pro posed floor area: Total of Lines $3 - 9 =$	1,559 s.f.


If Line 10 is less than or equal to Line 2, your proposal **complies** with the Town's maximum floor area regulations and the project may proceed to the Residential Project Review Committee for review. If Line 10 is greater than Line 2 your proposal does not comply with the Town's regulations.

Signature and Seal of Professional Preparing Worksheet

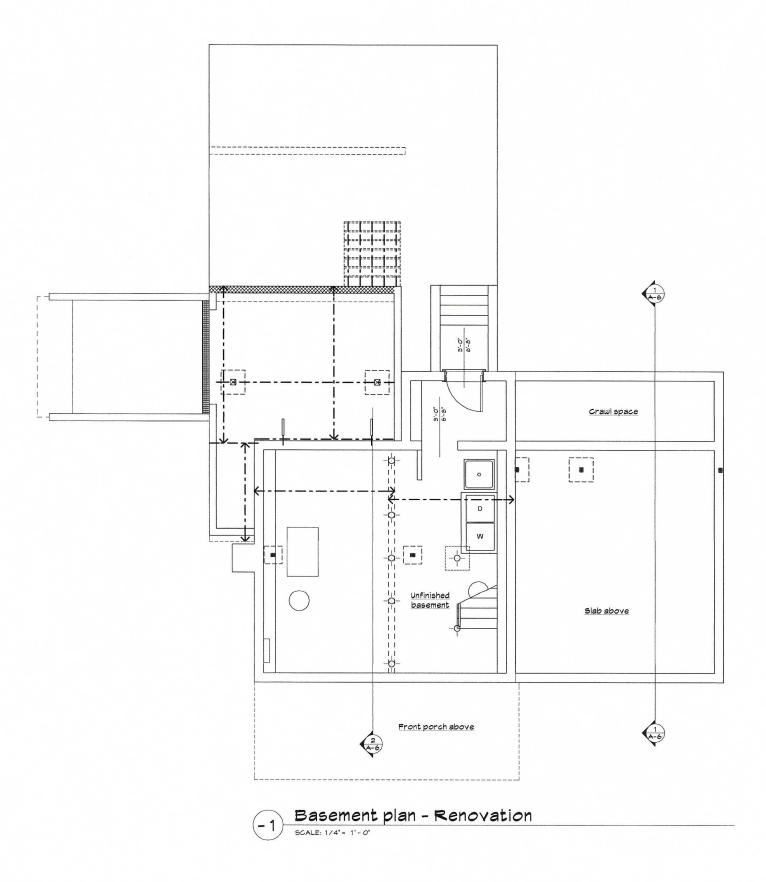

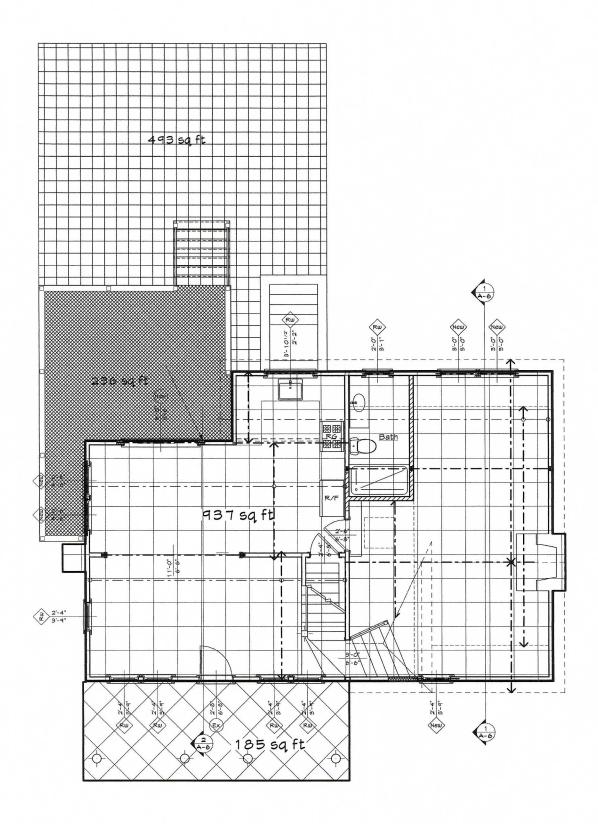

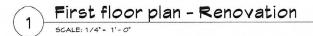

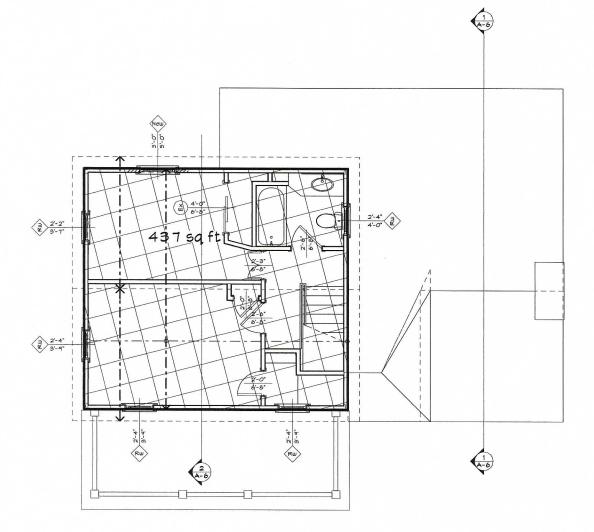

2 Second floor plan - Renovation



Patrick M. Croke Architect

20 Woodsbridge Road Katonah, New York 10536 T: 914.234.6093 F: 914.234.0548



info@pmcarchitect.com

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DRAWINGS AND SPECIFICATIONS, AS INSTRUMENTS OF PROFESSIONAL SERVICE, ARE AND SHALL REMAIN THE PROPERTY OF THE ARCHITECT. DOCUMENTS ARE NOT BE USED, IN WHOLE OR IN PART, FOR OTHER PROJECTS OR PURPOSES OR BY ANY OTHER PARTIES THAN THOSE AUTHORIZED BY CONTRACT WITHOUT THE SPECIFIC WRITTEN AUTHORIZATION OF THE ARCHITECT.

CONTRACTORS MUST CHECK ALL DIMENSIONS ON SITE. ONLY FIGURED DIMENSIONS ARE TO BE WORKED FROM. DISCREPANCIES MUST BE REPORTED IMMDIATELY TO THE ARCHITECT BEFORE PROCEEDING.

NOTE: DO NOT SCALE DRAWINGS

This project is designed in conformance with the 2020 Residentail code of NYS

orwill Rd E (Zafar)\2 - Drawings\20051 - 58 Whi

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			1
10	RPRC submission	09/07/21	13
9	Revisions as per 7/20/21 site visit and 7/22/21 inspection report	08/18/21	1
8	Construction phase changes	01/12/21	1
7	Revised per Building department review comments dated 01/06/21	01/06/21	1
6	Revised per Building department review comments dated 11/06/20	11/10/20	1
5	Submission for new permit under new ownership	10/09/20	1
4	Window change at 2nd floor rear bedroom. Revisions to Drawings A-4 and A-5 only.	05/31/19	*
3	Additional notes about foundation wall under new deck (drawing A-2)	01/31/19	1
2	Silt fence added to site plan	01/14/19	*
1	RPRC submission	01/14/19	*
No:	Description:	Date:	_

Revisions:

Project Name:

Renovation and new <u>deck</u> 58 Mhippoorwill Rd E

Armonk, NY

Drawing Title: Site Photo and map

Date: 09/07/21 Revised as noted abo Project # 2005 Scale:



Drawing Number:

As noted



Zoning analysis

Proposal for addition and renovation to existing residence 58 Whippoorwill Road, North Castle, NY

Parcel ID:	Section 2, Block 2, Lot 21E
Zone:	R-10
Lot size (acres):	0.182
Lot size (square feet):	7,938

Regulation	Minimum	Maximum	Actual (Existing)	Proposed	Remarks
Min. lot size (Square feet)	10,000		7,938	No change	
Front yard (Feet)	30	· · · · · · · · · · · · · · · · · · ·	25.59	25.59	1
Side #1 (Feet)	15	1	29.05	24' +/-	1
Side #2 (Feet)	15	1	0.58	0.58	1
Total two sides (Feet)	30	1	29.63	24.58' +/-	1
Rear yard (Feet)	30	1	48.75	48' +/-	1
Max. height, stories		2 1/2	2	2	
Max. height, feet	1	30'	22 +/-	22 +/-	
Frontage (Feet)	100	1	69	No change	
Width (Feet)	100	1	69	No change	
Depth (Feet)	100	1	114.98	No change	
Max. gross fl. Area (SF)		3235	1371	1371	
Gross land coverage (SF)		3,381	2,476	2,927	2
		30%	17.33%	14.70%	Percentage, 3
Building coverage	1	2,381	1,376	1,167	Square feet, 3

Remarks:

1 - Proposed setbacks are to the existing house or new deck, whichever is less.

2 - Land coverage as scaled from subdivision map. Driveway coverage increased from 681 SF to 705 SF for existing extension

of second curb cut to Whippoorwill Road.

3 - Existing building coverage as per subdivision map

Table R301.2(1)

Climatic and Geographic Design Criteria

Ground		WIND [DESIGN		Seismic Subject to damage from:					Ice barrier	
Snow		Topographic	Special	Wind-borne	Design		Frost line		design	underlayment	Flood
Load	Speed (MPH)	effects	wind region	debris zone	Category	Weathering	depth	Termite	temp.	required	hazards
30	115 MPH ultimate wind speed	No	Yes	No	С	Severe	42"	Moderate - heavy	7° F	Yes	No

GENERAL NOTES AND SPECIFICATIONS FOR STRUCTURAL MEMBERS

SECTION 03010 - CONCRETE

- A. Scope of Work
 - 1) Concrete shall be ready mix 3500 psi ultimate strength in 28 days. Slump shall not exceed 4". 2) Reinforcement shall be as indicated. Slabs shall be reinforced with 6" x 6" W1.4 x W1.4 WWF unless otherwise indicated. All reinforcing bars shall conform to ASTM (A625) deformed bars with a minimum yield stress of 40,000 PSI.

B. Execution

1) Place concrete in conformance with American Concrete Institute Standards.

SECTION 04200 - UNIT MASONRY

- A. Materials
 - 1) Concrete Masonry Units (CMU) ASTM C90, Grade N, Type 1, normal weight units.
 - 2) Bricks Standard Modular Brick, color as specified by architect.
 - 3) Masonry Mortar, Exterior: ASTM C 270, portland cement-lime mortar, Type M. 4) Continuous Masonry Wire Reinforcement: Truss or Ladder design, minimum 9 ga. welded steel
 - wire, 0.8 oz. hot-dip zinc coating, width 1-1/2" to 2" less than wall thickness.
- B. Execution
 - 1) Comply with recommendations of the National Concrete Masonry Association and A.C.I.531. 2) Install continuous masonry wire reinforcement at every other course in CMU walls. Overlap at corners. Lap 16" at ends.
 - 3) Anchor wall to adjacent construction with panel anchors.
 - 4) Bond intersecting walls with masonry units or provide anchors spaced 0'- 8" O.C.
 - 5) Anchor ends of walls to structure with anchors spaced 8" O.C., except as otherwise shown. 6) Do masonry work only when average daily temperature is above 40 degrees F. or consult
 - Architect for cold weather procedures which shall be provided at no additional cost.

SECTION 05120 - STRUCTURAL STEEL

- A. Materials
 - 1) Steel shapes, plates, and bars: ASTM A36.
 - 2) Steel pipe: ASTM A501
- 3) High strength threaded fasteners: ASTM A325 B. Execution
 - 1) Comply with Specifications for the Design, Fabrication and Erection of Structural Steel for Buildings of the American Institute of Steel Construction (latest edition).

SECTION 06100 - ROUGH CARPENTRY

- A. Materials
 - 1) Framing shall be as shown on the drawings and shall conform to all applicable building codes. All members unless otherwise noted (U.O.N.) on structural drawings shall be one of the following: a) Douglas Fir (South) No. 2 or Better (Minimum design values in psi: Fb=825, Fv=90,
 - E=1,200,000).
 - b) TJI Joists Plywood web joists as manufactured by Trus Joist Corporation. c) LVL as used on the drawings refers to 1.9 E Microllam Laminated Veneer Lumber beams manufactured under the TrusJoist brand by Weyerhauser.
 - d) PSL as used on the drawings refers to 2.0 E Microllam Parallel Strand Lumber beams manufactured under the TrusJoist brand by Weyerhauser.
 - e) LSL as used on the drawings refers to 1.3 E TimberStrand Laminated Strand Lumber beams manufactured under the TrusJoist brand by Weyerhauser.
 - f) Any framing lumber in contact with concrete, exposed to weather or less than 6" above grade shall be pressure treated unless specifically noted otherwise.
 - 2) Studs shall be nom. 2" x 6" for exterior wall and nom. 2" x 4" for interior walls unless otherwise noted, and placed not over 16 o.c. and shall be doubled at openings and tripled at corners.
 - 3) Joists and rafters shall be single lengths between bearings and doubled around openings. All joists under parallel partitions and all headers and trimmers shall be doubled.
 - 4) Connectors at all flush framing and where noted shall be galvanized as manufactured by Teco, Simson, or equal. Sizes as required.
 - 5) Provide blocking, bridging, cats, furring, etc., as required by good practice. Cross-bridging shall not be over 8'-0" o.c. in all floor and roof framing of standard dimensional lumber.
 - 6) All members manufactured by Trus Joist Corporation shall be installed in strict accordance with the manufacturer's requirements and suggested details.
 - 7) All floor and flat roof systems utilizing shall be constructed as a "glued and nailed" system with 3/4" T&G plywood sheathing.
 - 8) Any wood or laminated beam supported on steel columns shall be supported using Lally Column Caps (LCC) as manufactured by Simpson. LCC to be welded to column or provide other sufficient permanent attachment to column.



Our 50 Series Replacement double-hung features a slim profile that allows for maximum light and a clean design for more of a contemporary style.

Simplified design


Flat exterior frame for a clean and modern appearance.




SHOWN

Easy cleaning

Tilt-in feature for easy cleaning from inside your home.

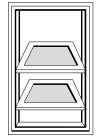

Weathertight performance Dual weatherstripping helps seal out dust, wind and water. The **Standard lock** pulls the sash tight to seal out elements.

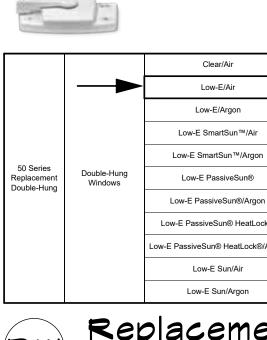

Building coverage summary

58 Whippoorwill Road, North

Zone: R-10

Lot size (acre): 0.182

Existing lot:

Max. building coverage: 30%


Max. gross land coverage:



.		
Castle,	NY	


			Existing coverage are scaled from survey dat David Scott Freeman, L	ed 8/9/14 by	based on the outer di proposed a			
			Existing	1		Proposed		
		Structure/item/area	Foot print	% of lot	Change (SF)	Foot print	% of full lot	
		Residence - Existing	1,167	14.70%	0	1,167	14.70%	
		Car port	209	2.63%	(209)	0	0.00%	
		(Existing total building coverage of 1376 SF as per subdivision map)						
7,938	SF	Total building coverage	1,376	17.33%	(209)	1,167	14.70%	
2,381	SF		Ma	allowed bui	Iding coverage:	Percent	30%	
3,381	SF		Max. allowed buil		iung coverage.	SF	2,381	
			Existing	1	Proposed			
		Structure/item/area	Foot print	% of lot	Change (SF)	Foot print	% of full lot	
	Building coverage (from above)	1,376	17.33%	(209)	1,167	14.70%		
		Building coverage (from above) Existing deck at rear	<u>1,376</u> 31	<u>17.33%</u> 0.39%	(209) (31)	<u>1,167</u> 0		
							0.00%	
		Existing deck at rear		0.39%	(31)	0	14.70% 0.00% 2.97% 0.00%	
		Existing deck at rear New deck at rear	31	0.39% 0.00%	(31) 236	0 236	0.00% 2.97% 0.00%	
		Existing deck at rear New deck at rear Back recessed area	31 235	0.39% 0.00% 2.96%	(31) 236 (235)	0 236 0	0.00% 2.97% 0.00% 0.77%	
		Existing deck at rear New deck at rear Back recessed area Back recessed area ramp and walls	31 235 61	0.39% 0.00% 2.96% 0.77%	(31) 236 (235) 0	0 236 0 61	2.97%	
		Existing deck at rear New deck at rear Back recessed area Back recessed area ramp and walls Free standing wall	31 235 61 12 56	0.39% 0.00% 2.96% 0.77% 0.15% 0.71%	(31) 236 (235) 0 (12) 0	0 236 0 61 0 56	0.00% 2.97% 0.00% 0.77% 0.00% 0.71%	
		Existing deck at rear New deck at rear Back recessed area Back recessed area ramp and walls Free standing wall Walks	31 235 61 12	0.39% 0.00% 2.96% 0.77% 0.15% 0.71% 8.88%	(31) 236 (235) 0 (12) 0 209	0 236 0 61 0 56 914	0.00% 2.97% 0.00% 0.77% 0.00% 0.71% 0.00%	
		Existing deck at rear New deck at rear Back recessed area Back recessed area ramp and walls Free standing wall Walks Driveways - Increase is area under	31 235 61 12 56	0.39% 0.00% 2.96% 0.77% 0.15% 0.71%	(31) 236 (235) 0 (12) 0	0 236 0 61 0 56	0.00% 2.97% 0.00% 0.77% 0.00% 0.71% 0.00%	
		Existing deck at rear New deck at rear Back recessed area Back recessed area ramp and walls Free standing wall Walks Driveways - Increase is area under carport	31 235 61 12 56	0.39% 0.00% 2.96% 0.77% 0.15% 0.71% 8.88%	(31) 236 (235) 0 (12) 0 209	0 236 0 61 0 56 914	0.00% 2.97% 0.00% 0.77% 0.00% 0.71%	

Google Maps 58 - 60 Whippoorwill Road East

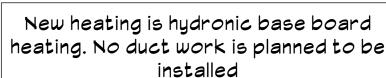

freezing annual index temp. 1160 (1500 or less)



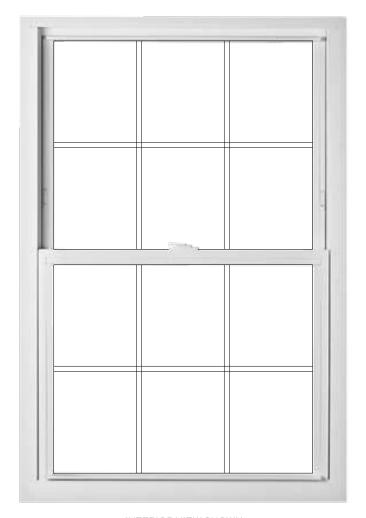

INTERIOR VIEW SHOWN

Exterior colors

Flexible ventilation Double-hung windows have two

operating sash that move up and down and allow **venting from the** top and bottom. This window also features vent latches for the option of **partial ventilation**.



Easy installation to save you time **Custom sizes** ensure an exact fit while **pre-drilled installation** holes save you time.




DID YOU KNOW?


This window is also available in a single-hung where only the bottom sash opens and tilts in for cleaning.

		White	Beig	le														
		1	· · · · · · · · · · · · · · · · · · ·							-	I							
	2.2mm	Intercept		0.48	0.62	0.65	-	-	-	-	Intercept	0.48	0.56	0.58	-	-	-	
	3.0mm	Intercept		0.48	0.61	0.64	-	-	-	-	Intercept	0.49	0.55	0.57	-	-	-	
	2.2mm	Intercept		0.34	0.29	0.55	-	-	-	-	Intercept	0.34	0.26	0.49	-	-	-	-
	3.0mm	Intercept		0.35	0.29	0.54	-	-	-	-	Intercept	0.36	0.26	0.48	-	-	-	
	2.2mm	Intercept		0.30	0.29	0.55	-	NC	-	-	Intercept	0.30	0.26	0.49	-	NC	-	
	3.0mm	Intercept		0.30	0.29	0.54	-	NC	-	-	Intercept	0.31	0.26	0.48	-	-	-	Π-
	2.2mm	Intercept		0.34	0.25	0.50	-	-	-	S	Intercept	0.34	0.23	0.44	-	-	-	5
	3.0mm	Intercept		0.34	0.25	0.49	-	-	-	S	Intercept	0.35	0.23	0.44	-	-	-	5
-	2.2mm	Intercept		0.30	0.25	0.50	-	NC	SC	S	Intercept	0.30	0.23	0.44	-	NC	SC	
n	3.0mm	Intercept	SIL-N-2	0.30	0.25	0.49	-	NC	SC	S	Intercept	0.31	0.23	0.44	-	-	-	
	2.2mm	Intercept		0.34	0.45	0.56	-	-	-	-	Intercept	0.34	0.40	0.50	-	-	-	
	3.0mm	Intercept		0.35	0.44	0.56	-	-	-	-	Intercept	0.36	0.40	0.50	-	-	-	
	2.2mm	Intercept		0.30	0.45	0.56	Ν	-	-	-	Intercept	0.30	0.41	0.50	-	-	-	
on	3.0mm	Intercept		0.31	0.45	0.56	-	-	-	-	Intercept	0.32	0.40	0.50	-	-	-	
-1-0	2.2mm	Intercept		0.31	0.38	0.56	-	-	-	-	Intercept	0.31	0.34	0.50	-	-	-	
ock®	3.0mm	Intercept		0.31	0.37	0.56	-	-	-	-	Intercept	0.32	0.33	0.50	-	-	-	
2/4	2.2mm	Intercept		0.28	0.37	0.56	Ν	NC	-	-	Intercept	0.28	0.34	0.50	Ν	NC	-	Π.
3/Argon	3.0mm	Intercept		0.28	0.37	0.56	Ν	NC	-	-	Intercept	0.29	0.33	0.50	-	NC	-	
	2.2mm	Intercept		0.34	0.23	0.43	-	-	-	S	Intercept	0.34	0.20	0.38	-	-	-	
	3.0mm	Intercept		0.34	0.23	0.43	-	-	-	S	Intercept	0.35	0.20	0.38	-	-	-	
	2.2mm	Intercept		0.30	0.22	0.43	-	NC	SC	S	Intercept	0.30	0.20	0.38	-	NC	SC	
	3.0mm	Intercept		0.30	0.22	0.43	- 1	NC	SC	S	Intercept	0.31	0.20	0.38	-	-	-	3

Replacement window specs

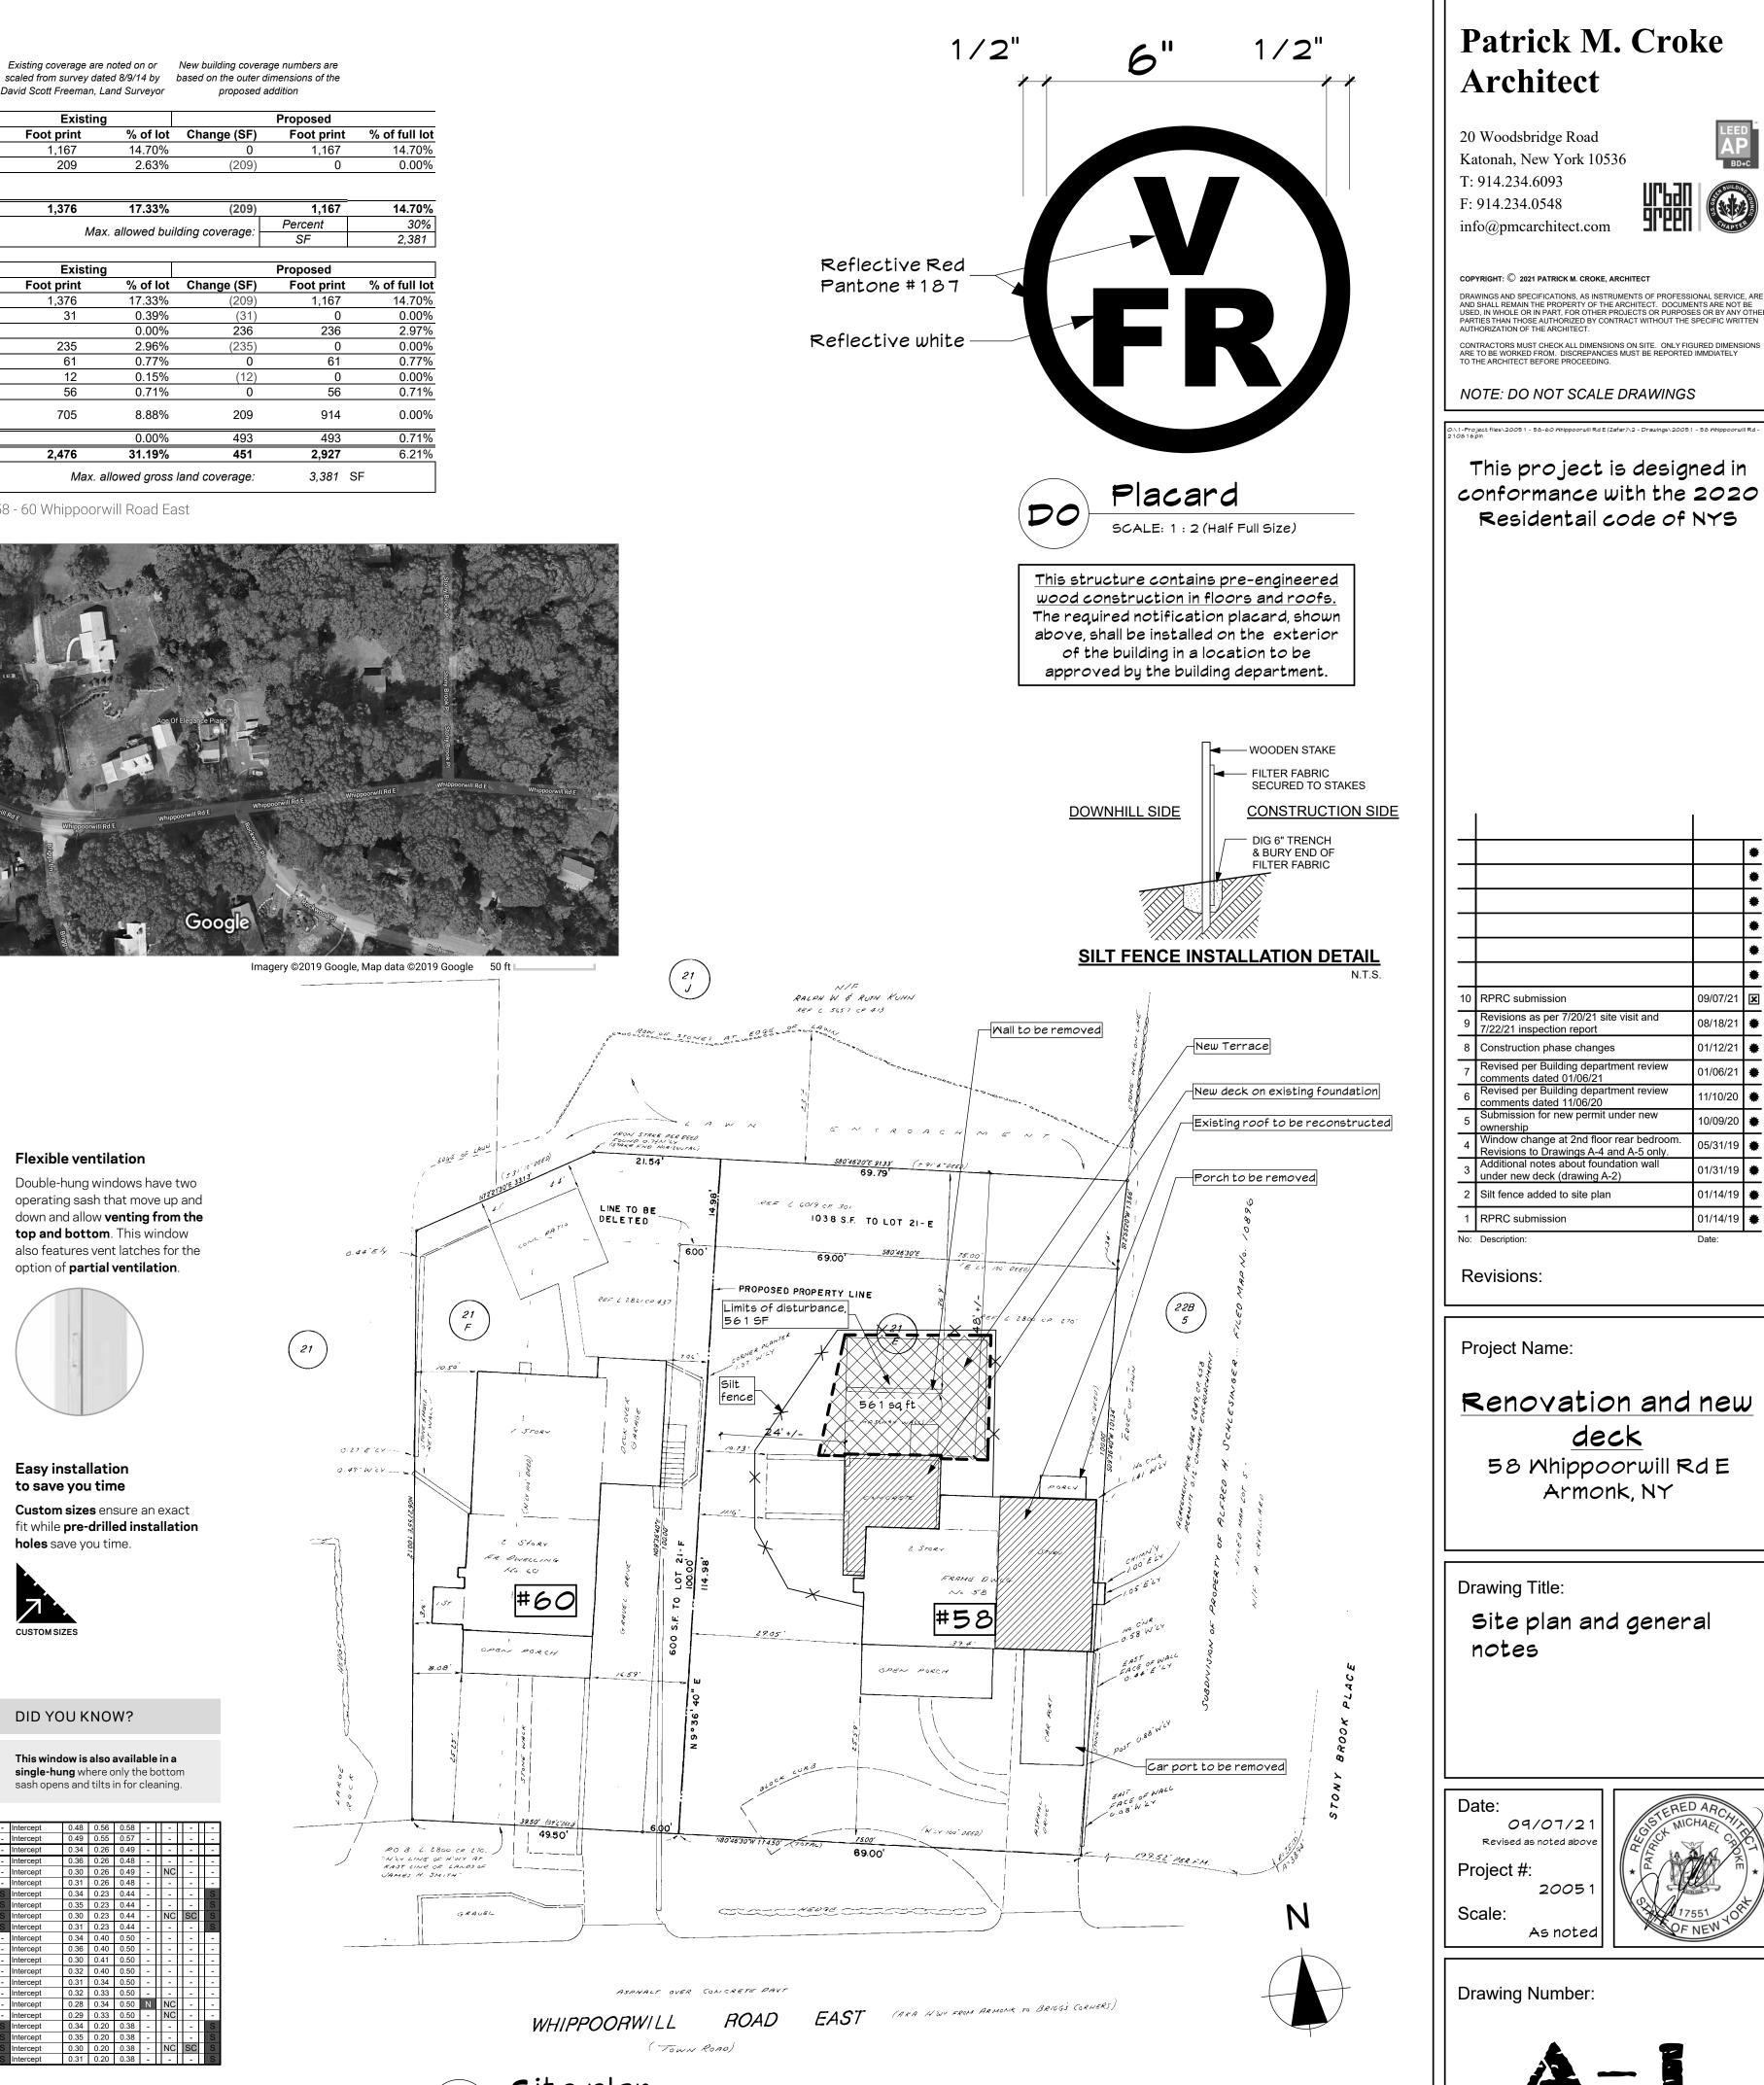




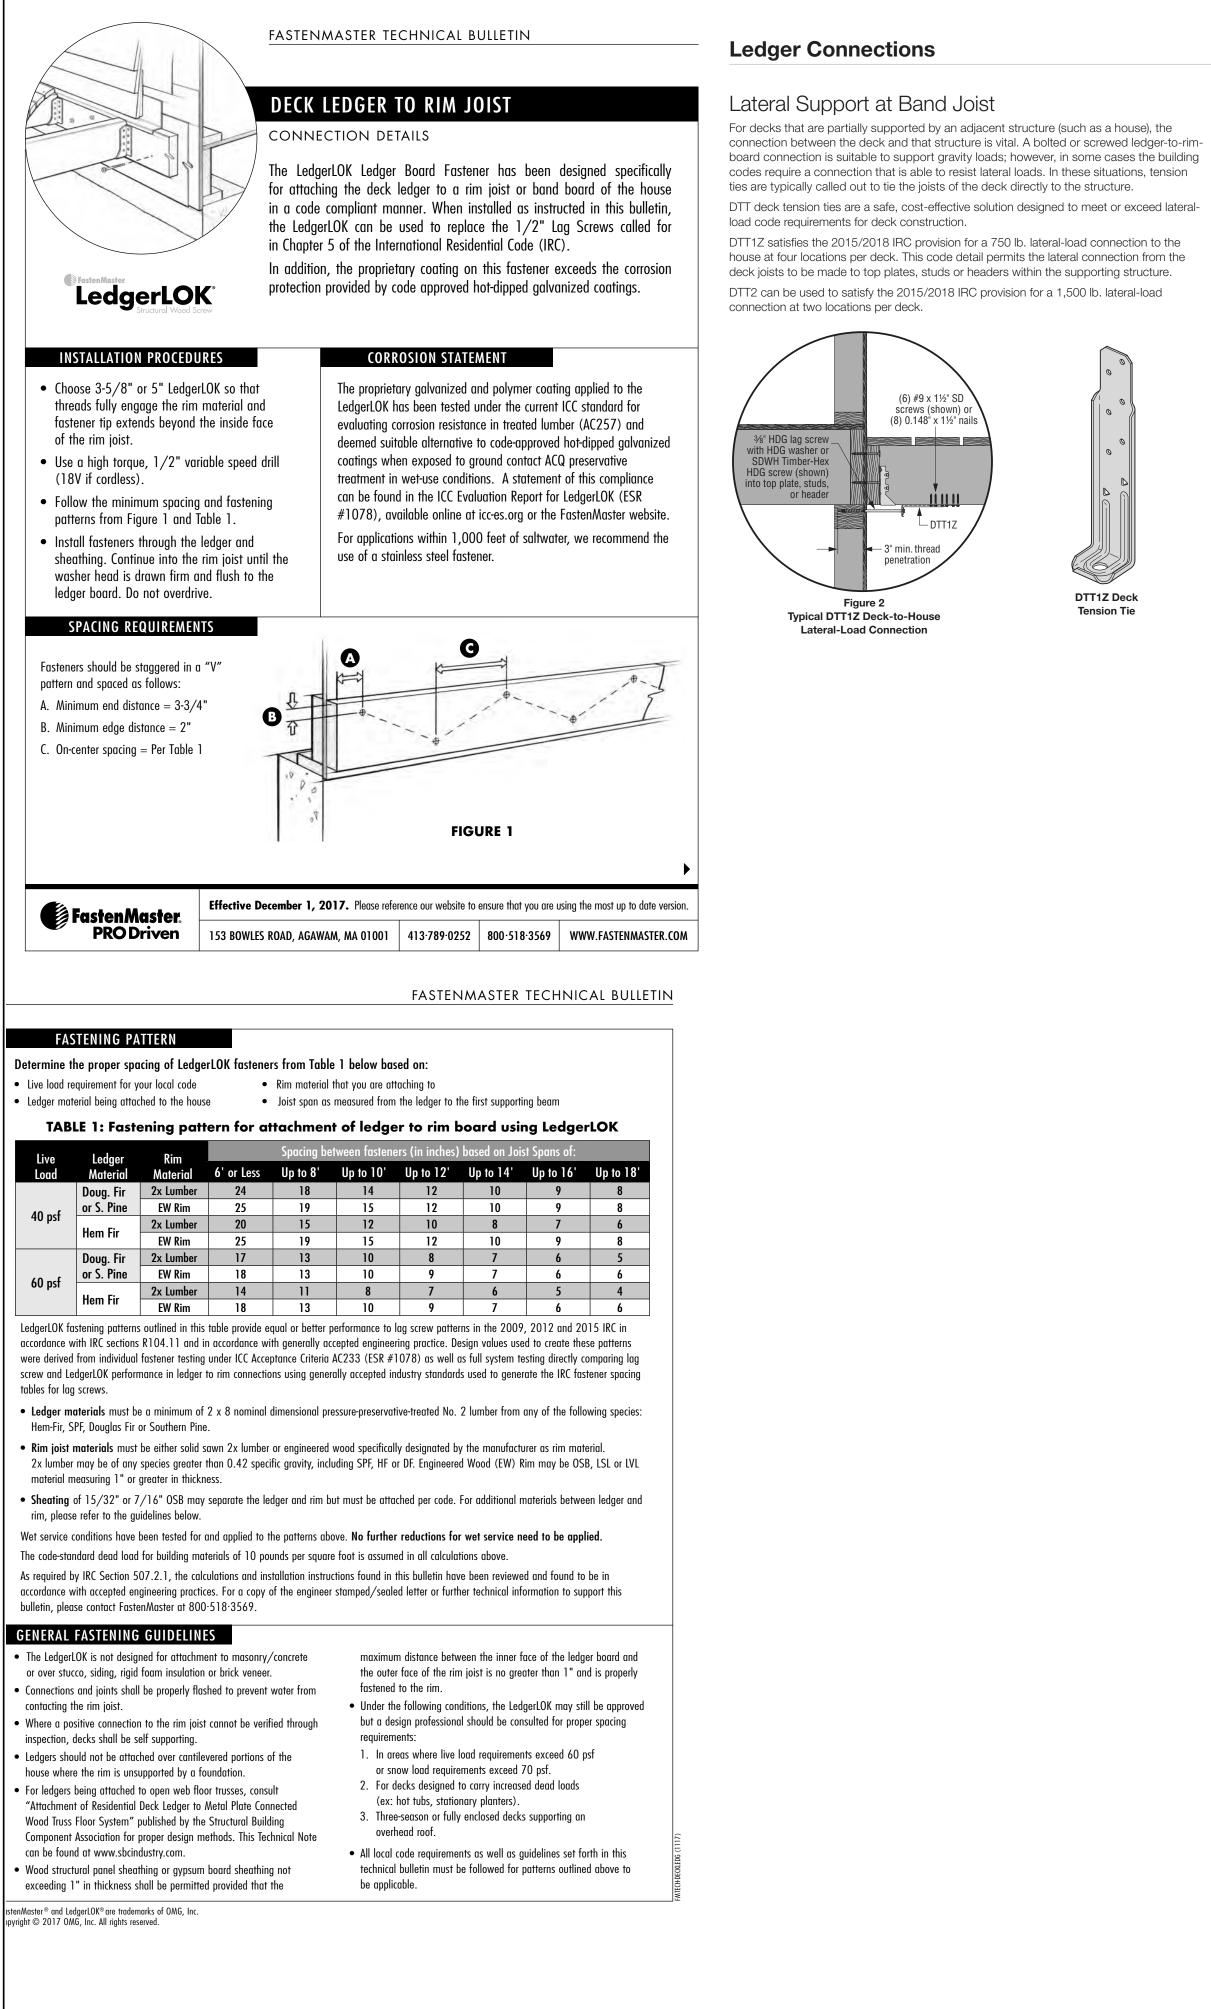

Conservation Constru lew York State, Resid

1 and fenestration requirements)2.1.2) of the 2020 Residential Code of New York State)

Maximum Minimum U-factor R-value (c) 0.32 0.55 49 (d*,* e) 20 cavity or 13 cavity +5 ontinuous 8/13 19 10/13 10 5 under full slab plus 10

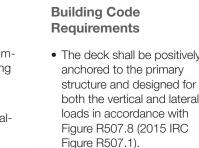

IRC 2018 Section R507.8

IRC 2015 Section R507.1

• Where the lateral-load

connection is permitted to

holdown tension devices shall

two locations per deck, within

24 inches of each end of the

deck, and have an allowable

IRC 2018 Section R507.9.2

than 1,500 lb.

less than 750 lb.

stress design capacity not less

be installed in not less than

be installed per Figure 1

SIMPSON

IRC 2015 Section R507.2.4 vert edge Where the lateral-load connections are provided in accordance with Figure 2, the holdown device shall be within 24 inches of each end of the 24'-0" * deck, and have an allowable stress design capacity of not IRC 2018 Section R507.9.2 IRC 2015 Section R507.2.4 New Terrace |-----l Remove existing wall to grade ╞╼═┠╼═╂══┨ All deck framing to be ╞┠══┠══╂══╂══┨ ╞╏═╴┇╴╴┇╴╴┇ pressure treated _____ -Existing belgium block pad New Deck above Existing slab to remain -Sloped lawn area— 12'-0" Max. (3)2x12 dropped beam Existing trench drain-6x6 posts on 2'x2'x1'd concrete footing (2) 2×12 header, flush-Lateral -Load Connection with DTT 1Z Deck tension tie See Ledger connection on A-2 Joists 1.75"x5.5" _____ Existing(4) 2x8D beam to remain New 1'-6x 1' 6" x 1'd -concrete W footing below post Boiler —(3) 2x4 posts from abov Unfinished (нмн) basement — Electrical panel <u>Front porch above</u>



L______

<u>ction</u>	
lential	

estchester, Suffolk and Nassau Counties and NYC

Depth of insulation

2 ft

2 ft

All existing portions of the building shell that (a) The second R-value applies shere have a free that the second R-value applies shere have been a free that the second R-value applies are the second restricted as the se cavities filled with insulation as per Note C. the mass wall.

(b) The first value shown represents minimum "R" value of continuous insulated sheathing on the interior or the exterior of the wall, the second value shown represents minimum "R" value of cavity insulation at the interior of the basement wall. "10/13" means R-10 continuous insulated sheathing on the interior or exterior of the home or R-13 cavity insulation at the interior of the basement wall.

(c) Alterations, renovations or repairs to roof/ceiling, wall or floor cavities shall be insulated as noted above where possible. If the available cavity is not deep enough, such areas shall be insulated to full depth with insulation having a minimal nominal value of R-3.0/inch. (N1109.1.1 (R503.1.1) of the 2020 Residential Code of New York State)

(d) Ceilings with attic spaces - Where R-49 installation is required in ceilings, installation of R-38 over 100% of the ceiling area requiring installation shall satisfy the requirement for R-49 insulation wherever the full height of uncompressed R 38 insulation extends over the wall top plate at eaves. (R402.2.1)

(e) Ceilings without attic spaces - Where greater than R-30 installation is required in roof/ceilings, installation of R-38 over 100% of the ceiling area requiring installation shall satisfy the requirement for R-49 insulation wherever the full height of uncompressed R 38 insulation extends over the wall ton plate at eavies (R Δ O2 2 1)

-New Terrace - Concrete pavers on sand

12" deep concrete pad poured on 18" deep crushed stone base.

-2 x 1 2 stringers @ 1 2" O.C.

Wall has pushed of first course above lower slab. Rebuild hatched section wall from first course up and grout solid.

Existing foundation walls Excavate to bottom of footing and report findings to architect prior to start of construction. If fotings are not to 42" below grade, a redesign of the support walls will be required.

2x12 flush ledger installed over ice and water shield. Install flashing from under siding to extend over top of ledger and under decking. Ledger to be connected to box beam of house with Ledger Lock fasteners installed as per instructions included on this drawing. -Existing stair to basement

Top course of existing wall at this length to be removed and reconstructed.

	Crawl space New 2'x2'x1'd concrete footing below post New 2'x2'x1'd concrete footing below post		
→	(3) 2x4 posts from above		
	<u>Slab above</u>		
	Smoke/CO detector, his interconnected where b	ard wired oossible	lan

(Smoke and Carbon Monoxide (CO) detector may be battery operated as per section J403.2.1 and are not required to be interconnected as per Section J403.2.2)

Patrick M. Croke Architect

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NOTE: DO NOT SCALE DRAWINGS

This project is designed in conformance with the 2020 Residentail code of NYS

1-Project files\20051 - 58-60 Whippoorwill Rd E (Zafar)\2 - Drawings\20051 - 58 Whippoorwill Rd 28 16 pln

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10	RPRC submission	09/07/21	Þ
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No:	Description:	Date:	-

Revisions:


Project Name:

Renovation and new deck

58 Mhippoorwill Rd E Armonk, NY

Drawing Title: Basement floor plan

Date: 09/07/21 Revised as noted abo Project # 200 Scale:

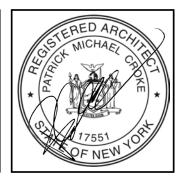

Drawing Number:


As note



Demolition general notes:

- 1. Maintain weatherproof exterior building enclosure at all areas to the maximum extent practical.
- 2. Take care to prevent water, humidity and construction damage.
- 3. Demolish and remove components in an orderly and careful manner, in logical and safe sequence.
- 4. Protect existing supporting structural members and all items which are to remain. Protect
- 5. Provide shoring and bracing to support all areas which are to remain.
- 6. All demolished materials are to be removed and legally disposed of off-site.
- 7. All plumbing, heating, air conditioning and electrical services encountered during demolition shall be properly disconnected and removed if not in use or rerouted as needed for lines to be left in use during construction or feeding other area of the building.


	<u>/////////////////////////////////////</u>
2'-0" 3'-9" ¥	Replacement window (Rw) wi frame or door unit (Rd) withi opening
2'-0" 3'-9" Z	Replacement style window or frame to match existing
2'-0" × 3'-9" Ш	Existing to remain
2'-0" 3'-9"	To be removed and wall patc
2'-0" 3'-9"	To be salvaged and relocate

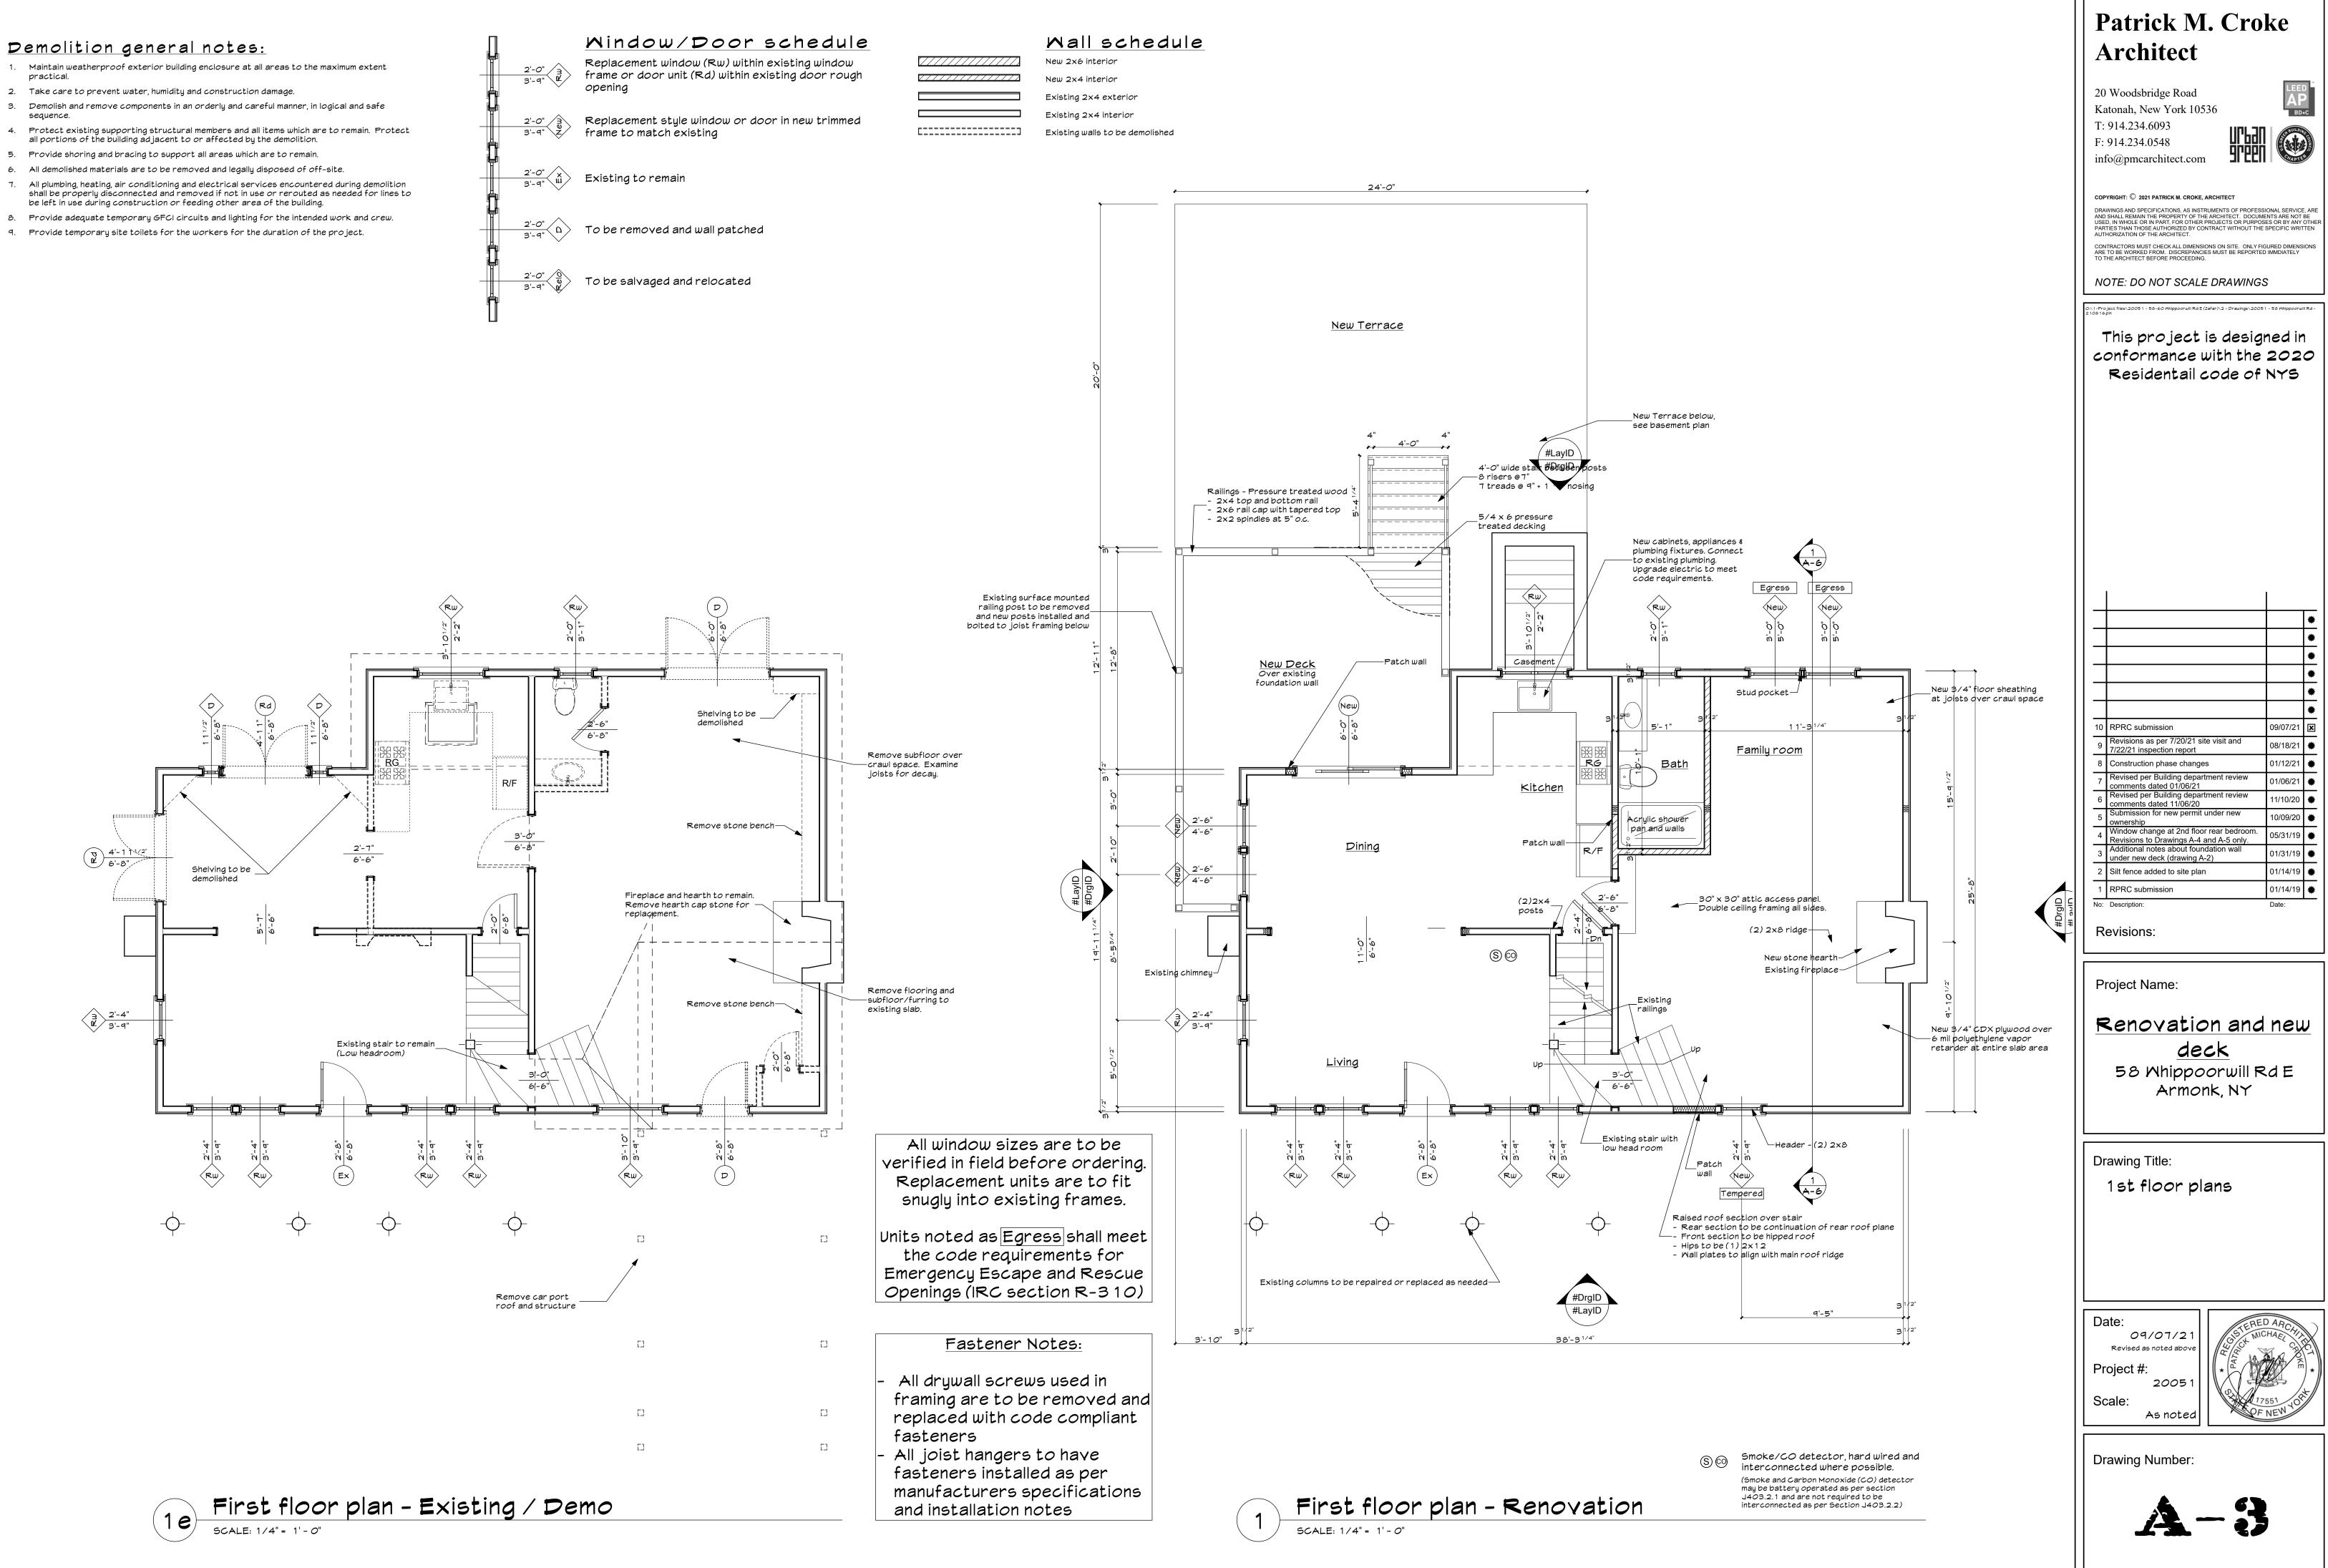




Demolition general notes:

- 1. Maintain weatherproof exterior building enclosure at all areas to the maximum extent practical.
- 2. Take care to prevent water, humidity and construction damage. 3. Demolish and remove components in an orderly and careful manner, in logical and safe
- sequence.
- 4. Protect existing supporting structural members and all items which are to remain. Protect all portions of the building adjacent to or affected by the demolition.
- 5. Provide shoring and bracing to support all areas which are to remain.
- 6. All demolished materials are to be removed and legally disposed of off-site.
- 7. All plumbing, heating, air conditioning and electrical services encountered during demolition shall be properly disconnected and removed if not in use or rerouted as needed for lines to be left in use during construction or feeding other area of the building.
- 8. Provide adequate temporary GFCI circuits and lighting for the intended work and crew. 9. Provide temporary site toilets for the workers for the duration of the project.

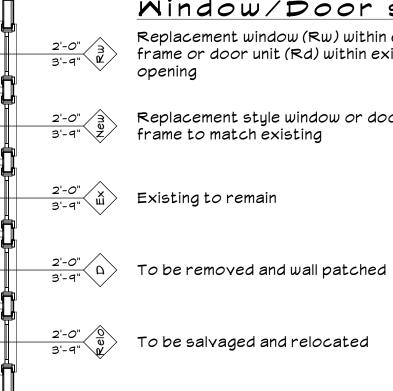

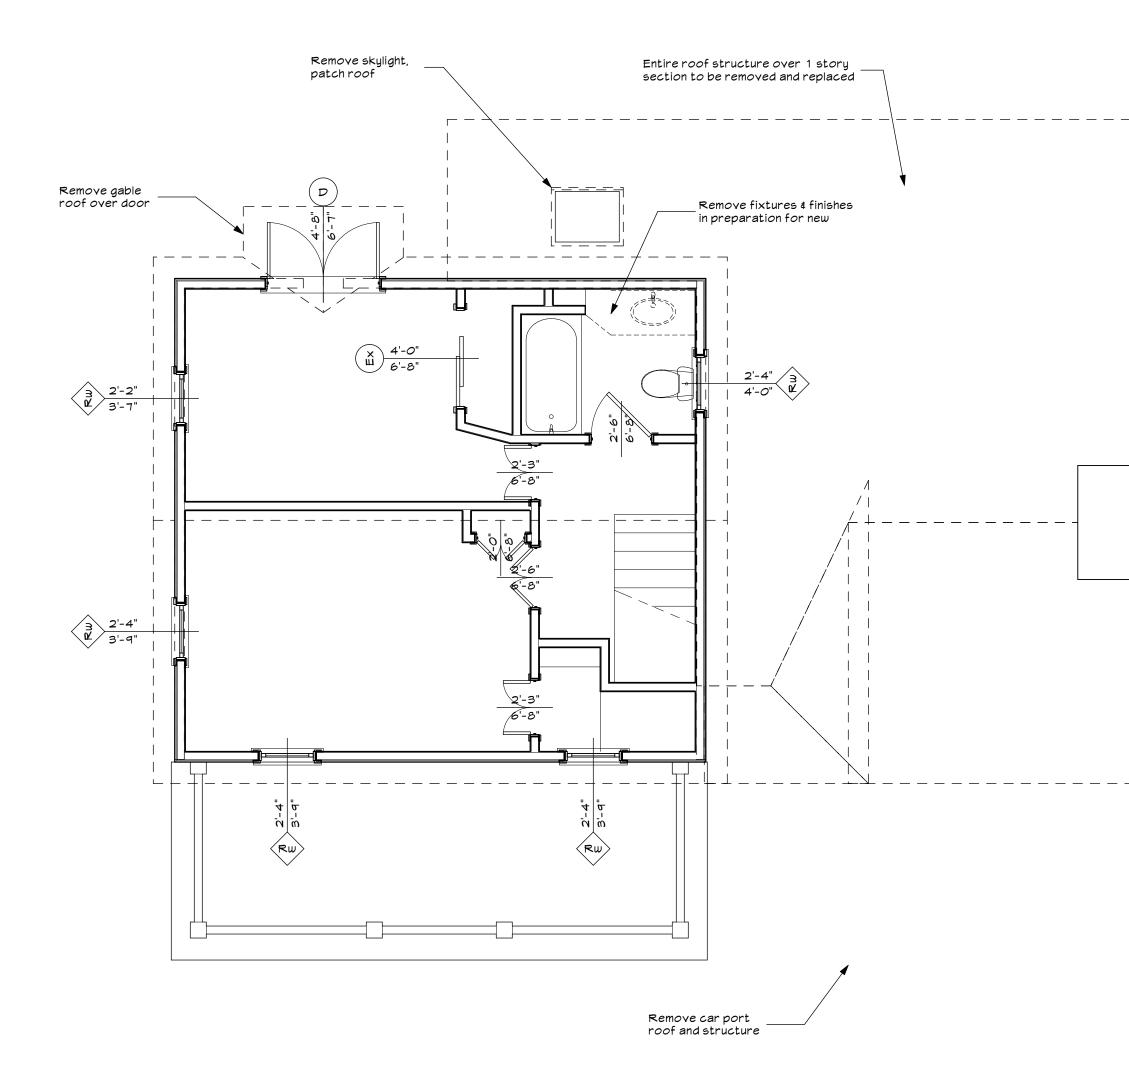




Mindow/Door schedule Replacement window (Rw) within existing window frame or door unit (Rd) within existing door rough


Replacement style window or door in new trimmed


Fastener Notes:


[_____]


- All drywall screws used in framing are to be removed and replaced with code compliant fasteners
- All joist hangers to have fasteners installed as per manufacturers specifications and installation notes

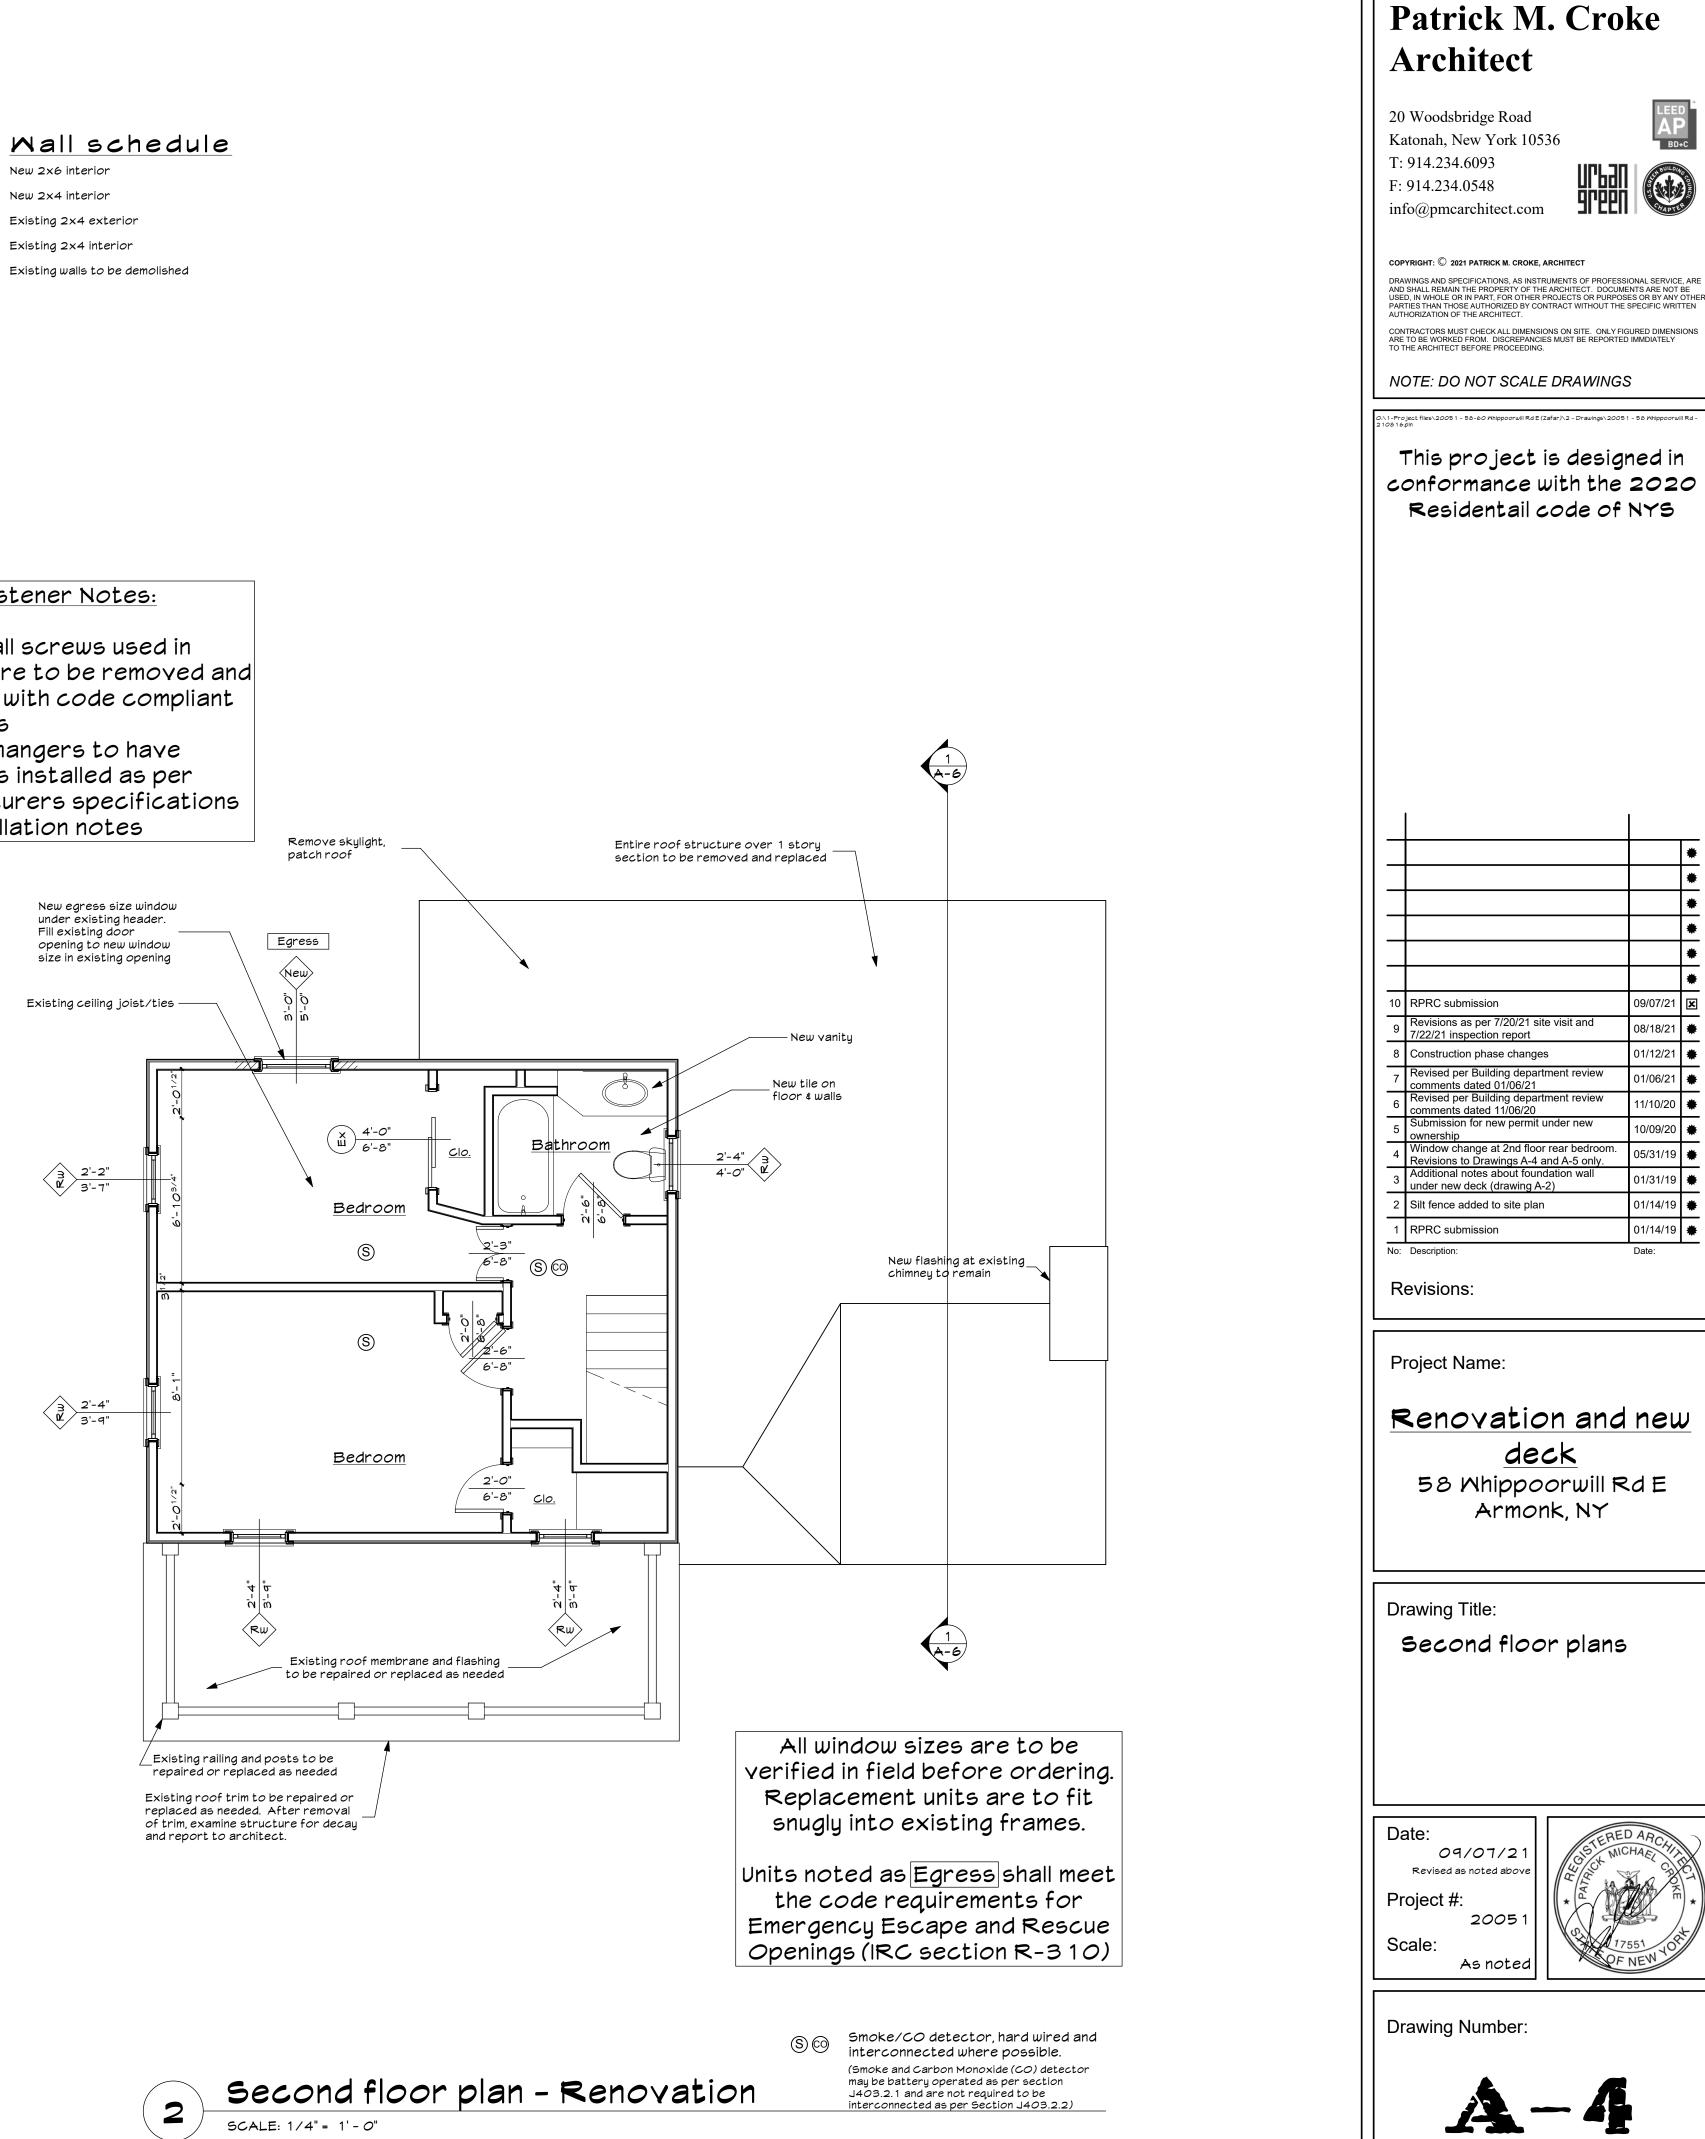


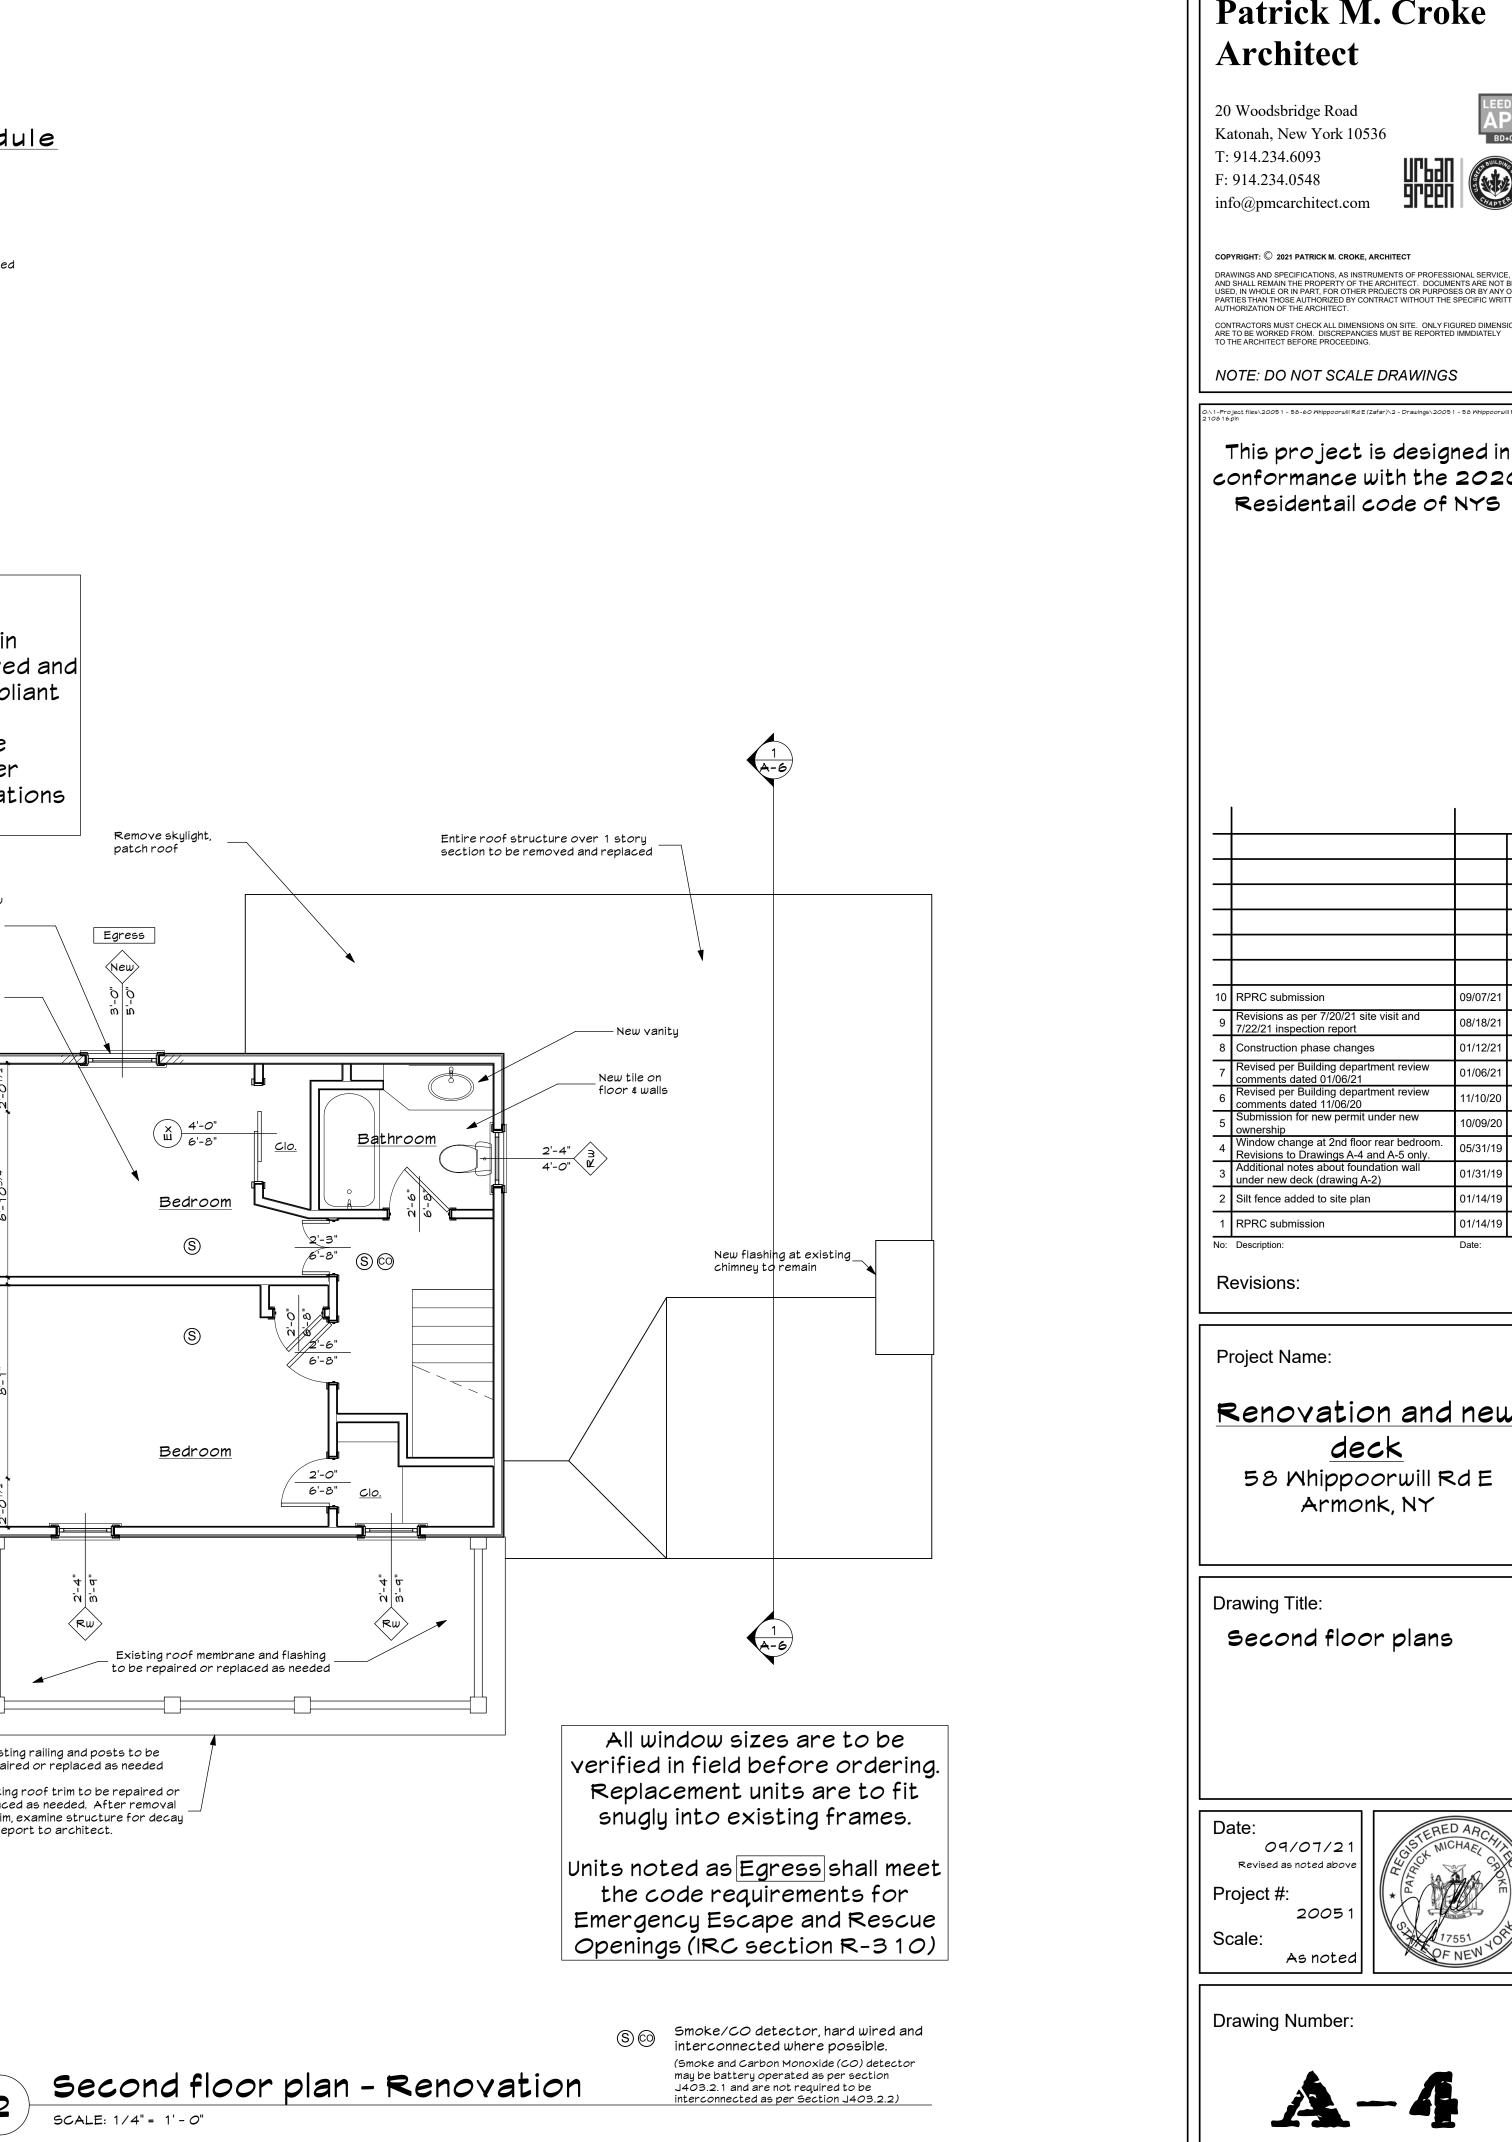


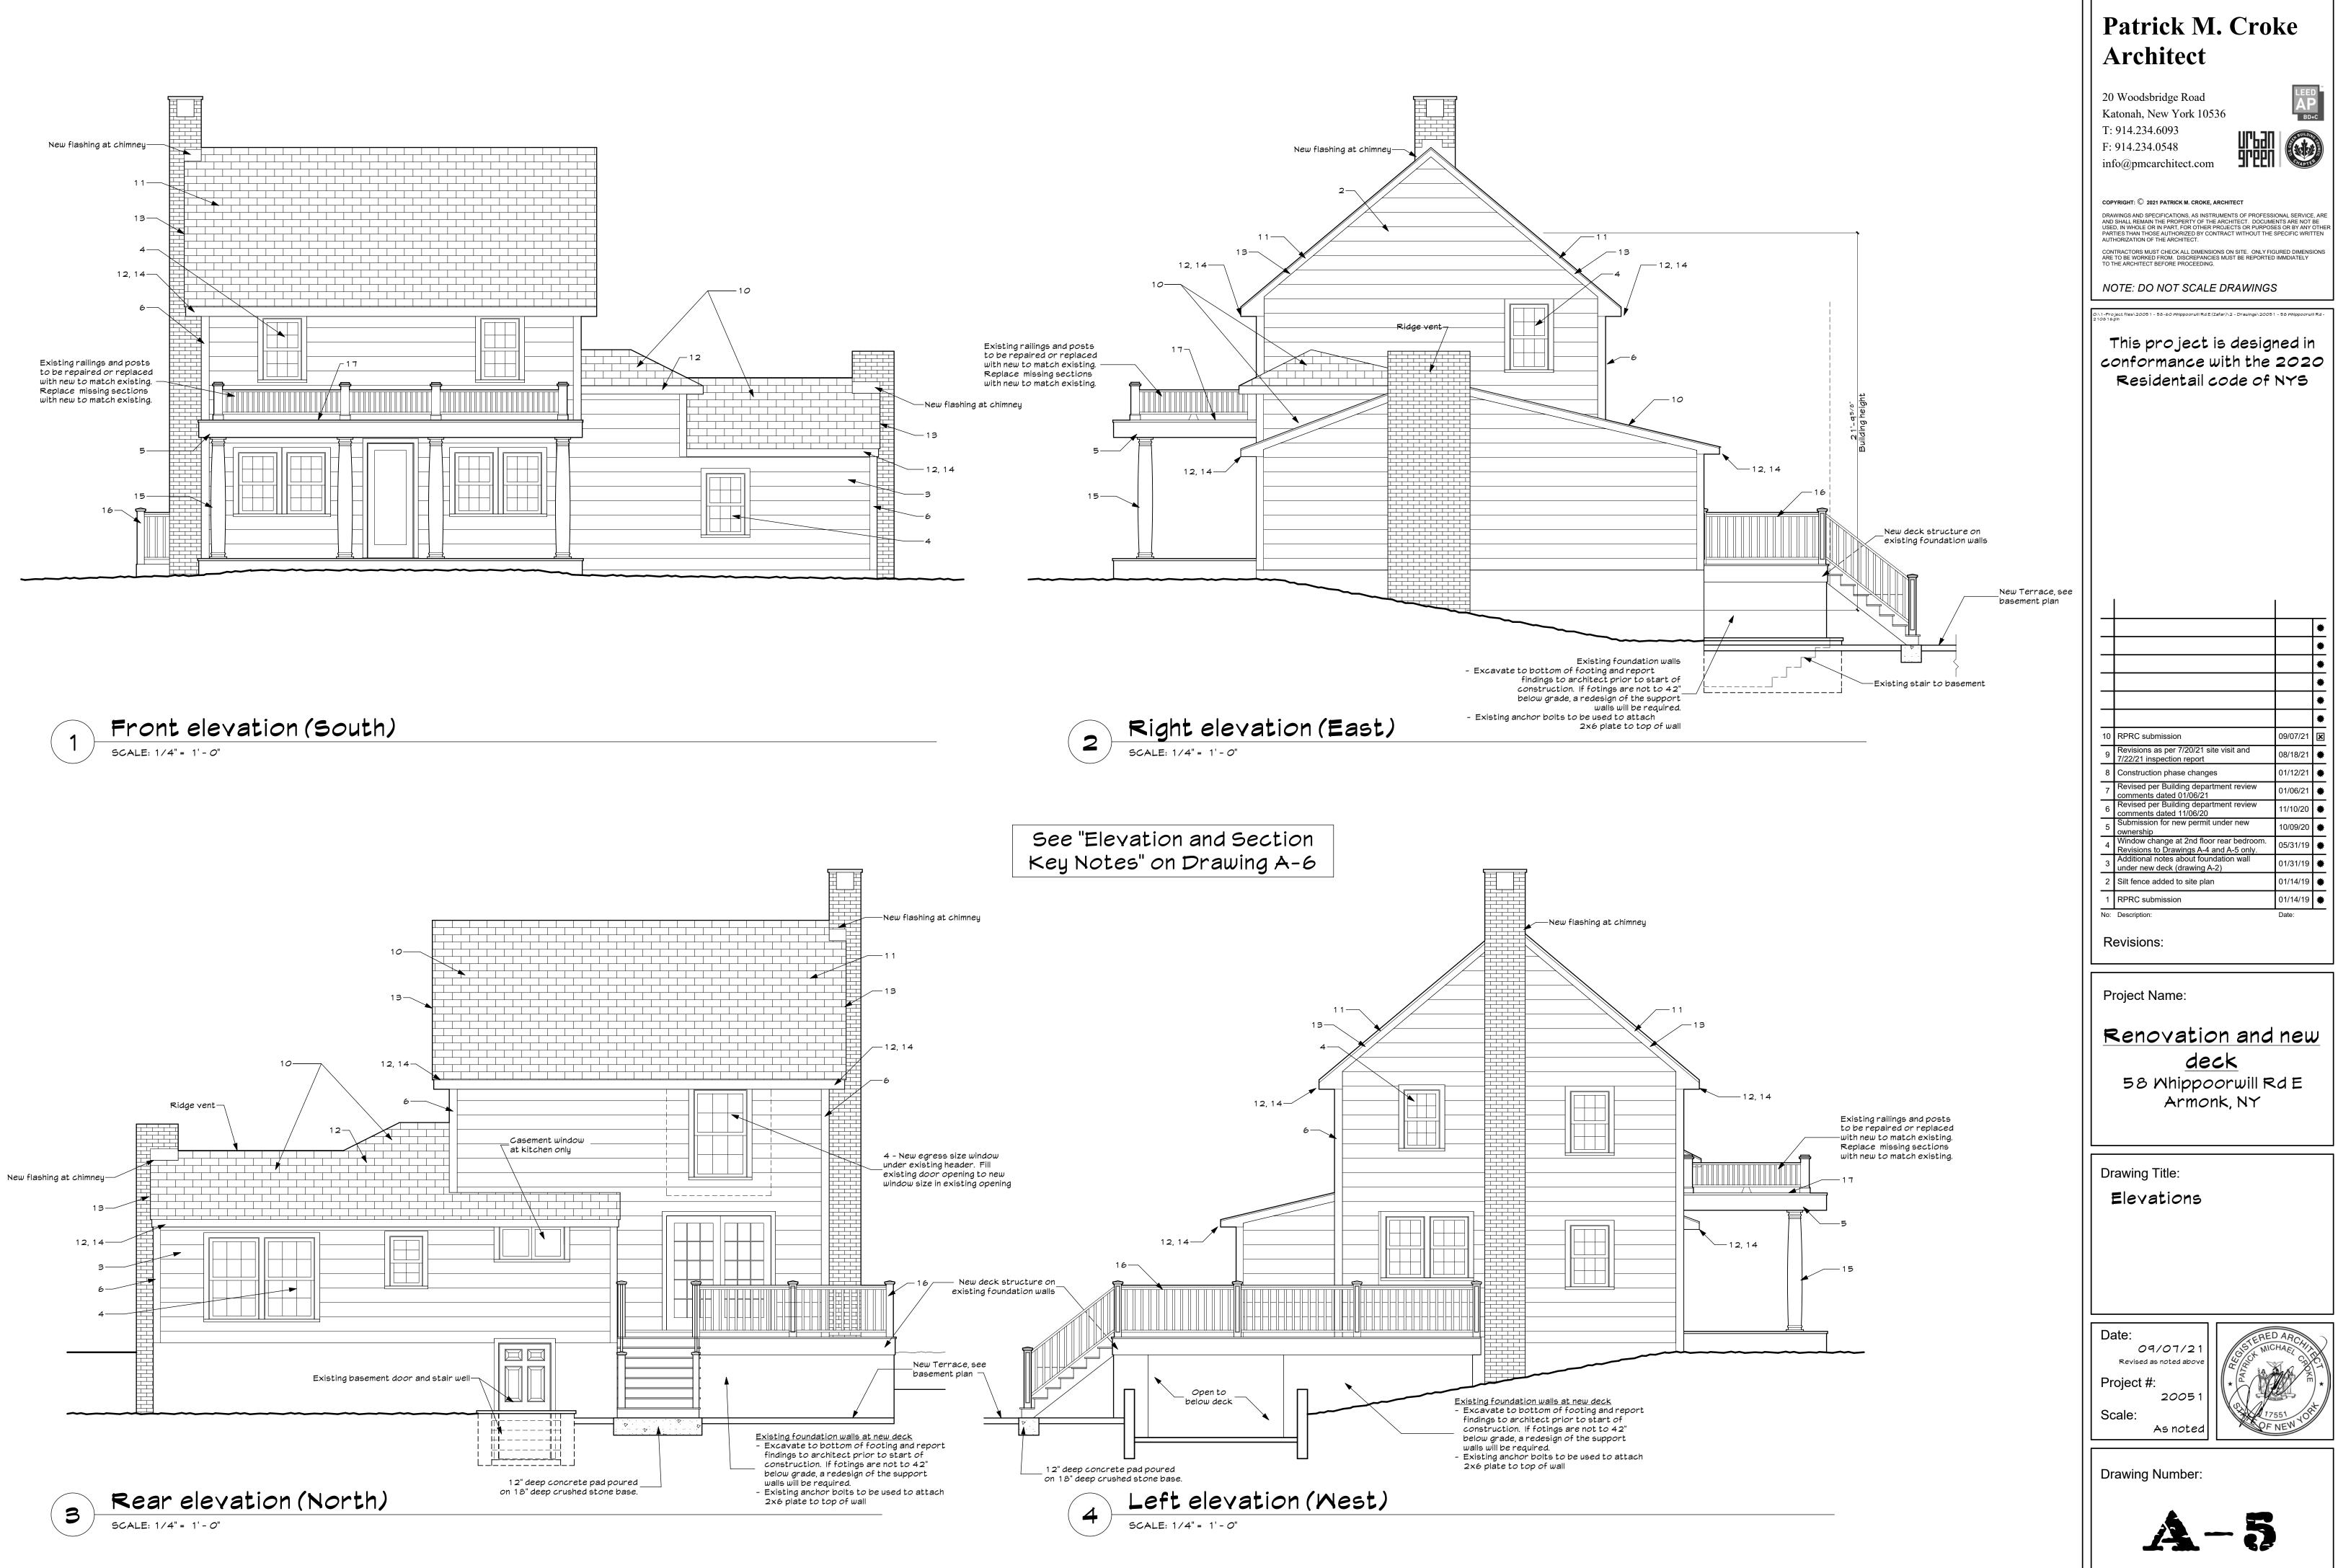

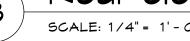

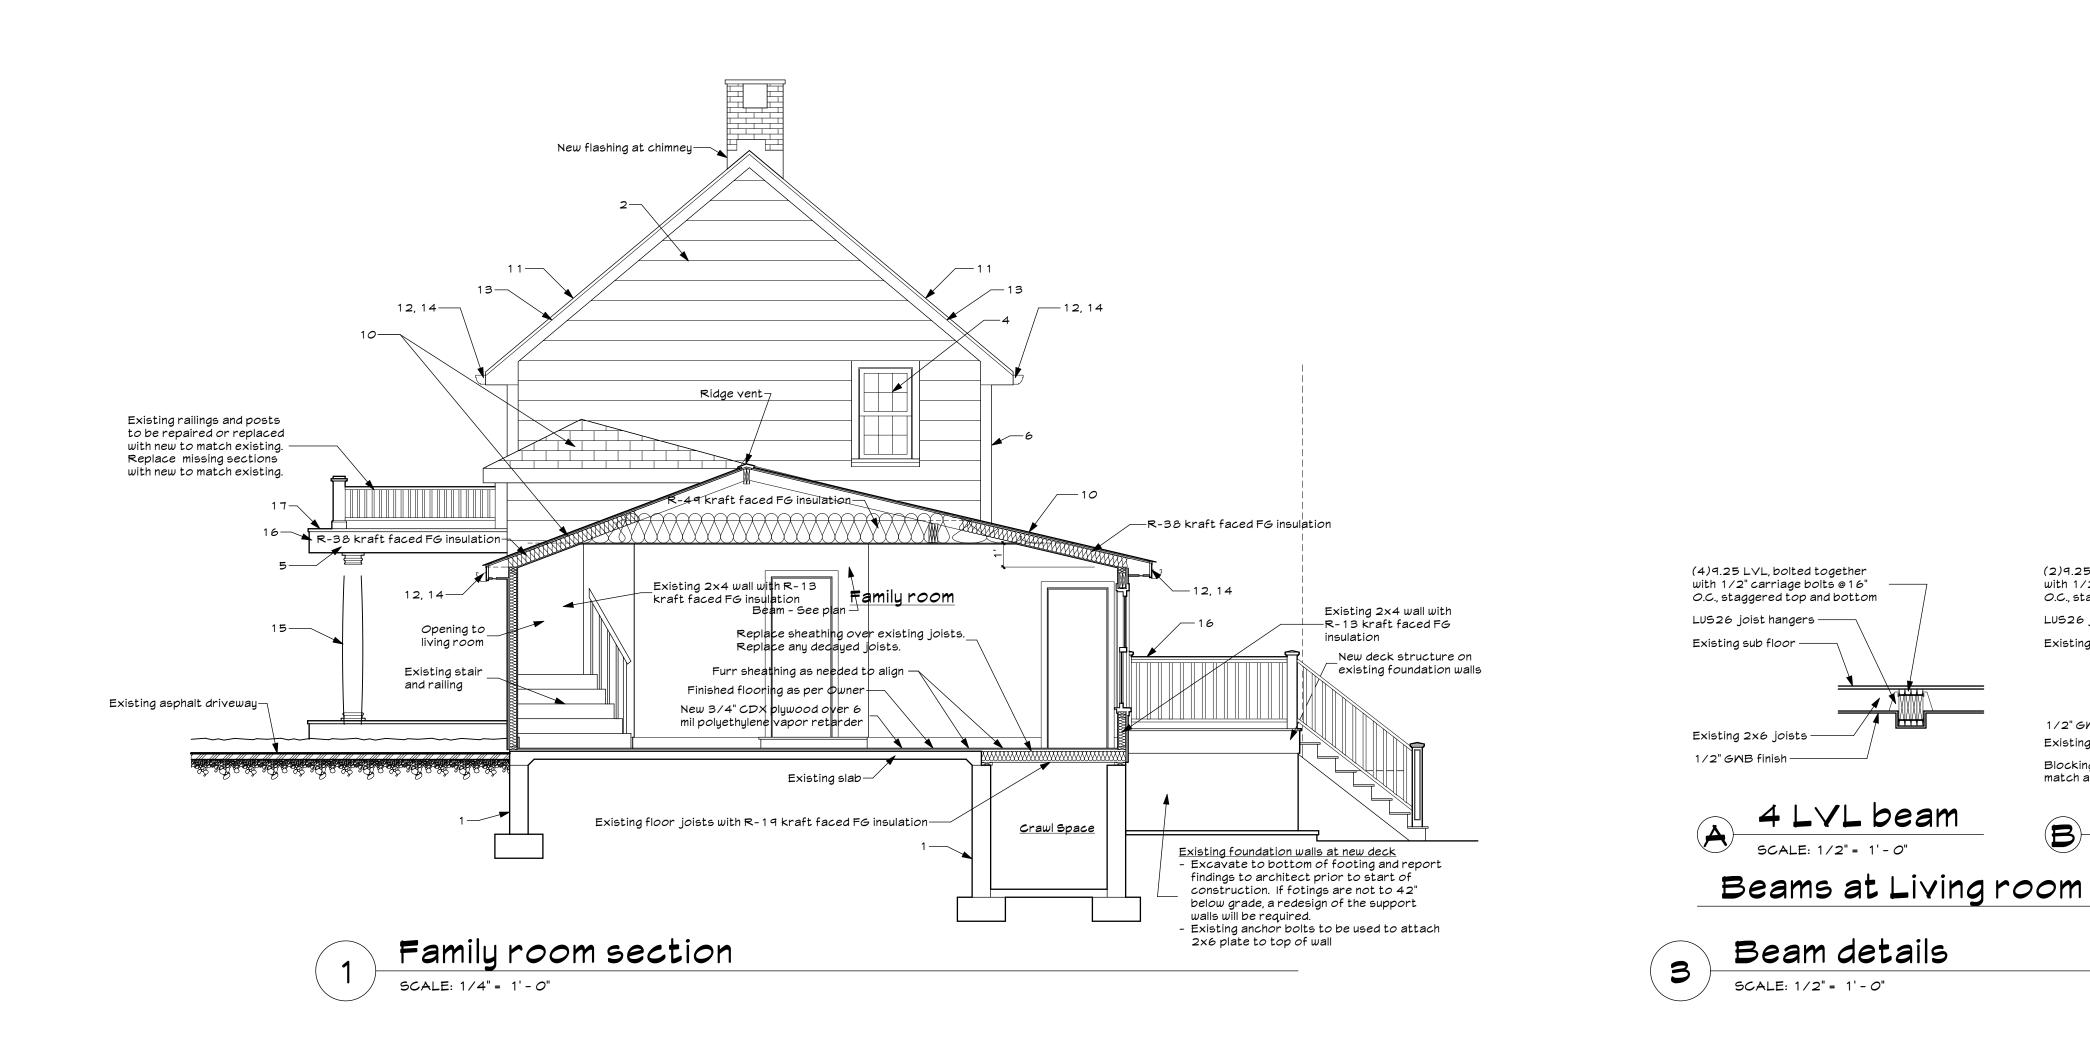

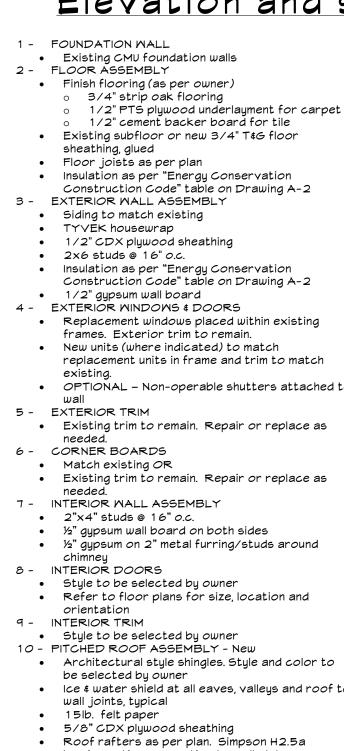

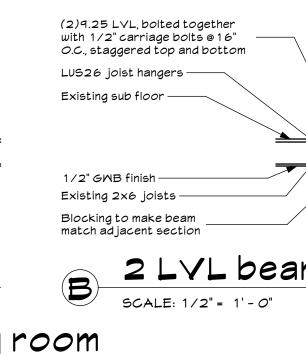

Elevation and section key notes

- Finish flooring (as per owner)
- 3/4" strip oak flooring
- 1/2" PTS plywood underlayment for carpet
 1/2" cement backer board for tile
- Existing subfloor or new 3/4" T&G floor sheathing, glued
- Floor joists as per plan Insulation as per "Energy Conservation
- Construction Code" table on Drawing A-2 3 - EXTERIOR WALL ASSEMBLY
- Siding to match existing
- TYVEK housewrap
- 2x6 studs @ 16" o.c.
- Insulation as per "Energy Conservation Construction Code" table on Drawing A-2
- 4 EXTERIOR WINDOWS & DOORS
- Replacement windows placed within existing frames. Exterior trim to remain.
- New units (where indicated) to match replacement units in frame and trim to match
- OPTIONAL Non-operable shutters attached to
- Existing trim to remain. Repair or replace as
- Existing trim to remain. Repair or replace as
- needed. 7 INTERIOR WALL ASSEMBLY
- ½" gypsum wall board on both sides • 1/2" gypsum on 2" metal furring/studs around
- Style to be selected by owner Refer to floor plans for size, location and
- 10 PITCHED ROOF ASSEMBLY New
- be selected by owner Ice & water shield at all eaves, valleys and roof to
- wall joints, typical
- 5/8" CDX plywood sheathing • Roof rafters as per plan. Simpson H2.5a
- hurricane ties connection to wall plate.
- Ceiling joists- as per plan Insulation as per "Energy Conservation
- Construction Code" table on Drawing A-2
- Plastic vent channels at cathedral ceilings and at eaves
- Continuous ridge vent where there are no existing gable vents

- 11 PITCHED ROOF ASSEMBLY Existing • Architectural style shingles. Style and color to be selected by owner • Ice & water shield at all eaves, valleys and roof to
- wall joints, typical • 15lb. felt paper • Replace sheathing where needed. Sheathing to
- be 5/8" CDX plywood sheathing as a minimum Continuous ridge vent where there are no existing gable vents
- 12 EAVE ASSEMBLY • Existing trim to remain. Repair or replace as
- needed. New construction to match existing Continuous alum vent at all new soffits, white
- 13 RAKE ASSMEBLY • Existing trim to remain. Repair or replace as
- needed. 14 - ROOF WATER DRAINAGE
- Seamless white aluminum gutters and leaders (not shown on plans and elevations) • Drain into boot and solid PVC pipe separate from footing drains, run to daylight
- 15 EXTERIOR COLUMNS • Existing columns to remain. Repair as needed.
- If columns are not repairable, replace with new to match existing. 16 - EXTERIOR RAILINGS - NEW
- Pressure treated material U.O.N., select material for best appearance and quality sand completely prior to paint/stain
- 2x4 top and bottom rail • 2x2 spindles @ 5" o.c. max.
- 2x6 top cap, route decorative detail at top edges with pitch for water runoff. Top of cap at 36" above deck.
- 4x4 posts @ 8' o.c. max., bolted to deck structure
- 17 FLAT ROOF ASSEMBLY Over existing structure
- Modified bituminous roofing system over base sheet • Flashing over cant strip - up abutting wall 12"
- minimum and 36" min. below shingles on abutting pitched roofs. • Flashing 12" min. up railing posts.
- White aluminum drip edge over 1x3 edge moulding over existing fascia

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1-Project files\2005 1 - 58-60 Mhippoorwill Rd E (Zafar)\2 - Drawings\2005 1 - 58 Mhippoorwill Rd 18 16ph

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10	RPRC submission	09/07/21	1
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No:	Description:	Date:	

Revisions:

Project Name:

Renovation and new deck

58 Mhippoorwill Rd E Armonk, NY

Drawing Title: Sections and details

Date: 09/07/21 Revised as noted abov Project # 2005 Scale: As noted



Drawing Number:



\backslash	(3)9.5 LVL, bolted together with 1/2" carriage bolts @ 16" O.C., staggered top and bottom
	LUS26 joist hangers
	Existing sub floor
	1/2" GMB finish —
	Existing 2x6 joists —
	Ceiling joists over sink area———
m	3 LVL beam
	SCALE: 1/2" = 1'-0"

2nd floor bearing wall —

Beams at Kitchen