

Transmittal

To:	Town of North Castle	Date:	01/18/2022
10.	TOWN OF WORLD GUODE	Date.	01/10/2022
Attn:	Planning Department	From:	Yosef Melamed, R.A.
,	a		
Subject:	Residential Project Review Committee	Project:	# Byram Ridge Road
	Submission		Armonk, NY 10504
	000111001011	l	,

Subject:	Residential Pro Submission	oject Review Committee	Project:	# Byram Ridge Road Armonk, NY 10504
These are s	submitted digitally	via email to the Planning Dep	partment:	
⊠ RPRC	Application	□ RPRC Completeness Review Form		ectural Plans & Elevations
□ Land Coverage & Floor Area Calculation Worksheets		⊠ Survey	⊠ Wetland & Soil Survey & Rep	
All fees are	mailed to the Tov	vn Hall:		
	ation Fee Check			

Please return any comments or questions to Melamed Architect

Phone: 917 -658-7236 or 631-935-3446

Emails: yosef@melamedarchitect.com, amy@melamedarchitect.com

Thank You



TOWN OF NORTH CASTLE

WESTCHESTER COUNTY 17 Bedford Road Armonk, New York 10504-1898

RESIDENTIAL PROJECT REVIEW COMMITTEE Adam R. Kaufman AICP, Chair Telephone: (914) 273-3000 x 43 Fax: (914) 273-3554 www.nortcastleny.com

RESIDENTIAL PROJECT REVIEW COMMITTEE (RPRC) APPLICATION

Section I- PROJECT

ADDRESS: no legal address assigned. adjacent to 88 Byram Ridge Road, Armonk NY 10504

Section III- DESCRIPTION OF WORK:

New construction single-family residence on vacant 1.003 acre lot with a wetland & large pond to the rear of the property. New 2-story house to include basement, 3-car garage, double-height living room & large bedrooms with private bathrooms. Exterior work to include new rear deck with swimming pool, accessory cabana structure, new driveway with one curb cut, and a covered entrance. The house massing size & shape maximizes the South-facing solar orientation, creates ample views toward the pond, & matches the surrounding neighborhood context.

Section III- CONTACT INFORMATION:

APPLICANT:APPLICANT:
ADDRESS: 153 W 27th St, Suite 303. New York, NY 10001
amy@melamedarchitect.com
PROPERTY OWNER: Daniel Simchi
ADDRESS: 135 Woodland Street Tenafly, NJ 07670
PHONE: 917-999-8177 MOBILE: EMAIL: daniel@ml1.capital
PROFESSIONAL: Yosef Melamed, Registered Architect
ADDRESS: 153 W 27th St, Suite 303. New York, NY 10001
PHONE: 212-203-5053 MOBILE: 917-658-7236
EMAIL: yosef@melamedarchitect.com & amy@melamedarchitect.com
Section IV- PROPERTY INFORMATION:
Zone: R-1A Tax ID (lot designation)101.01-2-65



Town of North Castle Residential Project Review Committee

17 Bedford Road Armonk, New York 10504 (914) 273-3542 (914) 273-3554 (fax)

RPRC COMPLETENESS REVIEW FORM

This form represents the standard requirements for a completeness review for all Residential Project Review Committee submissions. Failure to provide all of the information requested will result in a determination that the application is incomplete.

Project Name on Plan:						
☐Initial Submittal ☐Revised Preliminary						
Street Location:						
Zoning District: Property Acreage: Tax Map Parcel ID:						
Date:						
DEP	ARTMENTAL USE ONLY					
Date	Filed: Staff Name:					
Items	minary Plan Completeness Review Checklist marked with a "\sum" are complete, items left blank "\sum" are incomplete and must be leted, "NA" means not applicable.					
□1.	Plan prepared by a registered architect or professional engineer					
<u>□</u> 2.	Aerial photo (Google Earth) showing the applicant's entire property and adjacent properties and streets					
□3.	Map showing the applicant's entire property and adjacent properties and streets					
□ 4.	A locator map at a convenient scale					
□5.	The proposed location, use and design of all buildings and structures					
□6.	Existing topography and proposed grade elevations					
□7.	Location of drives					
□8.	Location of all existing and proposed site improvements, including drains, culverts, retaining walls and fences					

RPRC COMPLETENESS REVIEW FORM

Page 2

☐9. Description of method of water supply and sewage disposal and location of such facilities
☐10. The name and address of the applicant, property owner(s) if other than the applicant and of the planner, engineer, architect, surveyor and/or other professionals engaged to work
☐11. Submission of a Zoning Conformance Table depicting the plan's compliance with the minimum requirements of the Zoning District
☐12. If a tree removal permit is being sought, submission of a plan depicting the location and graphical removal status of all Town-regulated trees within the proposed area of disturbance. In addition, the tree plan shall be accompanied by a tree inventory includes a unique ID number, the species, size, health condition and removal status of each tree.
☐13. If a wetlands permit is being sought, identification of the wetland and the 100-foot wetland buffer.
More information about the items required herein can be obtained from the North Castle Planning Department. A copy of the Town Code can be obtained from Town Clerk or on the North Castle homepage: http://www.northcastleny.com/townhall.html
On this date, all items necessary for a technical review of the proposed site plan have been submitted and constitute a COMPLETE APPLICATION.

Byram Ridge Road Armonk, NY 10504

Residential Project Review Committee Submission





Yossi Melamed, RA AIA
Melamed Architect, P.C.
153 West 27th Street, Suite 303
New York, NY 10001
Tel: 212-203-5053
Tel: 212-749-5050
info@melamedarchitect.com
www.melamedarchitect.com




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ARCHITECTURAL DRAWING LIST

A-000	COVER SHEET
A-001	BUILDING INFORMATION & ZONING ANALYSIS
A-002	ARCHITECTURAL SITE PLAN
A-003	LAND COVERAGE & FLOOR AREA CALCULATION WORKSHEETS
A-100	PROPOSED BASEMENT PLAN
A-101	PROPOSED FIRST FLOOR PLAN
A-102	PROPOSED SECOND FLOOR PLAN
A-200	PROPOSED FRONT & REAR ELEVATIONS
A-201	PROPOSED SIDE ELEVATIONS



SCOPE OF WORK:

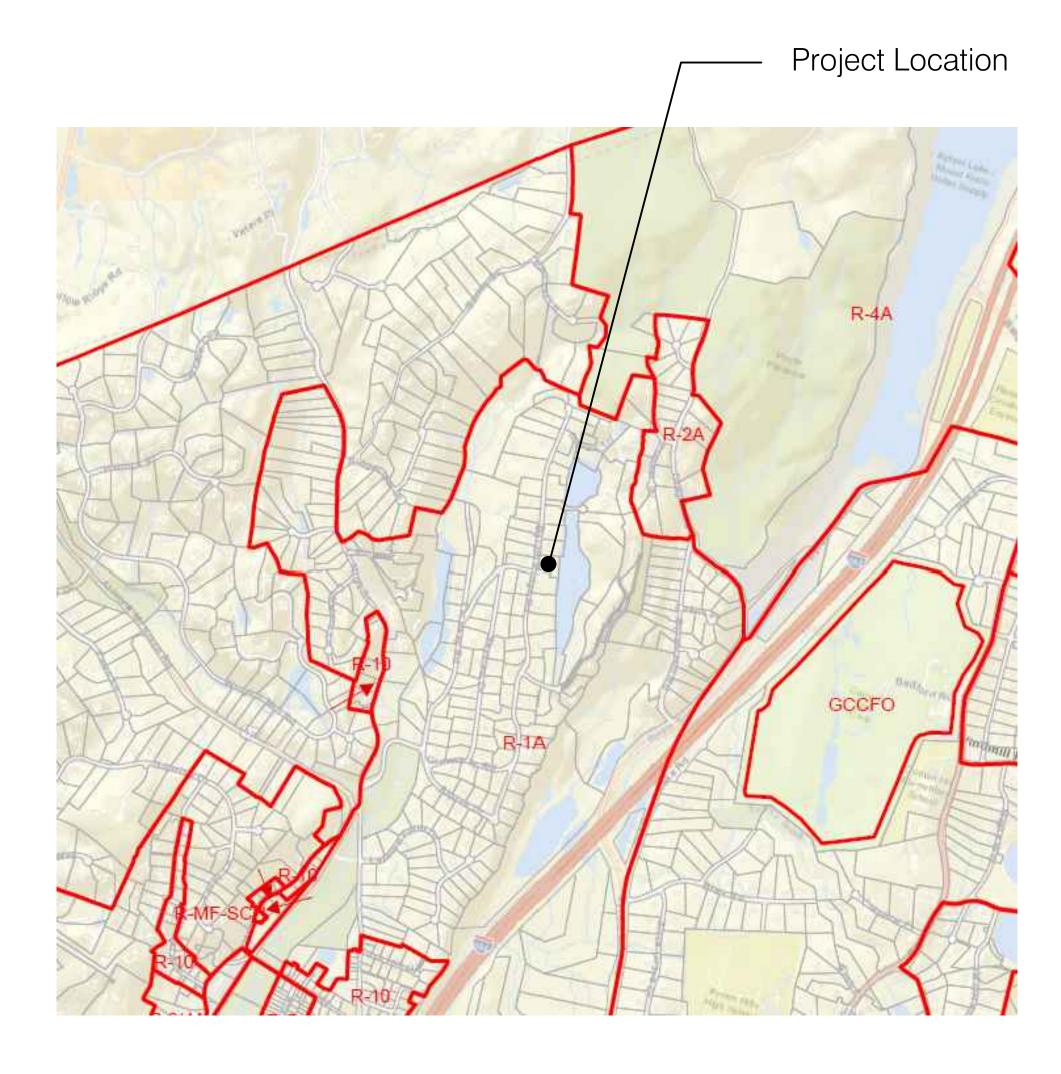NEW CONSTRUCTION TWO-STORY SINGLE FAMILY RESIDENCE W/ BASEMENT.
NEW CABANA ACCESSORY STRUCTURE.
EXTERIOR WORK INCLUDING NEW DRIVEWAY, SWIMMING POOL & REAR DECK.
FULL INTERIOR DESIGN & CONSTRUCTION.
PLUMBING, MECHANICAL, SPRINKLER, & STRUCTURAL DESIGN & CALCULATIONS

CODE COMPLIANCE


TO BE DONE BY LICENSED ENGINEERS.


ALL WORK SHALL BE INSTALLED IN ACCORDANCE WITH RULES AND REGULATIONS OF THE 2020 RESIDENTIAL CODE OF NEW YORK STATE, 2018 INTERNATIONAL BUILDING CODE, 2020 INTERNATIONAL PLUMBING CODE, BASE BUILDING STANDARDS AND ALL OTHER AUTHORITIES HAVING JURISDICTION.


		ZONING ANA	I VSIS		
		ZOMING AMA	<u>KL I OIO</u>		
ADDRESS:	# BYRAM RIDGE ROAD, A	RMONK NY 10504			
ZONING DISTRICT:	R-1A				
SECTION:	101.01				
BLOCK:	2				
LOT:	65				
LOT AREA:	43,699.06 S	F (1.003 ACRE)			
FLOOD ZONE:	ADJACENT TO ZONE A				
GROSS LAND COVERAGE	MAX ALLOWED		PROPOSED		
LAND COVERAGE AREA (SF)	9,960		7,615		COMPLIED
BUILDING COVERAGE	MAX ALLOWED			PROPOSED	
MAX BUILDING COVERAGE ALLOWED	12%	5,243.89	SF (43,699.06 X 12%)		
PROPOSED BUILDING COVERAGE			SF (3202 / 43,699.06)	7.3%	COMPLIED
GROSS FLOOR AREA	MAX ALLOWED		PROPOSED		
FLOOR AREA (SF)	7,727		5,980		
					COMPLIED
MIN. LOT AREA & LOT WIDTH:	MIN REQ'D		PROPOSED		
LOT AREA (SF)	1 ACRE		1.003 ACRE		COMPLIED
LOT FRONTAGE (LF)	125'		170'		COMPLIED
LOT WIDTH (LF)	125'		134'	(AT NARROWEST)	COMPLIED
LOT DEPTH (LF)	150'		235'		COMPLIED
YARD REGULATION:	REQUIRED		PROPOSED		
FRONT YARD	50'		112'-10"		COMPLIED
SIDE YARD	25'		26'-6" & 33'-11"		COMPLIED
REAR YARD	40'		69'-2"		COMPLIED
HEIGHT & SETBACK REGULATION:	REQUIRED		PROPOSED		
MAX. BUILDING HEIGHT:	36'		36'	TO MAX ROOF HEIGHT	COMPLIED





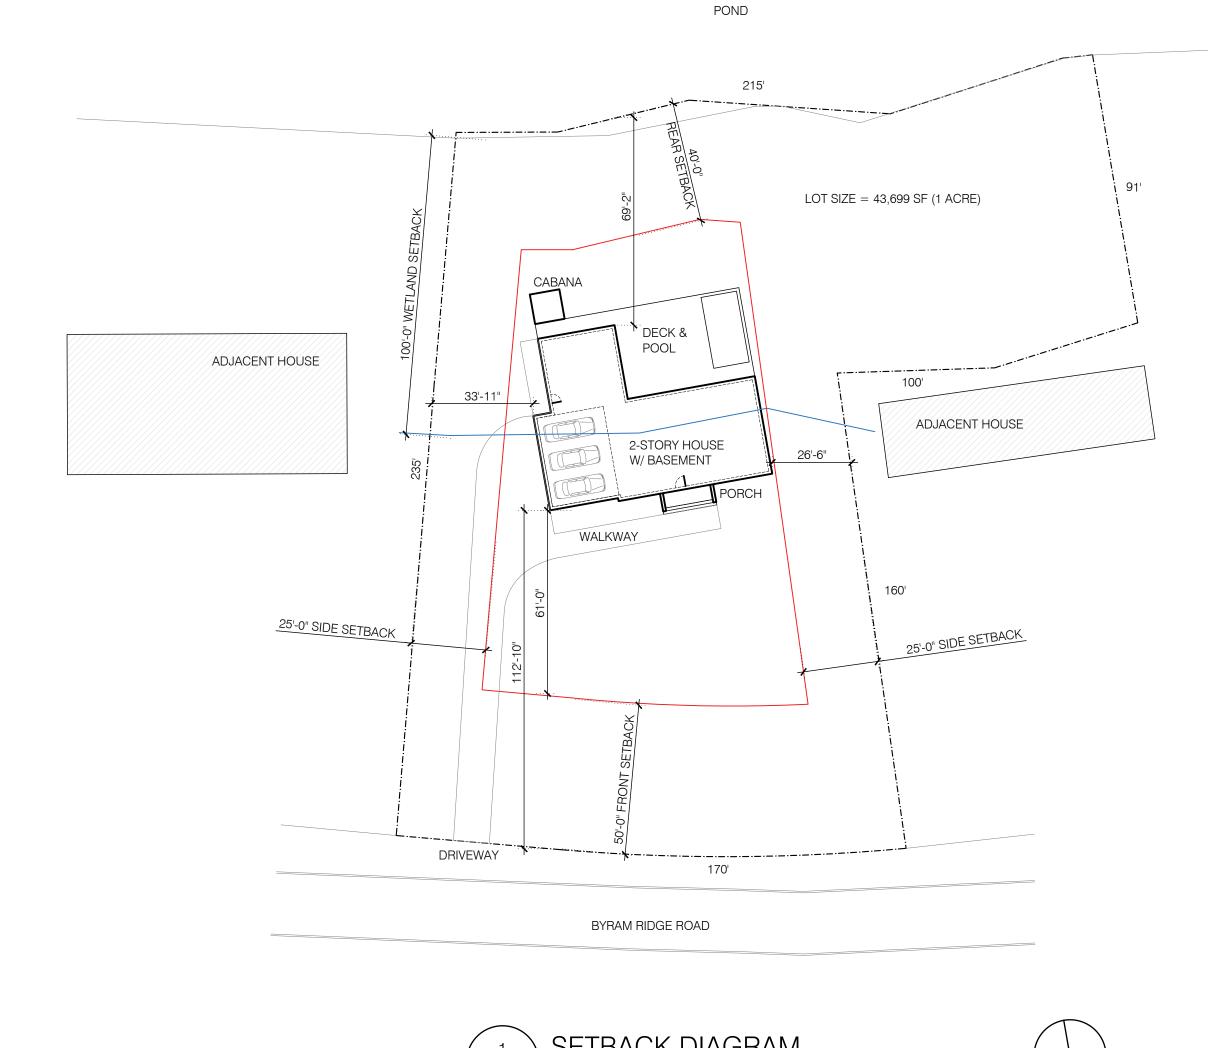

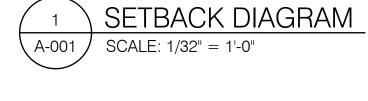

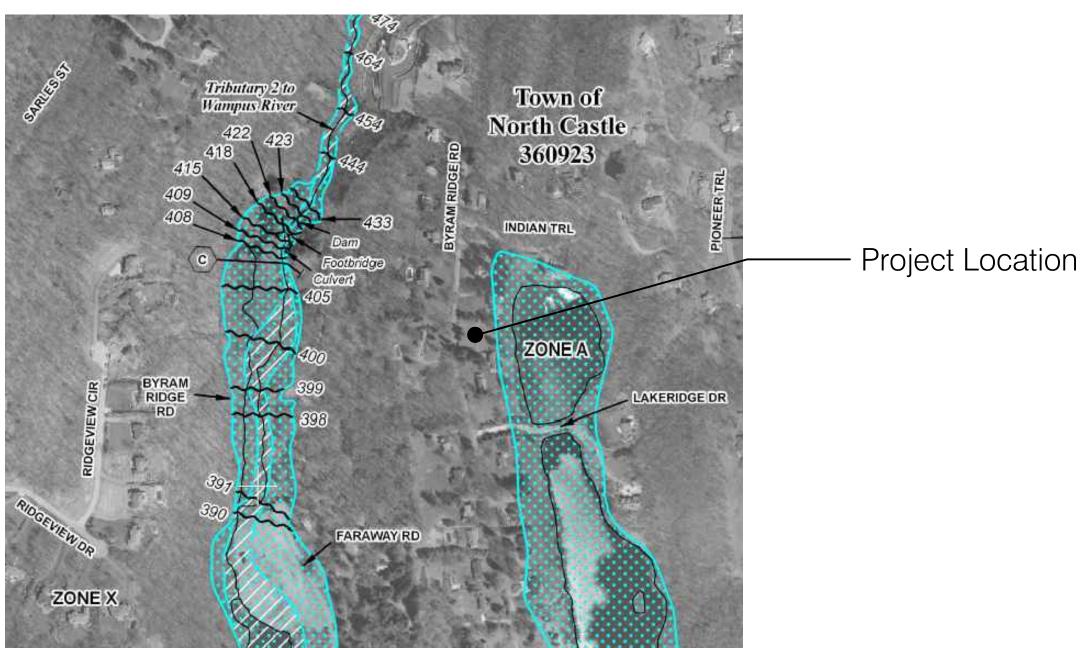


FEMA: 2007 MAP # 36119C0164F

Yossi Melamed, AIA
153 West 27th Street, Suite 303
New York, NY 10001
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info@melamedarchitect.com
www.melamedarchitect.com



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01.18.22	1	RPRC SUBMISSION		\geq			
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Byram Ridge Road Armonk, NY 10504

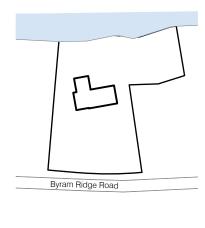

NOTICE


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DRAWING TITLE:

BUILDING INFORMATION & ZONING ANALYSIS

DRAWING NUMBER:

A-001

DATE:	SCALE:
2022	AS NOTE

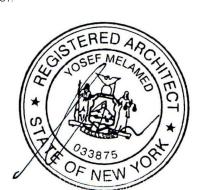
Melamed Architect PC

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DRAWING TITLE:

ARCHITECTURAL SITE PLAN

DRAWING NUMBER:

SCALE: 2022 AS NOTED

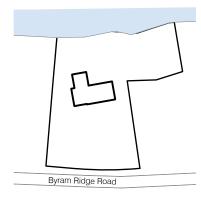


TOWN OF NORTH CASTLE WESTCHESTER COUNTY 17 Bedford Road Armonk, New York 10504-1898

PLANNING DEPARTMENT Adam R. Kaufman, AICP Director of Planning

Telephone: (914) 273-3542 Fax: (914) 273-3554 www.northcastleny.com

GROSS LAND COVERAGE CALCULATIONS WORKSHEET

BYRAM RIDGE ROAD Date: 01.18.22 Application Name or Identifying Title: Tax Map Designation or Proposed Lot No.: Gross Lot Coverage 43,699.06 SF = 1.003 ACRE Total lot Area (Net Lot Area for Lots Created After 12/13/06): 9,350 SF Maximum permitted gross land coverage (per Section 355-26.C(1)(b)): **BONUS** maximum gross land cover (per Section 355-26.C(1)(b)): Distance principal home is beyond minimum front yard setback x 10 = 610 SF 9,960 SF **TOTAL Maximum Permitted gross land coverage** = Sum of lines 2 and 3 Amount of lot area covered by **principal building:** 3,102 SF 0 existing +3,102 SF proposed = 6. Amount of lot area covered by **accessory buildings:** 0 existing + 100 SF proposed = 7. Amount of lot area covered by **decks**: 1,132 SF $0 \qquad \text{existing} + 1,132 \text{ SF proposed} =$ 8. Amount of lot area covered by **porches:** 126 SF $\underline{}$ existing + $\underline{126 \ SF}$ proposed = Amount of lot area covered by driveway, parking areas and walkways: 2,695 SF 0 existing + 2,695 SF proposed = Amount of lot area covered by terraces: 0 existing + 0 proposed = 11. Amount of lot area covered by tennis court, pool and mechanical equip: 0 existing + 460 SF proposed = 12. Amount of lot area covered by all other structures: _____ existing + ____ proposed = 7,615 SF

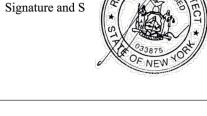

does not comply with the Town's regulations.

13. Proposed **gross land coverage:** Total of Lines 5 - 12 =

ing Worksheet


If Line 13 is less than or equal to Line 4, your proposal complies with the Town's maximum gross land coverage regulations and the project may proceed to the Residential Project Review Committee for review. If Line 13 is greater than Line 4 your proposal

01.18.22

SUMMARY TABLE

ACCESSORY = DECK = PORCH = DRIVEWAY = POOL/MECH =	100 SF 1,132 SF 126 SF 2,695 SF 460 SF
TOTAL LOT COVERAGE =	7,615 SF
MAX LOT COVERAGE =	9,960 SF
7,615 < 9,960. CO	MPLIES

HOUSE = 3,102 SF

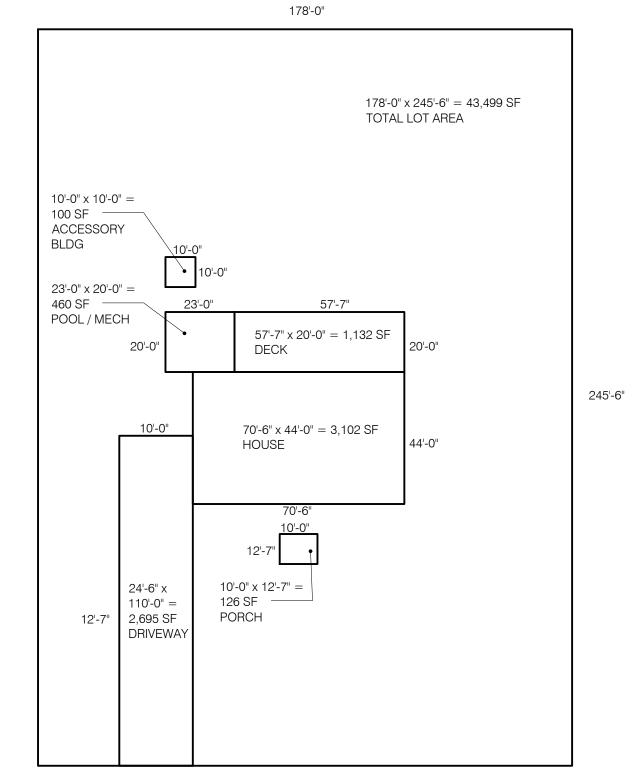





PLANNING DEPARTMENT Adam R. Kaufman, AICP Director of Planning

WESTCHESTER COUNTY 17 Bedford Road Armonk, New York 10504-1898


January 29, 2019 Telephone: (914) 273-3542 Fax: (914) 273-3554 www.northcastleny.com

FLOOR AREA CALCULATIONS WORKSHEET

TOWN OF NORTH CASTLE

Tax Maj	p Designation or Proposed Lot No.:	101.01-2-65	
Floor A	rea		
1.	Total Lot Area (Net Lot Area for L	ots Created After 12/13/06):	43,699.06 SF = 1.003 ACRE
2.	Maximum permitted floor area (pe	,	7,727 SF
3.	Amount of floor area contained wit output existing +2,365 SF		2,365 SF
4. -	Amount of floor area contained wit existing +2,778 SF	hin second floor: _ proposed =	2,778 SF
5. -	Amount of floor area contained wit existing + 738 SF	hin garage: _ proposed =	737 SF
6. –	Amount of floor area contained wit 0 existing $+$ 0	hin porches capable of being enclose_proposed =	ed:
7 . –	Amount of floor area contained wit	hin basement (if applicable – see de _ proposed =	finition): 0
8.	Amount of floor area contained wit	hin attic (if applicable – see definition _ proposed =	on):
9.	Amount of floor area contained wit existing +100 SF	hin all accessory buildings: _ proposed =	100 SF
- 10. Pro	posed floor area: Total of Line	3 - 9 =	5,980 SF
and the p	10 is less than or equal to Line 2, yo project may proceed to the Residential oposal does not comply with the Tow	Project Review Committee for revie	n's maximum floor area regulations w. If Line 10 is greater than Line 2

ing Worksheet

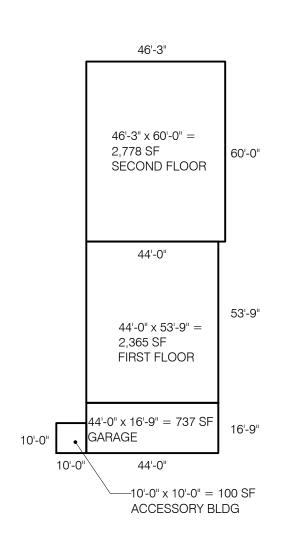

SUMMARY TABLE

FIRST FLOOR = 2,365 SF SECOND FLOOR = 2,778 SF GARAGE = 737 SF ACCESSORY = 100 SF TOTAL FLOOR AREA = 5,980 SF

01.18.22

MAX FLOOR AREA 7,727 SF

5,980 < 7,727. COMPLIES

THE BASEMENT IS EXCLUDED FROM GROSS FLOOR AREA BECAUSE IT IS NOT CONSIDERED A 'STORY' PER ZONING DEFINITION:

- A) THE FINISH SURFACE OF THE FLOOR ABOVE THE BASEMENT IS NOT GREATER THAN SIX
- FEET ABOVE AVERAGE GRADE. B) THE FINISH SURFACE OF THE FLOOR ABOVE THE BASEMENT IS <u>NOT</u> MORE THAN SIX FEET ABOVE THE FINISHED GROUND LEVEL FOR MORE THAN 50% OF THE TOTAL BUILDING
- PERIMETER. C) THE FINISH SURFACE OF THE FLOOR ABOVE THE BASEMENT IS NOT MORE THAN TWELVE FEET ABOVE THE FINISHED GROUND LEVEL AT ANY POINT ALONG THE BUILDING PERIMETER.

THE ATTIC IS EXCLUDED FROM GROSS FLOOR AREA BECAUSE IT HAS A FLOOR TO CEILING HEIGHT OF LESS THAN 7.5 FEET.




Melamed Architect PC

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Byram Ridge Road **Armonk, NY 10504**



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DRAWING TITLE:

LAND COVERAGE & FLOOR AREA CALCULATION WORKSHEETS

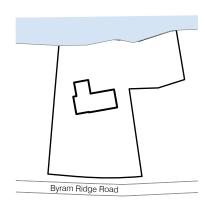DRAWING NUMBER:

DATE: SCALE: 2022 AS NOTED






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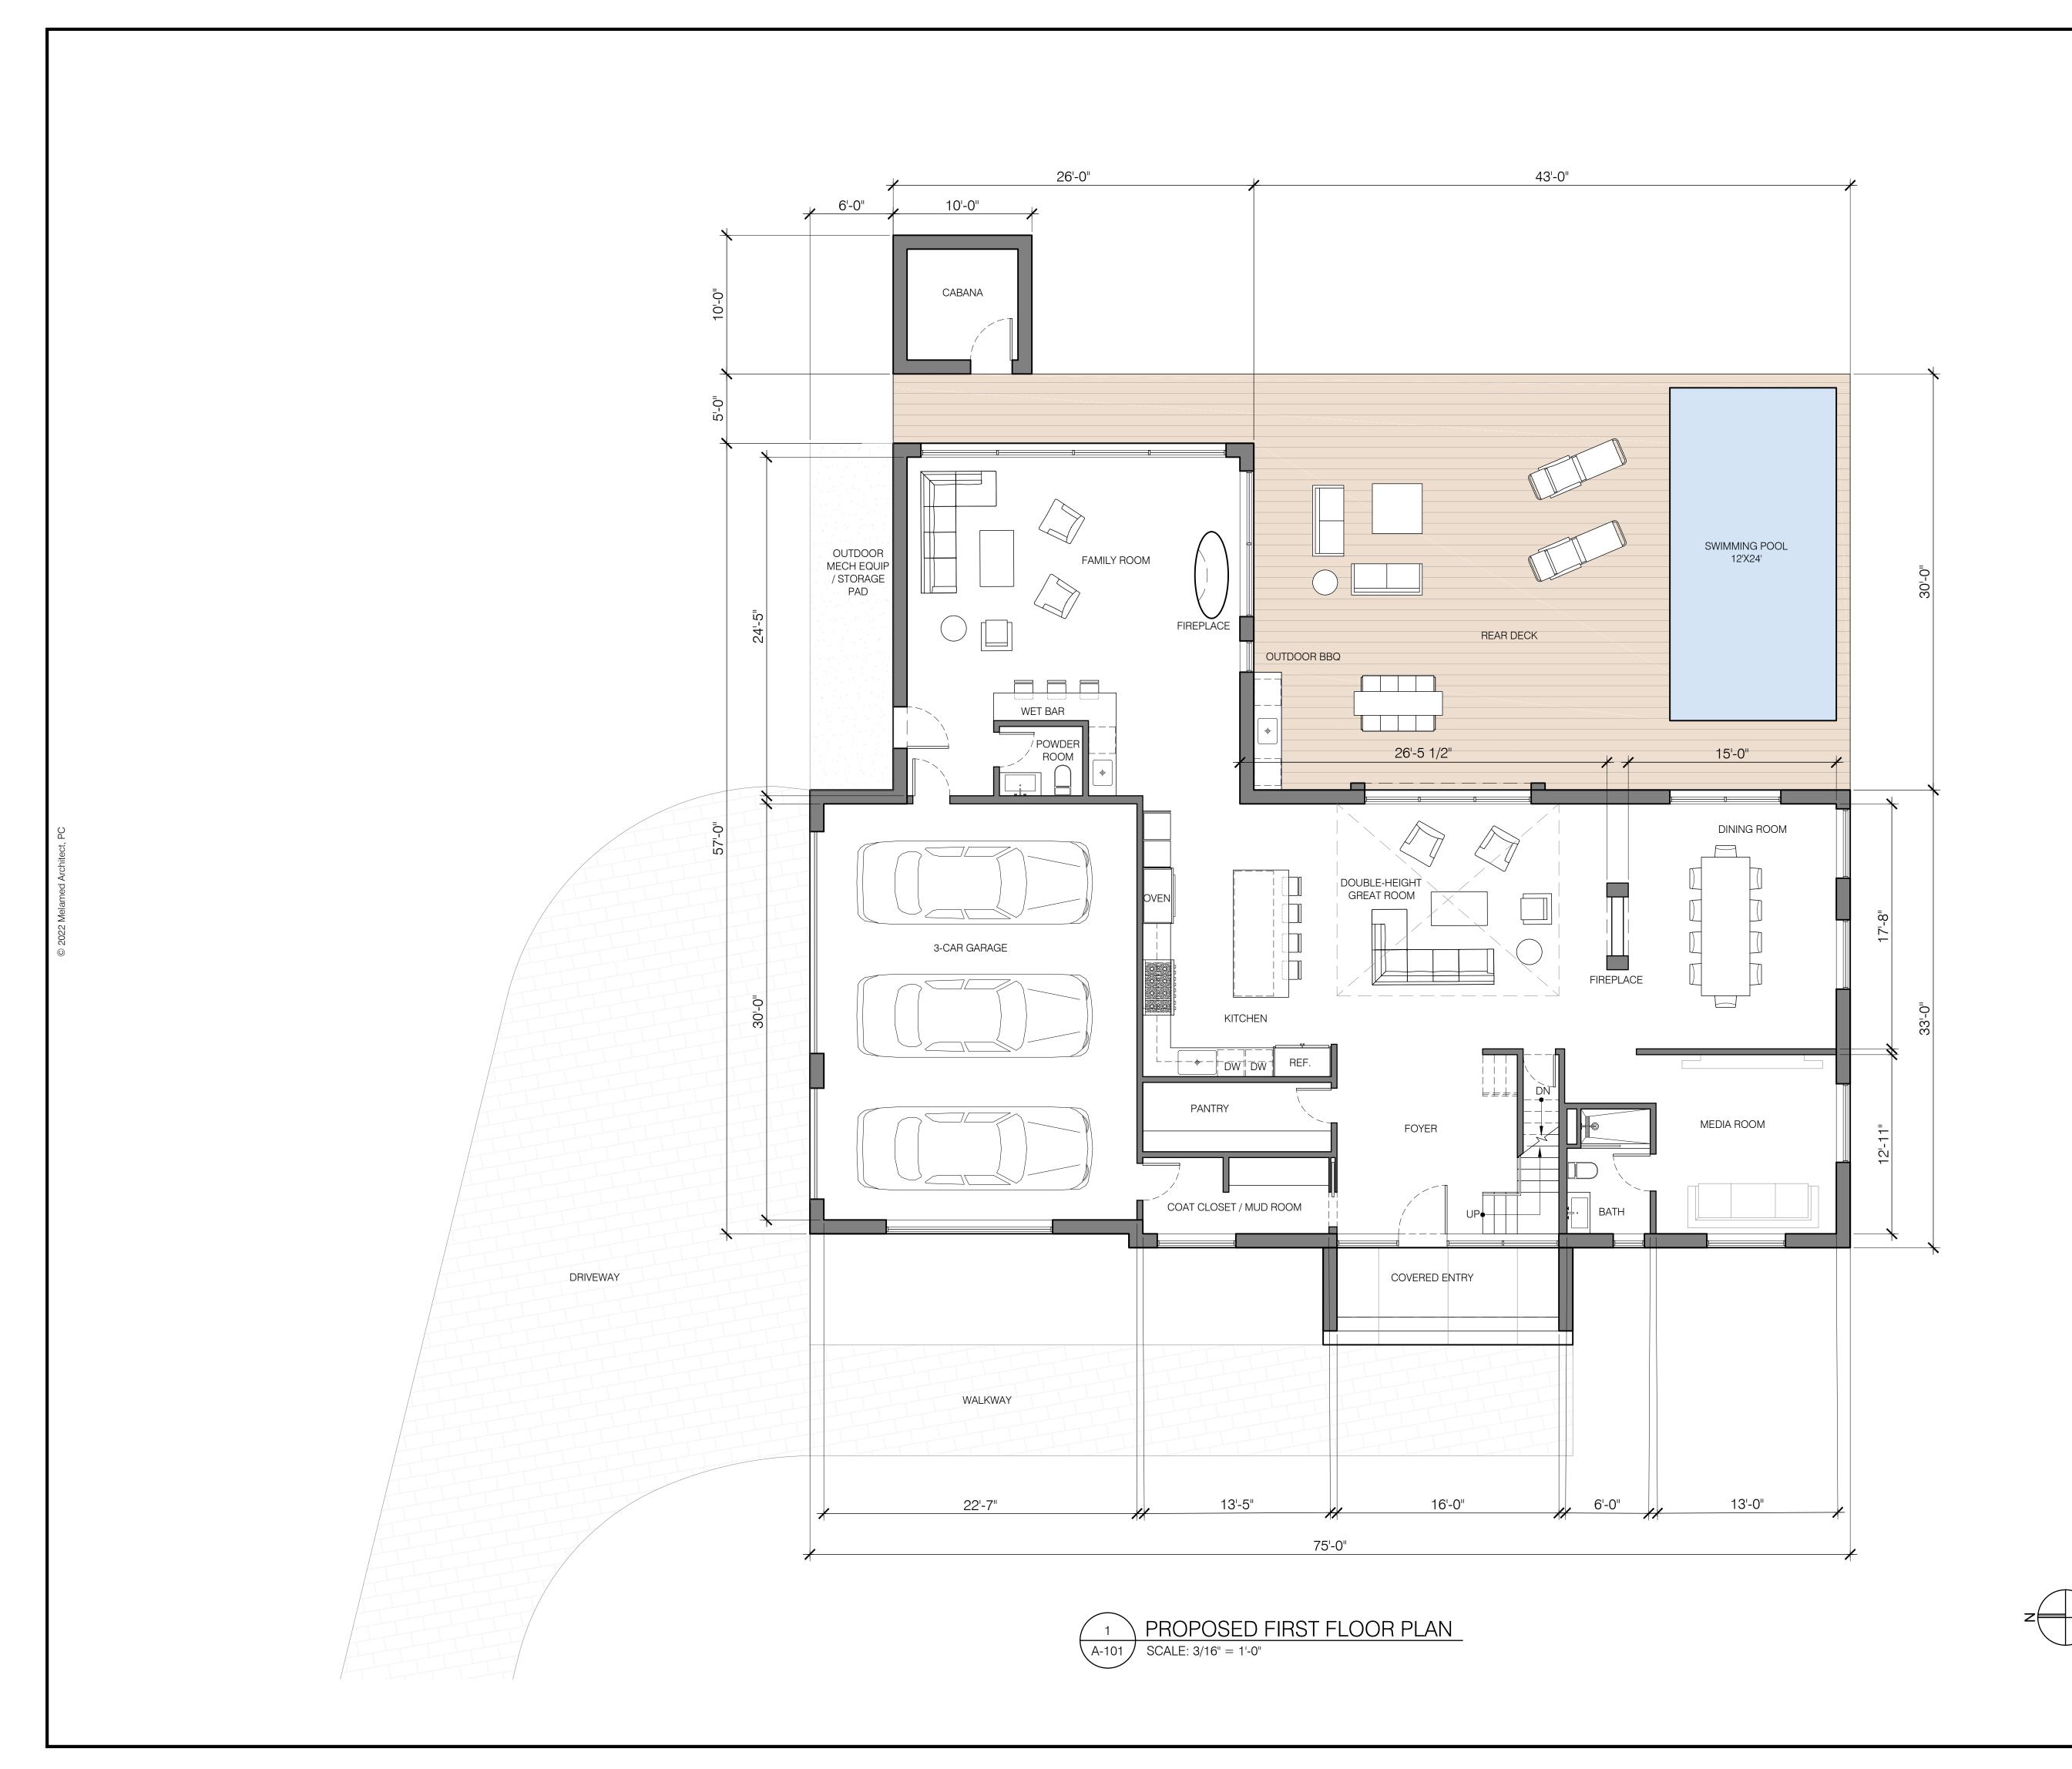
DRAWING TITLE:

PROPOSED BASEMENT PLAN

DRAWING NUMBER:

A-100

DATE: SCALE: 2022 AS NOTED

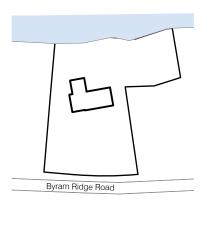




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Byram Ridge Road Armonk, NY 10504



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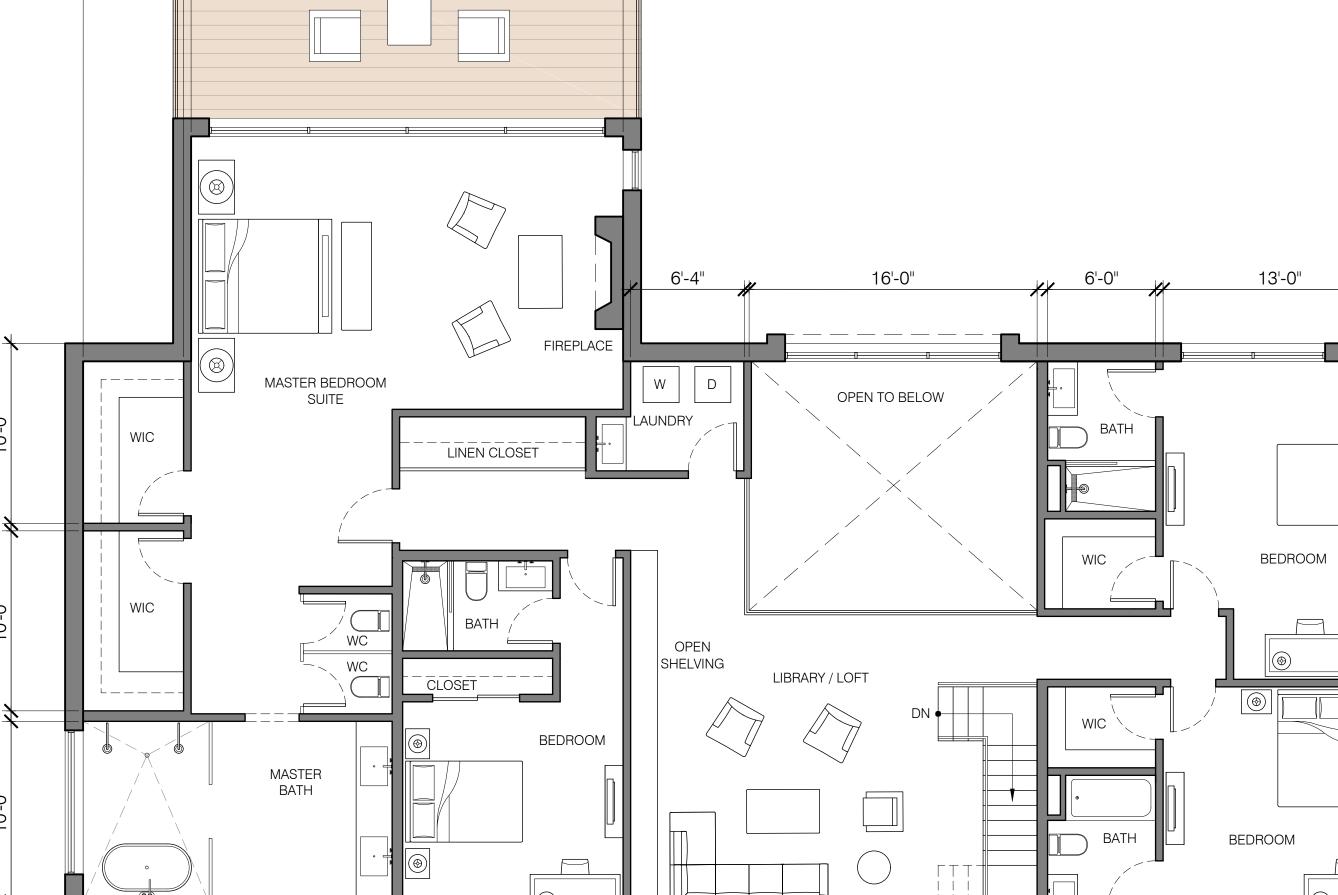
DRAWING TITLE:

PROPOSED FIRST FLOOR

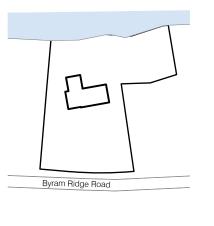DRAWING NUMBER:

DATE: SCALE: 2022

AS NOTED



5'-7"

17'-2"

24'-0"

SHADED TERRACE




22'-7"

6'-0"

13'-0"

12'-3"

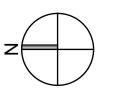


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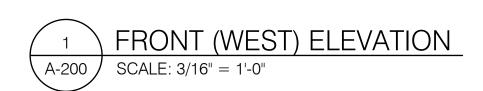
DRAWING TITLE:

PROPOSED SECOND FLOOR PLAN


DRAWING NUMBER:


DATE: 2022

SCALE: AS NOTED STANDING SEAM METAL ROOF

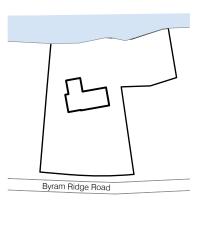

CHIMNEY W/ STONE VENEER

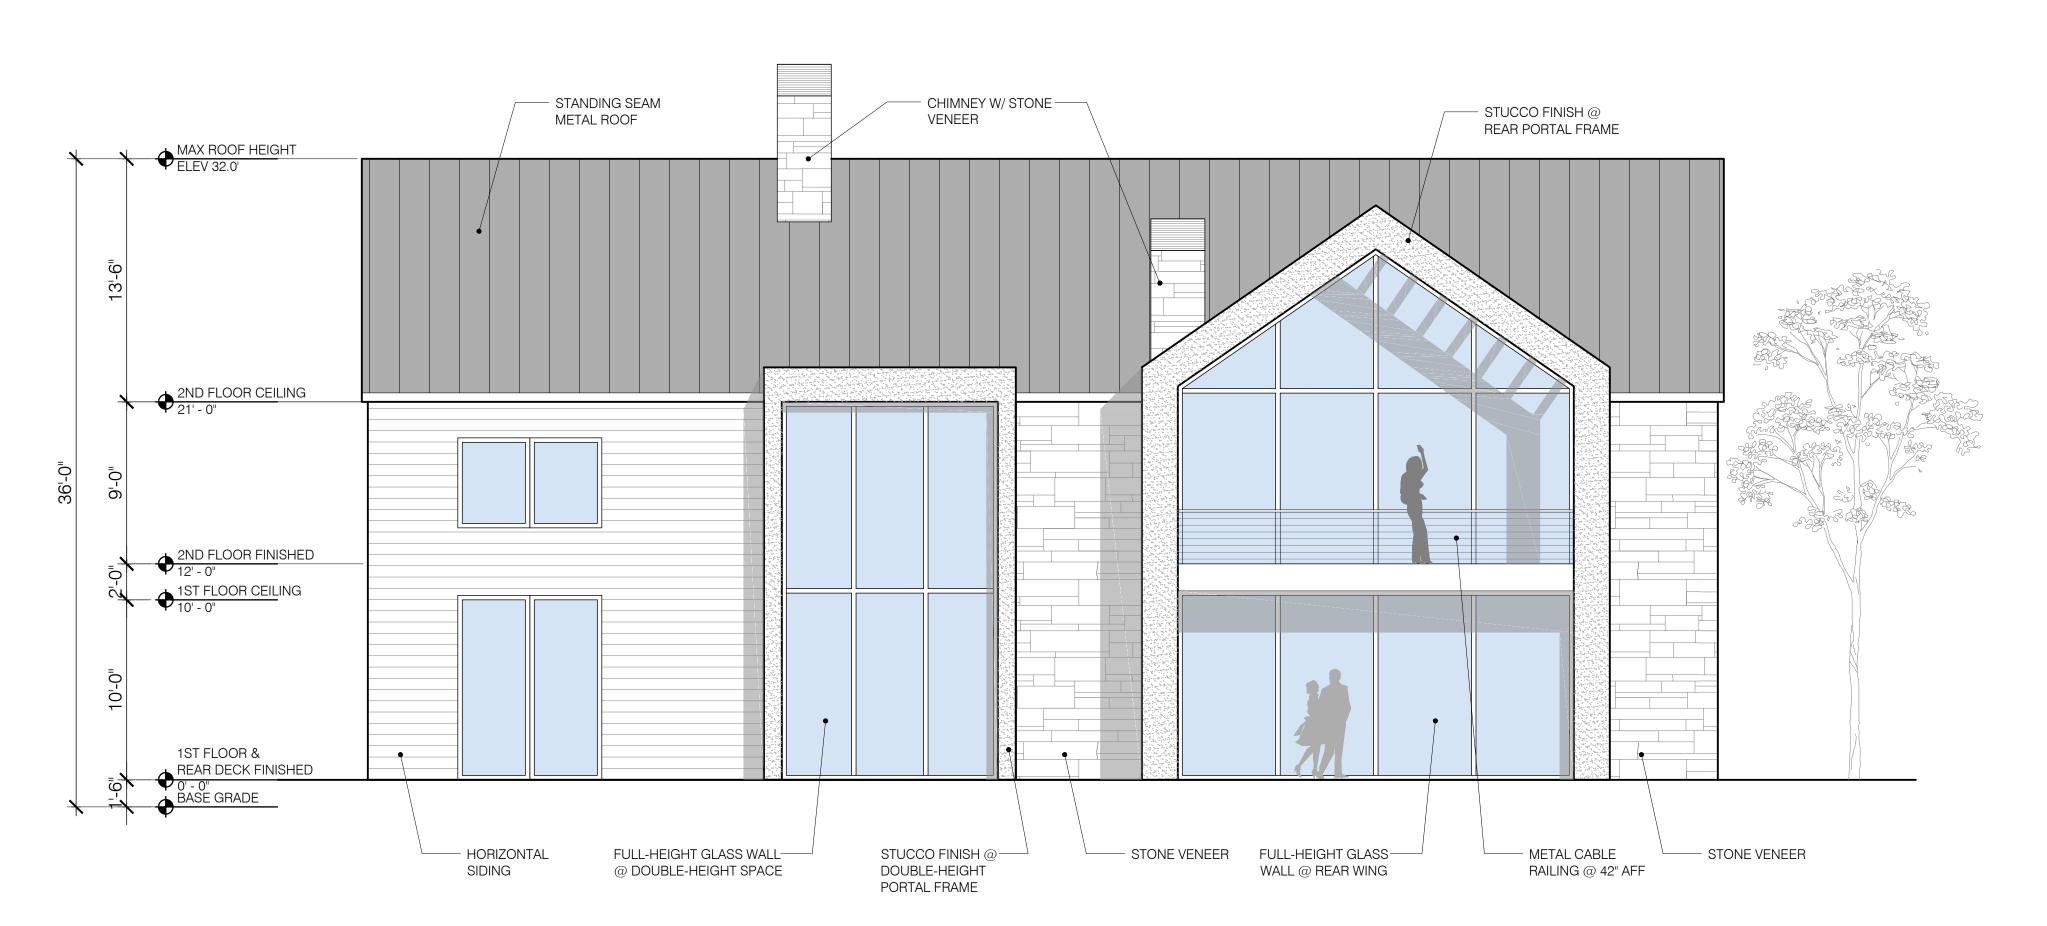

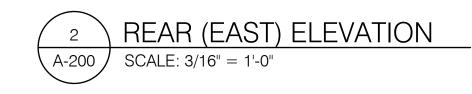


Melamed Architect PC

Yossi Melamed, AIA
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New York, NY 10001
Tel: 212-203-5053
info@melamedarchitect.com
www.melamedarchitect.com



DATE	REVISION NO.	COPY TO	COORDINATION	REVIEW	APPROVAL	BID	CONSTRUCTION
01.18.22	1	RPRC SUBMISSION		X			

Byram Ridge Road Armonk, NY 10504

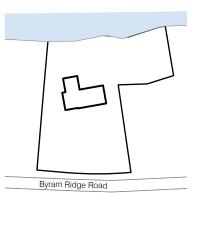

NOTICE

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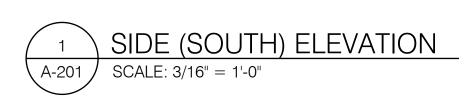
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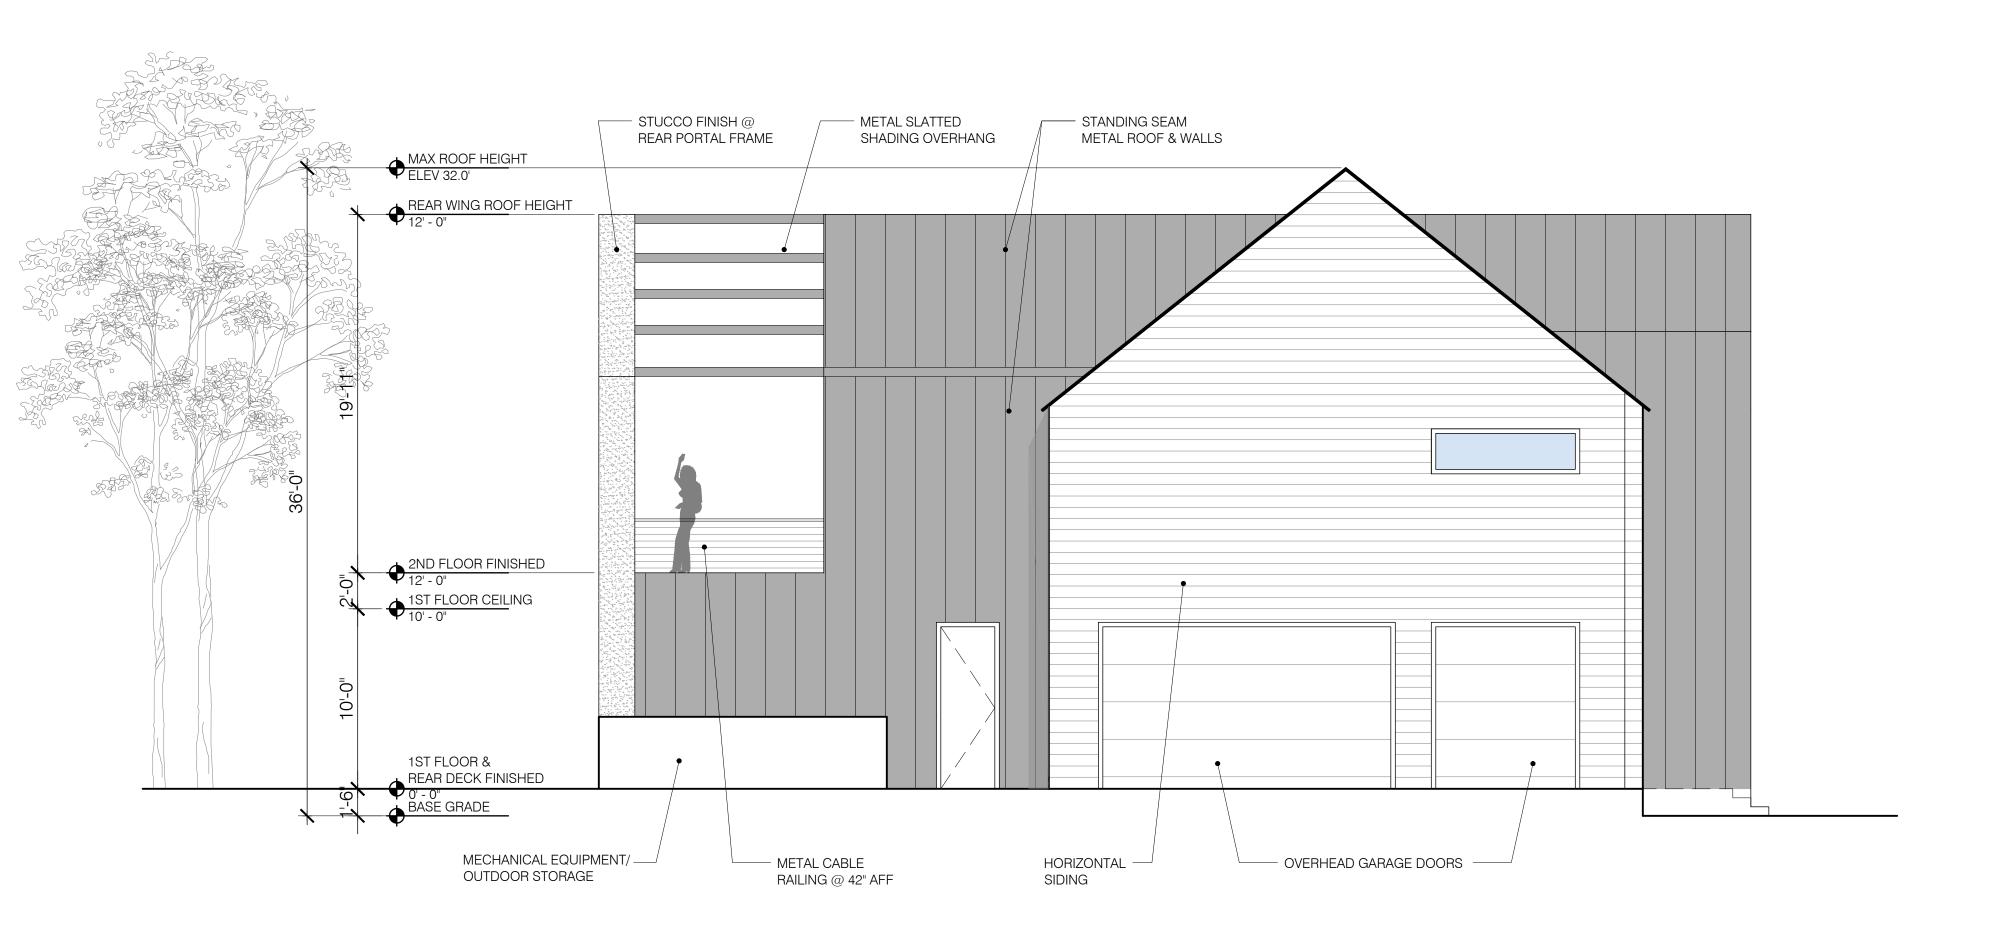
PROPOSED FRONT & REAR ELEVATIONS


DRAWING NUMBER:

A-200

DATE: SCALE:
2022 AS NOTED





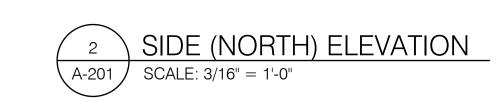


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2



DRAWING TITLE:

PROPOSED SIDE ELEVATIONS

DRAWING NUMBER:

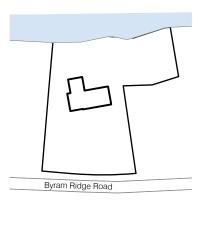A-201

DATE: SCALE:
2022 AS NOTED



Tax Lot 72 N/F Byram Ridge Lake Homeowners Association, Inc. -5 4° 36' 40" W 10.00' _5 6° 39′ 20″ E 60.41' - S 14° 39′ 20″ W S 2° 32' 00" E 67.19' 45.04' S 12° 37′ 30″ W -33.89' POND N 6° 06' 00" W 50.00' N 9° 33′ 30″ E 52.50' Flagstone | Roof Over 6.20' West -12.00 Tax Lot 66 Lot 4, FM 24432 Frame Garage N/F David & Bonnie Sacarny Tax Lot 65 Lot 3-1, FM 24432 11.93 Area = 43,699.06 Sq. Ft. = 1.003 Acres Tax Lot 64 Lot 3, FM 24432 N/F Lois Mallin 60.07 Light Metal Lid — Concrete -Retaining Wall PIPE FND. R=650.00' L=II4.84' N 16° 02′ 50″ E BYRAM RIDGE ROAD 55.16' Asphalt Curb Edge of Pavement

Certified to:

Seth Ferman

First American Title Insurance Company Title No. 142700FA-W The Judicial Title Insurance Agency, LLC

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TC MERRITTS LAND SURVEYORS

394 BEDFORD ROAD • PLEASANTVILLE • NY 10570 (914) 769-8003 • (203) 622-8899



Surveyed: June 21, 2021 Map Prepared: June 23, 2021

By:
Scott B. Gray New York State Licensed Land Surveyor No.050672

Only copies from the original of this survey marked with an original of the Land Surveyors embossed seal or red colored seal shall be considered to be true, valid copies.

Said certifications shall run only to the person for whom this survey is prepared and on his/her behalf to the title company, governmental agency and lending institutions listed hereon. Certifications are not transferable to additional institutions or subsequent owners.

Unauthorized alteration or addition to a survey map bearing a licensed Land Surveyors seal is a violation of Section 7209, Subdivision 2 of the New York State Education Law.

Possession only where indicated.

Adjacent property lines and easements not surveyed or certified. Access to adjacent rights of way, easements and public or private lands not guaranteed or certified.

Underground utilities shown hereon are approximate and should be verified before excavating.

Additional underground utilities are not shown or certified. Encroachments and structures below grade, if any, not shown or certified.

Subject to covenants, easements, restrictions, conditions and agreements of record.

Reference: Lot 3-1 as shown on a certain map entitled, "Resubdivision Map of Properties Belonging to S.A.H. Realty Corp. Niels & Joan Stone Jr., Lois J. Mallin and George & Marcia Nagle, Jr."

Said map filed in the Westchester County Clerk's Office, Division of Land Records on June 4, 1991, as map number 24432.

This survey depicts portions of property described in Deed Liber 7971, Page 481 and Deed Liber 10421, Page 241.

Premises shown hereon designated on the Town of North Castle Tax Maps as: Section 101.01, Block 2, Lot 65.


Property Address:

No # Byram Ridge Road Armonk, New York 10504

SURVEY OF PROPERTY PREPARED FOR SETH FERMAN

SITUATE IN THE TOWN OF NORTH CASTLE WESTCHESTER COUNTY, NEW YORK

SCALE: 1" = 30'

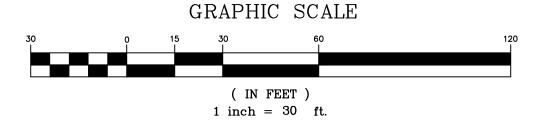

Project:
JOB# 21-245


Field Survey By:
AN/SH

Project Manager:
SBG

Reference:
JOB# 09-052

Drawn By:
CMP

Checked By:
SBG

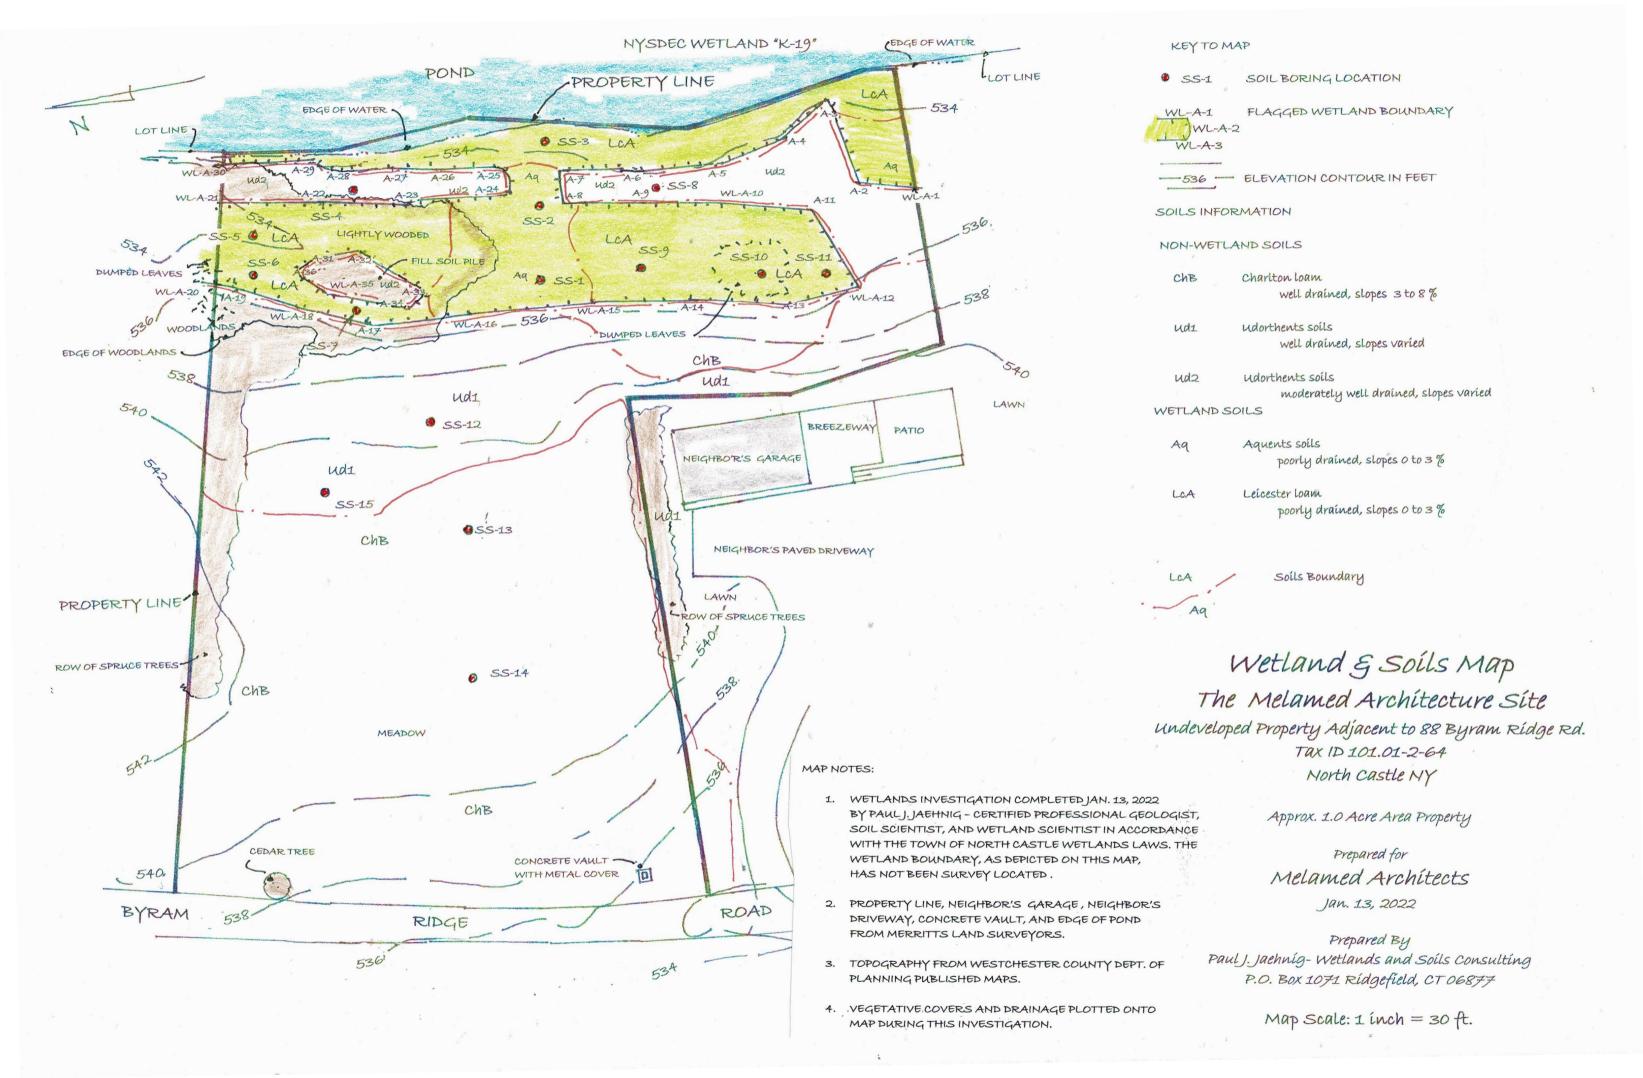

Wetland and Soils Survey

The Melamed Architecture Site
Undeveloped Property Adjacent to 88 Byram Ridge Road
Tax ID 101.01-2-65

North Castle, NY

Approx. 1.00-Acre Area

Prepared for Melamed Architects

Jan. 13, 2022



Wetland and Soils Survey

The Melamed Architecture Site
Undeveloped Property Adjacent to 88 Byram Ridge Road
Tax ID 101.01-2-65

North Castle, NY

Approx. 1.00-Acre Area

Prepared for Melamed Architects

Jan. 13, 2022

Introduction

A wetland investigation was completed on undeveloped property identified as Tax ID 101.01-2-64 and adjacent to 88 Byram Ridge Road in the Town of North Castle, NY on Jan. 13, 2022 by Paul J. Jaehnig, Certified Professional Geologist, Soil Scientist, and Wetland Scientist. The work consisted of the taking of soil borings at selected locations across the site to identify the presence of wetland or hydric soils and the delineation or flagging of the wetland boundary. The work was conducted in accordance with the Town of North Castle Freshwater Wetlands Law. The work was conducted at the request of the client Melamed Architects.

Site Description

The site is an approx. 1.0 acre area undeveloped property situated on the east side of Byram Ridge Road. The site is an "L" property with the base of "L" on the eastern end of the site and bordering a pond. The site is situated in an established residential neighborhood. The site is flanked on the south and north sides by established residential properties. The site consists of: a meadow; small wooded borders; and wetlands, including a section of pond shoreline (see enclosed *photos 1 to 6* in Appendix I and *Wetland & Soils Map*).

Slopes across the site vary from nearly level to gently sloping. A narrow strip along contour, and trending north to south across the eastern portion of the site, is moderately sloped. Gently sloped land covers the western, central, and some eastern portions of the site. Nearly level land is on the eastern portion of the site. Many areas on the eastern portion of the site have undulating topography modified by man-made activity carried-out on the site; possibly work related to the pond creation many years ago. A ridge axis traverses north to south across the west-central portion of the site. To the east of the axis, the land slopes down to the east, and down to the west to the west of the axis.

A mowed grassed meadow covers the eastern and central portions of the site (see *photo 1* in Appendix I). A lone cedar tree grows on the northwest corner of the site, in close proximity to the road (see *photo 1* in Appendix I). A fieldstone and concrete vault with metal cover is on the southwest corner of the meadow, in close proximity to the road (see *photo 2* in Appendix I).

Non-wetland woodlands, consisting primarily of tall planted spruces, grow along portions of the northern and southern borders of the site (see *photo 1* in Appendix I). Needle litter covers the woodland floor in these areas. A lightly wooded area, on some of the northeast edge of the site, consists of a few red maples. Some barberry shrubs grow on this lightly wooded area understory. Twig and leaf litter covers the woodland floor in these areas.

Wetland / Waterbody

Introduction

The wetland boundary was delineated in the field with consecutively numbered flagging, labeled WL-A-1, A-2, A-3, etc. and plotted on the enclosed *Wetland and Soils Map*. A wetland area is on the eastern portion of the site. A portion of a pond shoreline occupies

the entire eastern property line. A wetland, up to 60 ft. wide and fringing the west shore of the pond, occupies the eastern portion of the site.

Description of Pond

A pond, covering a number of acres, is on the eastern property line (see *photo 3* in Appendix I). The site is located on the northwest edge of the pond. The pond is manmade, formed by restricting outflow from a smaller pond with larger surrounding swampland. This work was completed many decades ago. The depth of the pond is not known by this office, however it is likely not too deep, as some emergent vegetation is noted toward the far shore.

Description of Wetland

A wetland area occupies the eastern portion of the site (see *photo 4* in Appendix I). The wetland is somewhat irregular in width, varying from 40 up to 60 ft. in an east to west direction. The wetland extends to the north and south from the site. The wetland is poorly drained and has micro-topography development varying from weak to absent.

The wetland has been previously disturbed by man-made activity including modification of natural vegetative cover, mixing and re-grading of natural wetland soil profiles, and placement and re-grading of fill soil over some wetland soils. One area of fill soil is located on the northwest portion of the wetland (see *photo 5* in Appendix I). A narrow, nearly level, slightly convex strip of non-wetland divides a portion of the wetland (see *photo 6* in Appendix I). Soils examined along the convex strip were identified as fill soil. This strip of non-wetland may be the remains of an old travel-way along the pond. These disturbances were likely carried-out in the course of developing the neighborhood and construction of the pond. Dumped leaf piles are on the southwest portion of the wetland and northwest corner of the wetland.

The wetland herbaceous vegetative cover appears to be modified by periodic mowing in order to keep the land open and vegetative growth in check. As a consequence, the northeast, central, and southern portions of the wetland are relatively open. The wetland vegetative cover consists of: a very thin tree canopy of a few red maples with shallow roots; open understory except for a few winterberry and barberry shrubs growing on the northern end of the wetland; and herbaceous Japanese stilt grass, few sallow sedges, onion grass, cinnamon fern, and local goldenrod. Some red maples have curved trunks and are leaning as a consequence of windstorms uprooting trees having shallow root development. Sphagnum moss groundcover is common on the central and eastern portions of the wetland. Cattail and wool grass grow in local clusters where the wetlands border shore of the pond. Matted leaves cover unvegetated ground on some of the northern portion of the wetland. To the south of the site, the wetland is maintained as a lawn area, with shrub and tree growth along the shore of the pond.

Wetland Buffers

There is a distinct topographic slope from the nearly level wetland up to the very gently sloped non-wetland meadow on the central and western portions of the site. A neighbor's garage and breezeway are at the top of slope bordering the southwest end of the wetland.

Wetland / Waterbody Functions

The pond provides stormwater control function, collecting and retaining run-off deposited from surrounding upland areas so it is made available for slow discharge to lower elevation points within the regional watershed. The pond provides habitat for a variety of wildlife including waterfowl, small fish, and snapping turtle. The pond is a passive recreational resource and aesthetic resource for the residents surrounding the pond.

The site wetland provides a water quality function by trapping potential pollutants carried in upland run-off before reaching the pond. Shallow groundwater discharge from the wetland portion in close proximity to the pond provides supporting hydrologic input to the waterbody. The wetland provides some potential habitat area for wildlife. Waterfowl may utilize the edges of the wetland for browsing and nesting from time to time. Deer, raccoon, and coyote likely traverse the wetland area. Bullfrogs likely utilize the pond shore. Small songbirds may utilize the more wooded portion of the wetland for nesting and perching opportunities. The exposure of the wetland to neighboring residential properties, however, does limit the regular use of the site wetland by wildlife.

New York State Dept. of Environmental Conservation Wetlands Jurisdiction

NYSDEC wetland *WL*-"*K*-19" is on the eastern end of the site according to a review of the NYSDEC wetlands maps (see *NYSDEC Wetlands Map* in Appendix II).

Regional Drainage

The site is located in the Byram River Drainage Basin (see *Regional Drainage Map* in Appendix III).

Soils

Soils borings were taken across the site using a Dutch auger and spade. Each soil boring was logged or described noting soil horizon depth, color, texture, structure, and presence of any redoximorphic (wetland or hydric) soil features such as mottling. The water table, if encountered, was measured. The detailed description of each soil boring is provided in Appendix IV. The locations of each soil boring are labeled SS-1, SS-2, etc. and plotted on the enclosed *Wetland and Soils Map*. Soils found on the site consist of: non-wetland, well drained Charlton loam (ChB), slopes 3 to 8 %, in the undisturbed, meadow on the western and central portions of the site; non-wetland, well drained Udorthents, cut, fill, and graded (Ud1), slopes varied, to describe areas on the eastern end of the meadow where soils have been placed and graded by past man-made work carried-out on the site; non-wetland, moderately well drained Udorthents (Ud2), to describe soils with mixed profiles due to placement and re-grading of soils by man in close proximity to the

wetland; wetland, poorly drained Aquents soils (Aq), slopes 0 to 3 %, to describe wetland soils disturbed by past man-made activity; and wetland, poorly drained Leicester loam (LcA), slopes 0 to 3 %, in undisturbed portion of the wetland. The distribution of the different soil-types is depicted on the enclosed *Wetland and Soils Map*.

Appendix I

Selected Site Photos



Photo 1 Looking east across the very gently sloped meadow on the western and central portions of the site.



Photo 2 Looking toward fieldstone and concrete vault with metal cover located on the southwest corner of the site.

Jan. 2022- The Melamed Architects Site, Byram Ridge Road, North Castle, NY

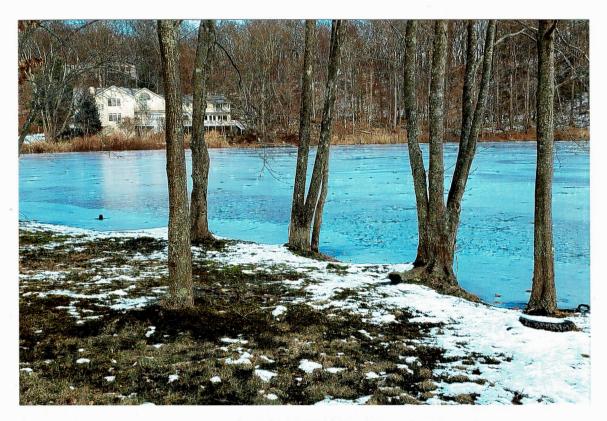


Photo 3 Looking northeast toward pond on the eastern edge of the site. Note neighbor's residence on opposite shore.



Photo 4 Looking south across wetland bordering pond. Note pond in upper left corner of the photo..

Jan. 2022- The Melamed Architects Site, Byram Ridge Road, North Castle, NY



Photo 5 Looking north across northwest portion of the wetland. Note tree-covered fill soil pile in right side of photo. a




Photo 6 Looking north along level and slightly convex possible old travel-way traversing wetland.

Jan. 2022- The Melamed Architects Site, Byram Ridge Road, North Castle, NY

Appendix II

NYS State Dept. of Environmental Conservation


Wetland Map

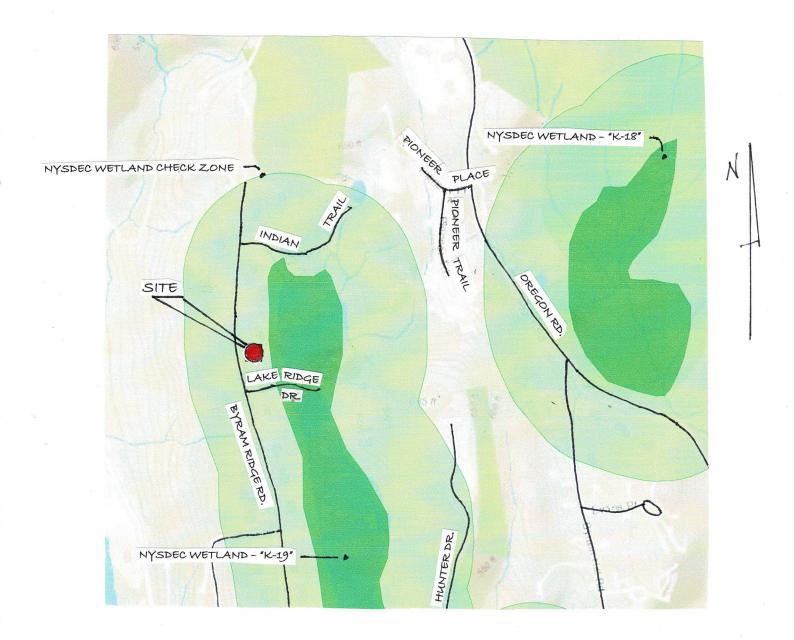

NYSDEC WETLAND MAP N.T.S.

Appendix III

Regional Drainage Map

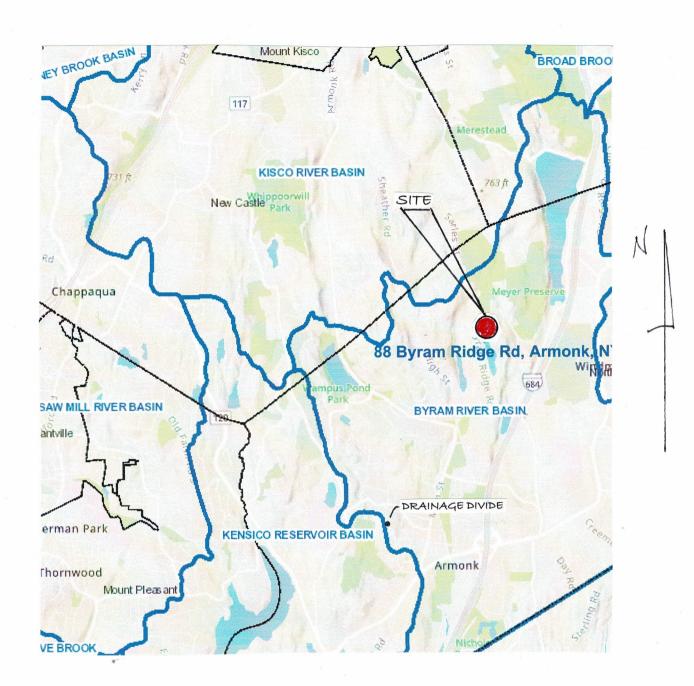

REGIONAL DRAINAGE MAP N.T.S.

Appendix IV

Soil Borings

Key To Soil Boring Logs

SS-1 Soil Boring

Color Munsell Color Notation

Hue Value Chroma

Brown 10YR 4 / 3

Texture Portion of Sand / Silt / Clay

silt loam – sandy loam – loamy sand

Water table In inches depth measured from

ground surface

SITE: VERY GENTLY SLOPED AND LIGHTLY WOODED LAND; WEAK MICRO-TOPOGRAPHY; FEW RED MAPLES WITH SHALLOW ROOTS; OPEN UNDERSTORY; GROUND COVERED WITH JAPANESE STILT GRASS.

- 0-6" DARK GRAY 10YR 4/1 LOAM WITH 10 % BROWN 7.5YR 4/4 OXIDIZED RHIZOSPHERES (REDOX CONCENTRATIONS).
- 6-15" MIXED GREENISH GRAY 10Y 6/1 LOAM WITH 10% DARK YELLOW BROWN 10YR 4/6 MOTTLES (REDOX CONCENTRATIONS).
- 15-28" GREENISH GRAY 10Y 6/1 LOAM WITH 10% DARK YELLOW BROWN 10YR 4/6 MOTTLES (REDOX CONCENTRATIONS).

WATER TABLE AT 6".

SS-2

SITE: NEARLY LEVEL LAND; WEAK MICRO-TOPOGRAPHY; GROUND COVERED WITH GRASSES AND SPHAGNUM MOSS.

- 0-6" DARK GRAY 10YR 4/1 LOAM WITH 10% OXIDIZED RHIZOSPERES (REDOX CONCENTRATIONS).
- 6-12" MIXED GREENISH GRAY 10Y 5/1 FINE SANDY LOAM WITH 10% DARK YELLOW BROWN 10YR 4/6 MOTTLES (REDOX CONCENTRATIONS).
- 12-28" GREENISH GRAY 10Y 6/1 VERY FINE SANDY LOAM WITH 10% DARK YELLOW BROWN 10YR 4/6 MOTTLES (REDOX CONCENTRATIONS); FIRM.

WATER TABLE AT 2".

SS-3

SITE: LEVEL, LOW-RELIEF LAND ADJACENT TO POND; FEW RED MAPLE WITH SHALLOW AND EXPOSED ROOTS; CLUSTER OF CATTAILS AND WOOLGRASSES DOT SHORE; SPHAGNUM MOSS BLANKETS GROUND.

- 0-3" DARK GRAY 10YR 4/1 LOAM WITH 10% BROWN 7.5YR 4/4 MOTTLES (REDOX CONCENTRATIONS).
- 3-28" GREENISH GRAY 10Y 6/1 FINE SANDY LOAM WITH 10% DARK YELLOW BROWN 10YR 4/6 MOTTLES (REDOX CONCENTRATIONS).

WATER TABLE AT 2".

<u>SS-4</u>

SITE: LEVEL AND SLIGHTLY CONVEX CORRIDOR OF LAND PARALLEL TO SHORE OF POND; GROUND COVERED WITH MOSS.

- 0-2" BROWN 10YR 4/3 LOAM.
- 2-8" MIXED BROWN 10YR 4/3 FINE SANDY LOAM WITH 10% GRAVEL.
- 8-15" MIXED BROWNISH YELLOW 10YR 6/6 AND YELLOW BROWN 10YR 5/6 FINE SANDY LOAM WITH 5% GRAVEL.
- 15-28" MIXED GRAY BROWN 10YR 5/2 VERY FINE SANDY LOAM WITH 10% GRAVEL.

WATER TABLE NOT ENCOUNTERED.

<u>SS-</u>5

SITE: LEVEL AND SLIGHTLY CONCAVE AREA; WEAK MICRO-TOPOGRAPHY; PUDDLED WATER; CANOPY OF FEW RED MAPLE TREES WITH SHALLOW ROOTS; FEW WINTERBERRY AND BARBERRY SHRUBS; MATTED LEAVES COVER UNVEGETATED GROUND.

- 0-4" DARK GRAY 10YR 4/1 LOAM.
- 4-28" GREENISH GRAY 10Y 6/1 VERY FINE SANDY LOAM WITH 10% DARK YELLOW BROWN 10YR 4/6 MOTTLES (REDOX CONCENTRATIONS).

WATER TABLE AT 0".

SS-6

SITE: SIMILAR TO SS-5.

SOIL: SIMILAR TO SS-5

WATER TABLE AT 0".

SS-7

SITE: NARROW AND ELONGATE CONCAVE AREA BETWEEN MEADOW AND FILL SOIL PILE; UNVEGETATED GROUND COVERED WITH MATTED LEAF LITTER.

0-13" DARK GRAY 10YR 4/1 SILT LOAM.

(SS-7 cont.)

13-28" GREENISH GRAY 10Y 6/1 LOAM WITH 10% DARK YELLOW BROWN 10YR 4/6 MOTTLES (REDOX CONCENTRATIONS).

WATER TABLE AT 4".

SS-8

SITE: LEVEL AND NARROW TERRACE PARALLEL TO POND SHORE; VEGETATED WITH CUT GRASS AND MOSS.

- 0-4" DARK GRAY BROWN 10YR 4/2 LOAM AND FINE SANDY LOAM WITH 10% GRAVEL.
- 4-28" MIXED LIGHT GRAY 5Y 7/2 FINE SANDY LOAM; FIRM.

WATER TABLE NOT ENCOUNTERED.

SS-9

SITE: LEVEL LAND; NO MICRO-TOPOGRAPHY; FEW RED MAPLE TREES WITH SHALLOW ROOTS; OPEN UNDERSTORY; GROUND COVERED WITH JAPANESE STILT GRASS, FEW SALLOW SEDGES, AND GOLDENROD.

- 0-4" DARK GRAY 10R 4/1 LOAM.
- 4-8" GRAY BROWN 20YR 5/2 FINE SANDY LOAM WITH 10% DIFFUSE DARK YELLOW BROWN 10YR 4/6 MOTTLES (REDOX CONCENTRATIONS).
- 8-28" GREENISH GRAY 10Y 6/1 LOAM AND 20% DARK YELLOW BROWN 10YR 4/6 MOTTLES (REDOX CONCENTRATIONS).

WATER TABLE AT 6".

SS-10

SITE: LEVEL AND UNEVEN GROUND; COVER OF DUMPED LEAVES.

- 0-12" LEAVES.
- 12-14" DARK GRAY 10YR 4/1 AND BROWN 10YR 4/3 LOAM WITH 5% GRAVEL.
- 14-16" GRAY BROWN 10YR 5.2 FINE SANDY LOAM WITH 10% DARK YELLOW BROWN 10YR 4/6 MOTTLES (REDOX CONCENTRATIONS).

(SS-10 cont.)

16-28" GREENISH GRAY 10Y 6/1 FINE SANDY LOAM WITH 10% DARK YELLOW BROWN 10YR 4/6 MOTTLES (REDOX CONCENTRATIONS).

WATER TABLE 16".

SS-11

SITE: LEVEL WETLANDS; WEAK MICRO-TOPOGRAPHY; ONE RED MAPLE TREE WITH SHALLOW ROOTS; OPEN UNDERSTORY; FEW SALLOW SEDGE, ONION GRASS, AND JAPANESE STILT GRASS.

- 0-12" VERY DARK GRAY 10YR 3/1 SILT LOAM.
- 12-14" GRAY BROWN 10YR 5/2 FINE SANDY LOAM WITH 20% DARK YELLOW BROWN 10YR 4/6 MOTTLES (REDOX CONCENTRATIONS).
- 14-28" GREENISH GRAY 10Y 6/1 FINE SANDY LOAM WITH 20% DARK YELLOW BROWN 10YR 4/6 MOTTLES (REDOX CONCENTRATIONS).

 WATER TABLE AT 6".

SS-12

SITE: NEARLY LEVEL MOWED GRASSED MEADOW.

- 0-24" MIXED DARK BROWN 10YR 3/3 LOAM.
- 24-40" MIXED VERY DARK GRAY 10YR 3/1 LOAM.

WATER TABLE NOT ENCOUNTERED.

SS-13

SITE: NEARLY LEVEL MOWED GRASS MEADOW.

- 0-13" BROWN 10YR 4/3 LOAM.
- 13-21" LIGHT YELLOW BROWN 2.5Y 6/4 LOAM WITH 10% BROWN 10YR 4/3 LOAM INCLUSIONS.
- 21-29" LIGHT YELLOW BROWN 2.5Y 6/4 VERY FINE SANDY LOAM.
 WATER TABLE NOT ENCOUNTERED.

<u>SS-14</u>

SITE: VERY GENTLY SLOPED MOWED GRASS MEADOW.

- 0-12" BROWN 10YR 4/3 LOAM.
- 12-14" YELLOW BROWN 10YR 5/6 LOAM.
- 14-29" YELLOW BROWN 10YR 5/6 FINE SANDY LOAM.

WATER TABLE NOT ENCOUNTERED.

SS-15

SITE: NEARLY LEVEL MOWED GRASS MEADOW.

- 0-24" MIXED DARK GRAY BROWN 10YR 4/2 AND BROWN 10YR 4/3 LOAM.
- 24-30" MIXED VERY DARK GRAY 10YR 3/1 LOAM.
 WATER TABLE NOT ENCOUNTERED.