

TOWN OF NORTH CASTLE

WESTCHESTER COUNTY 17 Bedford Road Armonk, New York 10504-1898

RESIDENTIAL PROJECT REVIEW COMMITTEE Adam R. Kaufman AICP, Chair

Telephone: (914) 273-3000 x 43 Fax: (914) 273-3554 www.nortcastleny.com

RESIDENTIAL PROJECT REVIEW COMMITTEE (RPRC) APPLICATION

Section I- PROJECT

ADDRESS: 9 Wrights Mill Rd, Armonk NY 10504

Section III- DESCRIPTION OF WORK:

Construction of porch over existing terrace in the rear yard.

(Please note that the expansion of the garage and alteration of the space over the garage shown on this plans was the subject of a review and determination by the RPRC on 2/16/2021). A Building Permit has been issued for this work

Section III- CONTACT INFORMATION:

APPLICANT: Teodoro Siguenza/Teo Siguenza architect PLLC

 ADDRESS:
 460 Old Post Road, Bedford NY 10506

 PHONE:
 914-234-6289

 MOBILE:
 914-519-7722

 EMAIL:
 ts@teosiguenza.com

 PROPERTY OWNER:
 Jonathan Stern

 ADDRESS:
 9 Wrights Mill Rd, Armonk NY 10504

 PHONE:
 MOBILE:
 914-500-5563
 EMAIL:
 jstern.nissan@gmail.com

 PROFESSIONAL::
 Teodoro Siguenza/Teo Siguenza architect PLLC

 Address:
 460 Old Post Road, Bedford NY 10506

 PHONE:
 914-234-6289
 MOBILE:
 914-519-7722

 EMAIL:
 ts@teosiguenza.com

 Section IV- PROPERTY INFORMATION:

 Zone:
 R-2A
 Tax ID (lot designation)
 100.02-1-33



Town of North Castle Residential Project Review Committee

17 Bedford Road Armonk, New York 10504 (914) 273-3542 (914) 273-3554 (fax)

RPRC COMPLETENESS REVIEW FORM

This form represents the standard requirements for a completeness review for all Residential Project Review Committee submissions. Failure to provide all of the information requested will result in a determination that the application is incomplete.

Project Name on Plan: Stern Residence

XInitial Submittal Revised Preliminary

Street Location: 9 Wrights Mill Rd, Armonk NY 10504

Zoning District: <u>R-2A</u> Property Acreage: <u>3.497</u> Tax Map Parcel ID: <u>100.02-1-33</u>

Date: 02/03/2022

DEPARTMENTAL USE ONLY

Date Fi	iled: Staff Name:
Items I	inary Plan Completeness Review Checklist marked with a bare complete, items left blank bare incomplete and must be ted, "NA" means not applicable.
1.	Plan prepared by a registered architect or professional engineer
2.	Aerial photo (Google Earth) showing the applicant's entire property and adjacent properties and streets
3.	Map showing the applicant's entire property and adjacent properties and streets
4.	A locator map at a convenient scale
5.	The proposed location, use and design of all buildings and structures
6.	Existing topography and proposed grade elevations
7.	Location of drives
8.	Location of all existing and proposed site improvements, including drains, culverts, retaining walls and fences

RPRC COMPLETENESS REVIEW FORM

Page 2

9.	Description of method of water supply and sewage disposal and location of such facilities
10.	The name and address of the applicant, property owner(s) if other than the applicant and of the planner, engineer, architect, surveyor and/or other professionals engaged to work
<u>1</u> 11.	Submission of a Zoning Conformance Table depicting the plan's compliance with the minimum requirements of the Zoning District
<u>12</u> .	If a tree removal permit is being sought, submission of a plan depicting the location and graphical removal status of all Town-regulated trees within the proposed area of disturbance. In addition, the tree plan shall be accompanied by a tree inventory includes a unique ID number, the species, size, health condition and removal status of each tree.
13.	If a wetlands permit is being sought, identification of the wetland and the 100-foot wetland buffer.

More information about the items required herein can be obtained from the North Castle Planning Department. A copy of the Town Code can be obtained from Town Clerk or on the North Castle homepage: <u>http://www.northcastleny.com/townhall.html</u>

____ On this date, all items necessary for a technical review of the proposed site plan have been submitted and constitute a COMPLETE APPLICATION.



PLANNING DEPARTMENT

Adam R. Kaufman, AICP

Director of Planning

TOWN OF NORTH CASTLE


WESTCHESTER COUNTY 17 Bedford Road Armonk, New York 10504-1898

January 29, 2019 Telephone: (914) 273-3542 Fax: (914) 273-3554 www.northcastleny.com

FLOOR AREA CALCULATIONS WORKSHEET

Application Name or Identifying Title:	Stern Residence	Date: 2-4-22
Tax Map Designation or Proposed Lot No.	.:	
Floor Area		
1. Total Lot Area (Net Lot Area for	Lots Created After 12/13/06):	152,329.00
2. Maximum permitted floor area (p	per Section 355-26.B(4)):	12,730.36
3. Amount of floor area contained w 3,405 existing + 0		3,405.00
4. Amount of floor area contained w <u>3,929</u> existing + <u>0</u>		3,929.00
5. Amount of floor area contained w <u>1,157</u> existing + <u>0</u>		1,157.00
6. Amount of floor area contained w <u>253</u> existing + <u>465</u>	/ithin porches capable of being enclosed: proposed =	718.00
7. Amount of floor area contained w 0 existing +0	/ithin basement (if applicable – see definition): proposed =	0
8. Amount of floor area contained w 0 existing + 0	/ithin attic (if applicable – see definition): proposed =	0
9. Amount of floor area contained w 0 existing + 0	/ithin all accessory buildings: proposed =	0
10. Pro posed floor area: Total of Lin	thes $3 - 9 = $	<u>9,209.00</u> SF

If Line 10 is less than or equal to Line 2, your proposal **complies** with the Town's maximum floor area regulations and the project may proceed to the Residential Project Review Committee for review. If Line 10 is greater than Line 2 your proposal does not comply with the Town's regulations.

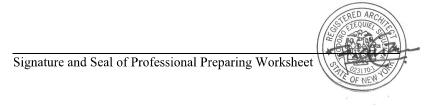

<u>2-4-22</u> Date



TOWN OF NORTH CASTLE

WESTCHESTER COUNTY 17 Bedford Road Armonk, New York 10504-1898

PLANNING DEPARTMENT Adam R. Kaufman, AICP Director of Planning Telephone: (914) 273-3542 Fax: (914) 273-3554 www.northcastleny.com

GROSS LAND COVERAGE CALCULATIONS WORKSHEET


Appli	cation Name or Identifying Title: <u>Stern Residence</u>	Date: <u>2-4-22</u>
Tax N	1ap Designation or Proposed Lot No.: <u>100.02-1-33</u>	
<u>Gross</u>	Lot Coverage	
1.	Total lot Area (Net Lot Area for Lots Created After 12/13/06):	<u>3.497 / 1</u> 52,329.00
2.	Maximum permitted gross land coverage (per Section 355-26.C(1)(b)):	18,160.68
3.	BONUS maximum gross land cover (per Section 355-26.C(1)(b)):	
	Distance principal home is beyond minimum front yard setback $87 x ext{ 10} = ext{ 870}$	87 <u>0.00</u>
4.	TOTAL Maximum Permitted gross land coverage = Sum of lines 2 and 3	19,030.68
5.	Amount of lot area covered by principal building: <u>4,562</u> existing + <u>0</u> proposed =	4,562.00
6.	Amount of lot area covered by accessory buildings: <u>0</u> existing + <u>0</u> proposed =	0
7.	Amount of lot area covered by decks: <u>0</u> existing + <u>0</u> proposed =	0
8.	Amount of lot area covered by porches: <u>253</u> existing + <u>465</u> proposed = (over ex. rear terrace)	718
9.	Amount of lot area covered by driveway, parking areas and walkways: <u>8,307</u> existing + <u>0</u> proposed =	8,307
10.	Amount of lot area covered by terraces: <u>2,570</u> existing + <u>-410</u> proposed =	2,160
11.	Amount of lot area covered by tennis court, pool and mechanical equip: <u>1,228</u> existing + <u>0</u> proposed =	1,228
12.	Amount of lot area covered by all other structures: <u>0</u> existing + <u>0</u> proposed =	0
13. Pr	roposed gross land coverage: Total of Lines 5 – 12 =	16,975.00

If Line 13 is less than or equal to Line 4, your proposal **complies** with the Town's maximum gross land coverage regulations and the project may proceed to the Residential Project Review Committee for review. If Line 13 is greater than Line 4 your proposal does not comply with the Town's regulations.




2-4-22 Date

Signature and Seal of Professional Preparing Worksheet

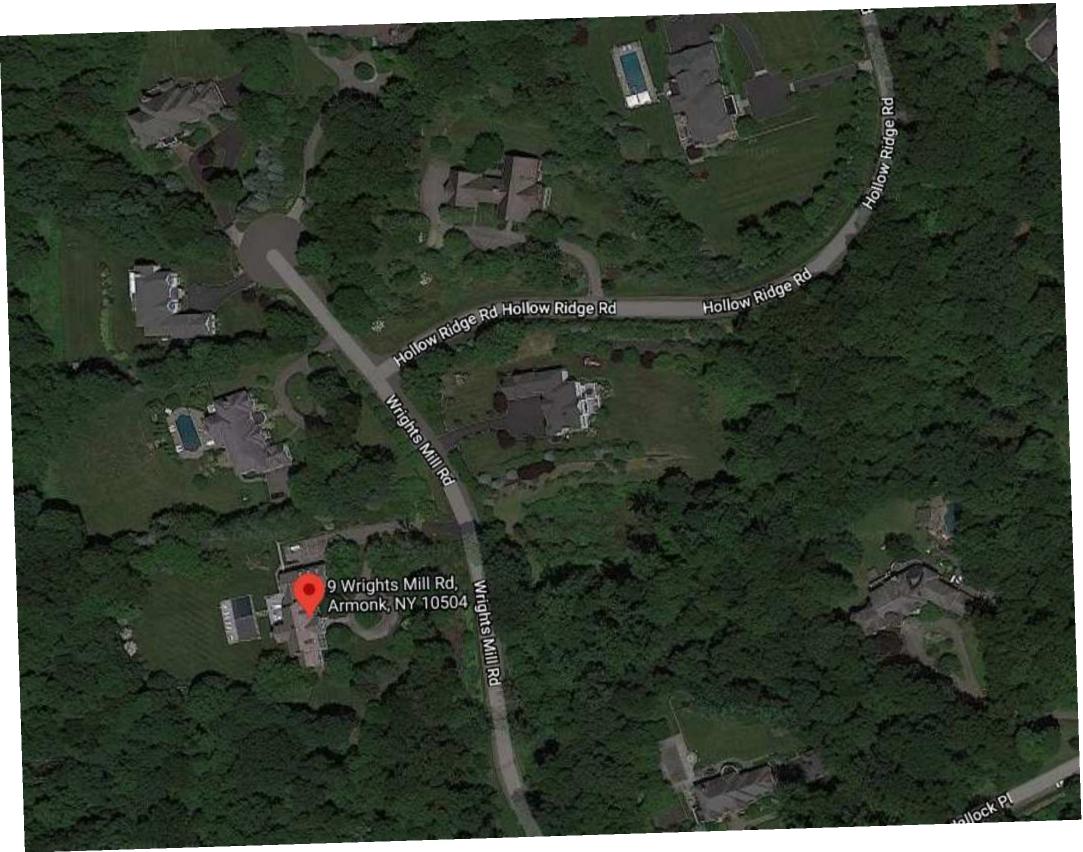



Ex. rear elevation

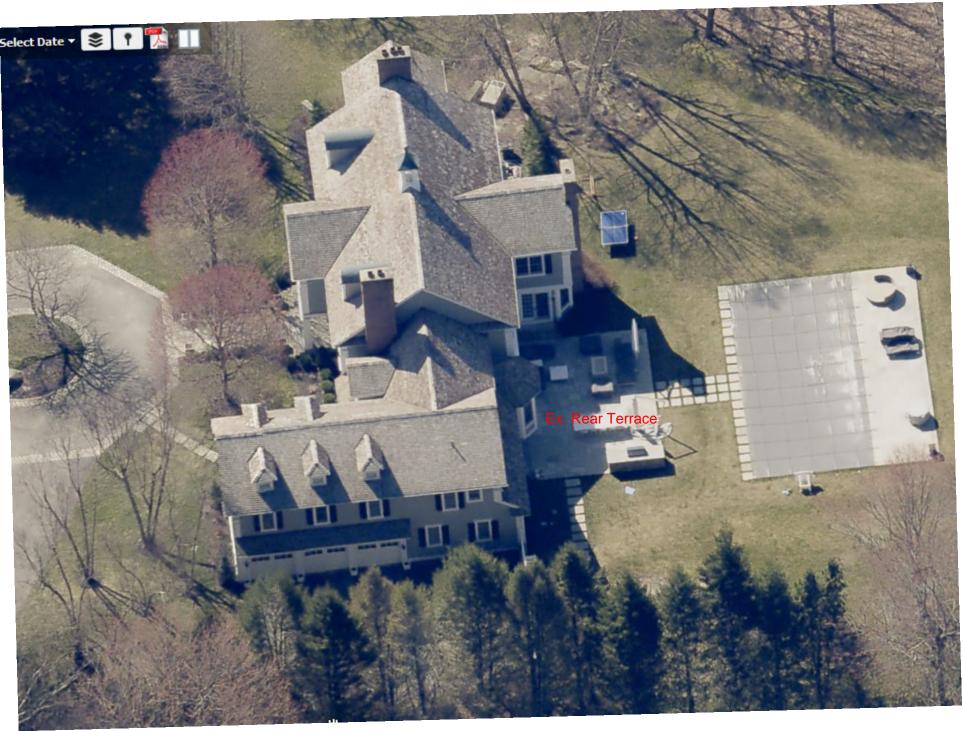

DRAWING LIST:

- TITLE SHEET& LIST OF DRAWINGS T101.00
- SP-1.00 SITE PLAN
- A101.00 PROPOSED FIRST FLOOR, CEILING FRAMING, ELECTRICAL AND PARTIAL FOUNDATION PLAN
- SECOND FLOOR, PROPOSED ROOF & ROOF FRAMING PLAN A102.00
- PROPOSED EXTERIOR ELEVATIONS & SECTION A200.00
- GROSS LAND COVERAGE CALCULATION SP-1.10
- FLOOR AREA CALCULATION F101.00

NOTE:


STERN RESIDENCE PROPOSED REAR PORCH (OVER EX. TERRACE)


9 WRIGHT MILL ROAD, ARMONK, NY

The building addition is designed & comply with the 2020 NYS Residential code & 2020 NYS energy code.

	CLIMATIC AND GEOGRAPHIC DESIGN CRITERIA IN ACCORDANCE WITH THE 2020 NYS RESIDENTIAL CODE TABLE 301.2(1) FOR ZONE 4 (WESTCHESTER COUNTY)												
		WIND DESI	GN		SEISMIC	SUBJ	ECT TO DAMA	GE FROM	WINTER	ICE BARRIER			MEAN ANNUAL
GROUND SNOW LOAD	SPEED (MPH)	TOPOGRAPHIC EFFECTS		WIND-BORNE DEBRIS ZONE		WEATHERING	FROST LINE DEPTH	TERMITES		UNDERLAYMENT REQUIRED	FLOOD HAZARDS	FREEZING INDEX	TEMP
30	115 MPH	NO	YES	NO	В	SEVERE	42"	MODERATE TO HEAVY	15 DAY	YES	4/24/84 REV 11/1/07	1500	48.5°

TEO SIGÜENZA A R C H I T E C T 460 OLD POST ROAD 2A BEDFORD, N. Y. TEL: 914.234.6289 FAX: 914.234.0619 www.teosiguenza.com	10506
GENERAL NOTES: 1. DO NOT SCALE DRAWINGS FOR CONSTRUCTION PURPOSES 2. ALL DIMENSIONS TO BE CHECKED 3. CONTRACTOR IS OBLIGED TO REPORT ALL ERRORS AND OMISSIONS TO THE ARCHITECT	
DATE: REVISION	
PROJECT STERN RESIDENCE PROPOSED REAR PORCH OVER EX. TERRACE 9 WRIGHT MILL ROAD ARMONK, NY	
DRAWING TITLE TITLE SHEET & LIST OF DRAWINGS SEAL	
DATE 2-3-22	
SCALE 3/16" = 1'-0" or as Noted DRAWING NO. T101.00	
PAGE NO.	

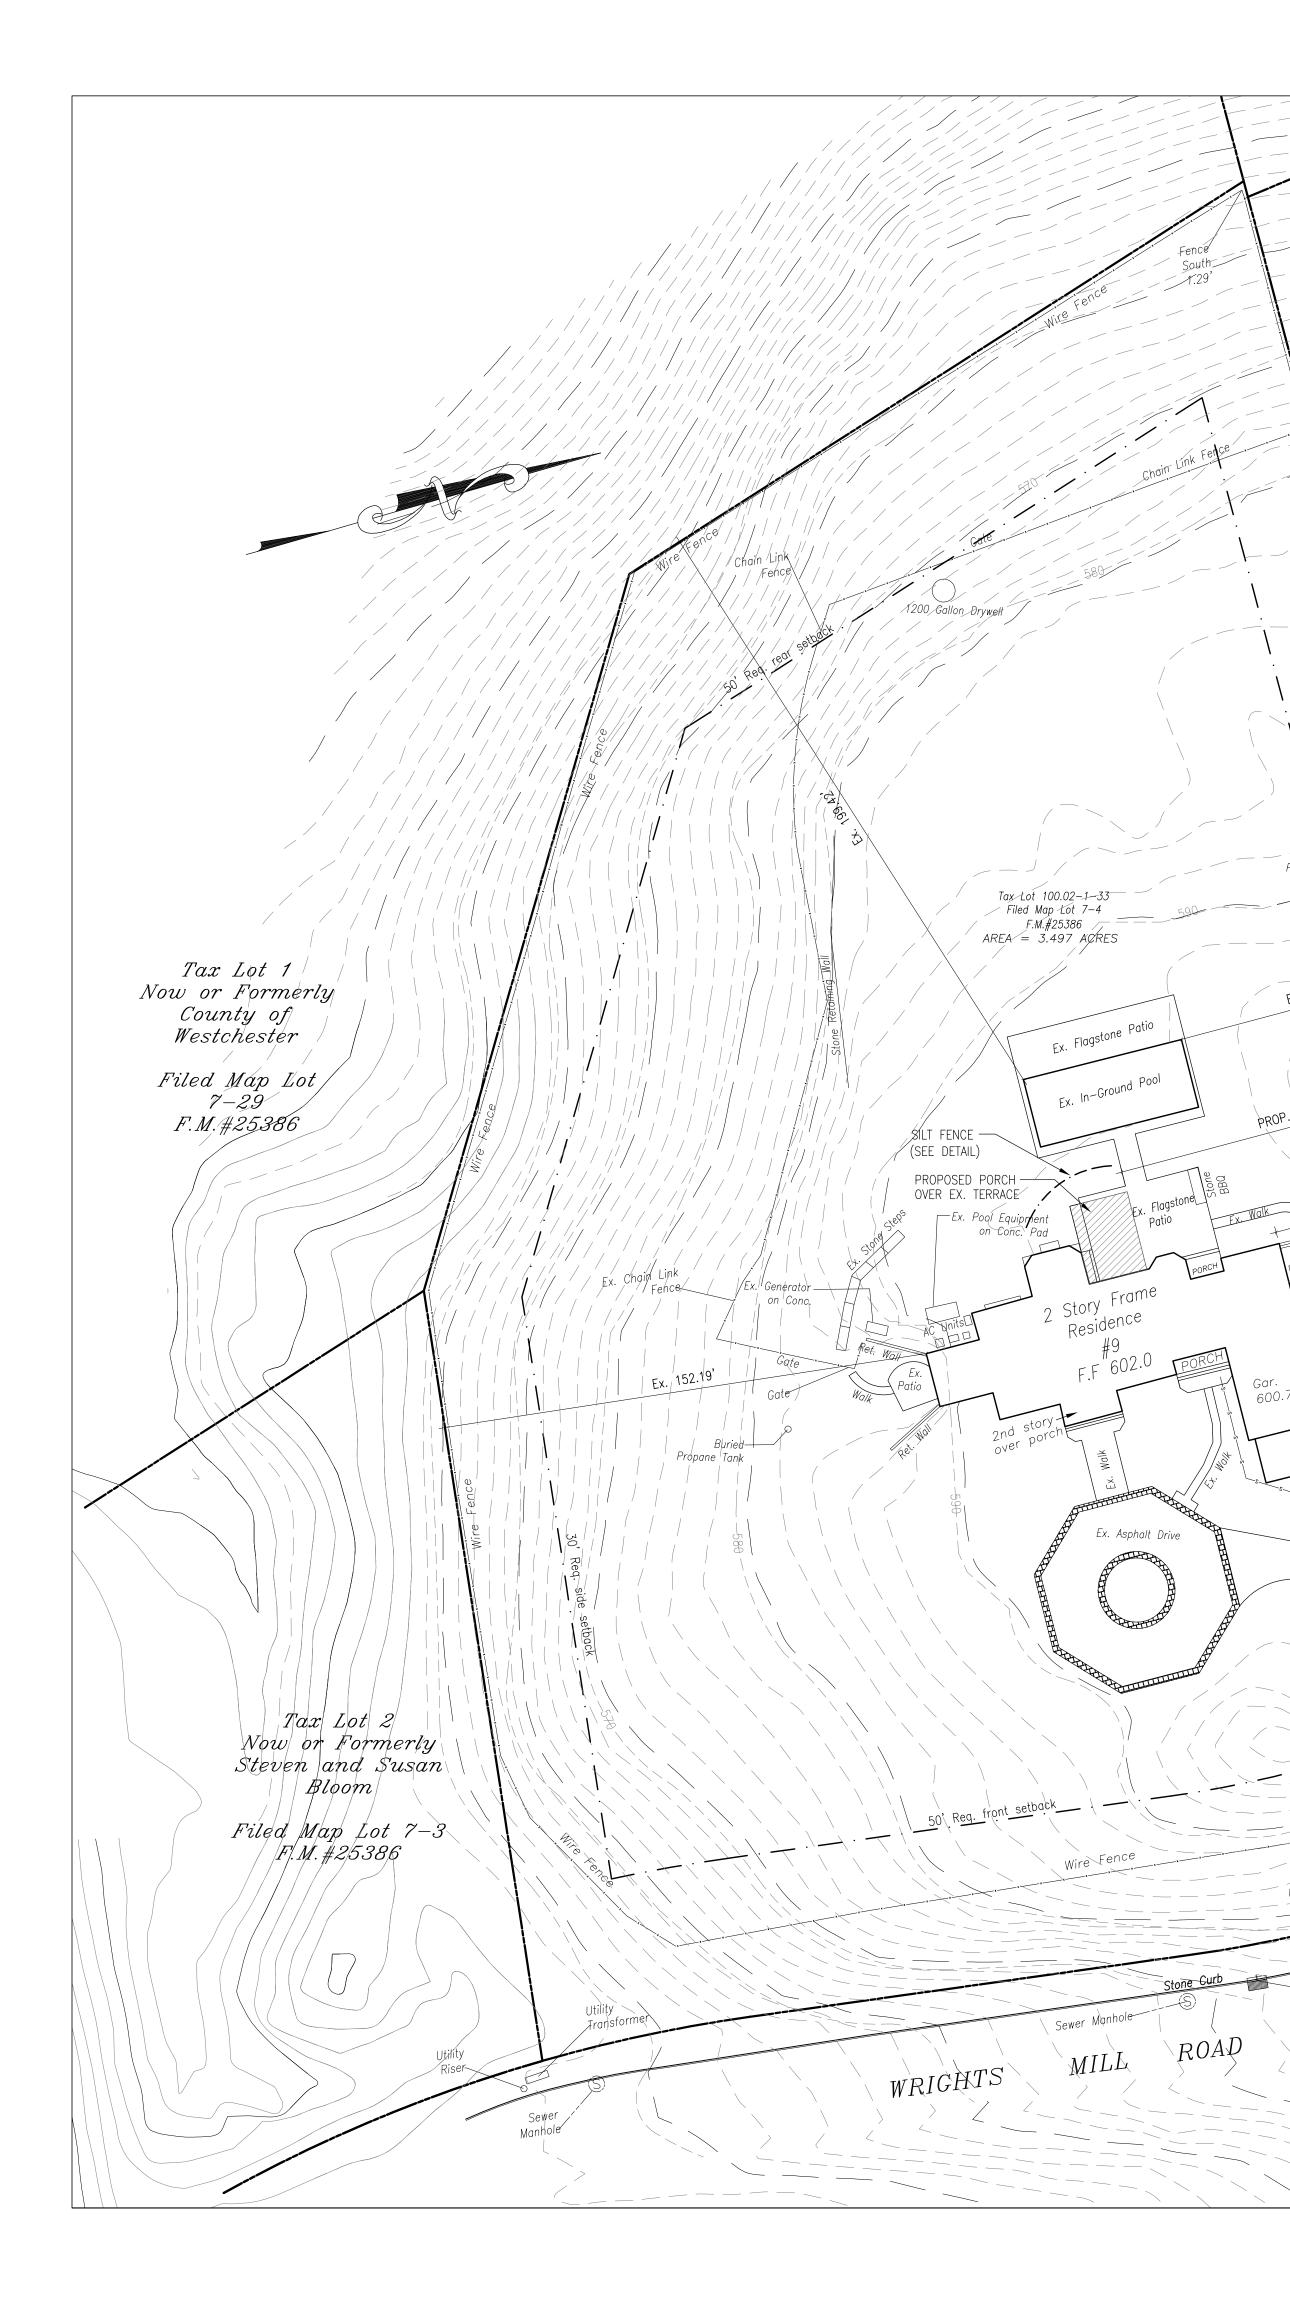

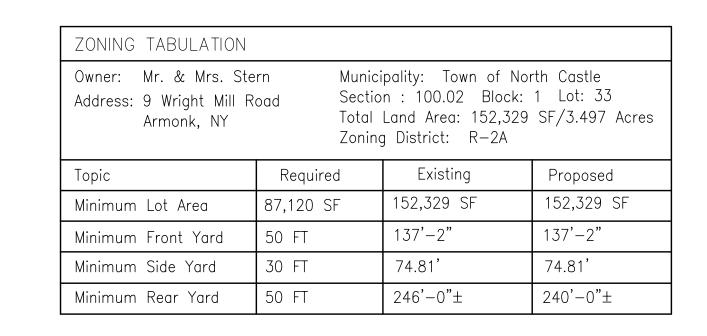

- Tax Lot 34 Now or Formerly Michael Carlinsky

Dénise Lindenauer

Filed Map Lot 1 F.M.#26464

EX. 87.91

Chain[,] Link

EX.

V-Vinyl Stockade

157

·

I side

/ . /se/

Fence

h 1 62

Ex.Well

Ex Aspha


Drive

Stone Masonry

Hility

FX. 75.6

& _ _ _ _

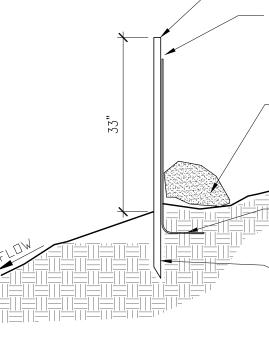

SILT FENCE DETAIL

EROSION CONTROL NO

1. Contractor shall be responsible for erosion control practices. The sedir are to be installed prior to any maj until permanent protection is establis

2. Timely maintenance of sediment of the Contractor. All structures sha at all times. The sediment level in o monitored and sediment removed pr reached or as ordered by the engin shall be inspected on a regular bas proper operation as designed. An ins prior to the start of construction.

3. The locations and the installatio standards shall be as ordered by th accordance with he standards set fo

 All topsoil not to be used for f the work area first and placed in a All topsoil required for final grading limed, fertilized, temporarily seeded

5. Any disturbed areas that will be and not subject to construction traff temporary seeding. Mulch shall be establishment of a temporary cover. and fertilized prior to temporary see

6. All disturbed areas within 500 f be wetted as necessary to provide

7. The Contractor shall keep the re of soil and debris and is responsible necessary during the course of the


8. Sediment and erosion control s the area stabilized when the drainad stabilized by permanent measures.

		207.2
2 Hollow Ria 100.02–1-		
Wright Mill Rd 00.02–1–36 Hollow	Ridge Rd	
	Wright Mill Rd 00.02-1-32	
9 Wright Mill Rd 100.02-1-33 P2 TW	2 Hallock Pl 100.02-1-31	
11 Wright Mill Rd 100.04–3–2 13 Wrig 100.0	ht Mill Rd 04-3-3	
LOCA	TION MAP	
HARDWOOD OR METAL POST 10' O.C. ON DOWNHILL SIDE OF FENCE SEDIMENT CONTROL FABRIC MIRAFI 100X FILT FABRIC OR APPROVED EQUAL	ſER	
MAINTAIN FENCE BY REMOVING SILT BUILDUP NECESSARY	AS	
EMBED POST 18"		
TES		
for compliance with all sediment an iment and erosion control practices ajor soil disturbances, and maintain lished.		
at control structures is the responsib all be maintained in good working all sediment traps shall be closely promptly when maximum levels are neer. All sediment control structures isis, and after each heavy rain to in nspection schedule shall be set fort	order s nsure	
on times of the sediment capturing the landscape architect, and in forth per local codes.		
final grading shall be stripped from a stabilized stockpile or fill area. g and stored on site shall be and mulched within 14 days.		
be left exposed more than 21 days affic, shall immediately receive a used if the season prevents the r. Disturbed areas shall be limed		
eeding. feet of an inhabited dwelling shall dust control.		
roadways within the project clear ble for any street cleaning		
e project. structures shall be removed and age area has been properly		
		VAL IS PROPOSED
	Name of the Application: Name & Address of Owner:	STERN RESIDENCE NICOLE STERN 9 WRIGHT MILL ROAD
	Name & Address of Architect: Licensed Professional: and Applicant	ARMONK, NY Teo Siguenza, Architect 460 Old Post Road, Suite 2A Bedford, N.Y. 10506


Name & Address of Survey: TC MERRITTS LAND SURVEYOR

394 Bedford road, Pleasantville, NY 10570

TEO SIGÜENZA A R C H I T E C T 460 OLD POST ROAD 2A BEDFORD, N. Y. TEL: 914.234.6289 FAX: 914.234.0619 www.teosiguenza.com	10506
<u>GENERAL NOTES:</u> 1. DO NOT SCALE DRAWINGS FOR CONSTRUCTION PURPOSES 2. ALL DIMENSIONS TO BE CHECKED 3. CONTRACTOR IS OBLIGED TO REPORT ALL ERRORS AND OMISSIONS TO THE ARCHITECT	
DATE: REVISION	
PROJECT STERN RESIDENCE PROPOSED REAR PORCH OVER EX. TERRACE 9 WRIGHT MILL ROAD ARMONK, NY	
DRAWING TITLE SITE PLAN SEAL	-
DATE 2-4-22	
SCALE $3/16" = 1'-0"$ or as Noted DRAWING NO. $SP-1.00$	
PAGE NO.	-

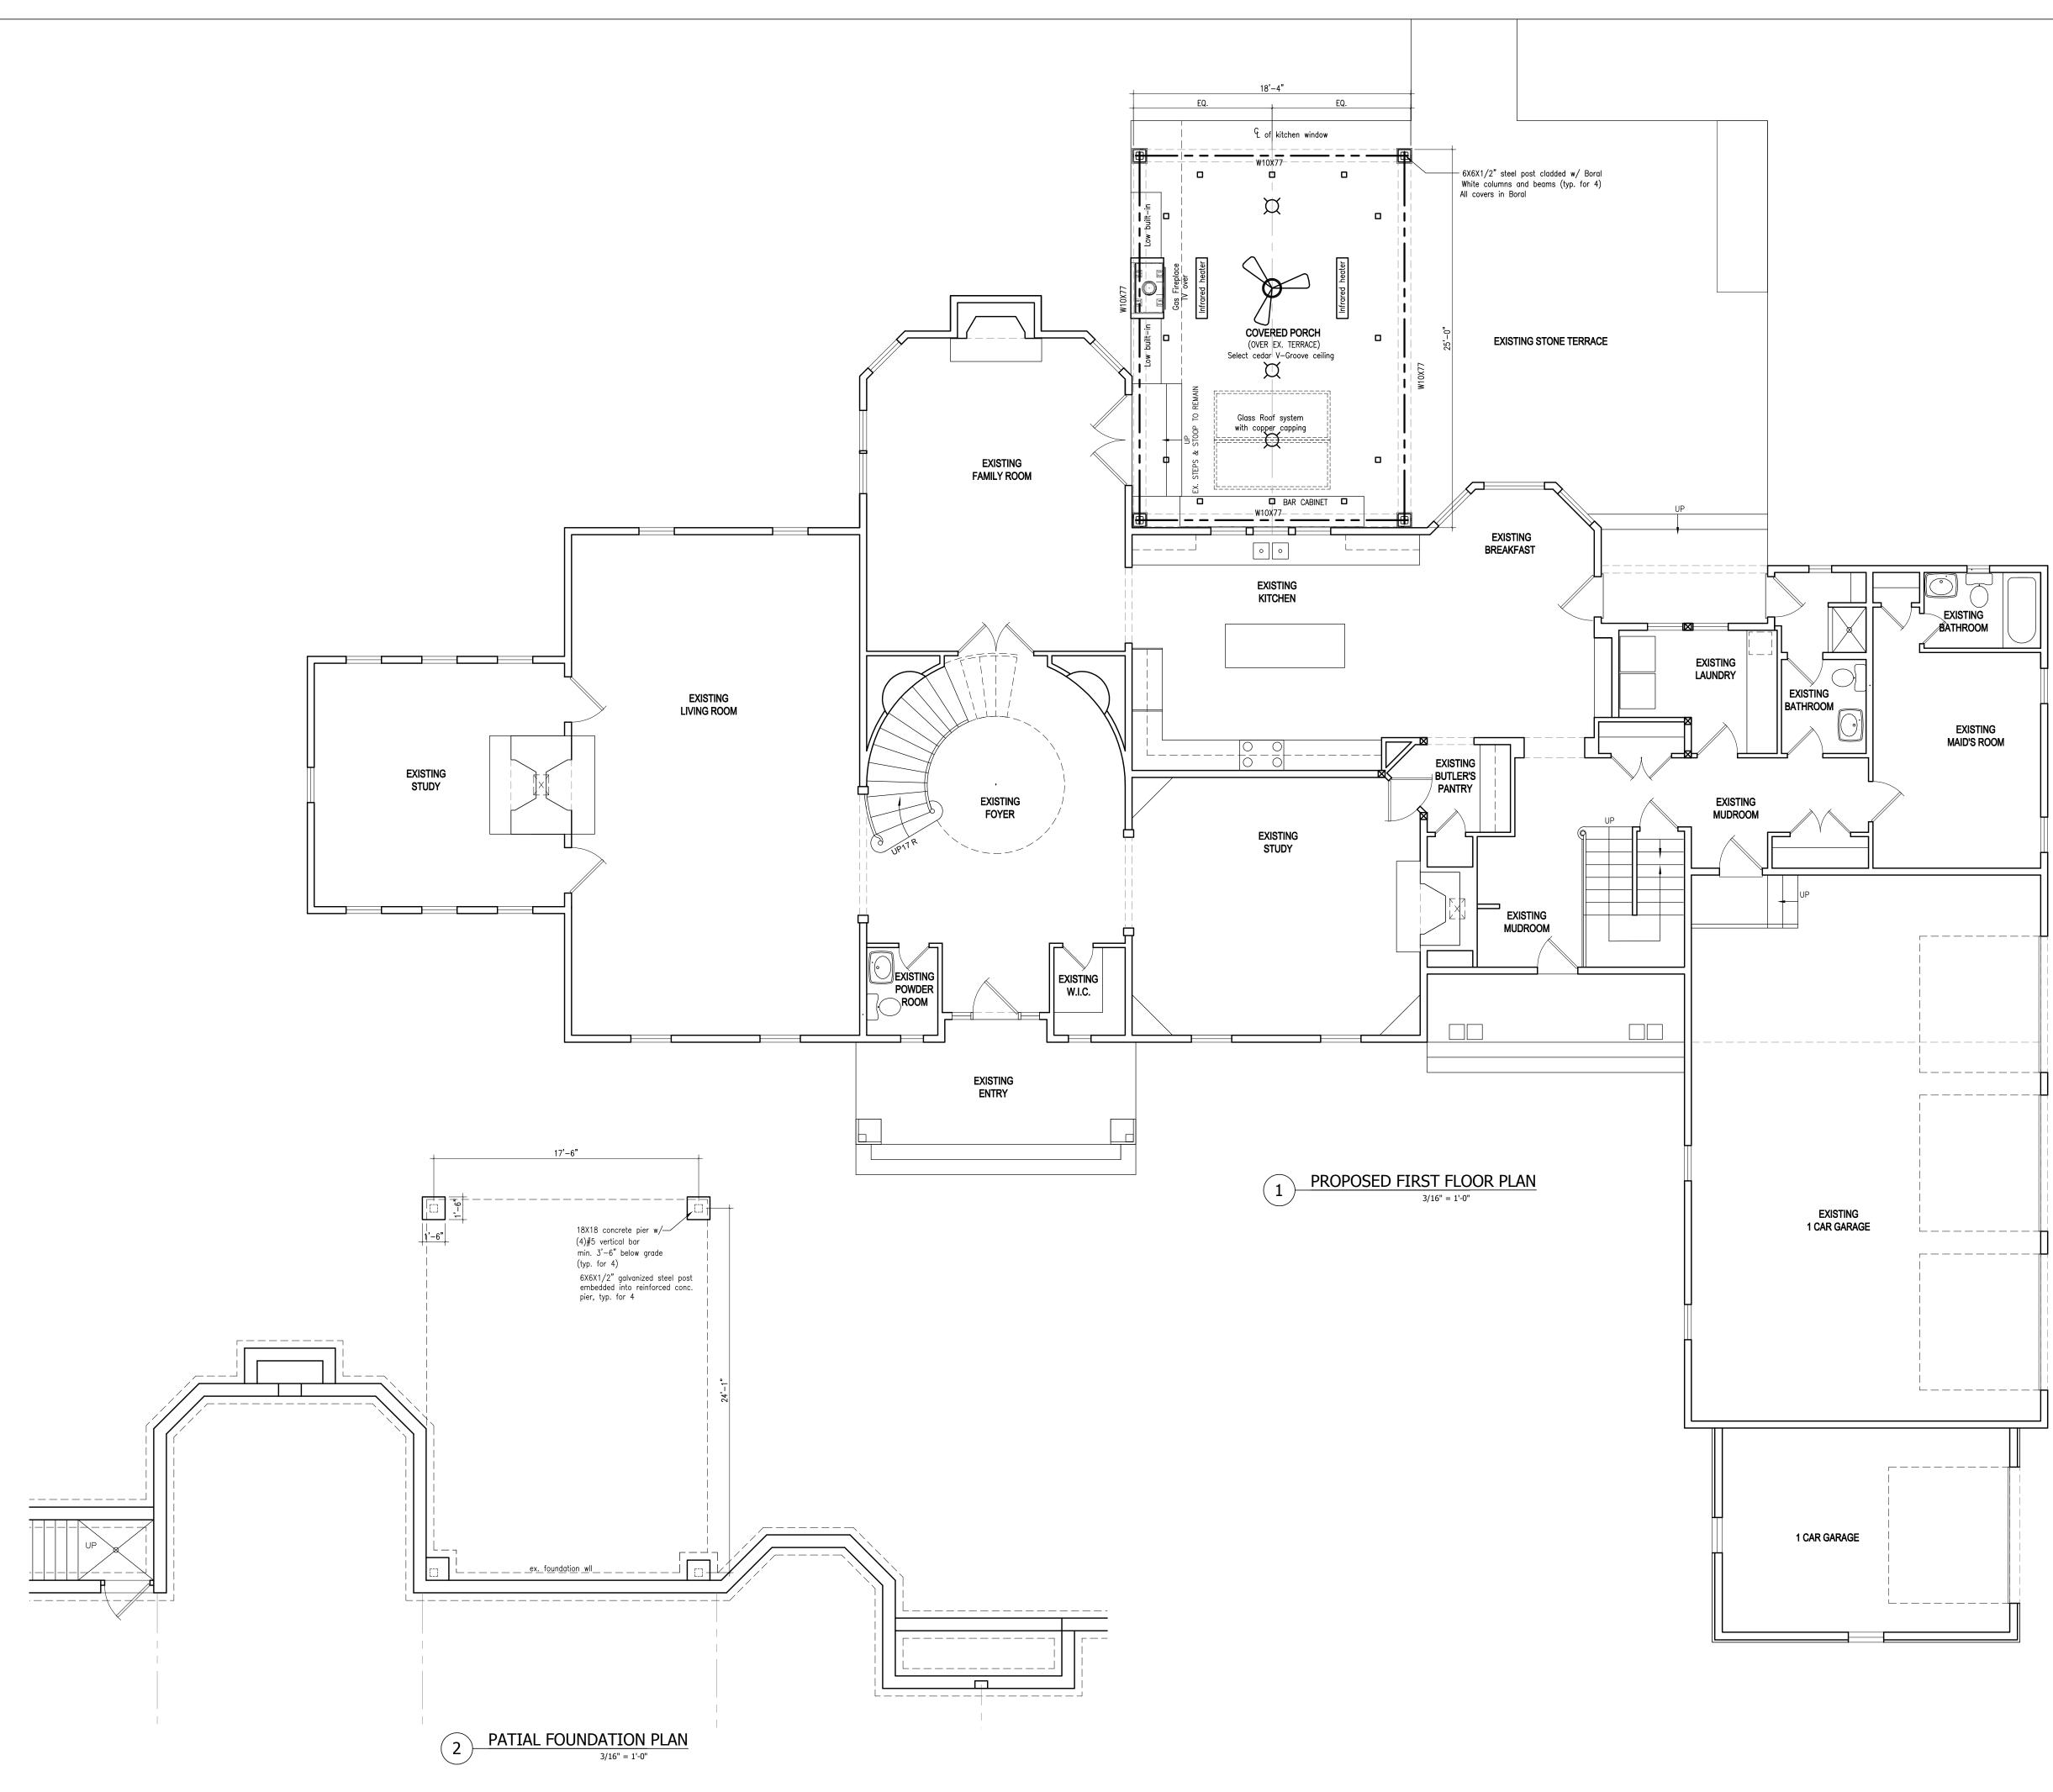

TEO SIGÜENZA A R C H I T E C T 460 OLD POST ROAD 2A BEDFORD, N. Y. TEL: 914.234.6289 FAX: 914.234.0619 www.teosiguenza.com	10506
GENERAL NOTES: 1. DO NOT SCALE DRAWINGS FOR CONSTRUCTION PURPOSES 2. ALL DIMENSIONS TO BE CHECKED 3. CONTRACTOR IS OBLIGED TO REPORT ALL ERRORS AND OMISSIONS TO THE ARCHITECT	
DATE: REVISION	
PROJECT STERN RESIDENCE PROPOSED REAR PORCH OVER EX. TERRACE 9 WRIGHT MILL ROAD ARMONK, NY	
DRAWING TITLE PROPOSED FIRST FLOOR, CEILING FRAMING, ELECTRICAL & PARTIAL FOUNDATION PLAN SEAL SEAL	
DATE 2-3-22	
SCALE 3/16" = 1'-0" or as Noted DRAWING NO. A101.00	
PAGE NO.	

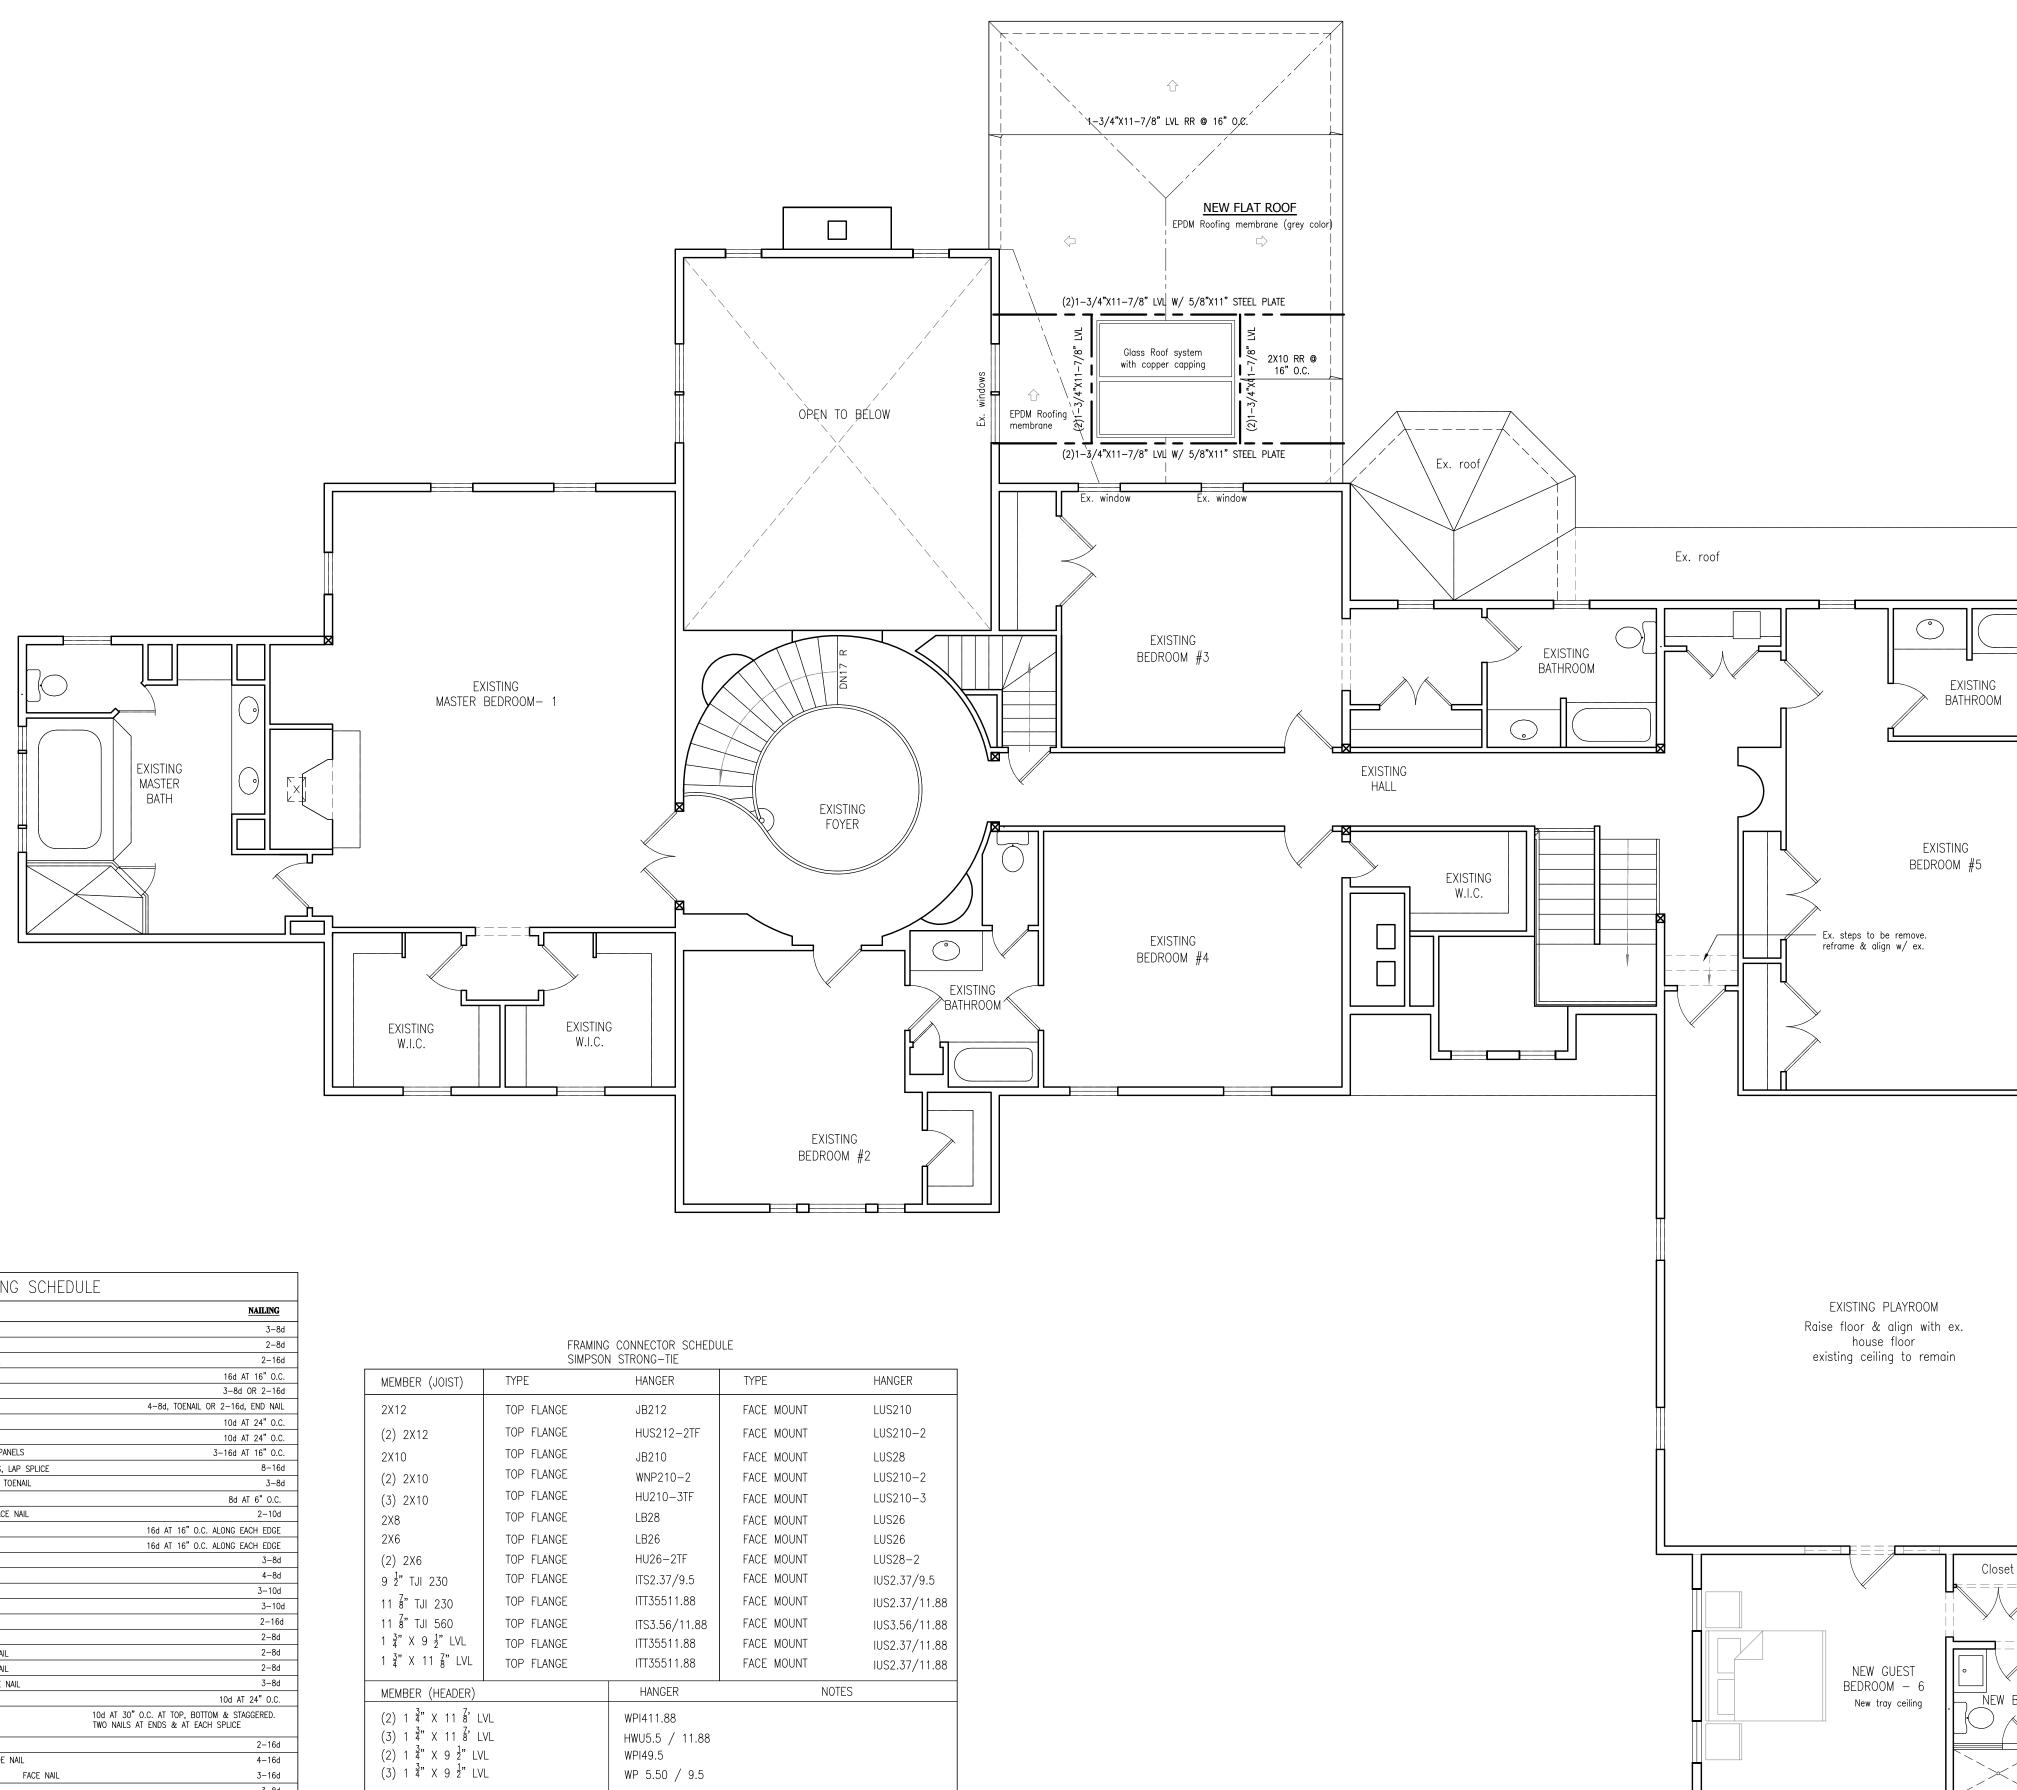

NAILING SCHED	ULE
CONNECTION	NAILING
1. JOIST TO SILL OR GIRDER, TOENAIL	3–8d
2. 1"x6" SUB-FLOOR OR LESS TO EACH JOIST, FACE NAIL	2-8d
3. 2" SUB-FLOOR TO JOIST GIRDER, BLIND AND FACE NAIL	2–16d
4. SOLE PLATE TO JOIST BLOCKING, TYP. FACE NAIL	16d AT 16" O.C.
5. TOP PLATE TO STUD, END NAIL	3-8d OR 2-16d
6. STUD TO SOLE PLATE, TOE NAIL	4-8d, TOENAIL OR 2-16d, END NAIL
7. DOUBLE STUDS, FACE NAIL	10d AT 24" O.C.
8. DOUBL TOP PLATES, TYP. FACE NAIL	10d AT 24" O.C.
9. SOLE PLATE TO JOIST OR BLOCKING, AT BRACED WALL PANELS	3-16d AT 16" O.C.
10. DOUBLE TOP PLATES, MIM. 25" OFFFSET OF END JOINTS, LAP SPLICE	8–16d
11. BLOCKING BETWEEN JOISTS OR RAFTERS TO TOP PLATE, TOENAIL	3–8d
12. RIM JOIST TO TOP PLATE, TOENAIL	8d AT 6" O.C.
13. TOP PLATES, LAPS AT CORNERS AND INTERSECTIONS, FACE NAIL	2-10d
14. BUILT-UP HEADER, TWO PIECES W/ 1/2" SPACER	16d AT 16" O.C. ALONG EACH EDGE
15. CONTINUOUS HEADER, TWO PIECES	16d AT 16" O.C. ALONG EACH EDGE
16. CEILING JOISTS TO PLATE, TOENAIL	3-8d
17. CONTINUOUS HEADER TO STUD, TOENAIL	4-8d
18. CEILING JOISTS, LAPS OVER PARTITIONS, FACE NAIL	3–10d
19. CEILING JOISTS TO PARALLEL RAFTERS , FACE NAIL	3–10d
20. RAFTER TO PLATE, TOENAIL	2-16d
21. 1" BRACE TO EACH STUD AND PLATE, FACE NAIL	2-8d
22. 1"x6" SHEATHING OR LESS TO EACH BEARING, FACE NAIL	2-8d
23. 1"x8" SHEATHING OR LESS TO EACH BEARING, FACE NAIL	2-8d
24. WIDER THAN 1"x8" SHEATHING TO EACH BEARING, FACE NAIL	3-8d
25. BUILT-UP CORNER STUDS	10d AT 24" O.C.
26. BUILT- UP GIRDERS & BEAMS, 2" LUMBER LAYERS	10d AT 30" O.C. AT TOP, BOTTOM & STAGGERED. TWO NAILS AT ENDS & AT EACH SPLICE
27. 2" PLANKS, AT EACH BEARING	2-16d
28. ROOF RAFTERS TO RIDGE, VALLEY OR HIP RAFTERS: TOE NAIL	4–16d
FACE NAIL	3–16d
29. RAFTERS TIES TO RAFTERS, FACE NAIL	3-8d
30. COLLAR TIE TO RAFTER, FACE NAIL	3-10d
31. RIM BOARD TO JOIST, FACE NAIL	3-10d

	FRAMING CONNECTOR SCHEDULE SIMPSON STRONG-TIE					
MEMBER (JOIST)	TYPE	HANGER	TYPE			
2X12	TOP FLANGE	JB212	FACE MOUNT			
(2) 2X12	TOP FLANGE	HUS212-2TF	FACE MOUNT			
2X10	TOP FLANGE	JB210	FACE MOUNT			
(2) 2X10	TOP FLANGE	WNP210-2	FACE MOUNT			
(3) 2X10	TOP FLANGE	HU210-3TF	FACE MOUNT			
2X8	TOP FLANGE	LB28	FACE MOUNT			
2X6	TOP FLANGE	LB26	FACE MOUNT			
(2) 2X6	TOP FLANGE	HU26-2TF	FACE MOUNT			
9 ¹ / ₂ " TJI 230	TOP FLANGE	ITS2.37/9.5	FACE MOUNT			
11 ⁷ / ₈ " TJI 230	TOP FLANGE	ITT35511.88	FACE MOUNT			
11 ⁷ / ₈ " TJI 560	TOP FLANGE	ITS3.56/11.88	FACE MOUNT			
$1 \frac{3}{4}$ " X 9 $\frac{1}{2}$ " LVL	TOP FLANGE	ITT35511.88	FACE MOUNT			
1 3 " X 11 7 " LVL	TOP FLANGE	ITT35511.88	FACE MOUNT			
MEMBER (HEADER)	L	HANGER				
(2) 1 ³ / ₄ " X 11 ⁷ / ₈ L		WPI411.88				
(3) 1 $\frac{3}{4}$ " X 11 $\frac{7}{8}$ " L		HWU5.5 / 11.88				
(2) $1 \frac{3}{4}$ " X 9 $\frac{1}{2}$ " LV		WPI49.5				
(3) 1 $\frac{3}{4}$ " X 9 $\frac{1}{2}$ " LV	Ĺ	WP 5.50 / 9.5				

NOTE: CONNECTIONS SHOWN ARE MINIMUM REQUIREMENTS UON ON PLAN. IF CONFLICT EXISTS BETWEEN TABLE SHOWN, ARCHITECTURAL DRAWINGS, ENGINEERED LUMBER MANUFACTURE SPECIFICATIONS OR LOCAL BUILDING CODE USE MOST STRINGENT. ALL NAILS USED IN LOCATIONS EXPOSED TO WEATHER TO BE CORROSION RESISTANT.

WOO	WOOD POST LEGEND						
	POST ABOVE						
	POST BELOW						
	POST ABOVE & BELOW						
	3- 2x POST						
	6X6 PARALLAM POST (otherwise noted)						
	STEEL COL.						


<u>PLAN NOTES:</u>


- 1. ALL FRAMING LUMBER SHALL BE DRY (19% MAXIMUM MOISTURE CONTENT) DOUGLAS FIR NO.2 GRADE WITH A BASE VÁLUE FB OF 825 PSI.
- 2. ALL OPENINGS SHALL BE FRAMED WITH DOUBLE MEMBERS UNLESS SHOWN OTHERWISE.
- 3. DO NOT SCALE DRAWINGS.
- 4. ALL POSTS AND JAMBS TO BE FULLY SPIKED.
- 5. PROVIDE 2x4 BLOCKING UNDER ALL POSTS AND JAMBS OF WINDOW AND DOOR OPENINGS EXCEEDING 6'-0" IN WIDTH.
- 6. ALL LAMINATED VENEER LUMBER AND COMPOSITE LUMBER SHALL BE TRUSS JOISTS, MICROLAMS OR PARALLAMS AS PRODUCED BY TRUSS JOIST MACMILLAN, OR AN APPROVED EQUIVALENT.
- 7. ALL METAL FRAMING CONNECTIONS SHALL BE FULLY NAILED AS PER MANUFACTURER'S RECOMMENDATIONS.
- 8. CONTRACTOR TO SUBMIT FOR REVIEW EXACT CONNECTION MANUFACTURER'S DATA SHEETS FOR EACH TYPE OF CONNECTION SPECIFIED.
- 9. FOR EAVE, OVERHANG AND OTHER EXTERNAL ROOF FEATURES SEE ARCHITECTURAL DRAWINGS.
- 10. CONTRACTOR TO SUBMIT SHOP DRAWINGS (1 SEPIA, 2 PRINTS) INCLUDING COMPLETE DETAILS FOR FABRICATION AND ASSEMBLY OF STRUCTURAL STEEL, INDICATE WELDS BY STANDARD SYMBOLS. SHOW SIZE, LENGTH AND TYPE OF WELDS, CONNECTIONS SHALL BE DESIGNED FOR A36 STEEL, E70XX ELECTRODES.

TEO SIGÜENZA A R C H I T E C T 460 OLD POST ROAD 2A BEDFORD, N. Y. TEL: 914.234.6289 FAX: 914.234.0619 www.teosiguenza.com	10506
GENERAL NOTES: 1. DO NOT SCALE DRAWINGS FOR CONSTRUCTION PURPOSES 2. ALL DIMENSIONS TO BE CHECKED 3. CONTRACTOR IS OBLIGED TO REPORT ALL ERRORS AND OMISSIONS TO THE ARCHITECT	
DATE: REVISION	
PROJECT STERN RESIDENCE PROPOSED REAR PORCH OVER EX. TERRACE 9 WRIGHT MILL ROAD ARMONK, NY DRAWING TITLE	
SECOND FLOOR PLAN & PROPOSED ROOF & FRAMING PLAN SEAL	
DATE 2-3-22 SCALE 3/16" = 1'-0" or as Noted	
DRAWING NO. A102.00 PAGE NO.	

		EX. ROOF	
		Ţ	
			2 PROPOSED RIGHT S



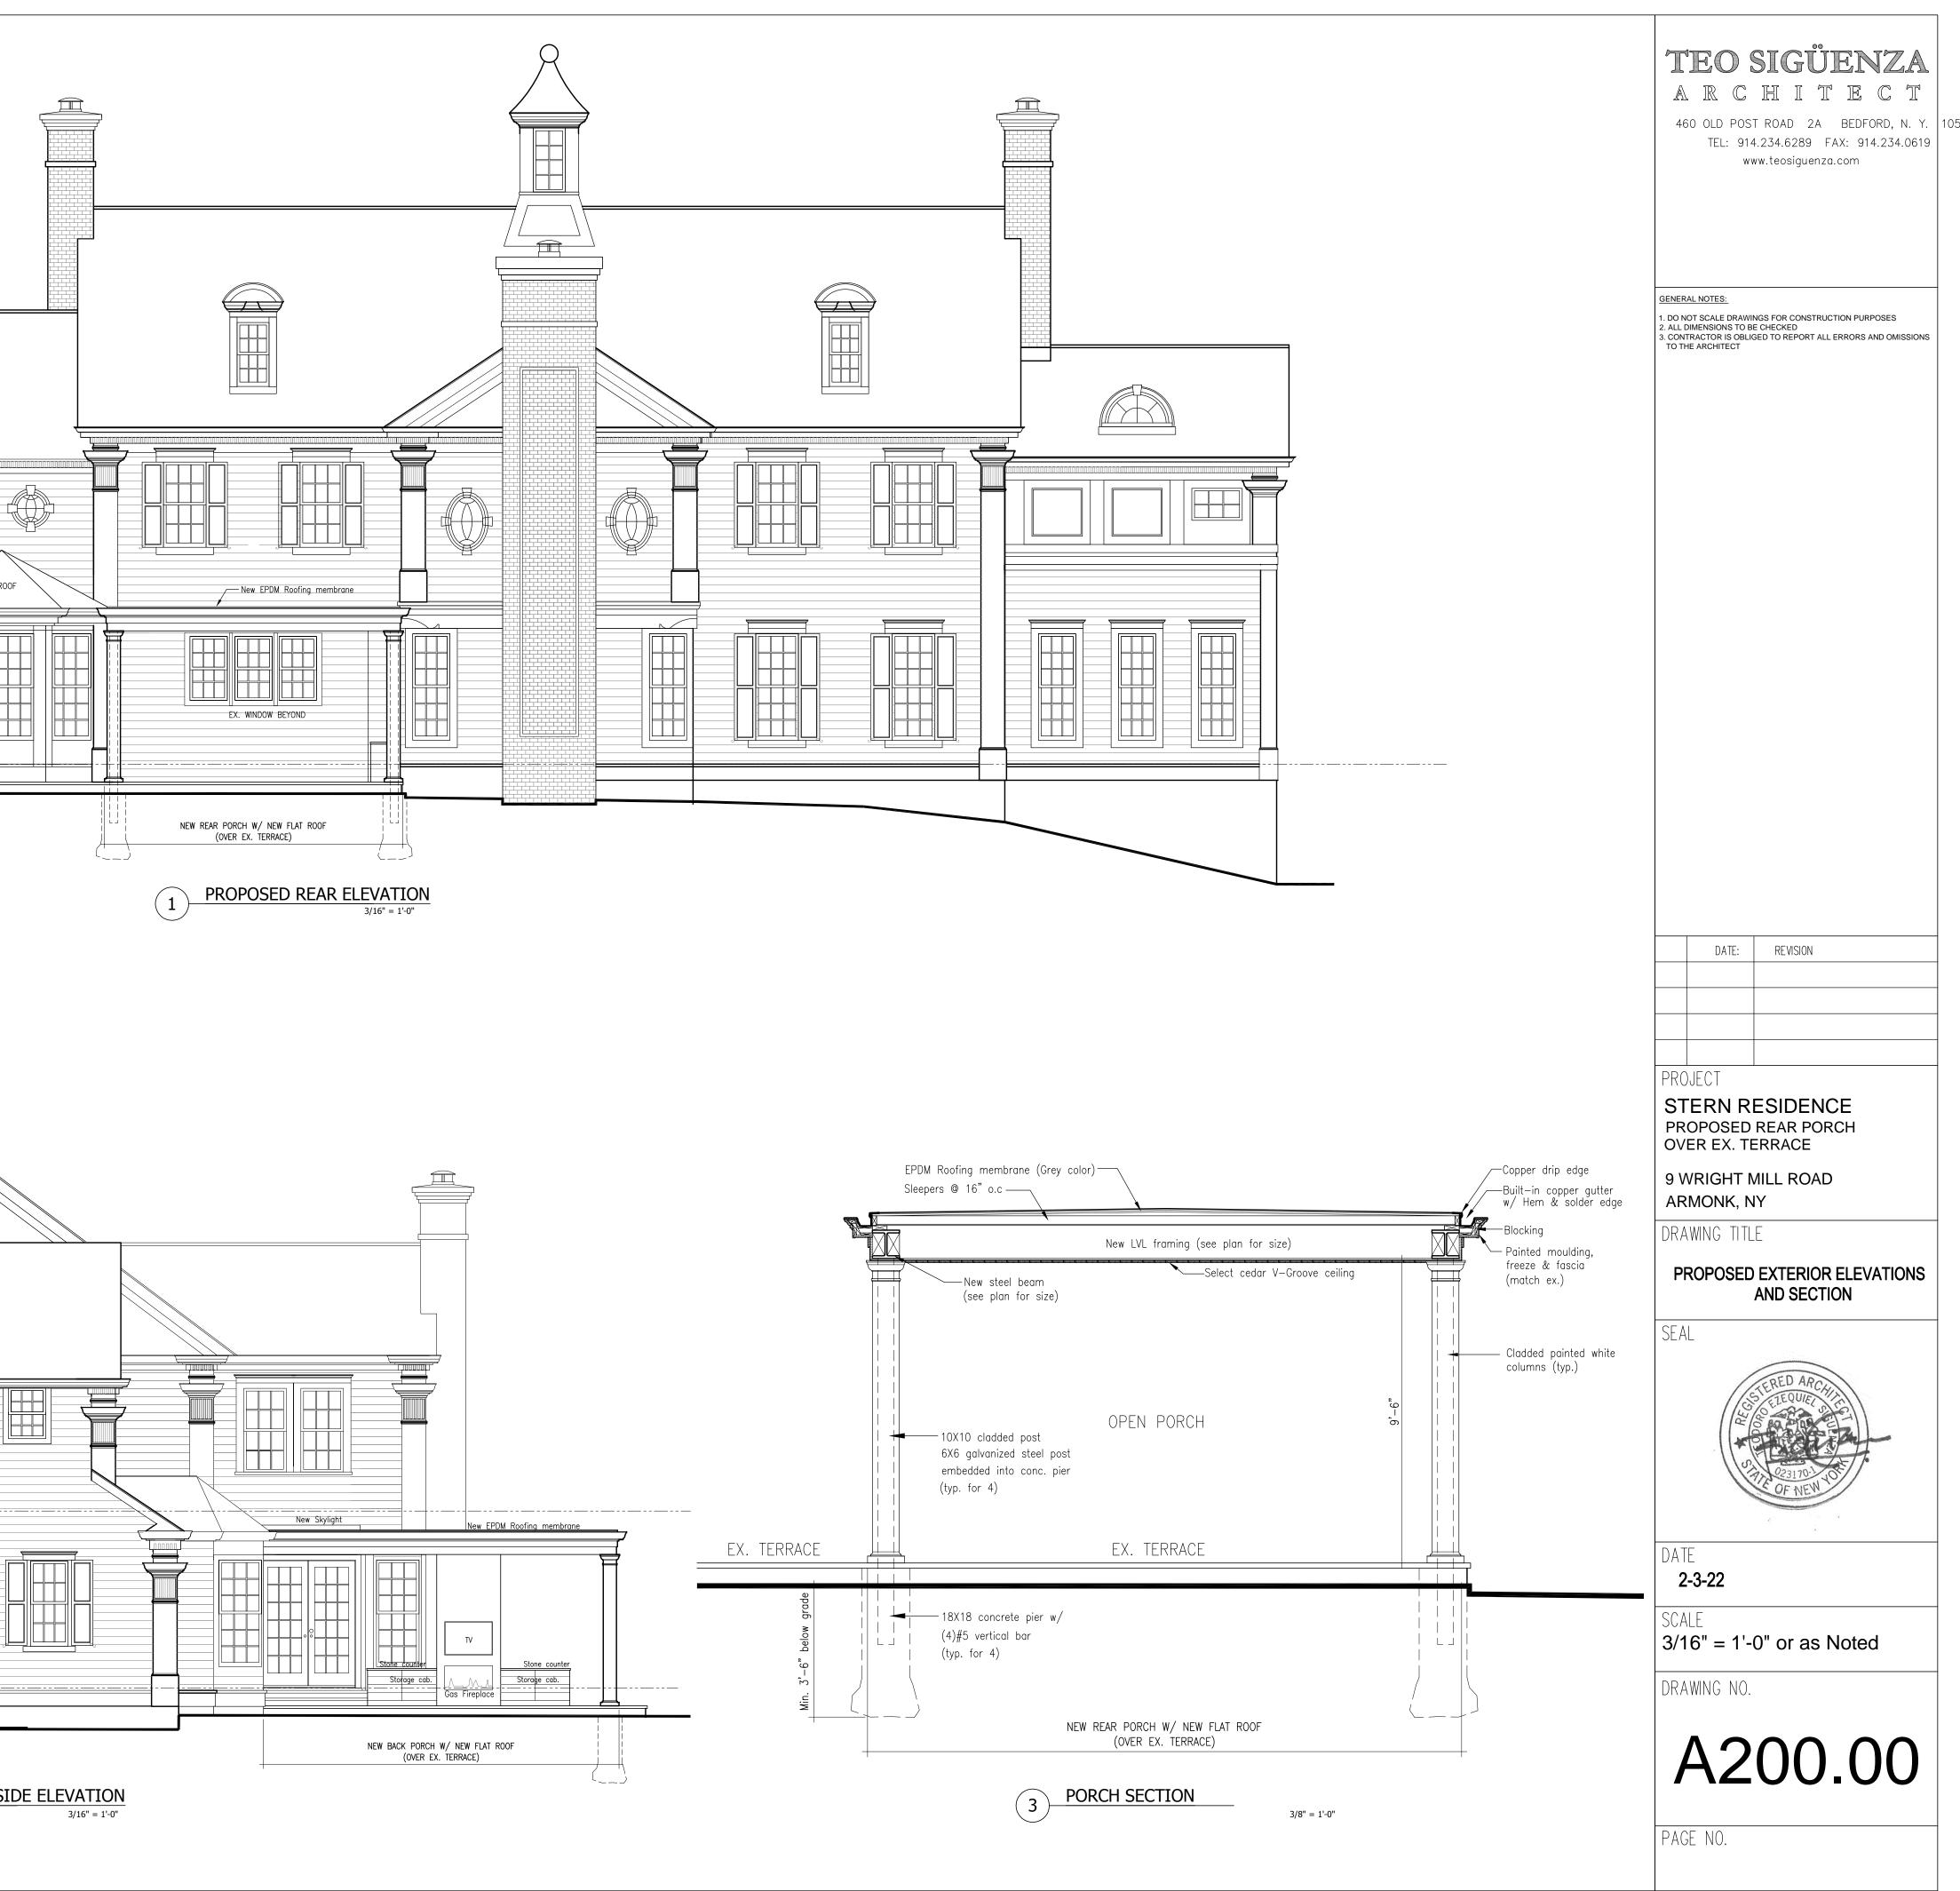

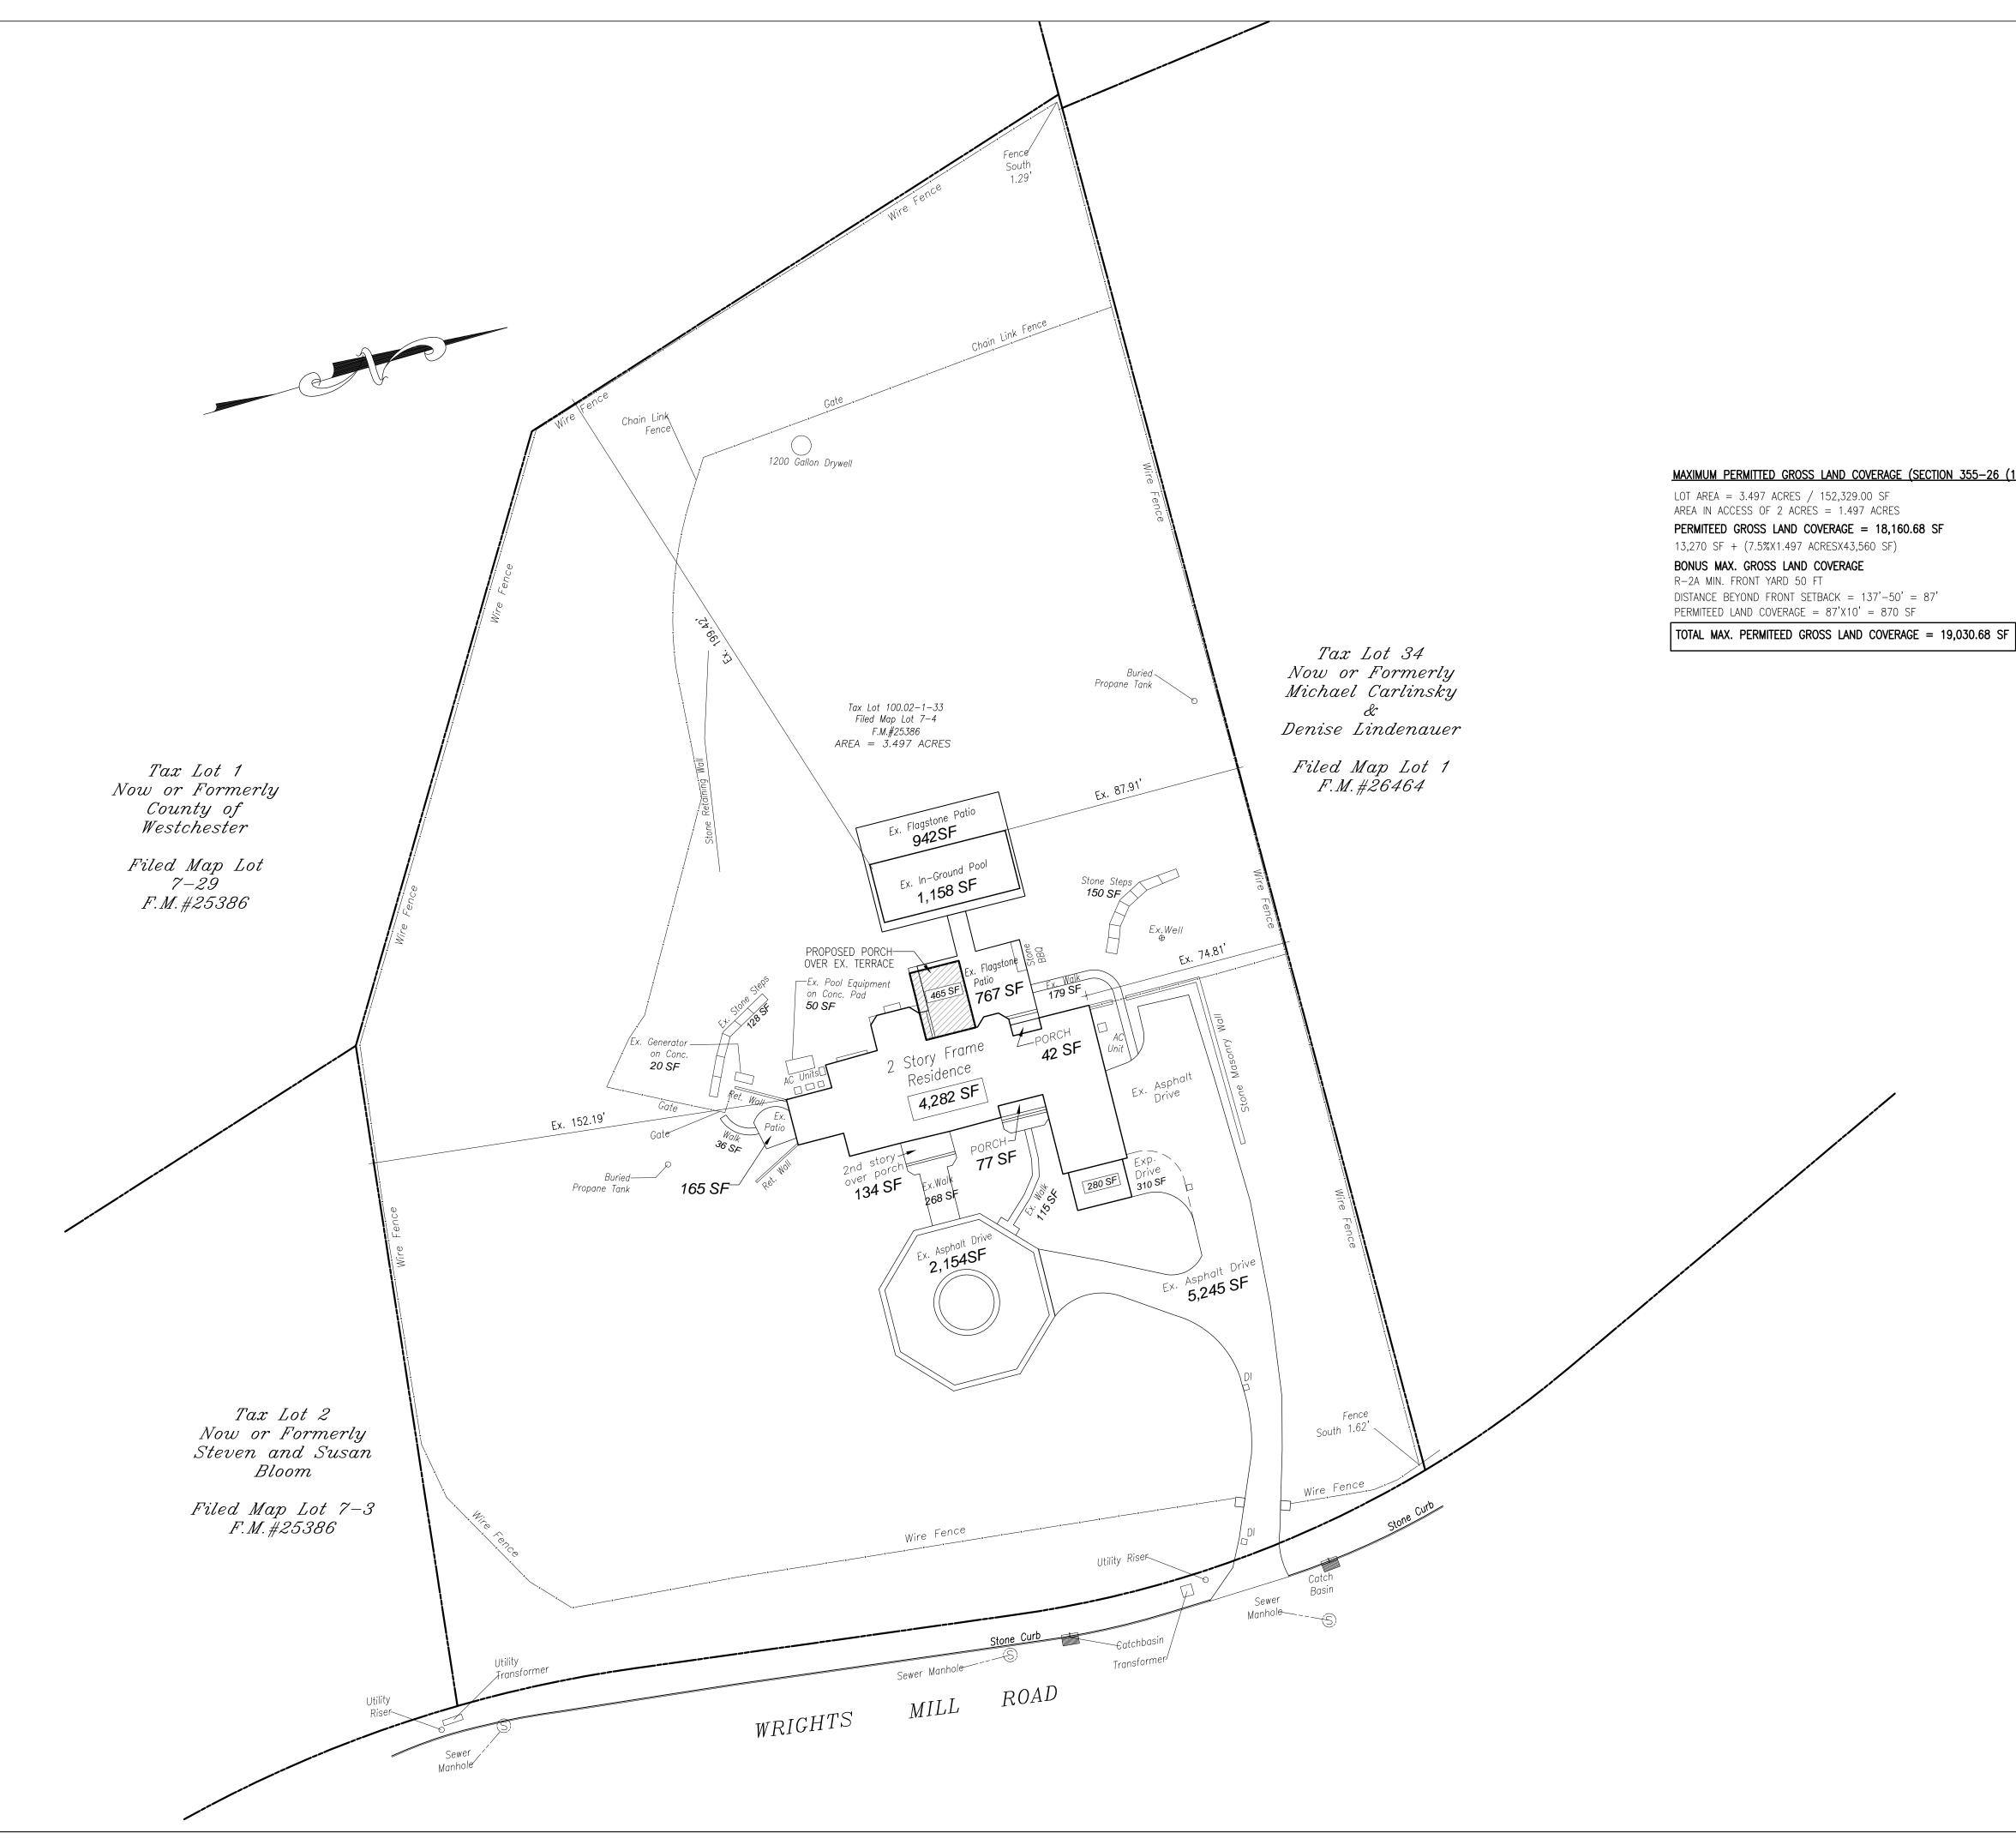

MAXIMUM PERMITTED GROSS LAND COVERAGE (SECTION 355-26 (1)) LOT AREA = 3.497 ACRES / 152,329.00 SF AREA IN ACCESS OF 2 ACRES = 1.497 ACRES PERMITEED GROSS LAND COVERAGE = 18,160.68 SF 13,270 SF + (7.5%X1.497 ACRESX43,560 SF) **BONUS MAX. GROSS LAND COVERAGE** R—2A MIN. FRONT YARD 50 FT DISTANCE BEYOND FRONT SETBACK = 137'-50' = 87' PERMITEED LAND COVERAGE = 87'X10' = 870 SF

TEO SIGÜENZA A R C HI I T E C T 460 OLD POST ROAD 2A BEDFORD, N. Y. TEL: 914.234.6289 FAX: 914.234.0619 www.teosiguenza.com	10506
GENERAL NOTES: 1. DO NOT SCALE DRAWINGS FOR CONSTRUCTION PURPOSES 2. ALL DIMENSIONS TO BE CHECKED 3. CONTRACTOR IS OBLIGED TO REPORT ALL ERRORS AND OMISSIONS TO THE ARCHITECT	
DATE: REVISION	
PROJECT STERN RESIDENCE PROPOSED REAR PORCH OVER EX. TERRACE 9 WRIGHT MILL ROAD ARMONK, NY	
DRAWING TITLE GROSS LAND COVERAGE CALCULATION SEAL	-
DATE 2-3-22 SCALE	
3/16" = 1'-0" or as Noted DRAWING NO. SP-1.10 PAGE NO.	

FXISTING LAND COVERAGE

DELETED TERRACE

TOTAL PROPOSED


EXISTING LAND COVERAGE				
PRINCIPAL BUIDLING	4,562.0 SF			
PORCHES	253.0 SF			
DRIVEWAY, PARKING & WALKWAYS	8,307.0 SF			
TERRACES & STEPS	2,570.0 SF			
TENNIS COURT, POOL & PADS	1,228.0 SF			
TOTAL EXISTING	16,920.0 SF			
PROPOSED LAND COVERAGE				
REAR PORCH	465.0 SF			

TOTAL LAND COVERAGE

TOTAL EXISTING	16,920.0 SF		
TOTAL PROPOSED	55.0 SF		
TOTAL LAND COVERAGE	16,975 SF < 19,030.68 SF		

-410.0 SF

55.0 SF

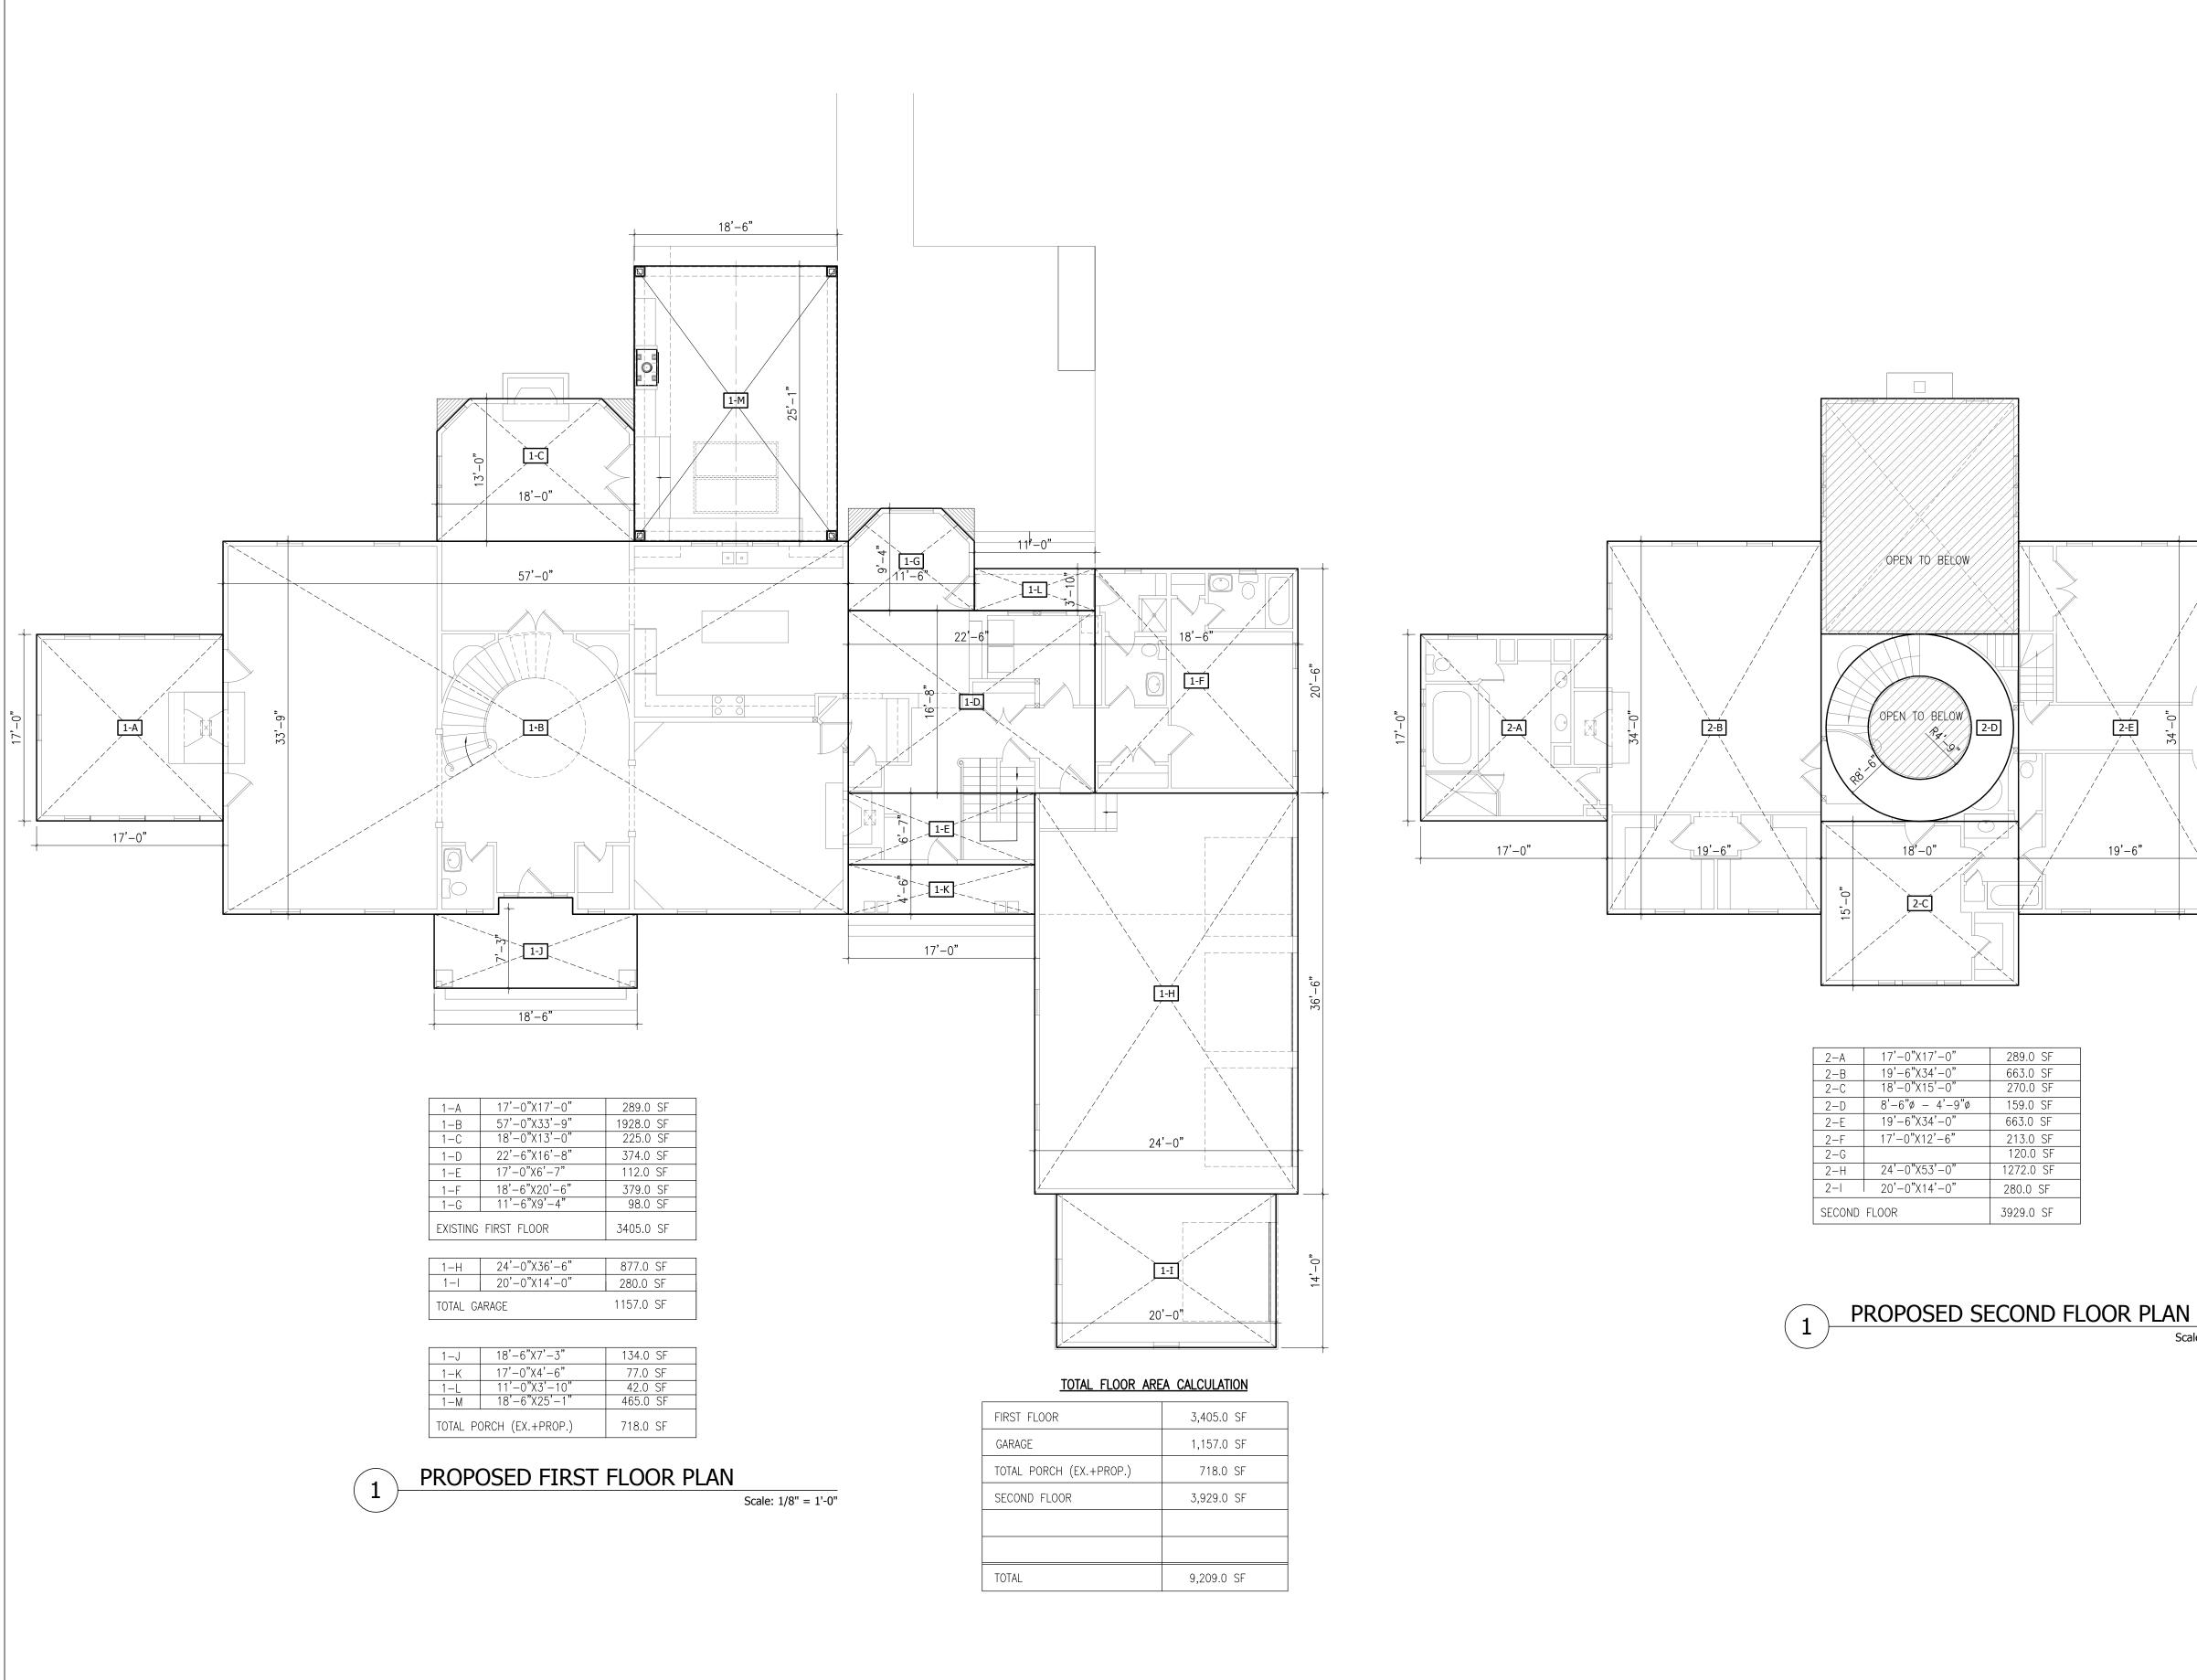

_OOR	3,405.0 SF
	1,157.0 SF
ORCH (EX.+PROP.)	718.0 SF
FLOOR	3,929.0 SF
	9,209.0 SF

