

Section I- PROJECT

TOWN OF NORTH CASTLE

WESTCHESTER COUNTY 17 Bedford Road Armonk, New York 10504-1898

RESIDENTIAL PROJECT REVIEW COMMITTEE Adam R. Kaufman AICP, Chair

ADDRESS: 6 FOR RIDGE POUD

Telephone: (914) 273-3000 x 43

Fax: (914) 273-3554 www.nortcastleny.com

RESIDENTIAL PROJECT REVIEW COMMITTEE (RPRC) APPLICATION

Section III- DESCRIPTION OF WORK:
GARAGE ADIDITION WITH WASTER BEDROOM, CLOSET & BATHROOM.
NEW MUDROOM, KITCHEN PENOVATION, NEW FIRE PLACE, INTÉRIOR
Section III- CONTACT INFORMATION:
APPLICANT: MICHAEL PICCIPILIO ARCHITETURE PUL ADDRESS: 345 KAPAL STREPT SUR: 703 VILLERIUM HIRATIC NIL 10588
PHONE: 368-9838 MOBILE: EMAIL: MICHAR CAPICIPAL ABOUTER. COM
PROPERTY OWNER:
ADDRESS: 6 FOX RIDGE ROAD
PHONE: MOBILE: 917-716-8176EMAIL: DENSEW @ 6 MAL. COM
PROFESSIONAL: SAME AS APPLICANT
ADDRESS:
PHONE:MOBILE:
EMAIL:
Section IV- PROPERTY INFORMATION:
Zone: PISA Tax ID (lot designation) [02.01-1-63



Town of North Castle Residential Project Review Committee

17 Bedford Road Armonk, New York 10504 (914) 273-3542 (914) 273-3554 (fax)

RPRC COMPLETENESS REVIEW FORM

This form represents the standard requirements for a completeness review for all Residential Project Review Committee submissions. Failure to provide all of the information requested will result in a determination that the application is incomplete.

γ,									
Project Name on Plan: Varghese Renovation									
■Initial Submittal □Revised Preliminary									
Street Location: 6 Fox Ridge Road									
Zoning District: R1.5A Property Acreage: 1.563 Tax Map Parcel ID: 102.01-1-63									
Date: 1-20-22									
DEPARTMENTAL USE ONLY									
Date Filed: Staff Name:									
Preliminary Plan Completeness Review Checklist Items marked with a are complete, items left blank are incomplete and must be completed, "NA" means not applicable.									
by a registered architect or professional engineer									
Plan prepared by a registered area. Aerial photo (Google Earth) showing the applicant's entire property and adjacent properties and streets.									
properties and streets 3. Map showing the applicant's entire property and adjacent properties and streets									
1. A locator map at a convenient scale									
The proposed location, use and design of all buildings and structures									
Existing topography and proposed grade elevations									
Location of drives									
Location of drives Location of all existing and proposed site improvements, including drains, culverts, retaining walls and fences									

Page 2
Description of method of water supply and sewage disposal and location of such facilities
10. The name and address of the applicant, property owner(s) if other than the applicant and of the planner, engineer, architect, surveyor and/or other professionals engaged to work
Submission of a Zoning Conformance Table depicting the plan's compliance with the minimum requirements of the Zoning District
2. If a tree removal permit is being sought, submission of a plan depicting the location and graphical removal status of all Town-regulated trees within the proposed area of disturbance. In addition, the tree plan shall be accompanied by a tree inventory includes a unique ID number, the species, size, health condition and removal status of each tree.
3. If a wetlands permit is being sought, identification of the wetland and the 100-foot wetland buffer.
More information about the items required herein can be obtained from the North Castle Planning Department. A copy of the Town Code can be obtained from Town Clerk or on the North Castle homepage: http://www.northcastleny.com/townhall.html
On this date, all items necessary for a technical review of the proposed site plan have been submitted and constitute a COMPLETE APPLICATION.

RPRC COMPLETENESS REVIEW FORM



TOWN OF NORTH CASTLE

WESTCHESTER COUNTY 17 Bedford Road Armonk, New York 10504-1898

PLANNING DEPARTMENT Adam R. Kaufman, AICP Director of Planning

Telephone: (914) 273-3542 Fax: (914) 273-3554 www.northcastleny.com

GROSS LAND COVERAGE CALCULATIONS WORKSHEET

Applic	ation Name or Identifying Title: VARGHESE	Date: 1-28-22	
Тах М	ap Designation or Proposed Lot No.: 102 01-1-63		
Gross	Lot Coverage		
1,	Total lot Area (Net Lot Area for Lots Created After 12/13/06):	68,084.28	
2.	Maximum permitted gross land coverage (per Section 355-26.C(1))(b)): <u>11,557,19</u>	
3.	BONUS maximum gross land cover (per Section 355-26.C(1)(h)):		
	Distance principal home is beyond minimum front yard setback zr x 10 =	210	
4.	TOTAL Maximum Permitted gross land coverage = Sum of line	nes 2 and 3 11,767 is	
5.	Amount of lot area covered by principal building: 2153 existing + 420 proposed =	2,578	
6.	Amount of lot area covered by accessory buildings: a existing + o proposed =	-0	
7.	Amount of lot area covered by decks: a existing + a proposed =	<u>u</u>	
8.	Amount of lot area covered by porches: o existing + _0 proposed =	<u>o</u>	
9.	Amount of lot area covered by driveway, parking areas and walk 2.628 existing + 137 proposed =	kways:	
10.	Amount of lot area covered by terraces: 291 existing + 0 proposed =	.Z91	
IJ.	Amount of lot area covered by tennis court, pool and mechanical o existing + o proposed =	equíp: <u>0</u>	
12.	Amount of lot area covered by all other structures: o existing + _0 proposed =	0	
(3. P ro	sposed gross land coverage: Total of Lines 5 - 12 =	5255	
the pro	13 is less than or equal to Line 4. your proposal complies with the T ject may proceed to the Residential Project Review Committee for record comply with the Town's regulations.		
	K	11-8-21	
Signati	are and Seal of Professional Preparing Worksheet	Date	



TOWN OF NORTH CASTLE


WESTCHESTER COUNTY 17 Bedford Road Armonk, New York 10504-1898

PLANNING DEPARTMENT Adam R. Kaufman, AICP Director of Planning

January 29, 2019 Telephone: (914) 273-3542 Fax: (914) 273-3554 www.northcastleny.com

FLOOR AREA CALCULATIONS WORKSHEET

Applica	tion Name or Identifying Title:	VARGHESE		Date: 1-28-22
Tax Ma	Designation or Proposed Lot No.:	102.01-1-63		
Floor A	<u>rea</u>			
1.	Total Lot Area (Net Lot Area for L	ots Created After 1	12/13/06):	58.084 28
2.	Maximum permitted floor area (pe	r Section 355-26,E	3(4));	9,171,21
3.	Amount of floor area contained wit		-	1.929
4.	Amount of floor area contained wit		-	1 422
5.	Amount of floor area contained wit		-	644
6.	Amount of floor area contained wit		le of being enclosed:	<u> </u>
7. -	Amount of floor area contained wit		pplicable – see definition): –	0
8.	Amount of floor area contained wit		able - see definition): -	0
9. -	Amount of floor area contained wit		ouildings: _	0
10. Pro	posed floor area: Total of Lines	53-9=		3.995
and the p	10 is less than or equal to Line 2, your open the residential apposal does not comply with the Town	Project Review Co		
Signatur	re and Seal of Professional Preparing	Worksheet		-28-22 Pate

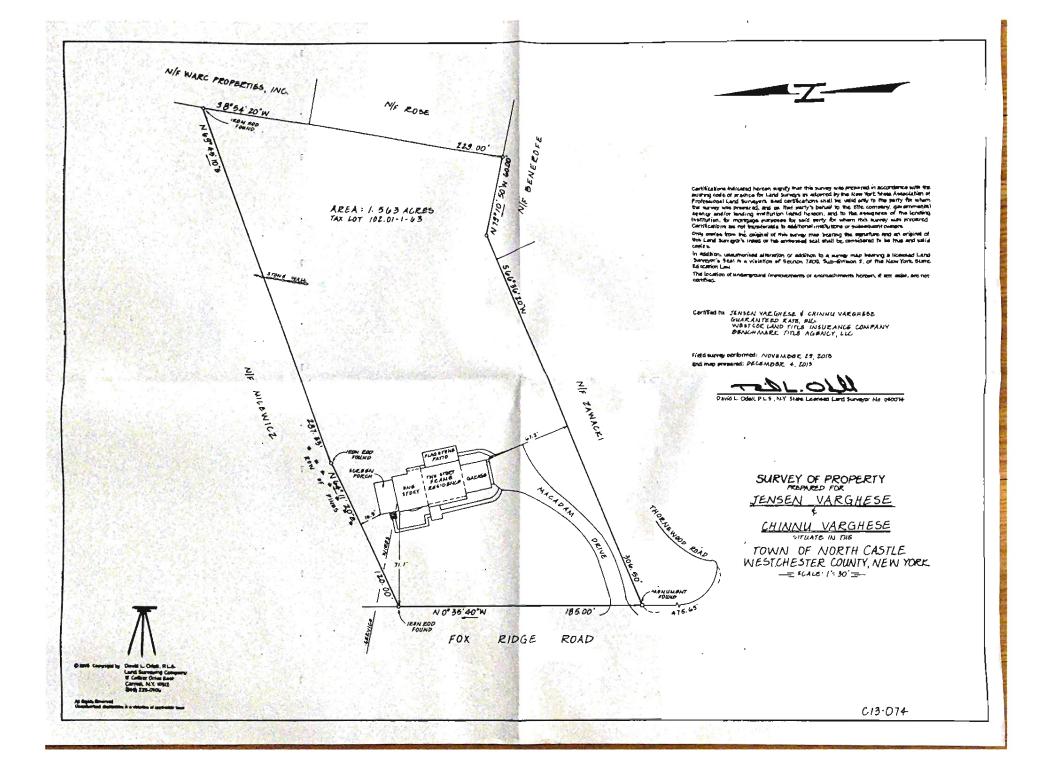

VARGHESE RESIDENCE RENOVATION

6 FOX RIDGE ROAD ARMONK, NEW YORK 10504



DO NOT SCALE DRAWINGS. REFER TO WRITTEN MEASUREMENTS FOR ACCURANCY, OR CONTACT ARCHITECT. CONTACT ARCHITECT UNAUTHORIZED ALTERATIONS OR ADDITIONS TO THIS DRAWING IS A VIOLATION OF NEW YORK STATE EDUCATION LAW. © Copyright 2021 MICHAEL PICCIRILLO ARCHITECTURE PLLC

ABBREVIATIONS PAINTED **ANCHOR BOLT** INCLUDING TELEPHONE DIAMETER **ACOUSTICAL TILE** DIM PLASTIC LAMINATE DIMENSION **INSIDE DIAMETER** P.LAM **TELEVISION** ABOVE FINISHED FLOOR DN DOWN INSULATION PLWD PLYWOOD THK **THICKNESS** ADD. ADDENDUM POLYVINYL CHLORIDE T&G DRAWING INTERIOR **TONGUE AND GROOVE** D.F. T&B **AIR CONDITIONING** DRINKING FOUNTAIN INVERT P.C.F. POUNDS PER CUBIT FOOT TOP AND BOTTOM T.O.S. ALTERNATE POUNDS PER SQUARE FOOT TOP OF SLAB ALUMINUM P.S.I. TOP OF STEEL ELECTRICAL POUNDS PER SQUARE INCH T.O.STL **ANODIZED** ELEC. WATER COOLER POLISHED T.O.W. TOP OF WALL ARCH **ARCHITECTURAL** ELEV ELEVATION LAMINATE **PLASTER** TREAD (S) EQ LAVATORY EQUAL **TYPICAL** BSMT EXP LINEAR FOOT T.O.C. EXPOSED TOP OF CURB BASEMEN' QUARRY TILE **BITUMINOUS** EXTERIOR BLKG **BLOCKING** EXP. JT. EXPANSION JOINT REFLECTED CEILING PLAN UNDERWRITERS LABORATORY BOARD MASONRY REFERENCE UNLESS NOTED OTHERWISE BLDG MANUFACTURER BUILDING REINF REINFORCED URINAL F.F.E. FINISHED FLOOR ELEV. MASONRY OPENING REV REVISION CABINET F.P.S.C. FIRE-PROOF, SELF-CLOSING MECH MECHANICAL REQUIRED VINYL COMPOSITION TILE CAST IN PLACE FLOOR **VAPOR BARRIER** FTG CPT VERT CARPET FOOTING ROOM VERTICAL CATCH BASIN FOUNDATION NOMINAL **ROUGH OPENING** CLG CEILING NOT IN CONTRACT CEM **CEMENT** NOT TO SCALE WATER CLOSET GALVANIZED WCOT **CERAMIC TILE** GAUGE **SPECIFICATION** WAINSCOT GYP. BD. GYPSUM BOARD COL COLUMN OUTSIDE AIR INTAKE SQUARE WATERPROOFING CONC CONCRETE ON CENTER WATER RESISTANT **SQUARE FOOT** HD. WD. HARDWOOD CONC. MASONRY UNIT **OVERHANG SQUARE YARD** WEATHERSTRIPPING HDR CONST CONSTRUCTION HEADER OPENING STAINLESS STEEL HT STD W.W.F CONT CONTINUOUS OPPOSITE **STANDARD** WELDED WIRE FABRIC STL **CUBIC FEET HOLLOW METAL** OUTSIDE DIAMETER WIDE, WIDTH C.Y. CUBIC YARD HOSE BIB OPTION OR OPTIONAL SYM SYMBOL WOOD NEW INTERIOR FINISHES SHALL COMPLY WITH 2020 NYS RESIDENTIAI REFERENCE SYMBOLS CODE -INTERIOR WALL AND CEILING FINISHES & CORRIDOR FINISHES SHALL BE A MIN CLASS "C" FLAME SPREAD AND SMOKE DEVELOPMENT INDEX -EXIT PASSAGE FINISHES SHALL BE A MIN CLASS "B" FLAME SPREAD AND SMOKE (A) GRID-SYMBOL -INTERIOR FLOOR FINISHES SHALL COMPLY WITH THE DOC FF 1 "PILL TEST" BUILDING SECTION PARTIAL SECTION PORTABLE FIRE EXTINGUISHERS - SHEET NUMBER - SHEET NUMBER -EXTINGUISHERS SHALL BE SELECTED, INSTALLED, MAINTAINED IN -GRID LINES

INTERIOR ELEVATION

ROOM NAME SYMBOL

100 ROOM REFERENCE I.D.

RESIDENTIAL ENERGY EFFICIENCY

PRESCRIPTIVE REQUIREMENTS:

FENESTRATION U-FACTOR- 0.35

- CLIMATE ZONE 4

CEILING R-VALUE- 49

WALL R-VALUE- 20

THEIR FRAMING

VALUES)

FLOOR R-VALUE- 19

ENERGY CODE COMPLIANCE:

2020 NYS RESIDENTIAL CODE, CHAPTER 4:

(REFER TO PLANS FOR PROJECT INSULATION

-THE BUILDING THERMAL ENVELOPE SHALL BE

-WALLS AND CEILINGS SEPERATING

-BUILDING ENVELOPE AIR TIGHTNESS SHALL BE

TESTED IN ACCORDANCE WITH ASHREA/ASTM

- PROVIDE A MINIMUM OF ONE THERMOSTATE

-DUCTS IN ATTIC SHALL BE INSULATED TO MIN.

COMPLETELY WITHIN THE BUILDING THERMAL

-ALL DUCTS SHALL BE SEALED AND COMPLY

-HOTAND COLD WATER PIPES SHALL BE

SHOWING COMPLIANCE WITH ABOVE.

WITH M1601.3.1 OF 2020 NYS RESIDENTIAL CODE

-HEATING AND COOLING EQUIPMENT SHALL BE

SIZED IN ACCORDANCE WITH ACCA MANUAL J.

GC SHALL PROVIDE SYSTEM SPECIFICATIONS

LIGHTING FIXTURES SHALL BE HIGH-EFFICIENCY

-A MINIMUM OF 50% OF LAMPS SHALL BE IN

R-8. ALL OTHER DUCTS SHALL BE INSULATED TO

CAPABLE OF AUTOMATICALLY ADJUSTING

SPACE TEMPERATURE PER 2020 NYS

MIN. R-6 (EXCEPT DUCTS LOCATED

-ALL JOINTS, SEAMS, AND PENETRATIONS

-JOINTS AROUND DOORS/WINDOWS AND

-RIM JOIST JUNCTION, SILL P[LATES AND

DURABLY SEALED TO LIMIT INFILTRATION.

-UTILITY PENETRATIONS

CONDITIONED SPACE

-ATTIC ACCESS OPENINGS

CONDITIONED FROM NON

RESIDENTIAL CODE.

INSULTED TO MIN. R-3

ENVELOPE)

- SHEET NUMBER

(100) DOOR REFERENCE I.D.

RETAIL SPACE, AND (2) 2-A, EXTINGUISHER FOR WAREHOUSE SPACE -EXISTING SPRINKLER SYSTEM SHALL BE MODIFIED PER NEW CONSTRUCTION TO PROVIDE THE REQUIRED COVERAGE FOR NEWLY CREATED SPACES. ALL SPRINKLER WORK/MODIFICATIONS SHALL BE DONE IN ACCORDANCE WITH NFPA

ACCORDANCE WITH NFPA 10. -PROVIDE (1) 2-A, EXTINGUISHER FOR EACH

-NEW MECHANICAL WORK AND ALTERATIONS TO EXISTING MECHANICAL INSTALLATIONS SHALL CONFORM TO CHAPTER 12 OF THE 2020 NYS RESIDENTIAL CODE.

-HEATING AND COOLING LOADS SHALL BE DETERMINED IN ACCORDANCE WITH THE PROCEDURES DESCRIBED IN THE ASHREA/ACCA 183. -HVAC EQUIPMENT SHALL MEET THE MINIMUM EFFICIENCY REQUIREMENT OF 2020 NYS RESIDENTIAL CODE.

-THE HEATING SYSTEM SHALL BE CAPABLE OF MAINTAINING A MINIMUM INDOOR TEMPERATURE OF 68 DEG. F AT A POINT 3'-0" ABOVE THE FLOOR ON THE DESIGN -G.C. SHALL PROVIDE SYSTEM SPECIFICATIONS FOR ARCHITECT REVIEW. -EACH

HEATING/COOLING SYSTEM SHALL BE PROVIDED WITH THERMOSTATIC CONTROLS -SUPPLY AND RETURN AIR DUCTS IN UNCONDITIONED SPACES SHALL BE

INSULATED WITH MIN. R-5 INSULATION -ALL EQUIPMENT SHALL BE INSTALLED PER MANUFACTURERS SPECIFICATIONS - PROPER CLEARANCES SHALL BE MAINTAINED TO ALL INSPECTION, SERVICE, REPAIR, OR REPLACEMENT WITHOUT REMOVING ELEMENTS OF PERMANENT CONSTRUCTION.

-SERVICE WATER HEATING EQUIPMENT SHALL MEET THE MINIMUM EFFICIENCY REQUIREMENT OF 2020 NYS RESIDENTIAL CODE. -ALL PLUMBING FIXTURES AND DRAINS USED TO RECIEVE OR DISCHARGE

LIQUID WASTE SHALL BE DIRECTLY CONNECTED TO THE SANITARY DRAINAGE SYSTEM IN ACCORDANCE WITH 2020 NYS RESIDENTIAL CODE. -ALL PLUMBING FIXTURES AND APPLIANCES USING WATER SHALL BE CONNECTED TO THE WATER SUPPLY SYSTEM IN ACCORDANCE WITH 2015 IPC. -THE SUPPLY LINES AND FITTINGS FOR EVERY PLUMBING FIXTURE SHALL BE INSTALLED SO AS TO PREVENT BACKFLOW IN ACCORDANCE WITH ASME A

112.18.1 -STRAINER PLATES AND DRAIN INLETS SHALL BE DESIGNED AND INSTALLED SO THAT ALL OPENINGS ARE NOT GREATER THEN 0.5" IN LEAST DIMENSION - OPENINGS FOR PIPES MADE IN FLOORS, WALL, AND CEILINGS SHALL BE CLOSED AND PROTECTED BY INSTALLATION OF APPROVED METAL COLLARS THAT ARE FASTENED TO THE STRUCTURE. EXTERIOR WALL AND ROOF OPENINGS SHALL BE MADE WATER TIGHT WITH APPROVED FLASHING. -BURIED

TRENCHES SHALL BE LINED WITH FINE GRAVEL -THE DEISGN OF WATER DISTRIBUTION SYSTEM SHALL CONFORM TO ACCEPTED ENGINEERING PRACTICE. METHODS UTILIZED TO DETERMINE PIPE SIZES SHALL BE APPROVED.

-WATER SERVICE AND DISTRIBUTION PIPE SHALL CONFORM TO NSF 61.

PIPING SHALL BE SUPPORTED THROUGHOUT ITS ENTIRE LENGTH. PIPE

-NEW ELECTRICAL COMPONENT, EQUIPMENT, AND SYSTEMS AND ALTERATIONS TO EXISTING ELECTRICAL INSTALLATIONS SHALL CONFORM TO NFPA 70.

-NEW FUEL GAS WORK AND ALTERATIONS TO EXISTING FUEL GAS INSTALLATIONS SHALL CONFORM TO THE 2020 NYS RESIDENTIAL CODE.

GENERAL NOTES

1. ALL WORK SHALL CONFORM TO THE 2020 NYS PLUMBING, AND MECHANICAL WORK SHALL CONFORM TO APPROVED BY ARCHITECT/OWNER ALL NATIONAL, STATE, AND LOCAL CODES. 2. THIS LAYOUT WAS BASED ON THE GIVEN

CONFIGURATION AND FEATURES OF THE EXISITNG STRUCTURE. DIMENSIONS ARE GIVEN AS GUIDES TO ESTABLISH THE LAYOUT WITHIN THE EXISTING STRUCTURE. THE GENERAL CONTRACTOR & EACH SUBCONTRACTOR SHALL CAREFULLY SURVEY AND **EXAMINE THE EXISTING STRUCTURE IN ESTABLISHING** LAYOUT OF THE WORK IN ORDER TO ASSURE PROPER FIT AND ALIGNMENT OF THE NEW WORK WITH PROPER RELATIONSHIP TO EXISTING FEATURES. WHEN

ESTABLISHING LAYOUT, CONTRACTOR SHALL CONTACT ARCHITECT FOR APPROVAL BEFORE COMMENCING WITH CONSTRUCTION. 3. BEFORE SUBMITTING A PROPOSAL THE CONTRACTOR SHALL VISIT THE PREMISES, FAMILIARIZE THEMSELVES W/ EXISTING CONDITIONS & SATISFY THEMSELVES AS TO THE NATURE AND SCOPE OF THE WORK & THE

DIFFICULTIES THAT ATTEND TO ITS EXECUTION. 4. MATERIALS, WORKMANSHIP AND INSTALLATION SHALL BE IN STRICT COMPLIANCE WITH NOT ONLY THE MANUFACTURERS' PRINTED INSTRUCTIONS, BUT ALSO THE STANDARDS OF RECOGNIZED AGENCIES OR ASSOCIATIONS.

5. ALL MATERIALS SHALL BE NEW, UNLESS OTHERWISE 6. PROVIDE TEMPORARY PROTECTION OF MATERIALS

AND EQUIPMENT. FROM DAMAGE DURING CONSTRUCTION.

8. IT IS INTENDED THAT THE CONTRACTOR PROVIDE A COMPLETE JOB. ANY OMISSIONS IN THESE GENERAL INSTRUCTIONS OR THE OUTLINE OF WORK ARE NOT TO BE ANY AND ALL CONDITIONS WHICH MAY INTERFERE WITH CONSTRUED AS REMOVING SUCH ITEMS FROM THE RESPONSIBILITIES OF THE CONTRACTOR.

9. TIME REQUIRED TO COMPLETE THE PROJECT SHALL BE STATED IN CONTRACTOR'S PROPOSAL. AFTER AWARD 20. ALL CONSTRUCTION AND SUBCONTRACTED WORK OF JOB, CONTRACTOR SHALL SUBMIT A CONSTRUCTION SCHEDULE FOR REVIEW, INDICATING THE SEQUENCE OF OPERATIONS AND TIME REQUIRED FOR EACH, ESTABLISHING A TARGET DATE.

10. ALL WORK SHALL BE PERFORMED BY SKILLED AND QUALIFIED WORKMEN IN THE APPROPRIATE TRADES. CONTRACTOR SHALL KEEP SUFFICIENT WORKMEN ON THE JOB AT ALL TIMES TO PERFORM THE WORK IN THE MOST EXPEDITIOUS MANNER CONSISTENT WITH GOOD WORKMANSHIP, SOUND BUSINESS PRACTICE AND IN THE BEST INTERESTS OF THE PROJECT.

SEISMIC

DESIGN

С

EFFECTS WIND REGION DEBRIS ZONE CATEGORY WEATHERING

CLIMATIC AND GEOGRAPHIC DESIGN CRITERIA

TERMITE

MODERATE

HEAVY

SUBJECT TO DAMAGE FROM

FROST DEPTH

LINE

42"

11. NO SUBSTITUTIONS WILL BE ACCEPTED UNLESS RESIDENTIAL CODE AND LOCAL CODES. ALL ELECTRICAL, SUBMITTED IN WRITING TO ARCHITECT/OWNER &

> 12. CONTRACTOR SHALL PROVIDE PROPER PROTECTION FOR ALL EXISTING WORK, FURNISHINGS AND FIXTURES LIKELY TO BE DAMAGED. WHEN EXTERIOR OPENINGS ARE MADE IN EXISTING WORK, THEY SHALL BE COVERED WITH WATERTIGHT PROTECTION AT THE END OF THE DAY'S WORK. 13. PATCH, REPAIR AND REPLACE ALL EXISTING WALLS, CEILINGS AND FLOORS DAMAGED DUE TO

NEW CONSTRUCTION. 14. STARTING TIME AND COMPLETION FOR CONSTRUCTION IS TO BE COORDINATED WITH OWNER AND AGREED UPON BY BOTH PARTIES. 15. CONTRACTOR IS EXPECTED TO WORK ON JOB WITHOUT ANY UNREASONABLE DELAY. IF A DELAY IS TO OCCUR, NOTIFICATION TO THE OWNER SHALL BE

16. WORK PERFORMED OVER ANY SURFACE CONSTITUTES ACCEPTANCE OF THAT SURFACE FOR THE SPECIFIED QUALITY OF THE WORK BEING

PERFORMED THEREON. 17. THE CONTRACTOR IS TO NOTIFY ARCHITECT IN WRITING OF ANY ADAPTATIONS TO THESE DRAWINGS OR SPECIFICATIONS REQUIRED BY LOCAL LIFE AND SAFETY CODES OR ANY OTHER GOVERNING AGENCY 18. SINCE IT IS NOT POSSIBLE TO INDICATE ON THE DRAWINGS ALL THE EXISTING WORK TO BE REMOVED BY DASHED LINES OR NOTES. THE CONTRACTOR IS ADVISED TO ACQUAINT HIMSELF WITH THE ACTUAL CONDITIONS AT LOCATIONS WHERE ALTERATIONS

19. THE CONTRACTOR SHALL REPORT TO ARCHITECT OR OTHERWISE AFFECT OR PREVENT THE PROPER EXECUTION AND COMPLETION OF THE WORK OF THIS

IS TO BE PERFORMED BY CONTRACTORS LICENSED IN THE STATE WHERE THE WORK IS BEING EXECUTED. 21. ALL CONTRACTORS ARE RESPONSIBLE TO CONFORM TO THE OWNER'S INSURANCE REQUIREMENTS AND TO PROVIDE A CERT. OF INSURANCE TO ALL PARTIES UPON AWARD OF

CONTRACT. 22. ALL CONTRACTORS ARE TO CONFORM WITH THE **BUILDING OWNER'S REQUIREMENTS FOR DELIVERY TO** THE SITE AND STORAGE OF ALL CONSTRUCTION

FLOOD

WINTER | ICE BARRIER

DESIGN UNDERLAYMANT

TEMP | REQUIREMENT

TABLE R301.2(1)

INDEX | TEMP

51.6

HAZARDS FREEZING ANNUAL

1500 OR

23. REMOVE DEBRIS AND ABANDONED ITEMS FROM AREA AND FROM CONCEALED SPACES. CONTRACTOR TO COORDINATE REMOVAL OF DEBRIS FROM SITE SO THAT IT DOES NOT INTERFERE WITH OWNER'S ACTIVITIES.

24. PROPERLY PREPARE ALL SURFACES BEFORE APPLICATION OF FINISHES, IN STRICT ACCORDANCE WITH THE PRINTED RECOMMENDATIONS. 25. EXECUTE PRIOR TO FINAL INSPECTION: CLEAN INTERIOR AND

EXTERIOR SURFACES EXPOSED TO VIEW, REMOVE TEMPORARY LABELS, STAINS AND FOREIGN SUBSTANCES. CLEAN FIXTURES AND CABINETRY TO A SANITARY CONDITION. 26. PERMITS: A. GENERAL CONTRACTOR / SUBCONTRACTOR IS RESPONSIBLE FOR ALL INFORMATION AND DESIGN (INCLUDING ELECTRICAL,

SPRINKLER, AND MECHANICAL) REQUIRED BY LOCAL BUILDING OFFICIAL TO OBTAIN ALL NECESSARY BUILDING PERMITS FOR CONSTRUCTION. B. GENERAL CONTRACTOR SHALL PAY FOR ALL PERMITS REQUIRED, UNLESS OTHERWISE SPECIFIED BY OWNER.

C. GENERAL CONTRACTOR SHALL OBTAIN FINAL CERTIFICATE OF

OCCUPANCY UPON COMPLETION OF WORK AND SHALL FORWARD

SAME TO OWNER. 27. CLEANING: A. MAINTAIN PREMISES AND PUBLIC PROPERTIES FREE FROM ACCUMULATIONS OF WASTE, DEBRIS AND RUBBISH, CAUSED BY

OPERATIONS. B. AT COMPLETION OF WORK, REMOVE WASTE MATERIALS. RUBBISH, TOOLS, EQUIPMENT, MACHINERY AND SURPLUS MATERIALS AND CLEAN ALL SIGHT-EXPOSED SURFACES. LEAVE PROJECT CLEAN AND READY FOR OCCUPANCY.

28. WARRANTIES: A. CONTRACTOR SHALL WARRANTY THE WORK WILL BE FREE FROM DEFECTIVE MATERIALS AND WORKMANSHIP FOR A PERIOD OF ONE YEAR AFTER THE DATE OF OWNER'S ACCEPTANCE OR WITHIN SUCH PERIOD OF TIME AS MAY BE PRESCRIBED BY THE TERMS OF ANY APPLICABLE SPECIAL WARRANTY REQUIRED BY THE CONTRACT DOCUMENTS.

29. CONTRACTOR AGREES THAT HE IS SKILLED AND EXPERIENCED IN THE USE AND INTERPRETATION OF PLANS AND SPECIFICATIONS HE HAS CAREFULLY REVIEWED THE PLANS AND SPECIFICATIONS FOR HIS PROJECT AND HAS FOUND THEM TO BE FREE OF AMBIGUITIES. FURTHER, HE HAS CAREFULLY EXAMINED THE SITE OF THE WORK AND FROM HIS OWN OBSERVATIONS HAS SATISFIED HIMSELF AS TO THE NATURE AND LOCATION OF THE WORK; THE CHARACTER, QUALITY, AND QUANTITY OF MATERIALS; THE DIFFICULTIES LIKELY TO BE **ENCOUNTERED AND OTHER ITEMS FOUND ON THE**

30. THE CONTRACTORS' EXPERIENCE, EXPERTISE AND PROFESSIONAL JUDGMENT SHALL NOT BE DISREGARDED DURING THE CONSTRUCTION PROCESS. THE CONTRACTORS' INPUT, COMMENTS AND RECOMMENDATIONS WILL BE WELCOMED AND EXPECTED BY THE OWNER AND THE ARCHITECT. CONSTRUCTION ALTERNATIVES WILL BE CONSIDERED AND EMBRACED IF THEY HAVE MERI AND A BETTER RESULT CAN BE ACHIEVED. SUCH CHANGES MAY NOT TAKE PLACE WITHOUT THE EXPRESS APPROVAL OF THE ARCHITECT.

> DATE: **PROJECT NAME:**

VARGHESE RESIDENCE RENOVATION

PROJECT ADDRESS: **6 FOX RIDGE ROAD** ARMONK, NY 10504



MICHAEL A PICCIRILLO, AIA

345 KEAR STREET SUITE #203 YORKTOWN, NEW YORK 10598

> TELEPHONE: 914-368-9838 FACSIMILE: 914-368-9839 michael@mpiccirilloarchitect.com www.mpiccirilloarchitect.com

TITLE SHEET **NOTES**

OF 11

07-05-21 DRAWN BY:

SMOKE ALARMS/ CARBON MONOXIDE ALARMS

TOPO SPECIAL WINDBORNE

EXTERIOR ELEVATION

— ELEVATION LEVEL LINE

WIND DESIGN

SHEET NUMBER

. SMOKE DETECTORS SHALL BE INSTALLED IN ALL BEDROOMS, ADJACENT HALL, AND ONE ON EACH STORY OF DWELLING PER 2020 NYS

30 PSF | 115 MPH - 120 MPH | NO

BLOW-UP DETAIL

SHEET NUMBER

DOOR LOCATION SYMBOL WINDOW LOCATION SYMBOL WINDOW REFERENCE I.D.

REVISION I.D.

GROUND

SNOW

LOAD

SECTION R315.

-ALL SMOKE ALARMS SHALL BE LISTED IN ACCORDANCE WITH UL 217 AND INSTALLED IN ACCORDANCE WITH THE PROVISIONS OF THIS CODE AND THE HOUSEHOLD FIRE WARNING **EQUIPMENT PROVISIONS OF NFPA 72.** -ALL SMOKE DETECTORS SHALL BE

INTERCONNECTED IN SUCH A MANNER THAT THE ACTUATION OF ONE ALARM WILL ACTIVATE ALL OF THE ALARMS IN THE INDIVIDUAL UNIT. THE ALARM SHALL BE CLEARLY AUDIBLE IN ALL BEDROOMS OVER BACKGROUND NOISE LEVELS WITHAL LL INTERVENING DOORS CLOSED. ALL SMOKE DETECTORS SHALL BE INSTALLED PER THE 2020 NYS RESIDENTIAL CODE, SECTION R314. 2. PROVIDE CARBON MONOXIDE DETECTORS PER 2015 THE INTERNATIONAL RESIDENTIAL CODE,

3. PROVIDE FIREBLOCKING PER THE 2020 NYS RESIDENTIAL CODE, SECTION R602.8. PROVIDE FIRE BLOCKING IN WALL CAVITIES OR FURRED ALL PIPING. VENTS AND WIRING HOLES, ETC. 4. SMOKE ALARMS SHALL BE PERMITTED TO BE BATTERY OPERATED WHEN INSTALLED IN ON-SITE ELECTRICAL POWER SYSTEM, OR IN THE STRUCTURE AS PER APPENDIX J 504.2.1 OF THE 2020 NYS RESIDENTIAL CODE.

ENERGY CODE MOTE: PROFESSIONAL. I ALSO CERTIFY KNOWLEDGE THE (E) COMPLIANCE WITH THE

SEVERE


THE BUILDING PLANS SHOWN HEREIN ARE IN COMPLIANCE WITH RESIDENTIAL CODE OF NEW YORK STATE. THE BUILDING PLANS DESCRIBED HEREIN COMPLIES WITH CHAPTER 3 INCLUDING PARAGRAPH R303.1 OF THE 2020 NYS RESIDENTIAL CODE. ALL HABITABLE ROOMS HAVE BEEN PROVIDED WITH AN VENTILATION TO THE OUTDOORS HAVE BEEN PROVIDED AT NOT

SPACES THAT EXCEED 8 FT IN HEIGHT, AROUND **BUILDINGS WITHOUT COMMERCIAL POWER OR AN BUILDINGS WHERE EXISTING INTERIOR WALL OR** CEILING FINISHES ARE NOT REMOVED TO EXPOSE THAT TO THE BUILDING PI SIGNED:


AGGREGATE GLAZING AREA OF NOT LESS THAN 8 PERCENT OF THE FLOOR AREA OF SUCH ROOMS. THE MINIMUM OPERABLE AREA FOR LESS THAN 4 PERCENT OF FLOOR AREA.

LOCATION MAP

SATTILITE MAP

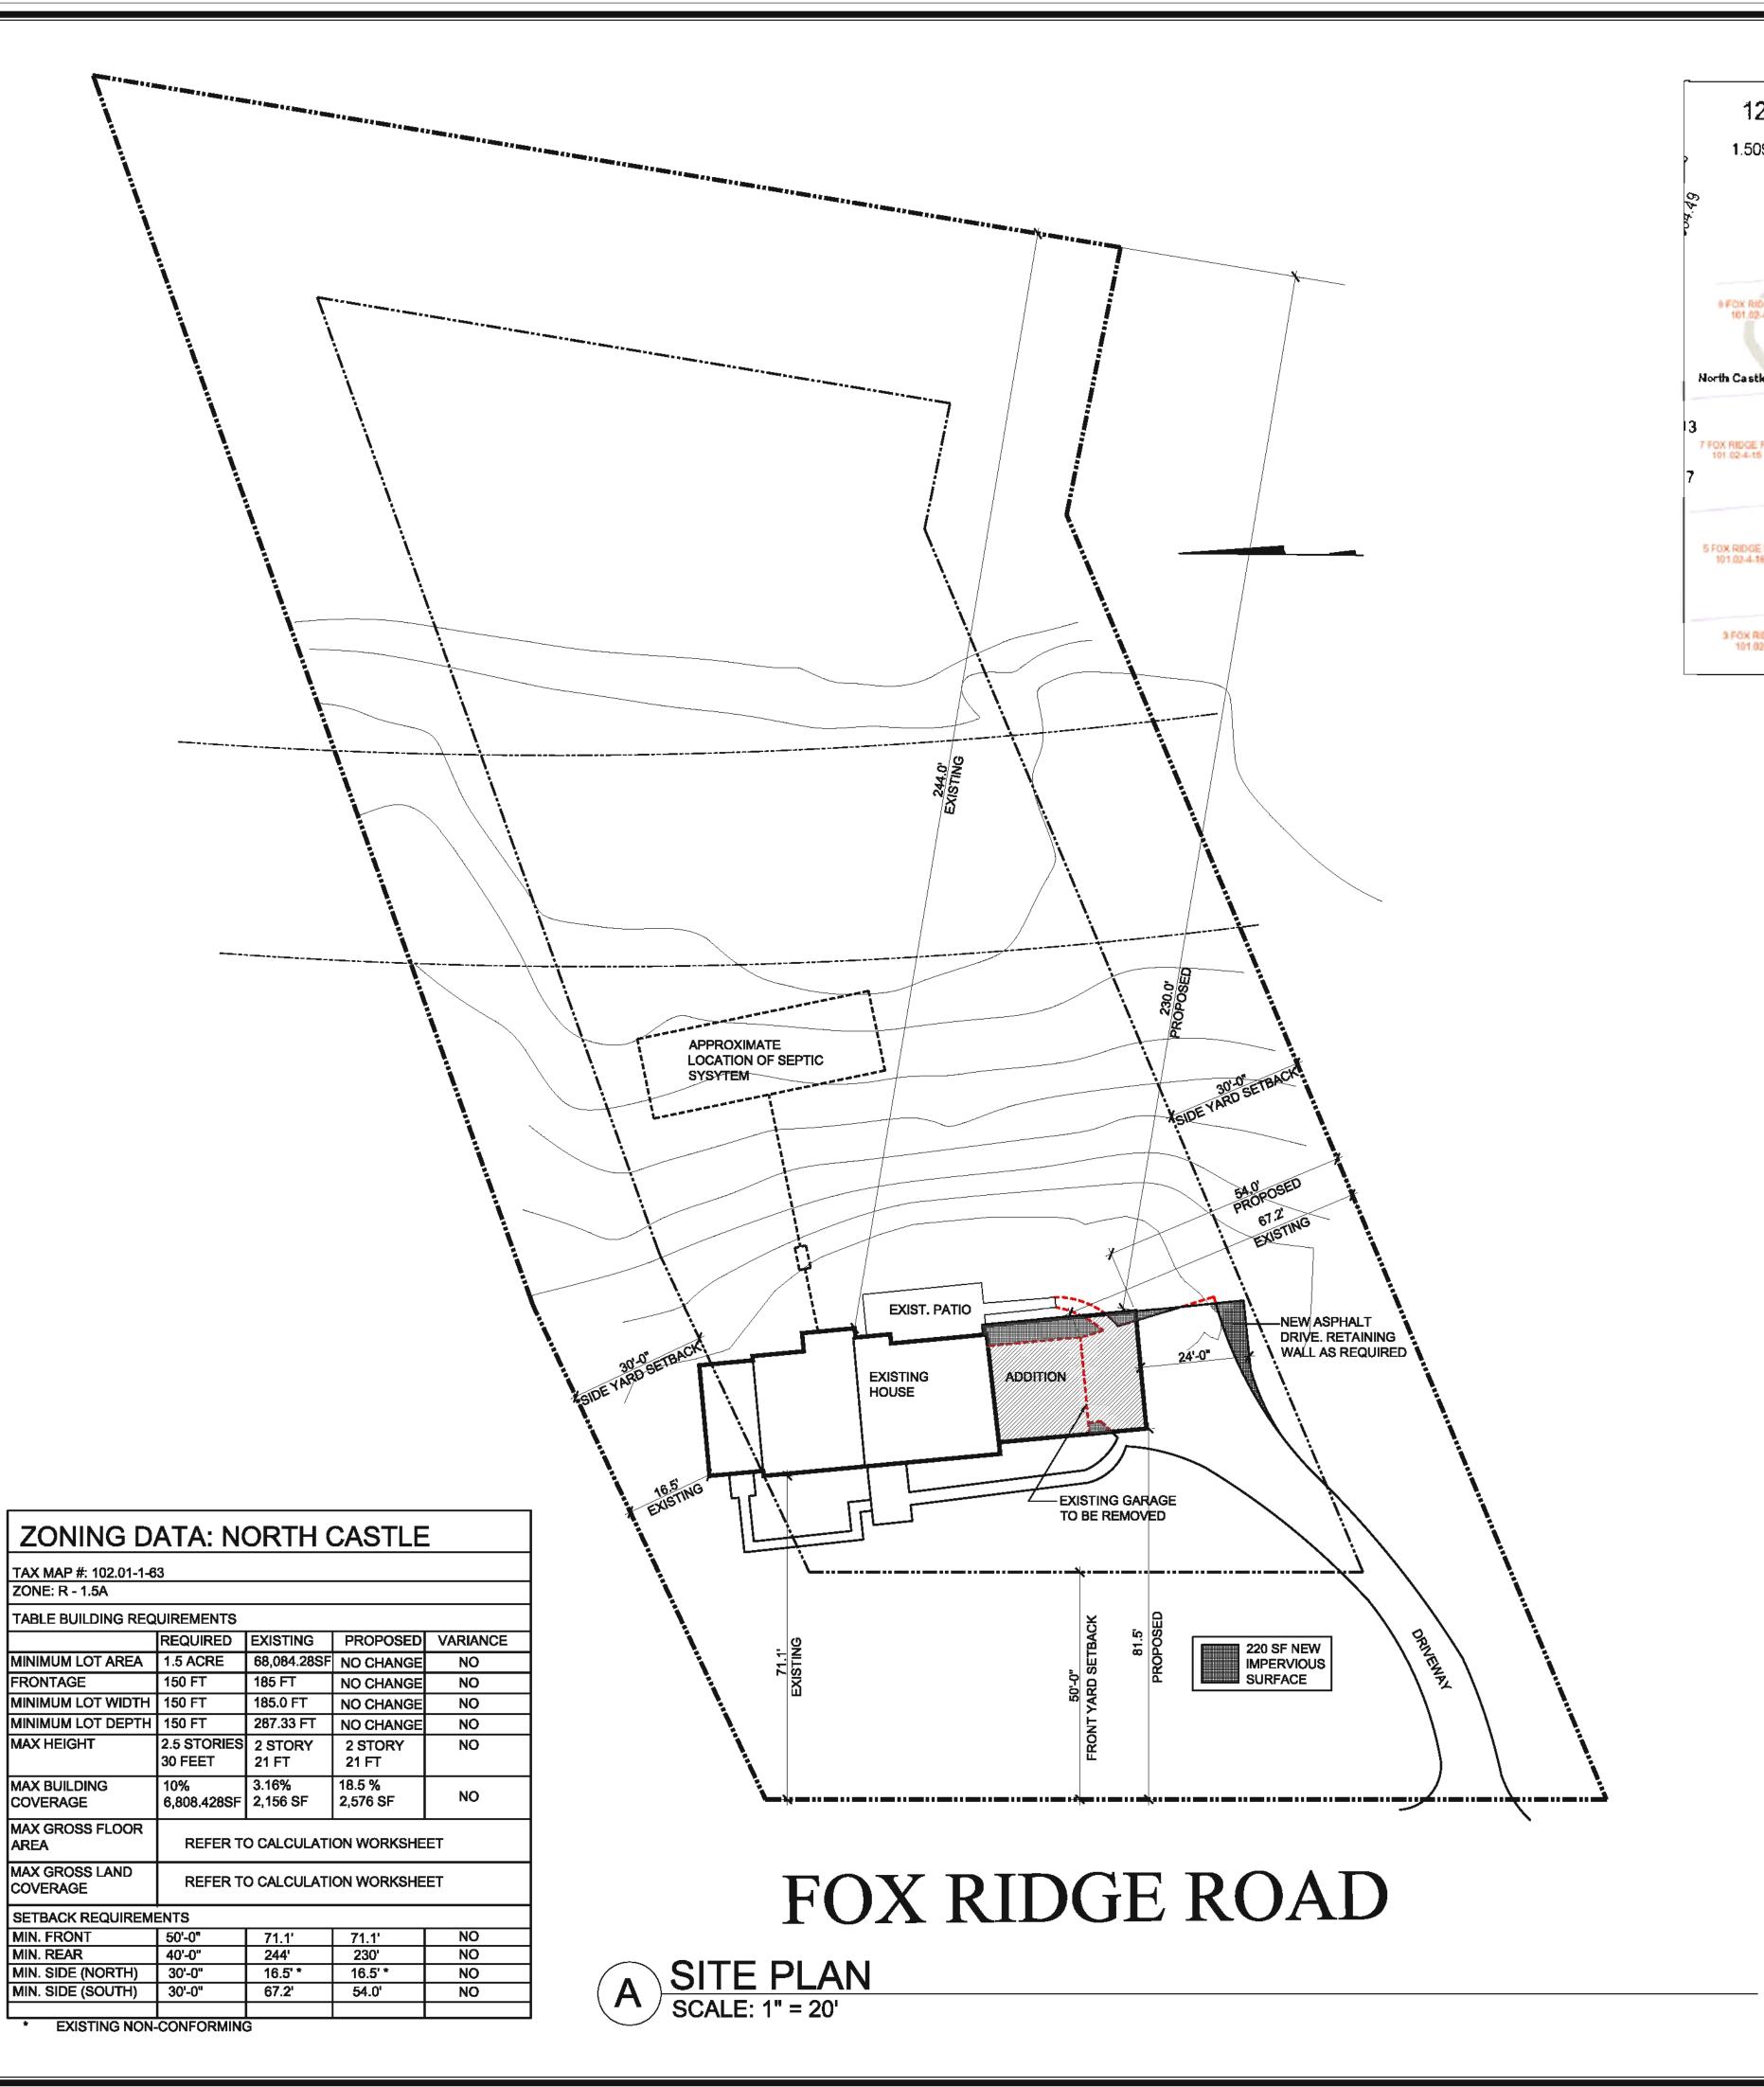

6 FOX RIDGE RD. ID: 102.01-1-63 (North Castle) 425.23 1,600Ac 10 FOX RIDGE RD 23 THORNEWOOD RD 102.01-1-74 11 FOX RIDGE RD 1.507AC 1.506Ac 9 FOX RIDGE RD 101.02-4-14 North Castle 510.92 1.563Ac 1.56Ac 5 FOX RIDGE RD 101.02-4-16 477,16 3 FOX RIDGE RD 101.02-417

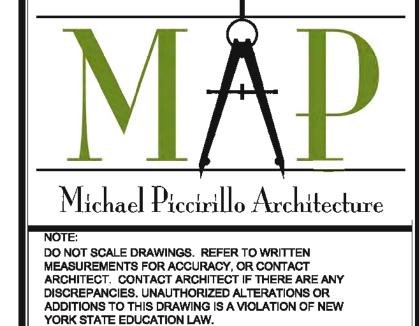

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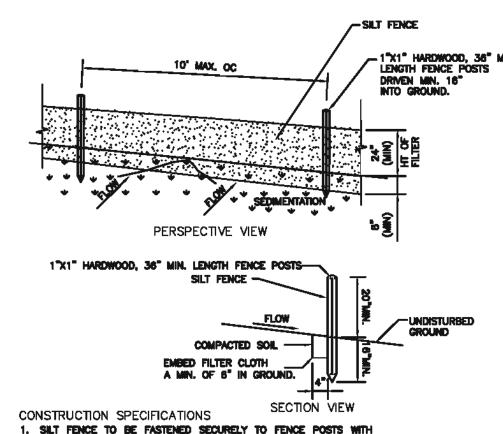
EROSION CONTROL BLANKETS

1:1.500

Westchester County GIS

http://giswww.westchestergov.com Michaelan Office Building

White Plains, New York 19601



SILT FENCE INSTALLATION DETAIL

NTS

STOCKPILE SHALL BE COVERED ENTIRELY BY AN ANCHORED PLASTIC COVER OR SEEDED STOCKPILE DETAIL

No.	DATE:	ISSUE:
1	1/28/22	ISSUED

VARGHESE RESIDENCE RENOVATION

PROJECT ADDRESS: 6 FOX RIDGE ROAD ARMONK, NY 10504



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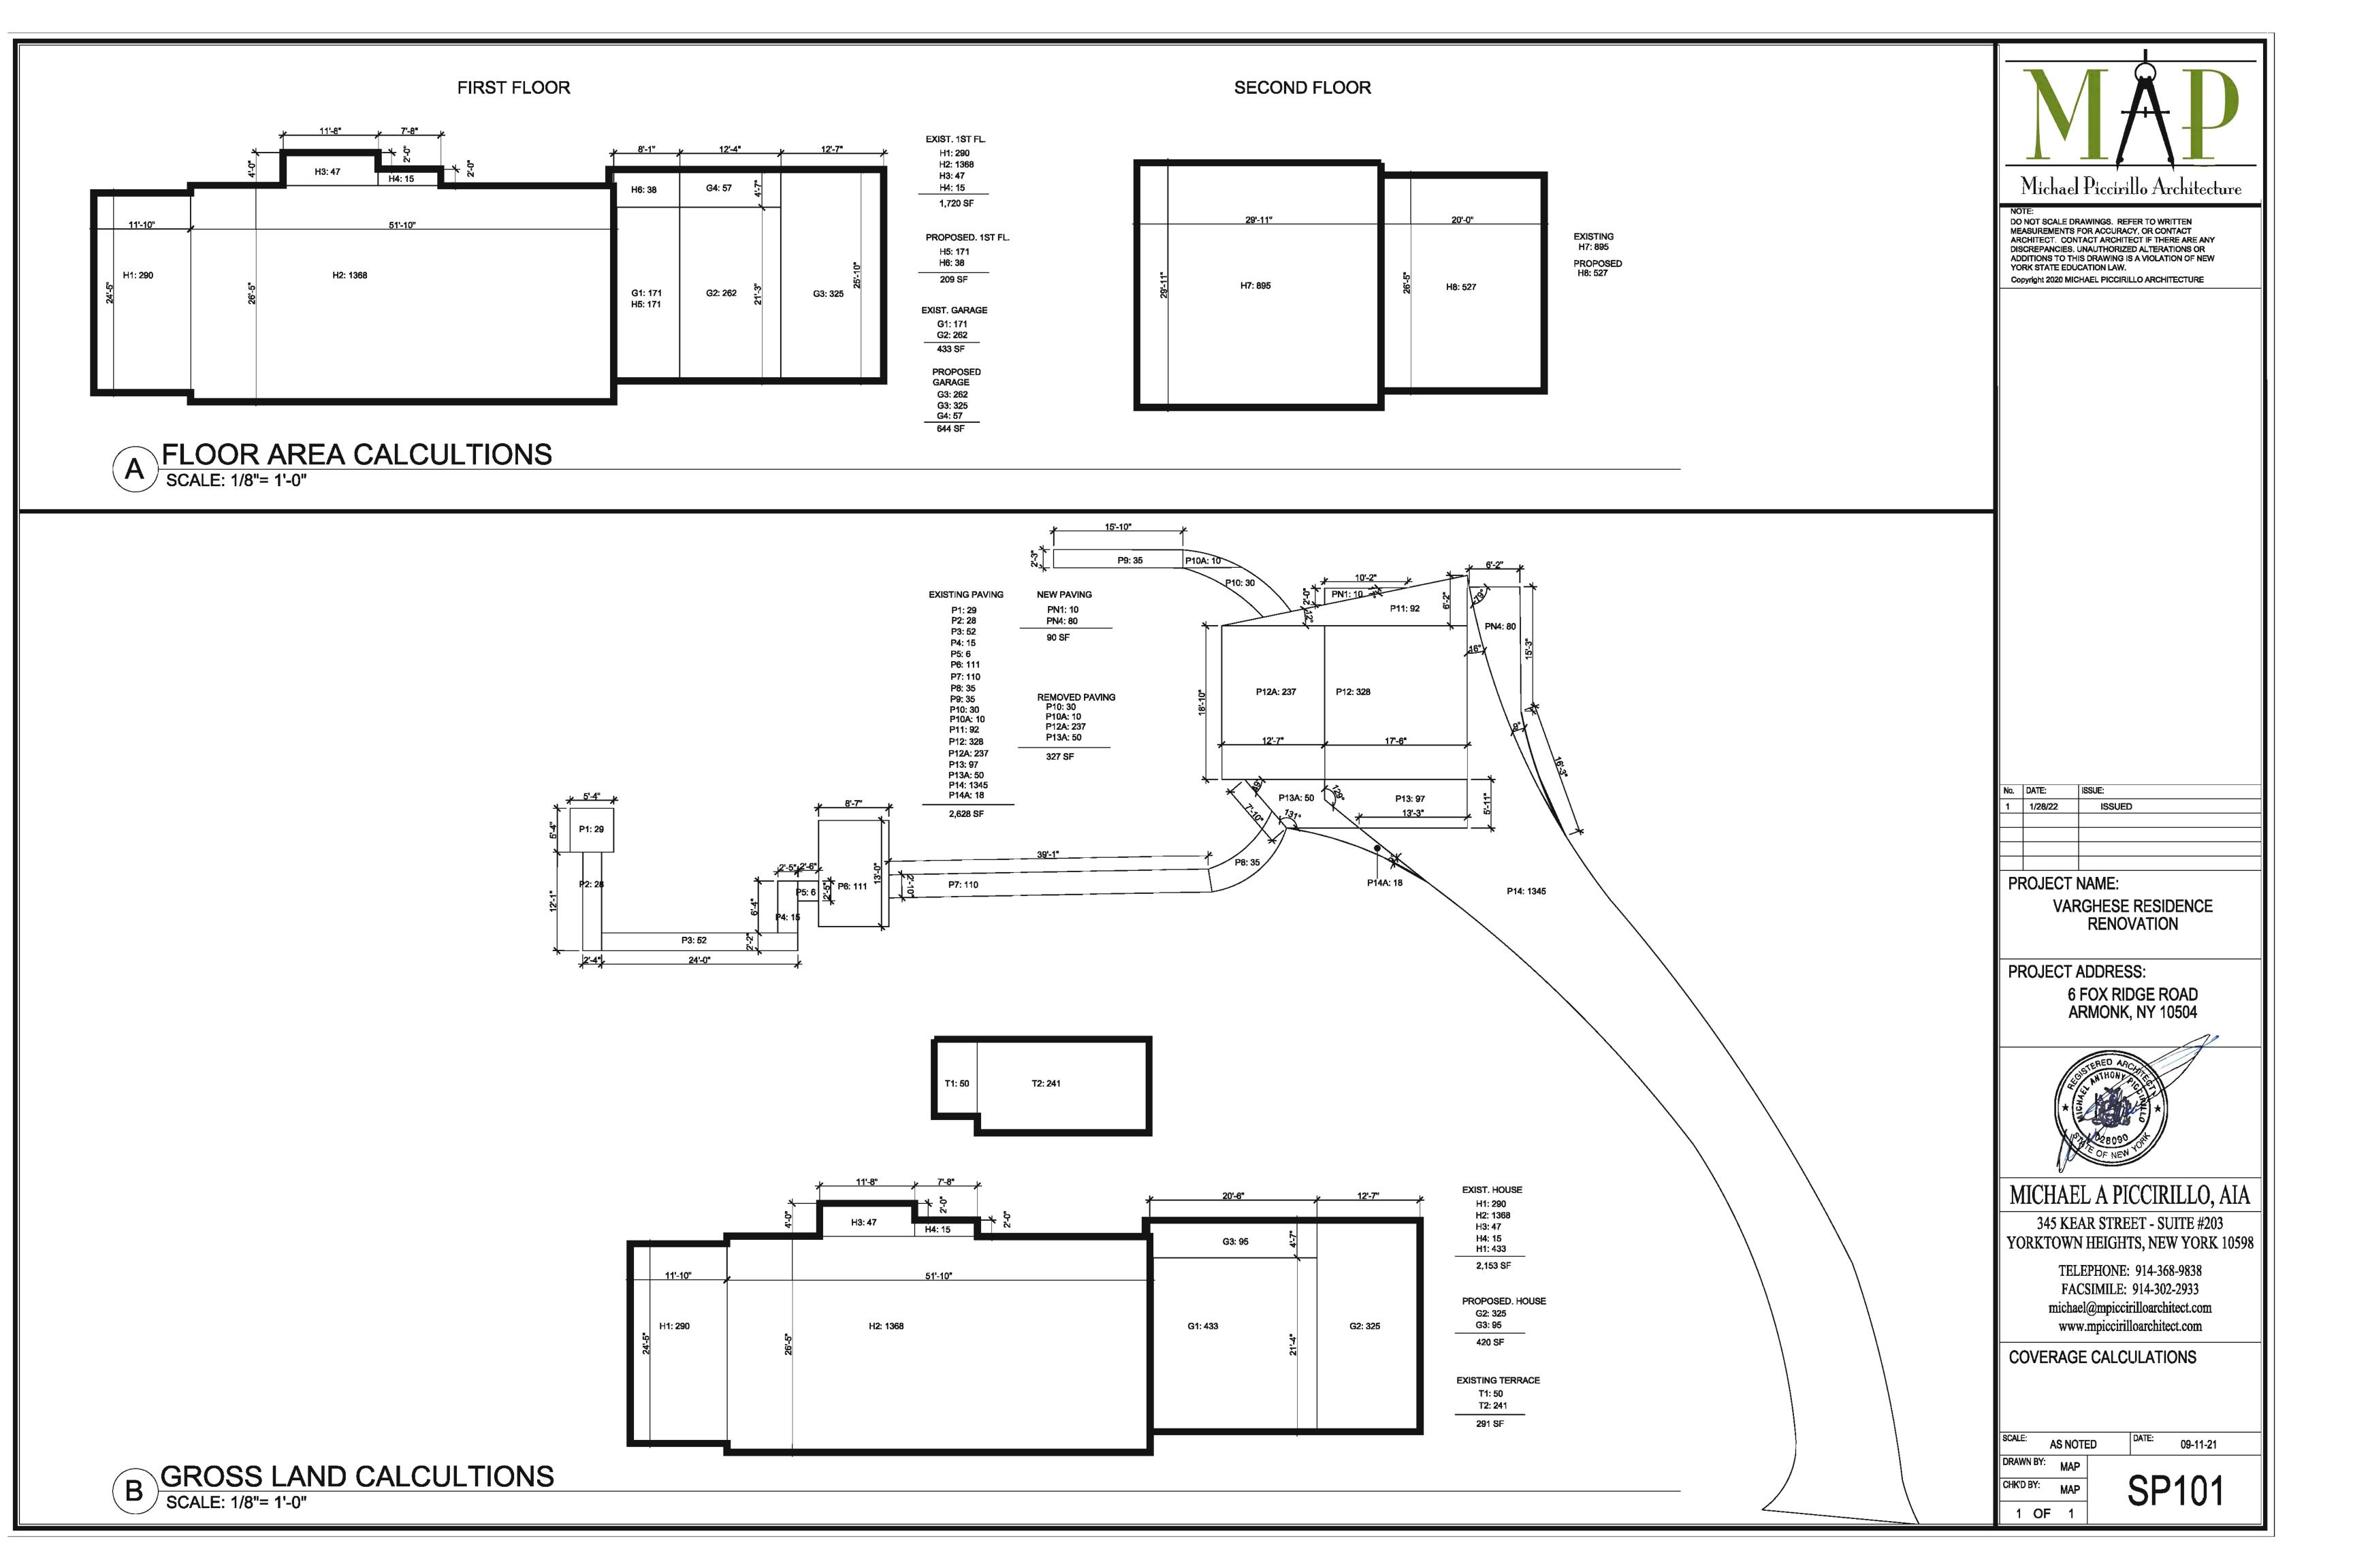
> TELEPHONE: 914-368-9838 FACSIMILE: 914-302-2933 michael@mpiccirilloarchitect.com www.mpiccirilloarchitect.com


SITE PLAN **ZONING DATA**


1 OF 1

09-11-21 DRAWN BY: CHK'D BY:

SP100



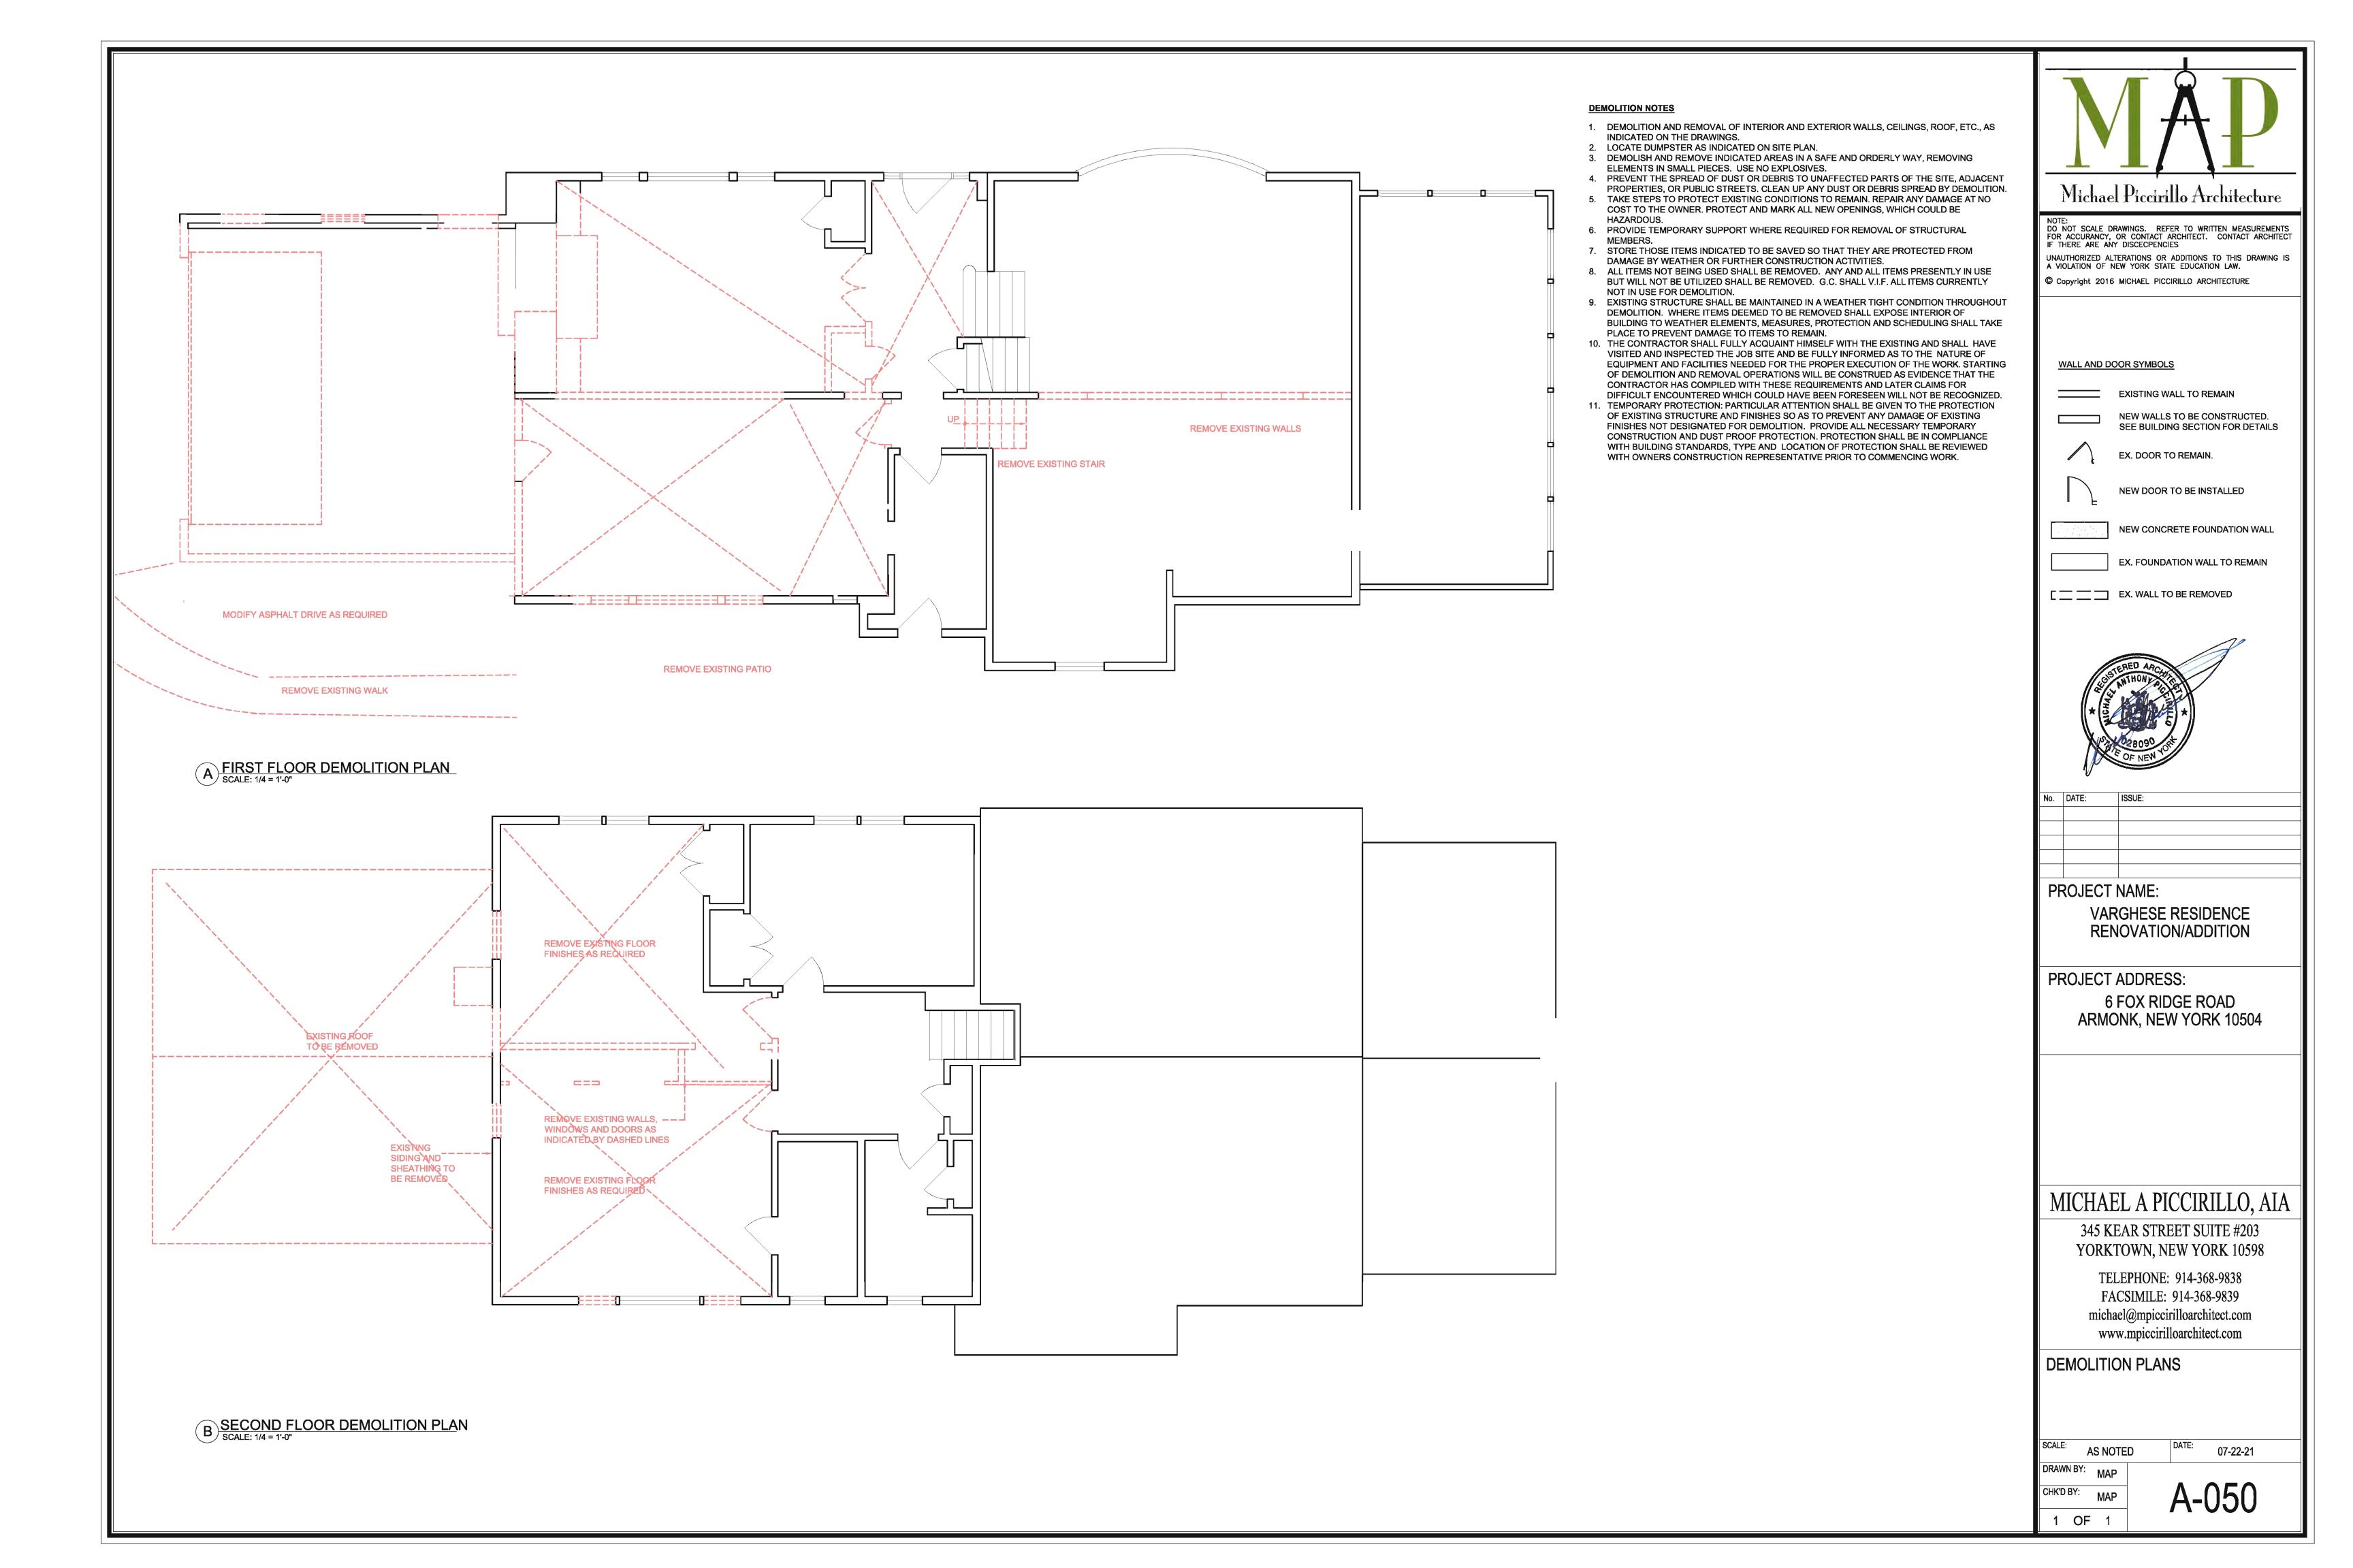

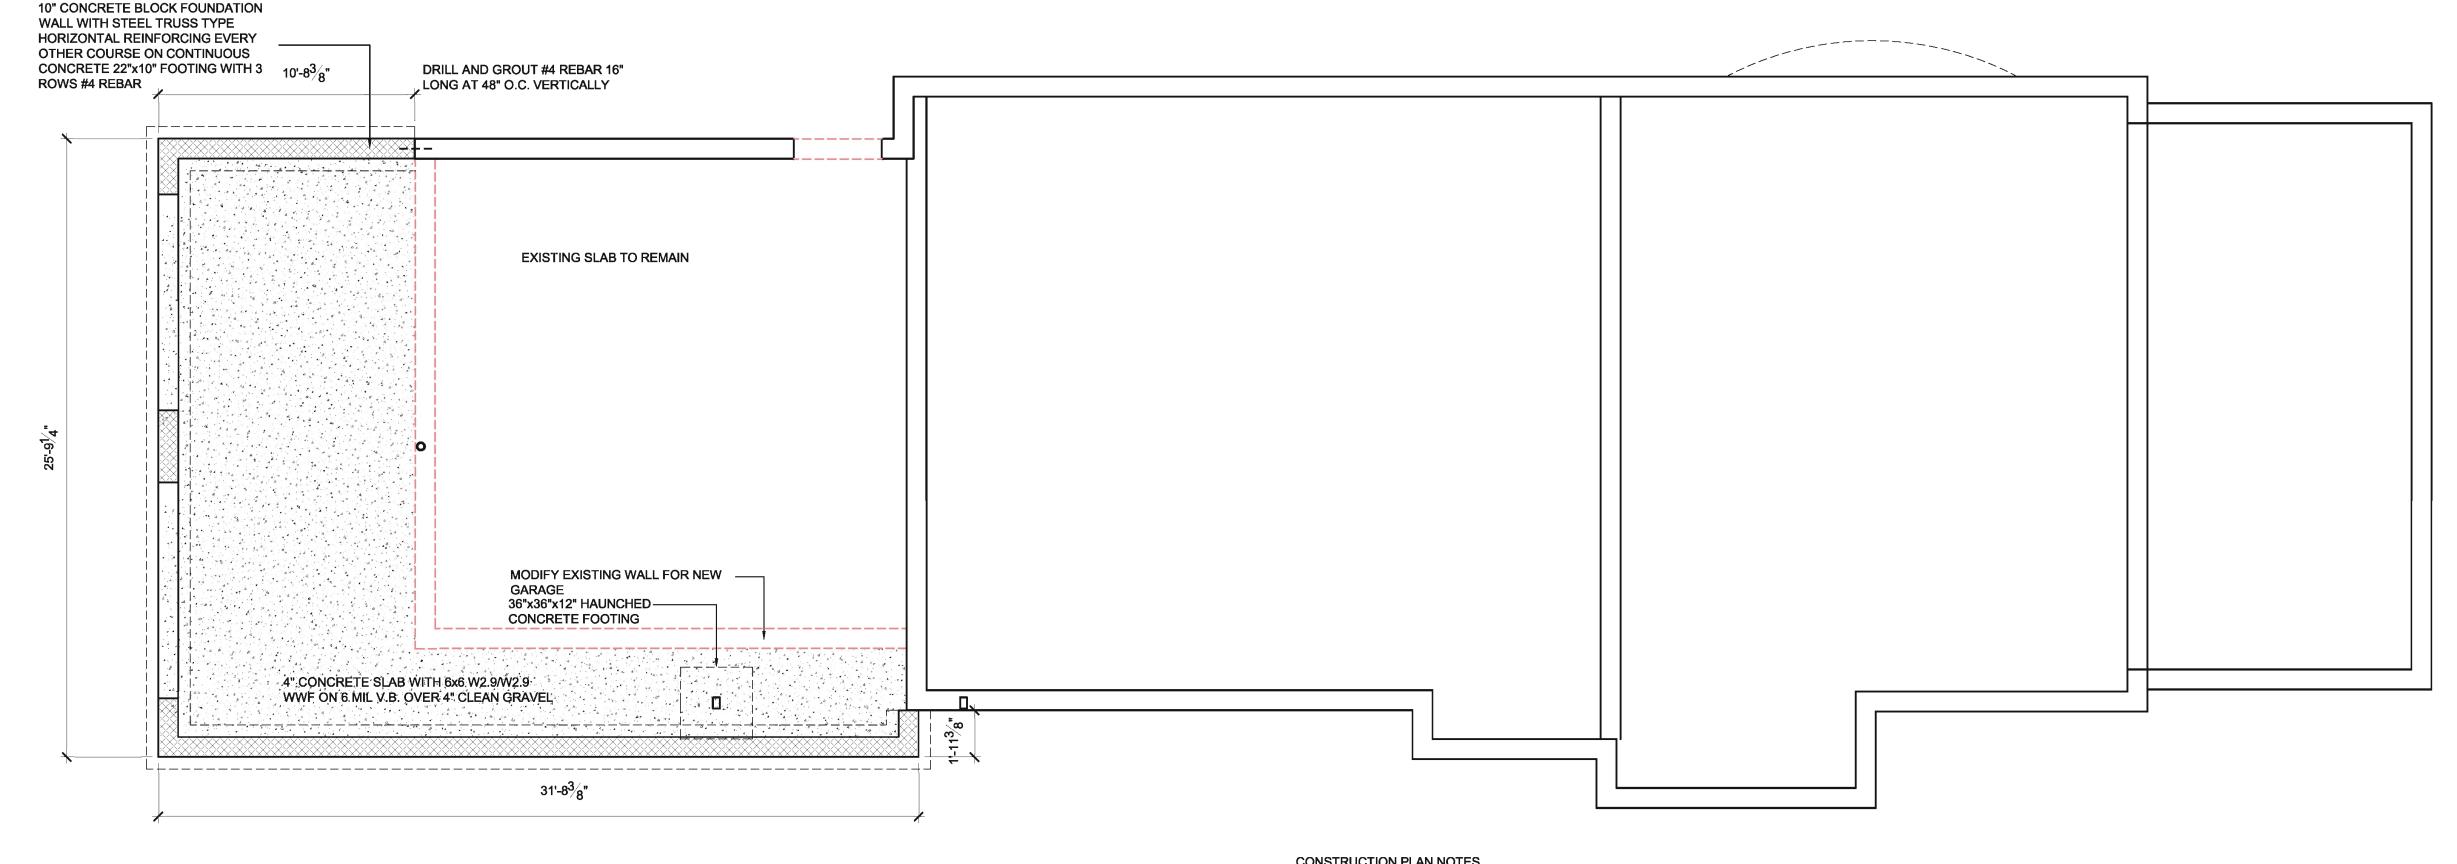

A FIRST FLOOR FOUNDATION PLAN SCALE: 1/4 = 1'-0"

CONSTRUCTION PLAN NOTES

PREPARE EXISTING SUBFLOOR FOR NEW FLOOR FINISHES. PATCH AND REPAIR ALL WALLS DAMAGED BY DEMOLITION TO APPEAR INTEGRAL

PROVIDE SADDLES AND WEATHERSTRIPPING AT ALL EXTERIOR DOORS. ALL PARTITIONS WITH WALL HUNG CABINETS, WALL HUNG FIXTURES, WALL TILE

OR COAT RACKS TO HAVE 2x WOOD STUDS @ 12" O.C. OR AS REQUIRED. 5. SHELVING TO BE PAINT GRADE BIRCH PLYWOOD WITH 1 1/4" HARDWOOD EDGE TYP. IN EVERY CLOSET. PROVIDE ADJUSTABLE SHELVES IN STORAGE OR

PROVIDE COAT ROD. BRACKETS AND SHELVING IN EVERY COAT CLOSET. 6. ALL PIPING NOT BEING CONNECTED TO ACTIVE FIXTURES SHALL BE CUT BACK BELOW LEVEL OF FINISHED FLOOR AND CAPPED PER APPLICABLE CODES AND

ENERAL REQUIREMENTS: G.C. SHALL PROVIDE ALL NECESSARY LABOR, MATERIALS AND EQUIPMENT TO COMPLETE ALL MASONRY SHOWN OR NOTED IN THESE DOCUMENTS. THE GENERAL REQUIREMENTS OF SECTION 1 SHALL APPLY TO ALL WORK UNDER THIS HEADING. A. ALL WORK IN THIS SECTION SHALL COMPLY WITH STATE AND LOCAL

B. MATERIALS: ALL MATERIAL SHALL COMPLY WITH THE LATEST A.S.T.M. STANDARDS. 1. POROUS FILL (AS REQUIRED) - CLEAN GRAVEL OR CRUSHED STONE. NO

CINDERS 2. MORTAR - 1.3 PORTLAND CEMENT MORTAR FOR ALL CONCRETE BLOCKWORK. 1:6 PORLAND CEMENT - LIME MORTAR FOR STONE WORK. NO RETEMPERING PERMITTED.

3. REINFORCING (AS REQUIRED) - DUR-O-WALL TRUSS-TYPE REINFORCING AS NOTED.

4. CONCRETE - MASONRY UNITS (C.M.U.) (AS REQUIRED) - LOAD BEARING STONE CONCRETE - MASONRY UNITS. AS MANUFACTURED BY BEDFORD HILLS CONCRETE PRODUCTS CO. OR APPROVED EQUAL. SIZE AS REQUIRED, AND AS NOTED IN DOCUMENTS.

C. CONCRETE BLOCKWORK SHALL BE REINFORCED ON EVERY SECOND HORIZONTAL JOINT WITH DUR-O-WALL TRUSS-TYPE BLOCK REINFORCEMENT. LAY BLOCKS WITH CELLS VERTICAL AND JOINTS STAGGERED IN EACH COURSE. ALL BLOCKWORK TO BE PROPERLY BONDED TOGETHER AND TO ADJACENT WORK.

D. COMPLY WITH RECOMMENDED METHODS AND PRACTICE AS DESCRIBED BY NATIONAL CONCRETE MASONRY ASSOCIATION STANDARDS AND BRICK INSTITUTE OF AMERICA.

A. EXCAVATION AND EARTHWORK 1. SOILS AT THE BASE OF ALL EXCAVATIONS SHALL HAVE A PRESUMPTIVE BEARING VALUE OF NO LESS THAN 2 TSF.

2. IF SOILS ARE UNSUITABLE AT THE LEVELS SHOWN ON THE DRAWINGS FOR FOUNDATIONS. THE EXCAVATION SHALL BE DEEPENED UNTIL SUITABLE SOILS ARE ENCOUNTERED. 3. SOILS AT THE EXCAVATION LEVEL SHALL BE COMPACTED

TO 95% MAX. DENSITY, ASTM D 1557. 1. ALL CONCRETE SHALL CONFORM TO ACI 318-86 (REV. 1986)

BUILDING CODE, AND ACI DESIGN HANDBOOK 340. IR-84.

2. CONCRETE: Fc = 3500 PSI 3. REINFORCING STEEL: Fy = 60 KSI 4. ALL EXTERIOR CONCRETE REQUIRES AIR ENTRAINMENT. 5. CONCRETE SLUMP SHALL BE NO GREATER THAN 4".

6. CURING IS REQUIRED PER ACI CODE. 7. WELDING REINFORCING STEEL IS PROHIBITED. 8. ANCHOR BOLTS SHALL BE IMBEDDED. OR DRILL-IN. AT THE DISCRETION OF THE CONTRACTOR. ANY EXTERIOR

ANCHOR BOLTS SHALL BE GALVANIZED. C. FIELD VERIFY ALL EXISTING DIMENSIONS AS INDICATED ON

DRAWINGS. 1. GENERAL CONTRACTOR TO LAYOUT ROOM WITH EXISTING CONDITIONS AND FIELD VERIFY PRIOR TO INSTALLING INTERIOR WALLS. NOTIFY ARCHITECT OF ANY DISCREPANCIES.

RENOVATION/ADDITION

No. DATE:

PROJECT NAME:

PROJECT ADDRESS: 6 FOX RIDGE ROAD ARMONK, NEW YORK 10504

VARGHESE RESIDENCE

Michael Piccirillo Architecture

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UNAUTHORIZED ALTERATIONS OR ADDITIONS TO THIS DRAWING IS

EXISTING WALL TO REMAIN

EX. DOOR TO REMAIN.

EX. WALL TO BE REMOVED

NEW DOOR TO BE INSTALLED

NEW CONCRETE FOUNDATION WALL

EX. FOUNDATION WALL TO REMAIN

NEW WALLS TO BE CONSTRUCTED. SEE BUILDING SECTION FOR DETAILS

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IF THERE ARE ANY DISCECPENCIES

WALL AND DOOR SYMBOLS



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PROPOSED PLAN

CHK'D BY:


AS NOTED 09-11-21 DRAWN BY: MAP

MAP

OF 1

CAST-IN -PLACE CONCRETE

- 1. DO ALL WORK IN CONFORMANCE WITH AMERICAN CONCRETE INSTITUTE STANDARDS. PERFORM ALL WORK IN ACCORDANCE WITH ACI-318 BUILDING CODE REQUIREMENTS FOR REINFORCED CONCRETE AND ACI-301 SPECIFICATIONS FOR STRUCTURAL CONCRETE FOR BUILDINGS, UNLESS SPECIFIED OTHERWISE.
- 2. INSPECTION AND TESTING (INCLUDING BUT NOT LIMITED TO TEST CYLINDERS: TAKE THREE TEST CYLINDERS FROM EACH POUR, LABEL WITH DATE AND LOCATION PLACED, AND DELIVER TO OWNER FOR TESTING) OF CONCRETE WORK AND CONCRETE MIX SHALL BE PERFORMED IN ACCORDANCE OF THE LOCAL BUILDING DEPARTMENT.
- 3. CONTRACTOR SHALL VERIFY DIMENSIONS AND LOCATIONS OF ALL OPENINGS, PIPE SLEEVES, ANCHOR BOLTS, ETC., AS REQUIRED BY ALL TRADES, BEFORE CONCRETE IS PLACED. 4. PROVIDE SAND AND GRAVEL BASE.
- 5. WELDED WIRE FABRIC SHALL BE 6" X 6" W2.9/W2.9 SIZE PLAIN FINISH CONFORMING TO ASTM A185 UNLESS OTHERWISE INDICATED. ALL REINFORCING BARS SHALL CONFORM TO ASTM SPEC A615 GRADE 60.
- 6. REINFORCING STEEL SHALL BE BILLET STEEL BARS, GRADE 60, GALVANIZED FINISH, CONFORMING TO ASTM A615. COMPLETE WITH ALL ACCESSORIES SUCH AS CHAIRS, BAR SUPPORTS, SPACERS, TIE WIRE, ETC.
- 7. SCREED AND FINISH CONCRETE SMOOTH AND LEVEL OR SLOPED AS INDICATED TO RECEIVE FURTHER CONSTRUCTION. EXTERIOR PAVEMENTS TO HAVE BROOMED FINISH.
- 8. ALL CONCRETE DESIGN AND PLACEMENT SHALL COMPLY WITH THE LATEST EDITION OF THE ACI 301, "SPECIFICATION FOR STRUCTURAL CONCRETE FOR BUILDINGS". HOT WEATHER CONCRETING SHALL BE IN ACCORDANCE WITH ACI 305. COLD WEATHER CONCRETING SHALL BE IN ACCORDANCE WITH ACI 306. ALL OTHER APPLICABLE CODES SHALL ALSO BE
- 9. CONCRETE SHALL BE NORMAL WEIGHT CONCRETE EXCEPT LIGHT WEIGHT CONCRETE SHALL BE USED FOR SLABS ON STEEL DECK UNLESS NOTED OTHERWISE. CONCRETE SHALL DEVELOP A MINIMUM COMPRESSIVE STRENGTH OF 3,500 PSI
- AT 28 DAYS FOR FOUNDATIONS. SLUMP SHALL NOT EXCEED 4". 10. REINFORCEMENT SHALL BE DEFORMED INTERMEDIATE GRADE NEW BILLET STEEL CONFORMING TO ASTM DESIGNATION A-615, GRADE 60. WELDED WIRE FABRIC SHALL CONFORM TO ASTM A-185.
- 11. FOLLOW ACI RULES AS TO TIES, ANCHORAGE, SPLICES, CONCRETE COVERAGE AND REINFORCEMENT SUPPORTS. 12. REINFORCEMENT MARKED "CONTINUOUS" (CONT.) SHALL BE LAPPED 36 BAR DIAMETERS AT SPLICES AND CORNERS, AND
- HOOKED AT NON-CONTINUOUS ENDS OR EXTENDED 36 BAR DIAMETERS UNLESS OTHERWISE NOTED. 13. CONSTRUCTION JOINTS SHALL BE LOCATED AT POINTS OF ZERO SHEAR. NO CONSTRUCTION JOINTS SHALL BE LOCATED IN MEMBERS CARRYING A CONCENTRATED LOAD. PROVIDE SHEAR BARS AS DIRECTED BY THE ENGINEER. LOCATIONS OF
- CONSTRUCTION JOINTS SHALL BE ACCEPTED BY THE ENGINEER. 14. PROVIDE SLEEVES AND BOX OUT FOR OPENINGS FOR MECHANICAL TRADES FOR SIZE AND LOCATION OF ALL OPENINGS. SEE ARCHITECTURAL AND MECHANICAL DRAWINGS IN ADDITION TO STRUCTURAL DRAWINGS. OPENINGS SHALL BE PLACED SO AS NOT TO AFFECT THE STRENGTH OF THE STRUCTURAL MEMBERS.

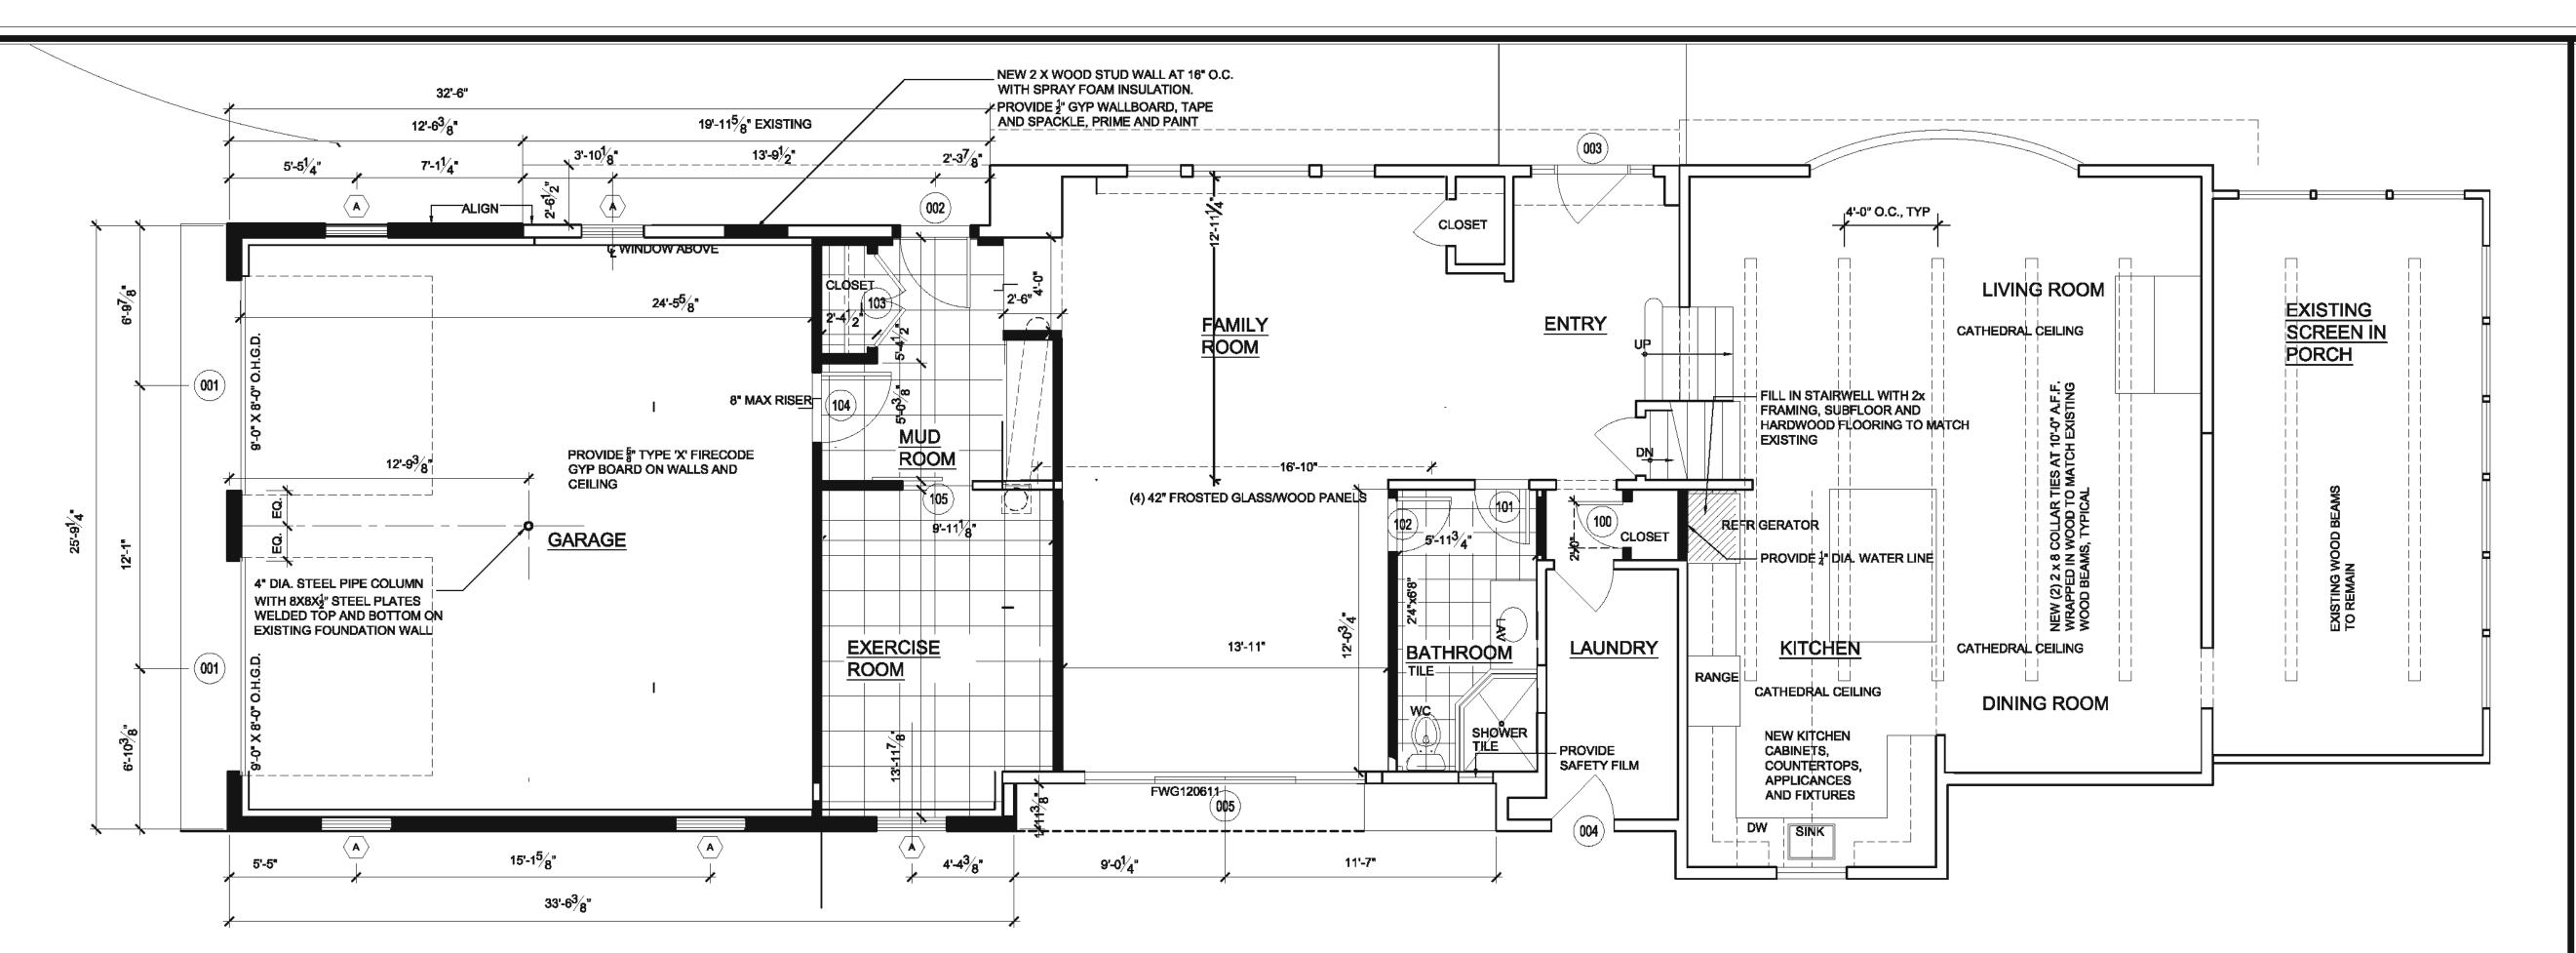

Direct vent and mechanical draft vent

(30.48 cm) min.

A FIRST FLOOR PLAN SCALE: 1/4 = 1'-0"

 $(0.9 \, \text{m})$ Mechanical draft vent ANY DIRECTION FROM OPENING INTO BUILDING Direct vent and mechanical BACKDRAFT DAMPER. 4. RANGE HOOD W/ EXHAUST TO EXTERIOR. draft vent terminal


Forced air inlet

EXISTING SSDS TANK VERIFY LOCATION

5. PROVIDE MAKE-UP AIR FOR HOOD SYSTEM CAPABLE OF 6. MAKE UP AIR SHALL BE APPROX. EQUAL TO EXHAUST AIR

DRYER EXHAUST TO EXTERIOR OF BUILDING (UNLESS DRYER IS LISTED AND LABELED AS CONDENSING (DUCTLESS DRYER).

- 2. DUCT TERMINATION SHALL NOT BE LESS THAN 3 FEET IN
- 3. DUCT SHALL BE 4" NOMINAL DIAMETER, MIN. 28 GAGE METAL, WITH SMOOTH INTERIOR, AND BE EQUIPPED W/
- INEXCESS OF 400 CFM. MAKEUP AIR SYSTEM MODEL No. MUAS BY FANTECH OR APPROVED EQUAL

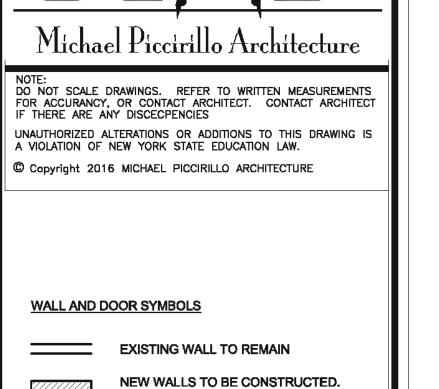

SEE BUILDING SECTION FOR DETAILS

NEW CONCRETE FOUNDATION WALL EX. FOUNDATION WALL TO REMAIN

EX. DOOR TO REMAIN.

NEW DOOR TO BE INSTALLED

EX. WALL TO BE REMOVED

PROJECT NAME:

No. DATE:

VARGHESE RESIDENCE RENOVATION/ADDITION

PROJECT ADDRESS: 6 FOX RIDGE ROAD ARMONK, NEW YORK 10504



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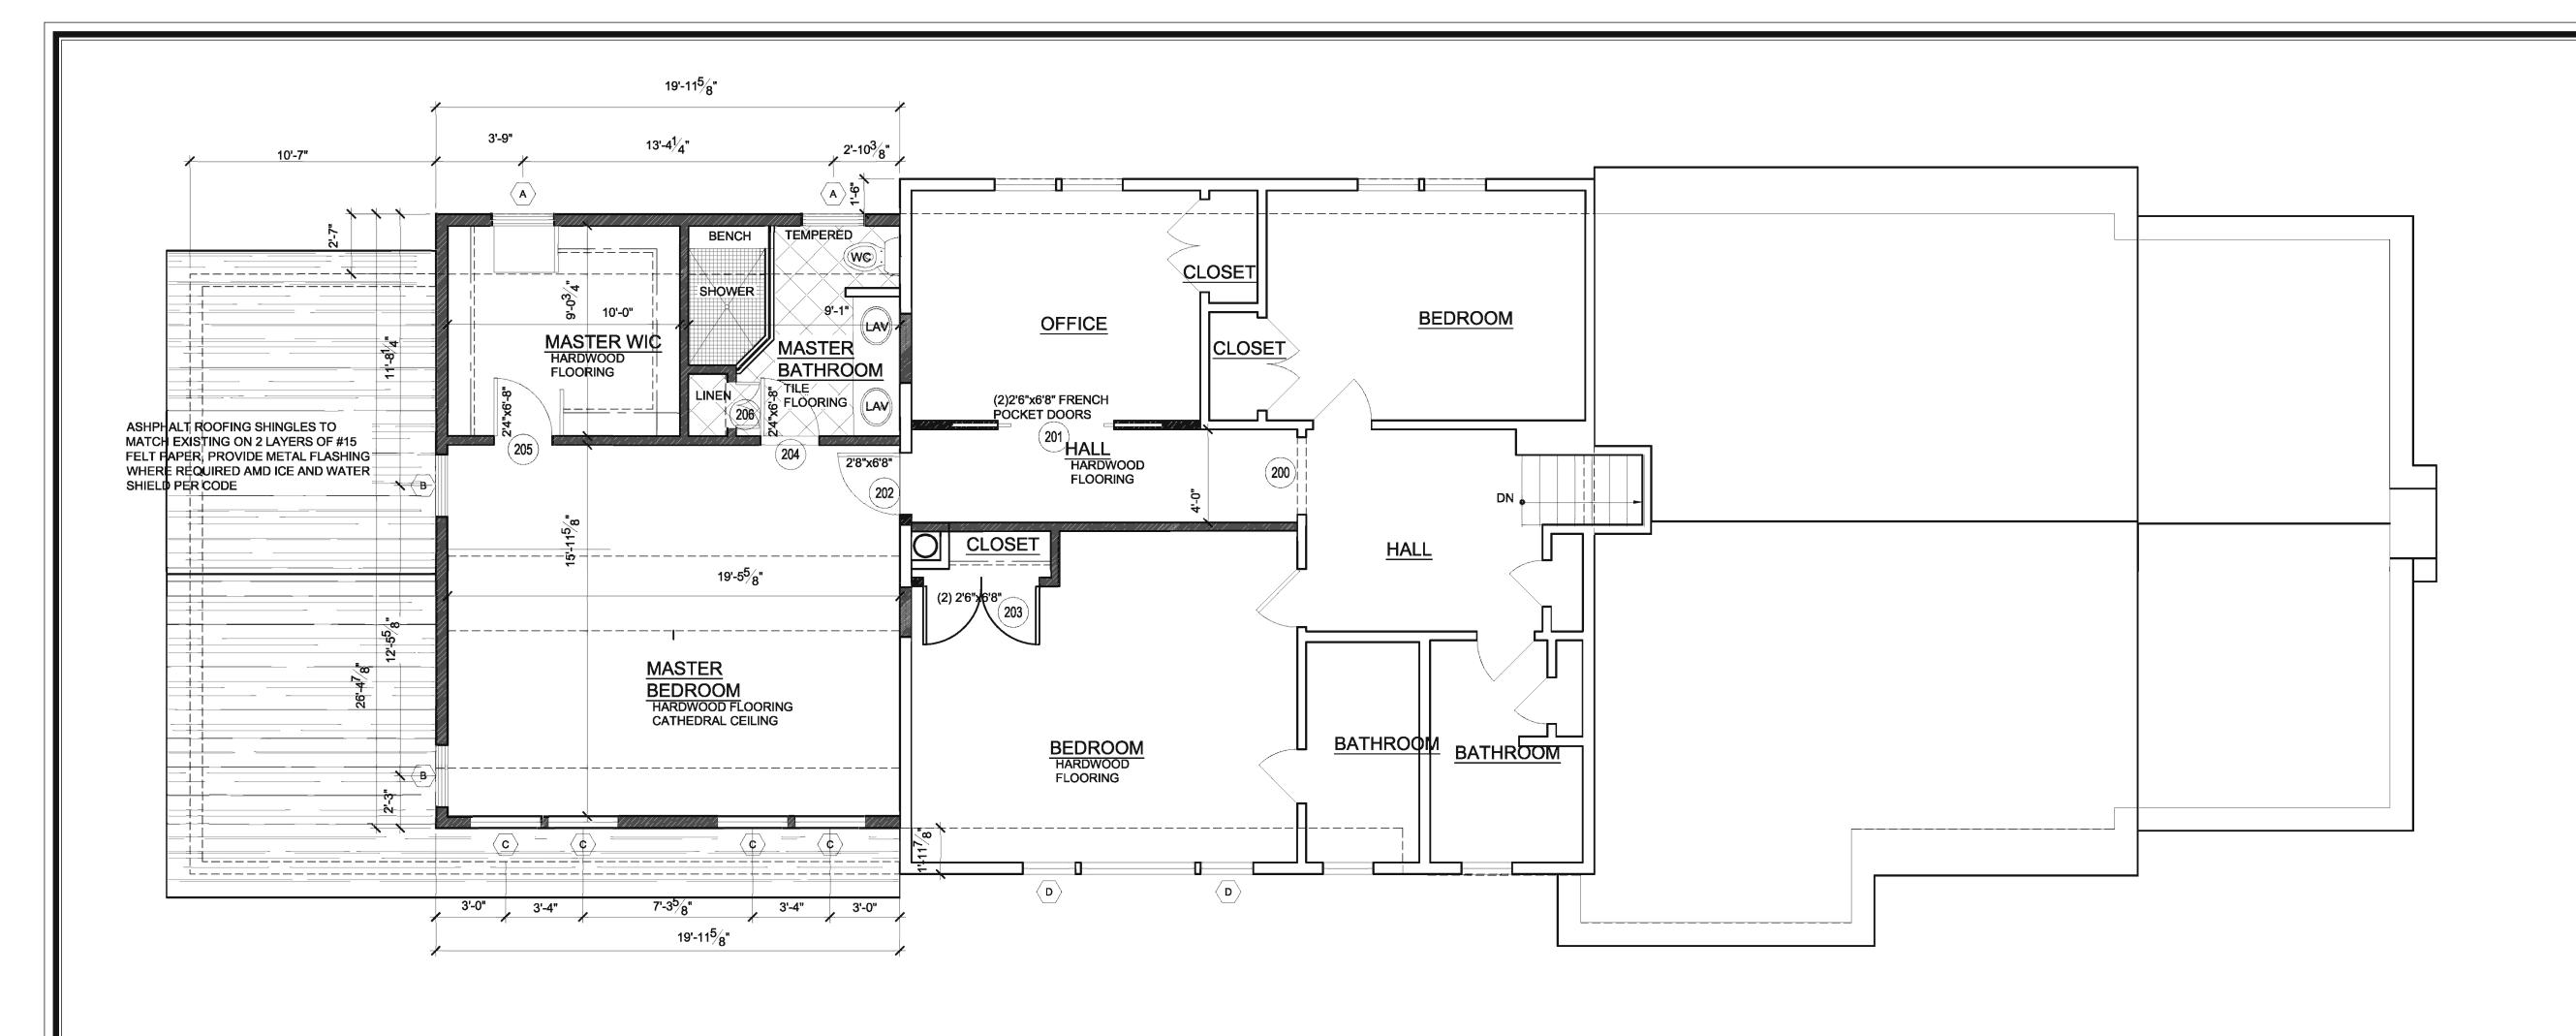
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PROPOSED PLAN


09-11-21 **AS NOTED** DRAWN BY: MAP

A-101 CHK'D BY: 1 OF 1

Note: All distances are measured from the nearest point of the air inlet or draft vent terminal. PRESCRIPTIVE VENT REQUIREMENTS C SCALE: 1/2 = 1'-0"



A SECOND FLOOR PLAN
SCALE: 1/4 = 1'-0"

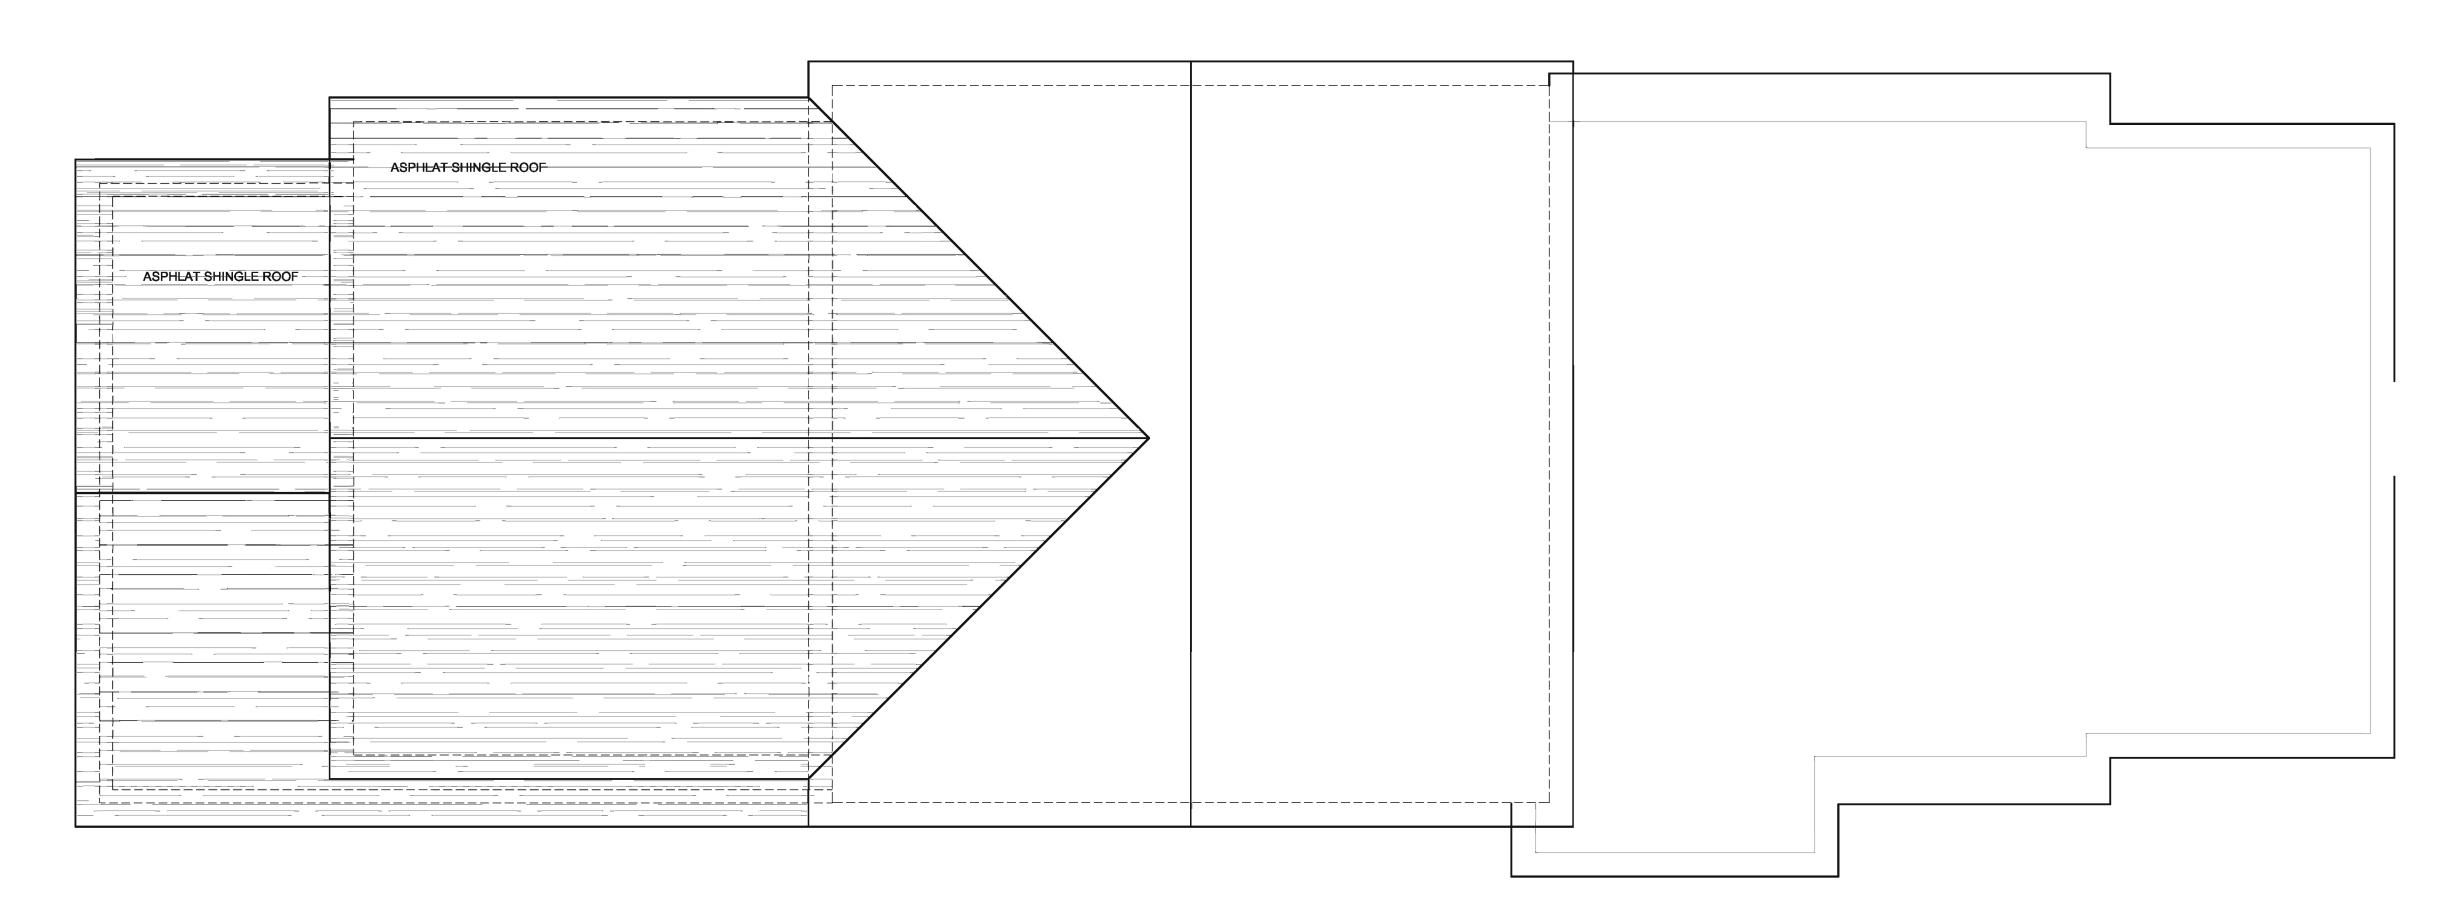

Michael Piccirillo Architecture

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No. DATE: ISSUE:

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PROPOSED PLAN


1 **OF** 1


 SCALE:
 AS NOTED
 DATE:
 09-11-21

 DRAWN BY:
 MAP

 CHK'D BY:
 MAP

B ROOF PLAN
SCALE: 1/4 = 1'-0"

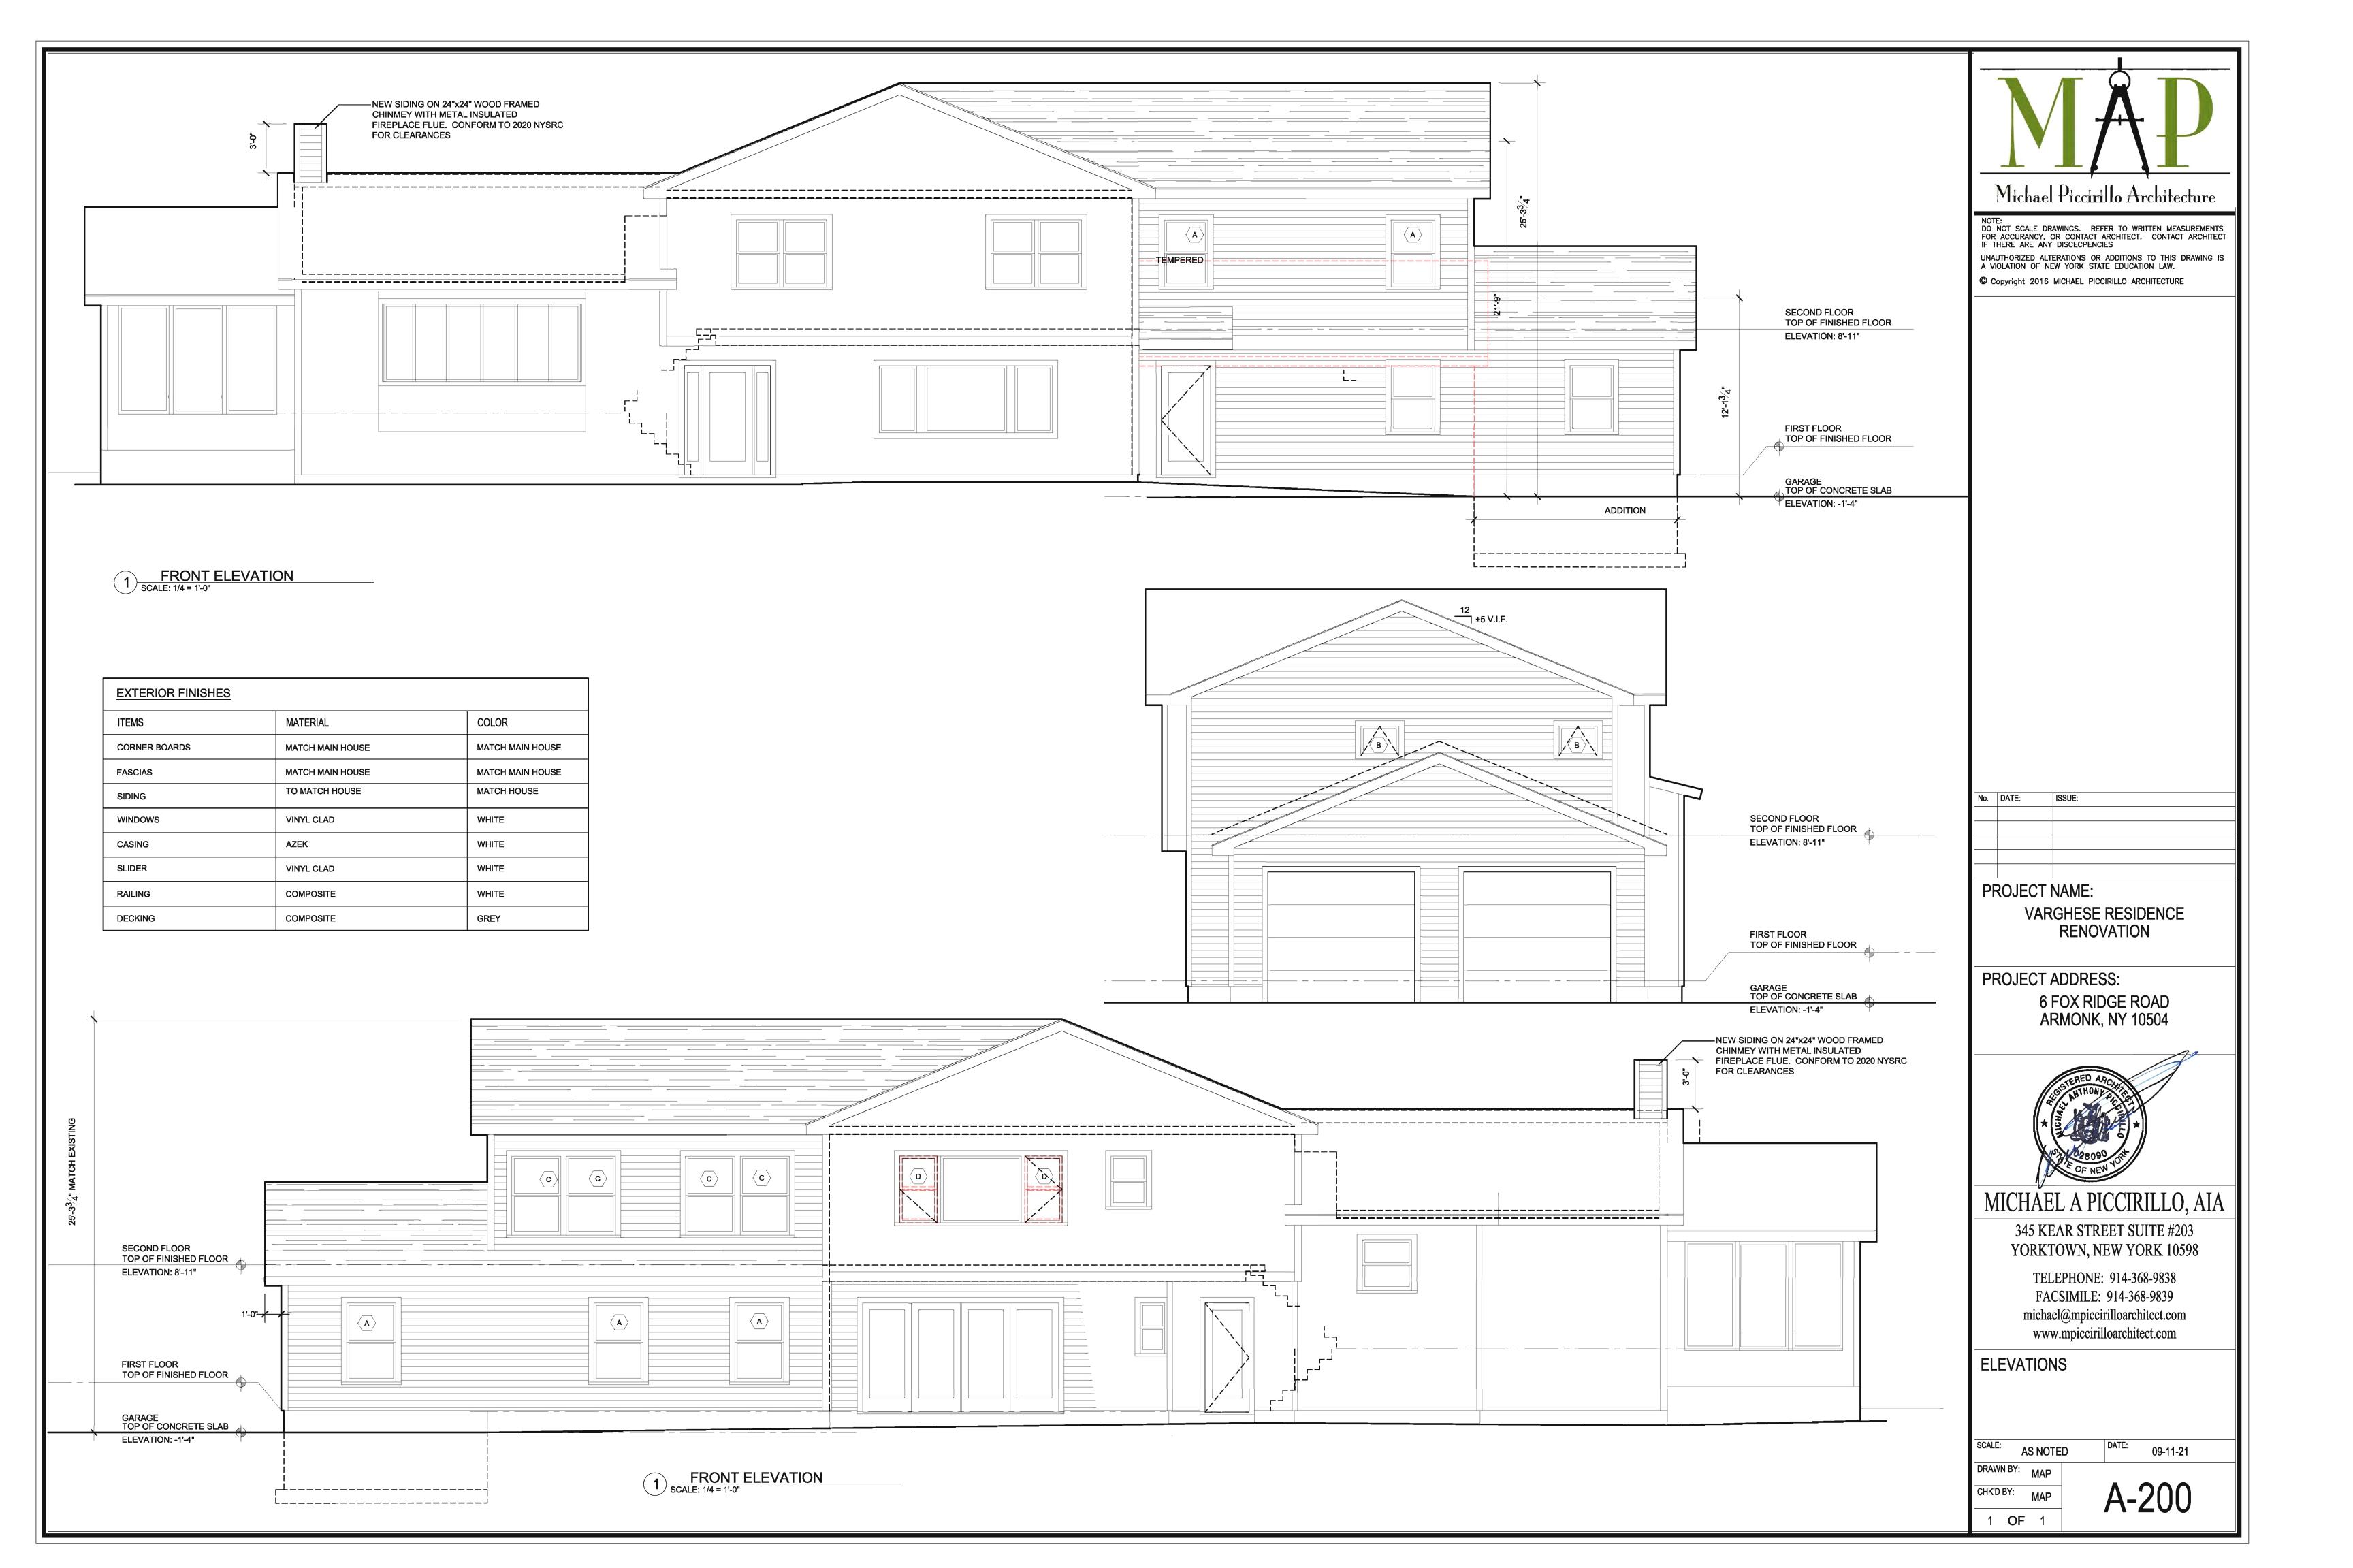

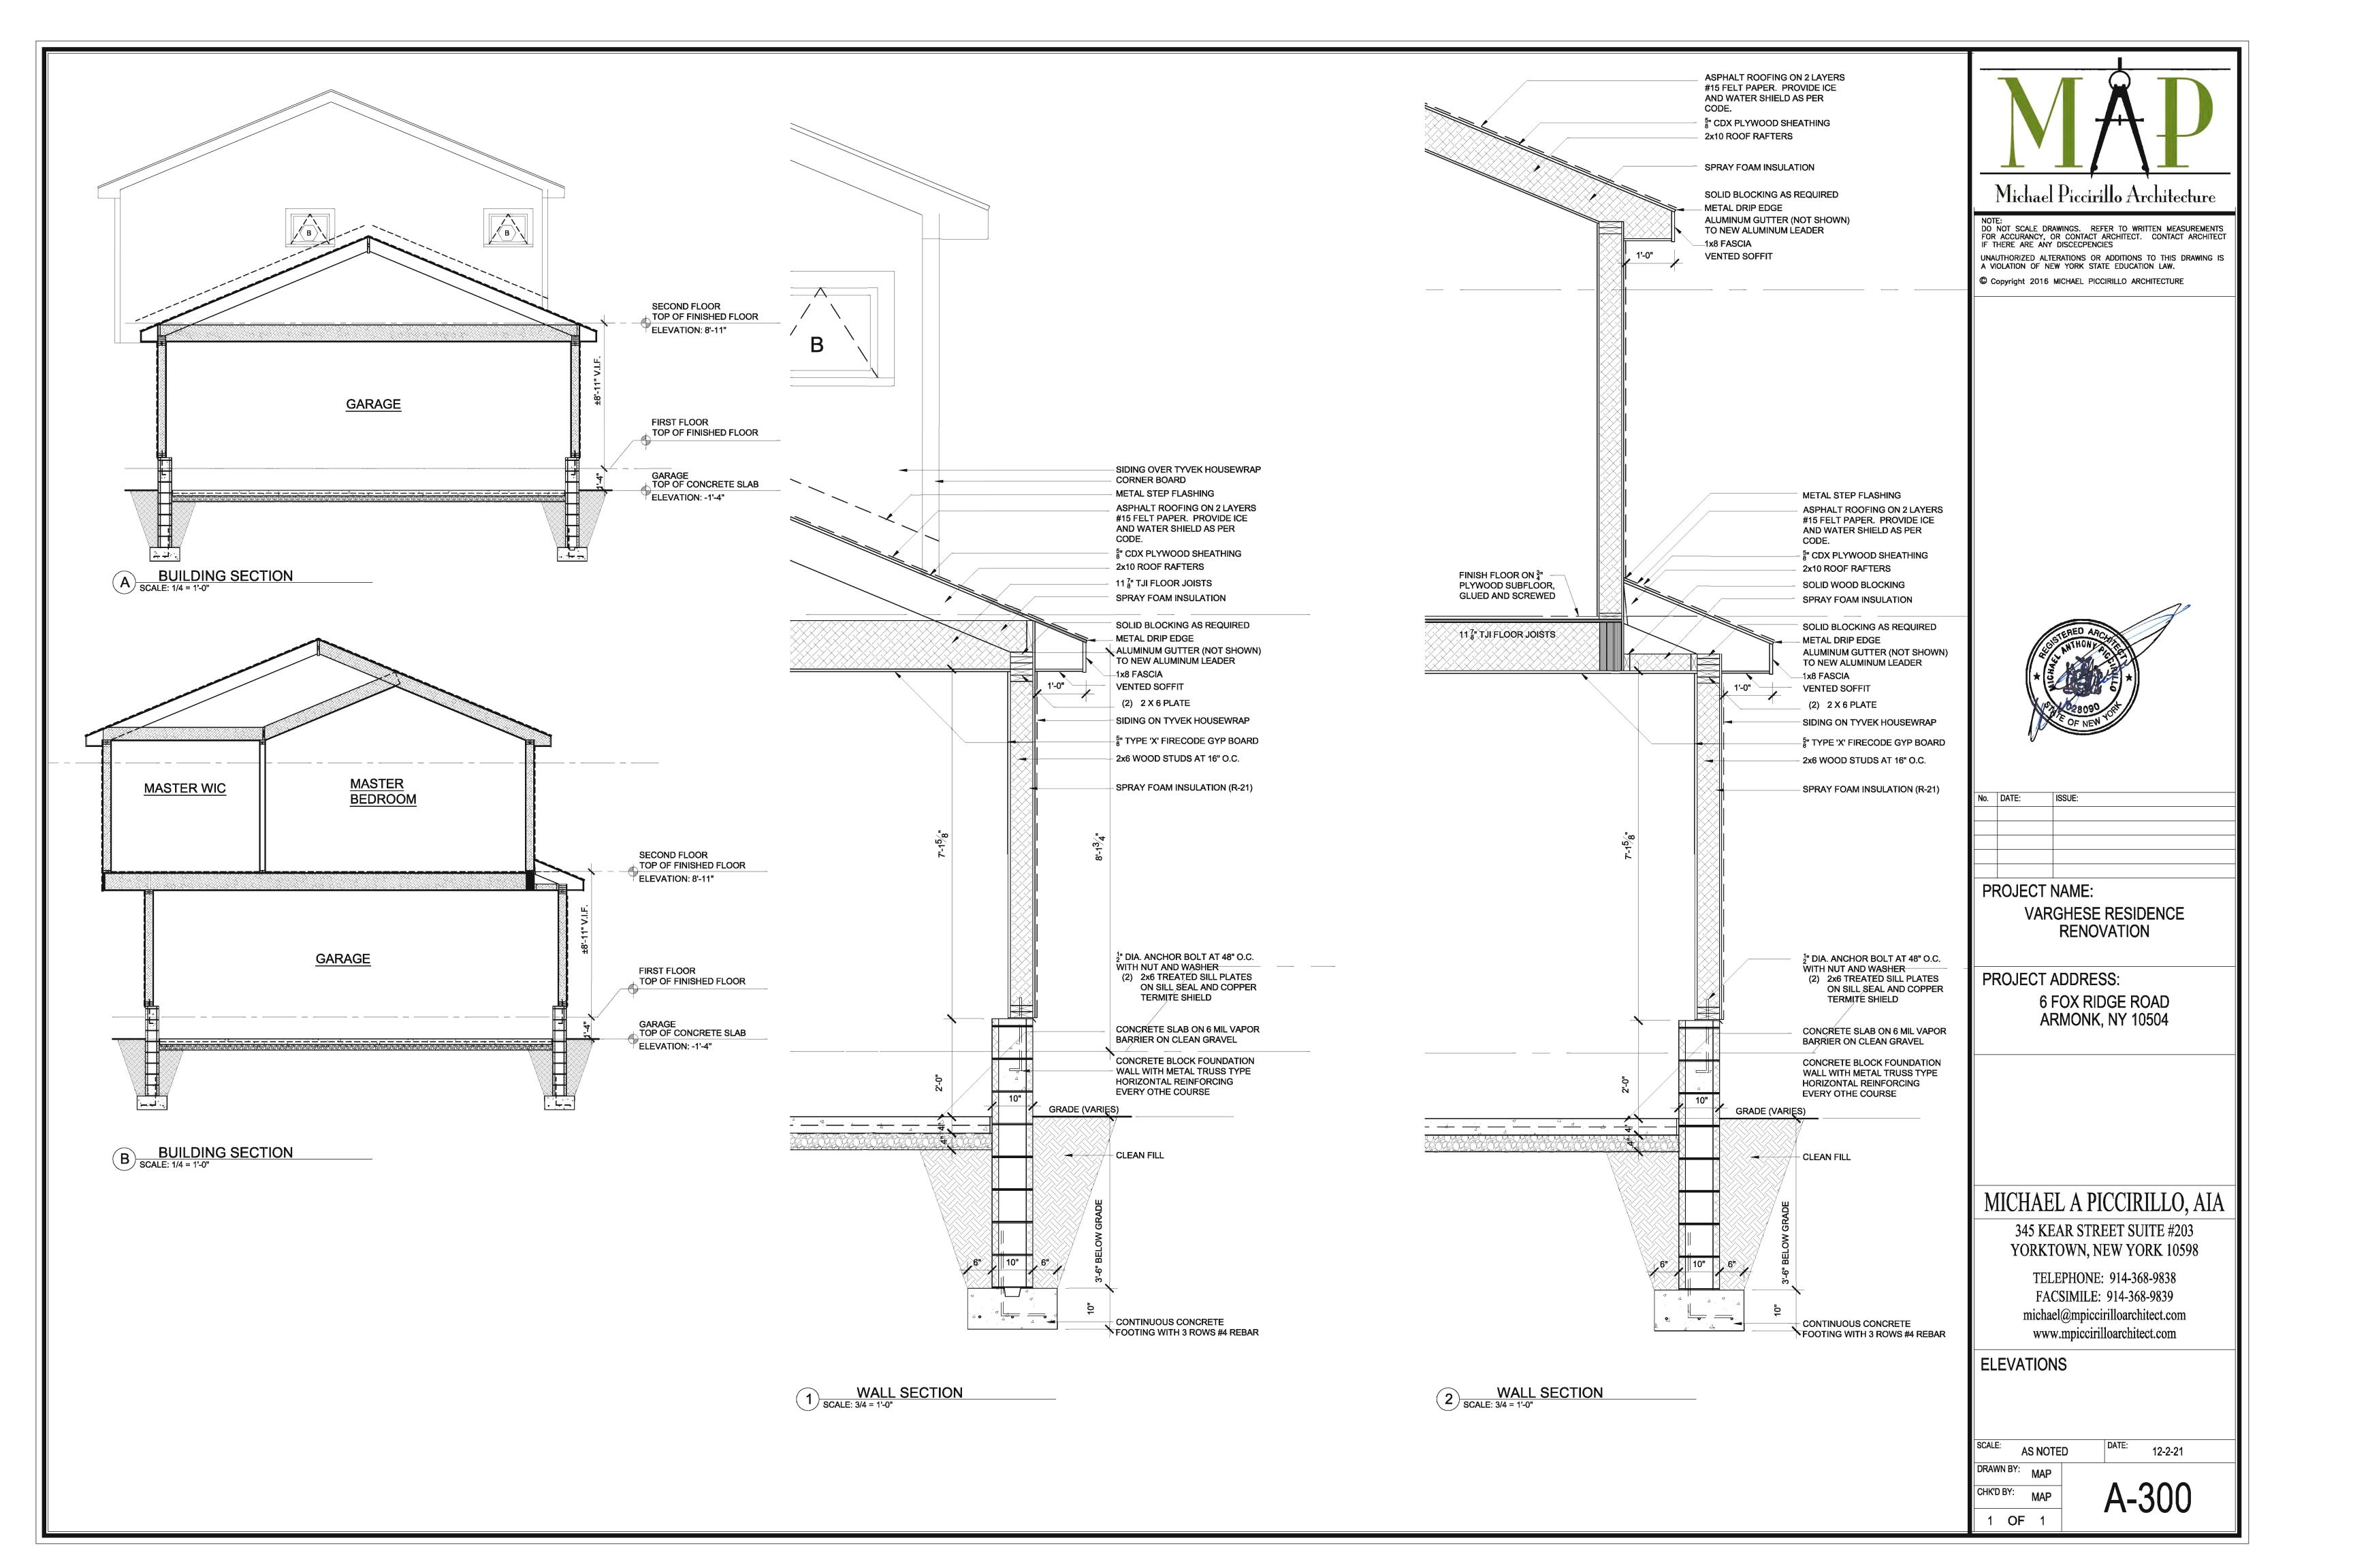

WI	NDOW	SCHEDU	LE					
WINDOW MARK	MODEL NUM.	WINDOW ROUGH OPENING (Width x Height)	WINDOW TYPE	INTERIOR CASING	EXTERIOR CASING	MUNTIN PATTERN	HARDWARE	REMARKS
A	TW2640	2'-8 ¼" x 4'-4 ½"	DOUBLE HUNG	MATCH EXISTING	VINYL MATCH EXISTING	SEE ELEVATION	MATCH EXISTING	BUG SCREEN
В	A251	2'-4 7/8" x 2'-0 5/8"	AWNING	MATCH EXISTING	VINYL MATCH EXISTING	SEE ELEVATION	MATCH EXISTING	BUG SCREEN
С	TW210410	3'-0 1/8" x 5'-0 7/8"	DOUBLE HUNG	MATCH EXISTING	VINYL MATCH EXISTING	SEE ELEVATION	MATCH EXISTING	BUG SCREEN
D	REPLACEMENT EGRESS WINDOW	± 2'-3" x 4'-3" V.I.F.	CASEMENT	MATCH EXISTING	VINYL MATCH EXISTING	SEE ELEVATION	MATCH EXISTING	BUG SCREEN 90° EGRESS HARDWARE

WINDOW SPECIFICATION WINDOW SHOP DRAWINGS MUST BE SUBMITTED TO THE ARCHITECT.

- 1. ALL WINDOWS SCHEDULED ARE MANUFACTURED BY ANDERSEN WINDOW COMPANY.
- 2. VINYL CLAD EXTERIOR: COLOR: WHITE
- 3. INTERIOR FINISH: COLOR: WHITE INTERIOR (MATCH EXISTING)
- 4. EXTERIOR TRIM: MATCH EXISTING 5. SPACER BAR: YES
- 6. GLAZING: INSULATED LOW-E 272 GLASS WITH ARGON GAS,
- HARDWARE: MATCH EXISTING 8. WINDOW SCREENS: MATCH EXISTING
- 9. PROVIDE SAFETY GLAZING WHERE REQUIRED BY THE 2020 RESIDENTIAL CODE OF NEW YORK STATE.

DOOR NUMBER	LOCATION	MODEL NUMBER DOOR OPENING (W x H xTHICKNESS)	DOOR TYPE	DOOR MATERIAL	DOOR & FRAME FINISH	FRAME MATERIAL	HARDWARE SET	REMARKS
001	GARAGE	T.B.D. \$3,000 ALLOWANCE PER DOOR 9'-0" x 8'-0" x 1 \(\frac{3}{4}"\)	NSULATED OVERHEAD GARAGE DOOR	WOOD / GLASS	WOOD	WOOD	ENTRY LOCKSET WEATHER-STRIPPING	3/4 HP MOTOR, KEYPADS, REMOTE
002	MUDROOM	T.B.D. 3'-0" x 6'-8" x 1 ¾"	ENTRY	WOOD / GLASS	WOOD	WOOD	ENTRY LOCKSET WEATHER-STRIPPING	ALUMINUM SILL
003	ENTRY	EXISTING	ENTRY					
004	LAUNDRY	EXISTING	ENTRY					
004	FAMILY ROOM	FWG 120611 12'-0" x 6'-11"	QUAD GLIDER	WOOD / GLASS	WOOD	WOOD	ENTRY LOCKSET WEATHER-STRIPPING	ALUMINUM SILL
100	CLOSET	4 PANEL 2'-0" x 6'-8" x 1 ¾"	SINGLE	MDF	PAINT	WOOD	PASSAGE	
101	BATHROOM	6 PANEL 2'-4" x 6'-8" x 1 ¾"	SINGLE	MDF	PAINT	WOOD	BATHROOM LOCKSET	MARBLE SADDLE
102	BATHROOM	6 PANEL 2'-4" x 6'-8" x 1 ¾"	SINGLE	MDF	PAINT	WOOD	BATHROOM LOCKSET	MARBLE SADDLE
103	CLOSET	4 PANEL (2) 2'-0" x 6'-8" x 1 ³ / ₄ "	DOUBLE	MDF	PAINT	WOOD	DUMMY KNOBS BALL CATCHES	
104	MUDROOM	6 PANEL 3'-0" x 6'-8" x 1 ⅔"	SINGLE	MDF	PAINT	WOOD	ENTRY WITH MORTISE, SELF CLOSING HINGES	C LABEL FIRE RATED DOOR AND FRAME
105	MUDROOM	T.B.D. BY OWNER 3'-0" x 6'-8" x 1 ³ / ₄ "	BARN	T.B.D.	PAINT	WOOD	BARN DOOR BY OWNER	
200	HALL	3'-4" x 6'-8"	TRIMMED OPENING		PAINT	WOOD		
201	HALL	FRENCH 2'-6" x 6'-8" x 1 ² / ₄ "	DOUBLE POCKET	GLASS / MDF	PAINT	WOOD	THUMB PULL	POCKET DOOR HARDWARE
202	MASTER BEDROOM	6 PANEL 2'-8" x 6'-8" x 1 ¾"	SINGLE	MDF	PAINT	WOOD	BEDROOM LOCKSET	
203	BEDROOM	6 PANEL 2'-6" x 6'-8" x 1 ¾"	DOUBLE	MDF	PAINT	WOOD	DUMMY KNOBS BALL CATCHES	
204	MASTER BATHROOM	6 PANEL 2'-4" x 6'-8" x 1 ¾"	SINGLE	MDF	PAINT	WOOD	BATHROOM LOCKSET	MARBLE SADDLE
205	MASTER W.I.C.	6 PANEL 2'-4" x 6'-8" x 1 ¾"	SINGLE	MDF	PAINT	WOOD	PASSAGE	
206	LINEN CLOSET	2 PANEL (2)1'-0" x 6'-8" x 1 ³ / ₂ "	DOUBLE	MDF	PAINT	WOOD	DUMMY KNOBS BALL CATCHES	

DOOR SCHEDULE NOTES

- 1. OWNER TO PROVIDE ALL DOOR LATCH/LOCK SETS AND HINGES.
- CONTRACTOR TO INSTALL ALL HINGES/LATCH/LOCK SETS. 2. WHERE WEATHER-STRIPPING IS CALLED FOR, PROVIDE ON FOUR (4) SIDES, INCLUDING SADDLE.

	FINISH SCHEDULE												
ROOM				NORTH	NORTH WALL		EAST WALL		SOUTH WALL		WALL		
NUMBER	ROOM NAME	FLOOR FINISH	BASE	MAT.	FIN.	MAT.	FIN.	MAT.	FIN.	MAT.	FIN.	CEILING	REMARKS
	GARAGE	EPOXY FINISH ON CONCRETE SLAB	_	GYP.	PAINT	GYP.	PAINT	GYP.	PAINT	GYP.	PAINT	GYP. BD. PAINTED	ALL GYP. BD. TO BE ∰ FIRECODE TYPE 'X'
	MUDROOM	TILE	WOOD	GYP.	PAINT	GYP.	PAINT	GYP.	PAINT	GYP.	PAINT	GYP. BD. PAINTED	
	EXERCISE ROOM	HARDWOOD FLOORING	WOOD	GYP.	PAINT	GYP.	PAINT	GYP.	PAINT	GYP.	PAINT	GYP. BD. PAINTED	
	FAMILY ROOM	HARDWOOD FLOORING	WOOD	GYP.	PAINT	GYP.	PAINT	GYP.	PAINT	GYP.	PAINT	GYP. BD. PAINTED	
	ENTRY	HARDWOOD FLOORING	TILE	GYP.	PAINT	GYP.	PAINT	GYP.	PAINT	GYP.	PAINT	GYP. BD. PAINTED	
	BATHROOM	TILE	TILE	GYP.	PAINT	GYP.	PAINT	GYP.	PAINT	GYP.	PAINT	GYP. BD. PAINTED	
	KITCHEN	HARDWOOD FLOORING	WOOD	GYP.	PAINT	GYP.	PAINT	GYP.	PAINT	GYP.	PAINT		
	LIVING ROOM	EXISTING HARDWOOD FLOORING - REFINISHED	WOOD	GYP.	PAINT	GYP.	PAINT	GYP.	PAINT	GYP.	PAINT	GYP. BD. PAINTED	
	DINING ROOM	EXISTING HARDWOOD FLOORING - REFINISHED	WOOD	GYP.	PAINT	GYP.	PAINT	GYP.	PAINT	GYP.	PAINT	GYP. BD. PAINTED	
	BEDROOM	HARDWOOD FLOORING	WOOD	GYP.	PAINT	GYP.	PAINT	GYP.	PAINT	GYP.	PAINT	GYP. BD. PAINTED	
	HALL	HARDWOOD FLOORING	WOOD	GYP.	PAINT	GYP.	PAINT	GYP.	PAINT	GYP.	PAINT		
	OFFICE	HARDWOOD FLOORING	WOOD	GYP.	PAINT	GYP.	PAINT	GYP.	PAINT	GYP.	PAINT	GYP. BD. PAINTED	
	MASTER BEDROOM	HARDWOOD FLOORING	WOOD	GYP.	PAINT	GYP.	PAINT	GYP.	PAINT	GYP.	PAINT	GYP. BD. PAINTED	
	MASTER W.I.C.	HARDWOOD FLOORING	WOOD	GYP.	PAINT	GYP.	PAINT	GYP.	PAINT	GYP.	PAINT	GYP. BD. PAINTED	

GYP. PAINT GYP. PAINT GYP. PAINT GYP.

FINISH SCHEDULE NOTES

ROOF

MASTER BATHROOM

- 1. ALL TILE OR STONE FLOORING TO BE SET ON THINSET OVER CEMENT BOARD, TYP. U.O.N.
- 1.1. ALL MARBLE TILE TO BE INSTALLED AS PER THE MARBLE INSTITUTE OF AMERICA, MARBLE TILE INSTALLATIONS REQUIRING A MUD SET TO BE COORDINATED WITH FRAMER TO DROP OR MODIFY FRAMING AS REQUIRED.
- 1.2. ALL NATURAL STONE TILE TO BE INSTALLED AS PER THE NATURAL STONE INSTITUTE OF AMERICA, NATURAL TILE INSTALLATIONS REQUIRING A MUD SET TO BE COORDINATED WITH FRAMER TO DROP OR MODIFY FRAMING AS
- 1.3. ALL CERAMIC & PORCELIN TILE TO BE INSTALLED AS PER THE NATIONAL TILE COUNCIL OF NORTH AMERICA, TILE TO BE
- INSTALLED ON THINSET AND UNCOUPLING AND WATERPROOF MEMBRANE DITRA OR DITRA-XL BY SCHLUTER OR
- 2. ALL TILE, MARBLE SADDLES AND COUNTERTOPS TO BE SUPPLIED BY OWNER AND INSTALLED BY CONTRACTOR. 3. HARDWOOD FLOORING TO BE 2 1/4" OAK HARDWOOD FLOORING TO MATCH EXISTING WITH MINIMAL SHORT PIECES.
- INSTALLED, SANDED PLUS 1 COAT NATURAL STAIN & 3 COATS OIL BASED POLYURETHENE. 4. ALL SURFACES AND FINISHES TO RECEIVE PRIMER IN STRICT ACCORDANCE WITH PAINT MANUFACTURER'S
- RECOMMENDATIONS. RECOAT AS REQUIRED FOR PROPER COVERAGE.

TO SEPTIC 4"

5. * PATCH TO MATCH ALL CEILINGS DAMAGED BY NEW CONSTRUCTION

HDWD. = CLEAR SELECT WHITE OAK HARDWOOD FLOORING GYP. = GYPSUM WALLBOARD

GYP. BD.

CEM. = CEMENT BOARD

PAINTED

PAINT

1 PLUMBING RISER DIAGRAM



Michael Piccirillo Architecture

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No. DATE:

PROJECT NAME: VARGHESE RESIDENCE RENOVATION/ADDITION

PROJECT ADDRESS: 6 FOX RIDGE ROAD ARMONK, NEW YORK 10504

EXISTING TO THE TEXT OF THE TE BATHROOM BATHROOM ¹1-1/2" 1-1/2" 4" VENT THROUGH ROOF ROOF UPPER FLOOR DISH WASHER MID FLOOR **KITCHEN EXISTING** WASHER 1-1/2" LOWER FLOOR! 1 1/2" WSFU 1.4 DFU 2 WATER WATER RENOVATED BATHROOM HEATER

4" VENT THROUGH ROOF

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SCHEDULES

SCALE: AS NOTED	DATE: 01-01-22
DRAWN BY: MAP	
CHK'D BY: MAP	A-600
1 OF 1	7. 300