

Section I- PROJECT

TOWN OF NORTH CASTLE

WESTCHESTER COUNTY 17 Bedford Road Armonk, New York 10504-1898

RESIDENTIAL PROJECT **REVIEW COMMITTEE** Adam R. Kaufman AICP, Chair Telephone: (914) 273-3000 x 43 Fax: (914) 273-3554 www.nortcastleny.com

RESIDENTIAL PROJECT REVIEW COMMITTEE (RPRC) APPLICATION

ADDRESS: 25 Orchard Dr. Armonk, N.Y.
Section III- DESCRIPTION OF WORK:
Proposal new single family residence
Section III- CONTACT INFORMATION:
APPLICANT: Santucci Construction Corp. ADDRESS: 15 Travis LA., Montrose, N.Y. 10548
PHONE: 914-736-0343 MOBILE: 914-444-1054 EMAIL: deanturei @santurei construction con
PROPERTY OWNER: Damian Development, LLC
ADDRESS: 15 LYCLUS COMP, 11/007 1059, 14. 7. 70578
ADDRESS: 15 Travis lane, Montrose, N. Y. 10548 PHONE: 914-136-0393 MOBILE: 914-447-1057 EMAIL SAMURE CONSTRUCTION COM PROFESSIONAL:: Ralph Mastromonaeo, PEPC
ADDRESS: 13 Dive Ct. (Loten-on-Houson 14.9. 10 sol
PHONE: 914-271-4762 MOBILE: 914-629-1152
EMAIL: hardy wass wast.com
Section IV- PROPERTY INFORMATION:
Zone: $R-10$ Tax ID (lot designation) $108.1-6.78$



Town of North Castle Residential Project Review Committee

17 Bedford Road Armonk, New York 10504 (914) 273-3542 (914) 273-3554 (fax)

RPRC COMPLETENESS REVIEW FORM


This form represents the standard requirements for a completeness review for all Residential Project Review Committee submissions. Failure to provide all of the information requested will result in a determination that the application is incomplete.

Project Name on Plan:
Initial Submittal Revised Preliminary
Street Location: 25 Orchard Dr. Armonk
Zoning District: R-10 Property Acreage: 15, 174 Sept ax Map Parcel ID: 108-1-6-78
Date: 3-1-2012
DEPARTMENTAL USE ONLY
Date Filed: Staff Name:
Preliminary Plan Completeness Review Checklist Items marked with a are complete, items left blank are incomplete and must be completed, "NA" means not applicable.
1. Plan prepared by a registered architect or professional engineer
2. Aerial photo (Google Earth) showing the applicant's entire property and adjacent properties and streets
3. Map showing the applicant's entire property and adjacent properties and streets
. A locator map at a convenient scale
5. The proposed location, use and design of all buildings and structures
3. Existing topography and proposed grade elevations
Location of all existing and proposed site improvements, including drains, culverts, retaining walls and fences

RPRC COMPLETENESS REVIEW FORM

Page 2

€.	Description of method of water supply and sewage disposal and location of such facilities
10	. The name and address of the applicant, property owner(s) if other than the applicant and of the planner, engineer, architect, surveyor and/or other professionals engaged to work
1	. Submission of a Zoning Conformance Table depicting the plan's compliance with the minimum requirements of the Zoning District
2	2. If a tree removal permit is being sought, submission of a plan depicting the location and graphical removal status of all Town-regulated trees within the proposed area of disturbance. In addition, the tree plan shall be accompanied by a tree inventory includes a unique ID number, the species, size, health condition and removal status of each tree.
]3	 If a wetlands permit is being sought, identification of the wetland and the 100-foot wetland buffer.
Dlan	e information about the items required herein can be obtained from the North Castle ning Department. A copy of the Town Code can be obtained from Town Clerk or on the h Castle homepage: http://www.northcastleny.com/townhall.html
	On this date, all items necessary for a technical review of the proposed site plan have been submitted and constitute a COMPLETE APPLICATION.

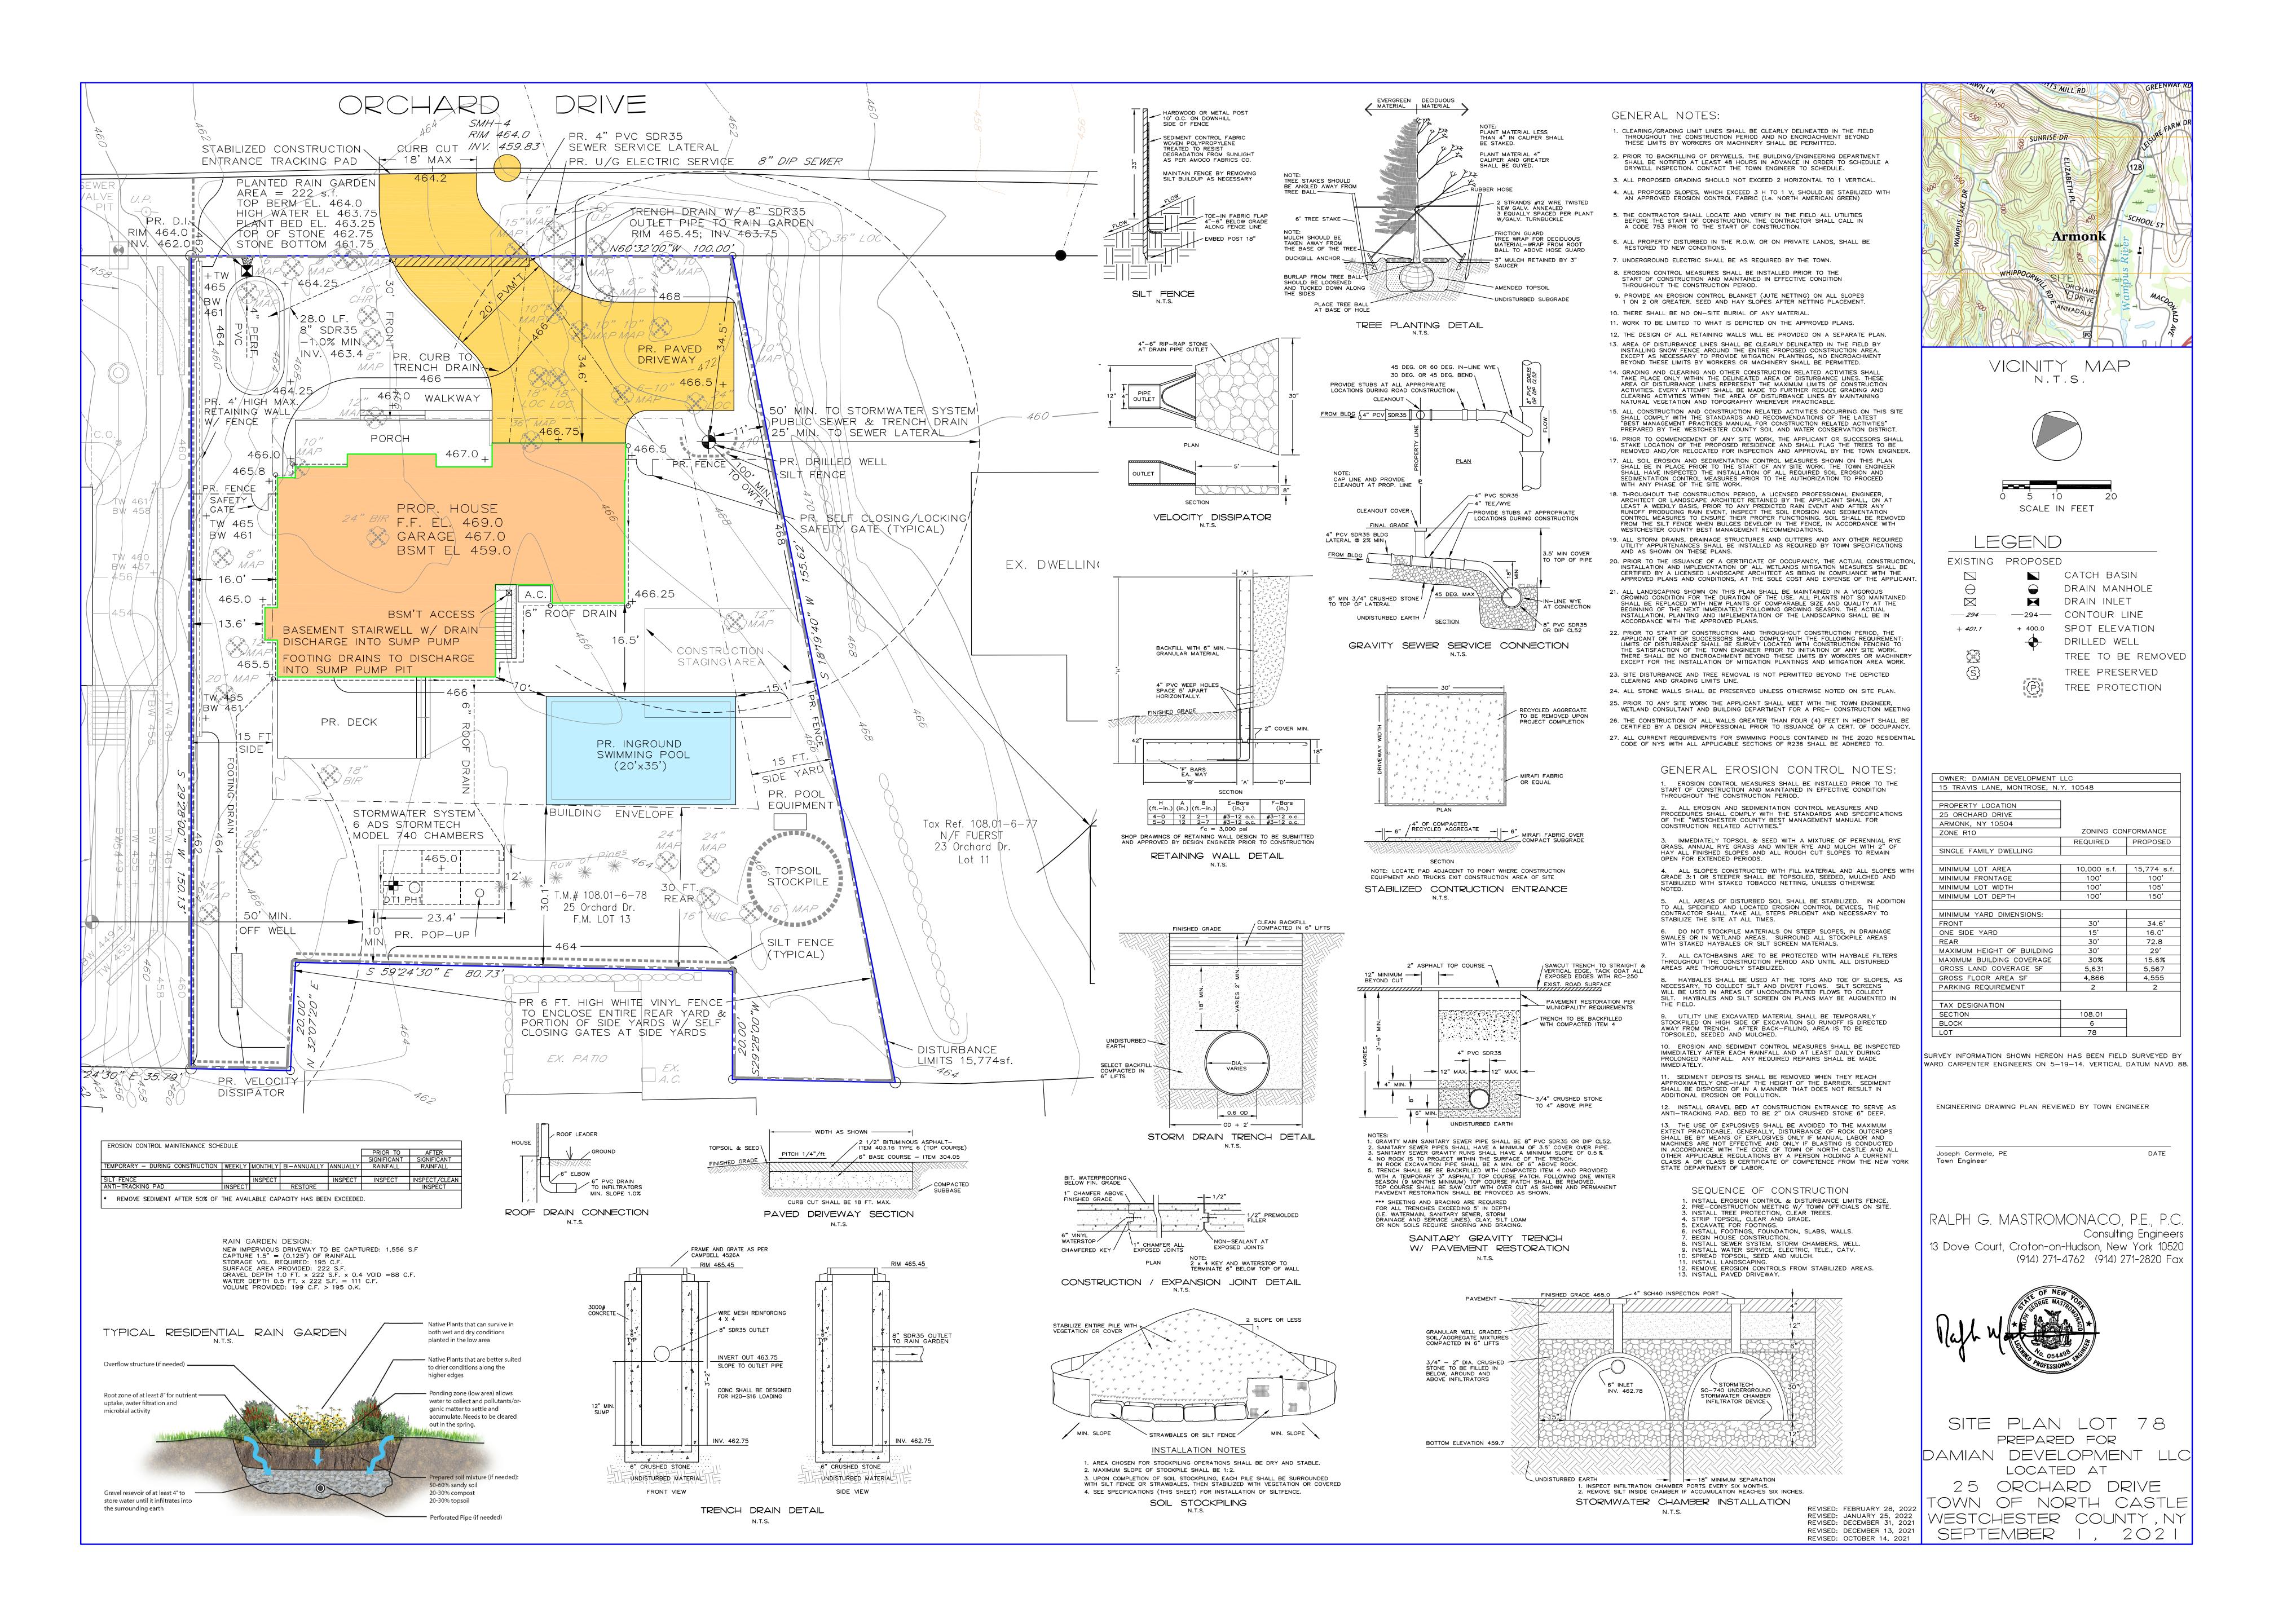

25 ORCHARD DRIVE ARMONK, NY NEW CONSTRUCTION SINGLE FAMILY RESIDENCE

PRESCRIPTIVE HVAC REQUIREMENTS REFER TO ENERGY CODE COMPLIANCE NOTES FOR OTHER REQUIREMENTS

- The HVAC system shall be deisgned by the HVAC sub contractor to heat the entire house to a minimum inside temperature of 72°F when the outside temperature is -5°F and with a 15mph wind. The cooling system shall cool all conditioned spaces to an inside temperature of 72°F when the outside temperature is 90°F.
- The G.C. shall be responsible for the adequacy of the system design and its ability to meet the performance specifications herein. All tonnages to be determined. All materials to be best quality new materials as specified. No substitutions will be permitted except with Architect's written approval.
- HEATING AND COOLING EQUIPMENT SHALL BE SIZED IN ACCORDANCE WITH ACCA MANUAL S BASED ON BUILDING LOADS CALCULATED IN ACCORDANCE WITH ACCA MANUAL .I
- EQUIPMENT LOAD CALCULATIONS SHALL TAKE INTO ACCOUNT ENVELOPE BUILDING TIGHTNESS OF 2-ACH50

MECHANICAL AND WATER HEATING

- Air handler leakge shall be designed by manufacturer at <=2%
- Provide programable thermostate installed for control of heating and cooling systems and initially set by manufacturer to code specifications.
- Heat pump thermostates shall be installed on all heat pumps.
- Circulating service hot water systems shall have automatic or accessible manual controls.
 All mechanical ventilation system fans not part of tested and
- All mechanical ventilation system fans not part of tested and listed HVAC equipment shall meet efficiency and airflow limits.


 Hot water hollers supplying heat through one or two pipe.
- Hot water boilers supplying heat through one-or-two-pipe systems shall have outdoor setback control to lower boiler water temp. based on outdoor temp.

 | Control water simulation system shall have a simulation number.
- Heated water circulation system shall have a circulation pump. The system return pipe shall shall be a dedicated return pipe or a cold water supply pipe. Gravity or thermos-syphon systems shall not be used. Controls for circulating hot water system pumps shall start the pump with signal for hot water demand within the occupancy. Controls shall automatically turn of the pump when water is in circulation loop is set at set-point temp. and no demand for hot water exists.

DUCTS

DUCTS SHALL BE PRESSURE TESTED TO DETERMINE AIR LEAKAGE WITH EITHER:

LEAKAGE WITH EITHER:
ROUGH IN TEST: TOTAL LEAKAGE TESTED WITH A
PRESSURE DIFFERENTIAL OF 0.1 INCH W.G. ACROSS THE
SYSTEM INCLUDING THE MANUFACTURER'S AIR HANDLER
ENCLOSURE IF INSTALLED AT THE TIME OF TEST.
POSTCONSTRUCTION TEST: TOTAL LEAKGE MEASURED
WITH A PRESSURE DIFFERENTIAL OF 0.1 INCH W.G. ACROSS
THE SYSTEM INCLUDING THE MANUFACTURER'S AIR
HANDLER ENCLOSURE

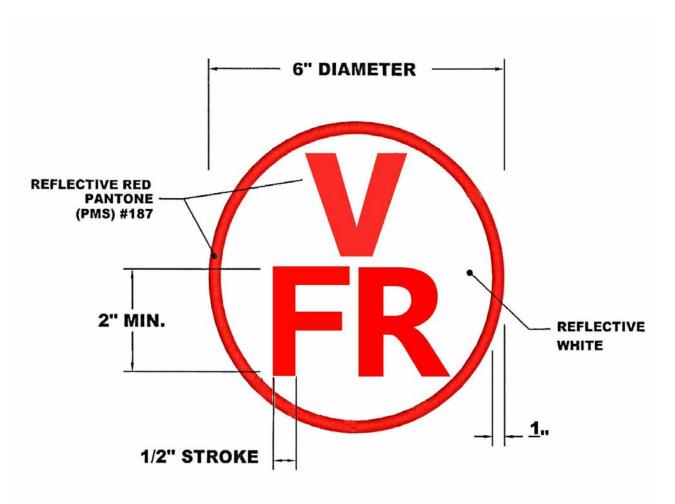

MINIMUM UNIFORMLY DISTRIBUTED LIVE LOADS	
USE	LIVE LOAD (PSF)
EXTERIOR BALCONIES	60
DECKS	40
PASSENGER VEHICLE GARAGES	50
ATTICS WITHOUT STORAGE	10
ATTICS WITH STORAGE	20
ROOMS OTHER THAN SLEEPING ROOMS LIVE LOAD	40
SLEEPING ROOMS LIVE LOADS	30
FLOOR DEAD LOADS	15
STAIRS	40
GUARDRAILS AND HANDRAILS	200
GUARD INFILL COMPONENTS	50
GROUND SNOW LOAD / ROOF LIVE LOAD	45

APPLICABLE CODES:

2020 RESIDENTIAL CODE OF NYS

ENERGY CODE COMPLIANCE:

2020 ECCC NYS, CHAPTER 4: RESIDENTIAL ENERGY EFFICIENCY
- CLIMATE ZONE 4
PRESCRIPTIVE REQUIREMENTS:
FENESTRATION U-FACTOR- 0.35
FENESTRATION SHGC- 0.40

FENESTRATION U-FACTOR- (FENESTRATION SHGC- 0.40 SKYLIGHT U-FACTOR- 0.55 CEILING R-VALUE- 49 WALL R-VALUE- 20 FLOOR R-VALUE- 19

ENERGY CODE NOTES:

- CONSTRUCTION DRAWINGS AND AND DOCUMENTATION DEMONSTRATE ENERGY CODE COMPLIANCE FOR LIGHTING AND MECHANICAL SYSTEMS, AND THE BUILDING ENVELOPE. THERMAL ENVELOPE REPRESENTED ON
- CONSTRUCTION DOCUMENTS

 THE BUILDING THERMAL ENVELOPE SHALL BE DURABLY SEALED TO LIMIT
- INFILTRATION.
 A. ALL JOINTS, SEAMS , AND PENETRATIONS

JOINTS AROUND DOORS/WINDOWS AND THEIR FRAMING

- C. UTILITY PENETRATIONS

 D. WALLS AND CEILINGS SEPARATING CONDITIONED FROM NON
 CONDITIONED SPACE
- CONDITIONED SPACE
 E. ATTIC ACCESS OPENINGS
- F. RIM JOIST JUNCTION, SILL P[LATES AND HEADERS
 3. BUILDING ENVELOPE AIR TIGHTNESS SHALL BE TESTED IN ACCORDANCE
 WITH ASHREA/ASTM E779. AIR LEAKAGE SHALL NOT EXCEED (3) AIR CHANGES
- 4. AIR BARRIER AND THERMAL BARRIEIR SHALL BE INSTALLED PER
- MANUFACTURER'S INSTRUCTIONS.

 PROVIDE A MINIMUM OF ONE THERMOSTAT FOR EACH HEATING AND COOLING SYSTEM CAPABLE OF AUTOMATICALLY ADJUSTING SPACE TEMPERATURE
- PER IECC 2015, R403.1.1.

 A. REFER TO HVAC SPECIFICATIONS FOR OTHER REQUIREMENTS
 IC-RATED RECESSED LIGHTING FIXTURES SHALL BE SEALED AT
- HOUSING/INERIOR FINISH AND LABELED TO INDICATE<2.0 CFM LEAKAGE @ 75 Pa.
- 7. AUTOMATIC OR GRAVITY DAMPERS SHALL BE INSTALLED ON ALL OUTDOOR AIR INTAKES AND EXHAUSTS.
- WOOD BURNING FIREPLACES SHALL HAVE TIGHT FITTING FLUE DAMPERS AND OUTDOOR AIR FOR COMBUSTION.
 U-FACTOR OF FENESTRATION PRODUCTS SHALL BE DETERMINED IN
- ACCORDANCE WITH NFRC 100.

 10. A PROTECTIVE COVERING SHALL BE INSTALLED TO PROTECT EXPOSED
- EXTERIOR INSULATION AND EXTENDS A MINIMUM OF 6" BELOW GRADE.

 11. ALL INSULATION SHALL BE LABELED OR THE INSTALLED R-VALUE SHALL BE
- 12. FLOOR INSULATION SHALL BE INSTALLED PER MANUFACTURER'S INSTRUCTIONS AND IN SUBSTANTIAL CONTACT WITH THE UNDERSIDE OF THE SUBFLOOR, OR FLOOR FRAMING CAVITY INSULATION SHALL BE IN CONTACT WITH THE TOP SIDE OF SHEATHING, OR CONTINUOUS INSULATION SHALL BE INSTALLED ON THE UNDERSIDE OF THE FLOOR FRAMING AND EXTEND FROM THE BOTTOM TO THE TOP OF ALL PERIMETER FLOOR FRAMING MEMBERS.
- THE BOTTOM TO THE TOP OF ALL PERIMETER FLOOR FRAMING MEMBERS.

 13. WALL INSULATION SHALL BE INSTALLED PER MANUFACTURERS

 SPECIFICATIONS
- 14. CEILING INSULATION SHALL BE INSTALLED PER MANUFACTURER'S SPECIFICATIONS. SPRAY POLYURETHANE FOAM THICKNESS AND INSTALLED R-VALUE SHALL BE LISTED ON CERTIFICATION PROVIDED BY THE INSULATION INSTALLER.
- 15. ATTIC ACCESS HATCH AND DOOR INSULATION R-VALUS SHALL BE OF THE ADJACENT ASSEMBLY.
- BUILDING CAVITIES SHALL NOT BE USED AS DUCTS OR PLENUMS.
 ALL DUCTS SHALL BE SEALED AND COMPLY WITH M1601 OF IRC 2015
 DUCT TIGHTNESS TEST RESULT 0F<=4CFM/100 FT2 ACROSS THE SYSTEM OR
- <=3CFM/100 FT2 WITHOUT AIR HANDLER @ 25 PA. FOR ROUGH IN TEST, VERIFICATION MAY NEED TO OCCUR DURING FARMING INSPECTION.
 19. DUCTS SHALL BE PRESSURE TESTED PER 403.2.2 1ECC 2015.
- 20. AIR HANDLER LEAKAGE DESIGNED BY MANUFACTURER AT<=2% OF DEISGN AIR FLOW.
 21. DUCTS IN ATTIC SHALL BE INSULATED TO MIN. R-8. ALL OTHER DUCTS SHALL
- 21. DUCTS IN ATTIC SHALL BE INSULATED TO MIN. R-8. ALL OTHER DUCTS SHALL BE INSULATED TO MIN. R-6 (EXCEPT DUCTS LOCATED COMPLETELY WITHIN THE BUILDING THERMAL ENVELOPE)
- 22. ALL MECHANICAL VENTILATION SYSTEMS FANS NOT PART OT TESTED AND LISTED HVAC EQUIPMENT SHALL MEET EFFICACY AND AIR FLOW LIMITS.
 23. HVAC PIPING CONVEYING FLUIDS ABOVE 105 D OR CHILLED FLUIDS BELOW 55D ARE INSULATED TO >= R-3
- 24. HEATING AND COOLING EQUIPMENT SHALL BE SIZED PER ACCA MANUAL S
 BASED ON LOADS CALCULATED PER ACCA MANUAL J OR OTHER METHODS
 APPROVED BY CODE OFFICIAL.
- A. GC SHALL PROVIDE SYSTEM SPECIFICATIONS SHOWING COMPLIANCE WITH ABOVE.
- HOT WATER PIPES SHALL BE INSULTED TO MIN. R-3.

 A MINIMUM OF 75% OF LAMPS IN LIGHTING FIXTURES SHALL BE HIGH-

R-VALUE CERTIFICATE

A PERMANENT CERTIFICATE SHALL BE POSTED ON A WALL IN THE MECHANICAL ROOM, AND SHALL LIST THE PREDOMINANT R-VALUES OF INSULATION INSTALLED IN OR ON THE CEILING/ ROOF, WALLS, FOUNDATION, AND DUCTS OUTSIDE CONDITIONED SPACES; U-FACTORS FOR FENESTRATION AND SOLAR HEAT GAIN COEFFECIENT OF FENESTRATION, AND THE RESULTS FOR ANY REQUIRED DUCT SYSTEM AND BUILDING ENVELOP AIR LEAKAGE TESTING DONE ON THE BUILDING. THE CERTIFICATE SHALL LIST THE TYPES AND EFFICIENCES OF HEATING, COOLING AND SERVICE WATER HEATING EQUIPMENT

ENERGY CODE NOTE:

GROUND

SNOW

LOAD

45 PSF

I CERTIFY THAT I AM A LICENSED PROFESSIONAL. I
ALSO CERTIFY THAT TO THE BEST OF MY
PROFESSIONAL KNOWLEDGE THE BUILDING PLANS
SHOWN HEREIN ARE IN COMPLIANCE WITH THE2015
IECC RESIDENTIAL PROVISIONS AS AMENDED BY THE
2017 SUPPLEMENT TO THE NYSECCC
SIGNED: DATE:

GENERAL NOTES

- 1. ALL WORK SHALL CONFORM TO IRC 2015, 2017 NYS SUPPLEMENT, AND LOCAL CODES. ALL ELECTRICAL, PLUMBING, AND MECHANICAL WORK SHALL CONFORM TO ALL NATIONAL, STATE, AND LOCAL CODES.
- 2. MATERIALS, WORKMANSHIP AND INSTALLATION SHALL BE IN STRICT COMPLIANCE WITH NOT ONLY MANUFACTURERS' PRINTED INSTRUCTIONS, BUT ALSO THE STANDARDS OF RECOGNIZED AGENCIES OR ASSOCIATIONS.
- 3. ALL MATERIALS SHALL BE NEW. UNLESS OTHERWISE SPECIFIED.
- 4. PROVIDE TEMPORARY PROTECTION OF MATERIALS AND EQUIPMENT.

5. IT IS INTENDED THAT THE CONTRACTOR PROVIDE A COMPLETE JOB. ANY OMISSIONS IN THESE GENERAL INSTRUCTIONS OR THE OUTLINE OF WORK ARE NOT TO BE CONSTRUED AS REMOVING SUCH ITEMS FROM THE RESPONSIBILITIES OF THE CONTRACTOR.

6. ALL WORK SHALL BE PERFORMED BY SKILLED AND QUALIFIED WORKMEN IN THE APPROPRIATE TRADES. CONTRACTOR SHALL KEEP SUFFICIENT WORKMEN ON THE JOB AT ALL TIMES TO PERFORM THE WORK IN THE MOST EXPEDITIOUS MANNER CONSISTENT WITH GOOD WORKMANSHIP, SOUND BUSINESS PRACTICE AND IN THE BEST INTERESTS OF THE

7. CONTRACTOR AGREES THAT HE IS SKILLED AND EXPERIENCED IN THE USE AND INTERPRETATION OF PLANS AND SPECIFICATIONS. HE HAS CAREFULLY REVIEWED THE PLANS AND SPECIFICATIONS FOR HIS PROJECT AND HAS FOUND THEM TO BE FREE OF AMBIGUITIES. FURTHER, HE HAS CAREFULLY EXAMINED THE SITE OF THE WORK AND FROM HIS OWN OBSERVATIONS HAS SATISFIED HIMSELF AS TO THE NATURE AND LOCATION OF THE WORK; THE CHARACTER, QUALITY, AND QUANTITY OF MATERIALS; THE DIFFICULTIES LIKELY TO BE ENCOUNTERED AND OTHER ITEMS FOUND ON THE JOB.

8. THE CONTRACTORS' EXPERIENCE, EXPERTISE AND PROFESSIONAL JUDGMENT SHALL NOT BE DISREGARDED DURING THE CONSTRUCTION PROCESS. THE CONTRACTORS' INPUT, COMMENTS AND RECOMMENDATIONS WILL BE WELCOMED AND EXPECTED BY THE OWNER AND THE ARCHITECT. CONSTRUCTION ALTERNATIVES WILL BE CONSIDERED AND EMBRACED IF THEY HAVE MERIT AND A BETTER RESULT CAN BE ACHIEVED. SUCH CHANGES MAY NOT TAKE PLACE WITHOUT THE EXPRESS APPROVAL OF THE ARCHITECT.

FIRE PROTECTION NOTES

1. SMOKE DETECTORS SHALL BE INSTALLED IN ALL EXISTING BEDROOMS,
ADJACENT HALL, AND ONE ON EACH STORY OF DWELLING PER APPLICABLE CODES (LISTED TOP OF SHEET)
ALL SMOKE DETECTORS SHALL BE LISTED AND INSTALLED IN ACCORDANCE WITH
THE PROVISIONS OF THE RCNYS AND THE HOUSEHOLD FIRE WARNING EQUIPMENT
PROVISIONS OF NEPA 72.

PROVISIONS OF NFPA 72.
ALL SMOKE DETECTORS SHALL BE INTERCONNECTED IN SUCH A MANNER THAT THE ACTUATION OF ONE ALARM WILL ACTIVATE ALL OF THE ALARMS IN THE

INDIVIDUAL UNIT. THE ALARM SHALL BE CLEARLY SHALL BE CLEARLY AUDIBLE IN
ALL BEDROOMS OVER BACKGROUND NOISE LEVELS WITHAL LL INTERVENING
DOORS CLOSED. ALL SMOKE DETECTORS SHALL BE INSTALLED PER APPLICABLE CODES (LISTED TOP OF SHEET)
REFER TO SHEET A004- DIVISION 10

2.PROVIDE FIREBLOCKING PER APPLICABLE CODES (LISTED TOP OF SHEET) PROVIDE FIRE BLOCKING IN WALL CAVITIES OR FURRED SPACES THAT EXCEED 8 FT IN HEIGHT, AROUND ALL PIPING, VENTS AND WIRING HOLES, ETC.

PRESCRIPTIVE VENTILATION REQUIREMENTS

WHOLE HOUSE MECHANICAL VENTILATION SYSTEM SHALL CONSIST OF SUPPLY OR EXHAUST FANS, OR COMBINATION OF BOTH, AND ASSOCIATED DUCTS AND CONTROLS, AND SHALL BE PROVIDED WITH CONTROLS THAT ENABLE MANUAL OVERRIDE.

WHOLE HOUSE MECHANICAL VENTILATION SYSTEM SHALL PROVIDE OUTDOOR AIR AT A

75 CFM (CONTINUOUS) OR INTERMITTENT PER TABLE M1505.4.3 (2)
KITCHEN: 100 CFM INTERMITTENT OR 25 CFM CONTINUOUS
BATHROOMS: MECHANICAL EXHAUST 50 CFM INTERMITTENT OR 20 CFM CONTINUOUS

PRESCRIPTIVE LIGHT REQUIREMENTS

PROVIDE ARTIFICIAL LIGHT CAPABLE OF PRODUCING AN AVERAGE ILLUMINATION OF 6 FOOTCANDLES OVER THE AREA OF THE ROOM AT A HEIGHT OF 30" ABOVE THE FLOOR LEVEL

RECEPTACLE LOCATIONS

1. ALL ROOMS (EXCEPT NON WALK IN CLOSETS).

2. INSTALLED SO THAT NO POINT MEASURED HORIZONTALLY ALONG THE FLOOR IS LINE IN ANY WALL SPACE I IS MORE THAN 6' FROM A RECEPTACLE.

3. AT COUNTERTOPS, INSTALLED SO THAT NO POINT ALONG THE WALL THE WALL LINE IS MORE THAN 24", MEASURED HORIZONTALLY FROM A RECEPTACLE.

4. PROVIDE 4 RECEPTACLES AT KITCHEN ISLAND
5. IN BATHROOM PROVIDE GFCI RECEPTACLE AT VANITIES. 2 OUTLETS AT (2) SINKS, ONE RECEPTACLE AT SINGLE SINK.

6. APPLIANCE RECEPTACLE SHALL BE WITHIN 6' OF APPLIANCE.7. PROVIDE ONE EXTERIOR GFCI RECEPTACLE AT FRONT, BACK, ANS SIDES OF HOUSE OF HOUSE.4 TOTAL EXTERIOR OUTLETS

8. PROVIDE MIN. 1 RECEPTACLE IN HALLSWAY 10' OR MORE.

9. PROVIDE RECEPTACLE FOR APPLIANCES IN LAUNDRY ROOM.

10. PROVIDE MIN. 1 GFCI RECEPTACLE IN GARAGE. REFER TO ELECTRICAL PLAN FOR OTHER OUTLETS IN GARAGE.

11. PROVIDE MIN. 1 WALL SWITCHED LIGHTING OUTLET IN EACH HABITABLE ROO

11. PROVIDE MIN. 1 WALL SWITCHED LIGHTING OUTLET IN EACH HABITABLE ROOM AND BATHROOM, HALLWAY, STAIRWAY, GARAGE, STORAGE, AND UTILITY SPACES. ALL SWITCHED SHALL BE PROVIDED BY OWNER

CLIMATIC AND GEOGRAPHIC DESIGN CRITERIA TABLE R301.2(1)								
WIND	SEISMIC DESIGN	SUBJECT TO DAMAGE FROM				WINTER DESIGN	ICE SHIELD UNDERLAYMEN	FLOOD HAZARDS
EED (MPH)	CATEGOR Y	WEATHERING	FROST DEPTH LINE	TERMITE	DECAY	TEMPERATUR E	T REQUIREMENT	HAZARDS
115 MPH	С	SEVERE	42"	MODERATE HEAVY	SLIGHT MODERATE	7° F	YES	

INSULATION AND FENESTRATION REQUIREMENTS								
CLIMATE ZONE	FENESTRATIO N U-FACTOR	SKYLIGHT U- FACTOR	CEILING R- VALUE	WOOD FRAME WALL R-VALUE	MASS WALL R-VALUE	FLOOR R- VALUE	BASEMENT WALL R-VALUE	SLAB R-VALUE AND DEPTH
4	0.35	0.55	49	20	5/10 ^g	19	10/13 ^C	10, 2 FT ^d

THIS PROJECT MEETS THE PRESCRIPTIVE METHOD FOR ENERGY CODE COMPLIANCE: CLIMATE ZONE 4



DO NOT SCALE DRAWINGS. REFER TO WRITTEN
MEASUREMENTS FOR ACCURANCY, OR CONTACT ARCHITECT
CONTACT ARCHITECT IF THERE ARE ANY DISCECPENCIES.
UNAUTHORIZED ALTERATIONS OR ADDITIONS TO THIS
DRAWING IS A VIOLATION OF NEW YORK STATE EDUCATION

© Copyright 2020 MICHAEL PICCIRILLO ARCHITECTURE

	DRAWING LIST
Sheet Number	Sheet Name
A001	TITLE SHEET
A002	SITE PLAN ZONING
A100	FOUNDATION/ BASEMENT PLAN
A101	FIRST FLOOR PLAN
A102	SECOND FLOOR PLAN
A103	ATTIC FLOOR PLAN
A104	ROOF PLAN
A200	ELEVATIONS
A300	BUILDING SECTIONS
A301	BUILDING SECTIONS
A350	WALL SECTIONS
A400	DETAIL/ SCHEDULES
E101	BASEMENT ELECTRICAL PLAN
E102	1ST FLOOR ELECTRICAL PLAN
E103	SECOND FLOOR ELECTRICAL PLAN
E104	ATTIC ELECTRICAL PLAN
S100	1ST FLOOR FRAMING
S101	2ND FLOOR FRAMING
S102	ATTIC FLOOR FRAMING
S103	ATTIC CEILING FRAMING
S104	ROOF FRAMING
S105	FRAMING NOTES DETAILS
S105.1	DECK DETAILS
S106	STRUCTURAL DETAILS
x201	PERSPECTIVES

 No.
 DATE:
 ISSUE:

 1
 2/28/22
 ISSUED

PROJECT NAME: SINGLE FAMILY HOUSE

PROJECT ADDRESS: 25 ORCHARD DRIVE ARMONK, NY



MICHAEL A PICCIRILLO, AIA

345 KEAR STREET YORKTOWN HEIGHTS, NEW YORK


TELEPHONE: 914-368-9838 FACSIMILE: 914-368-9839 michael@mpiccirilloarchitect.com

www.mpiccirilloarchitect.com

TITLE SHEET

Scale	Date
	Issue Date
Drawn by	
Author	
Checked by	$\Lambda \cap \Lambda$
Checker	A001
Project number	

/28/2022 1:22:44 PM

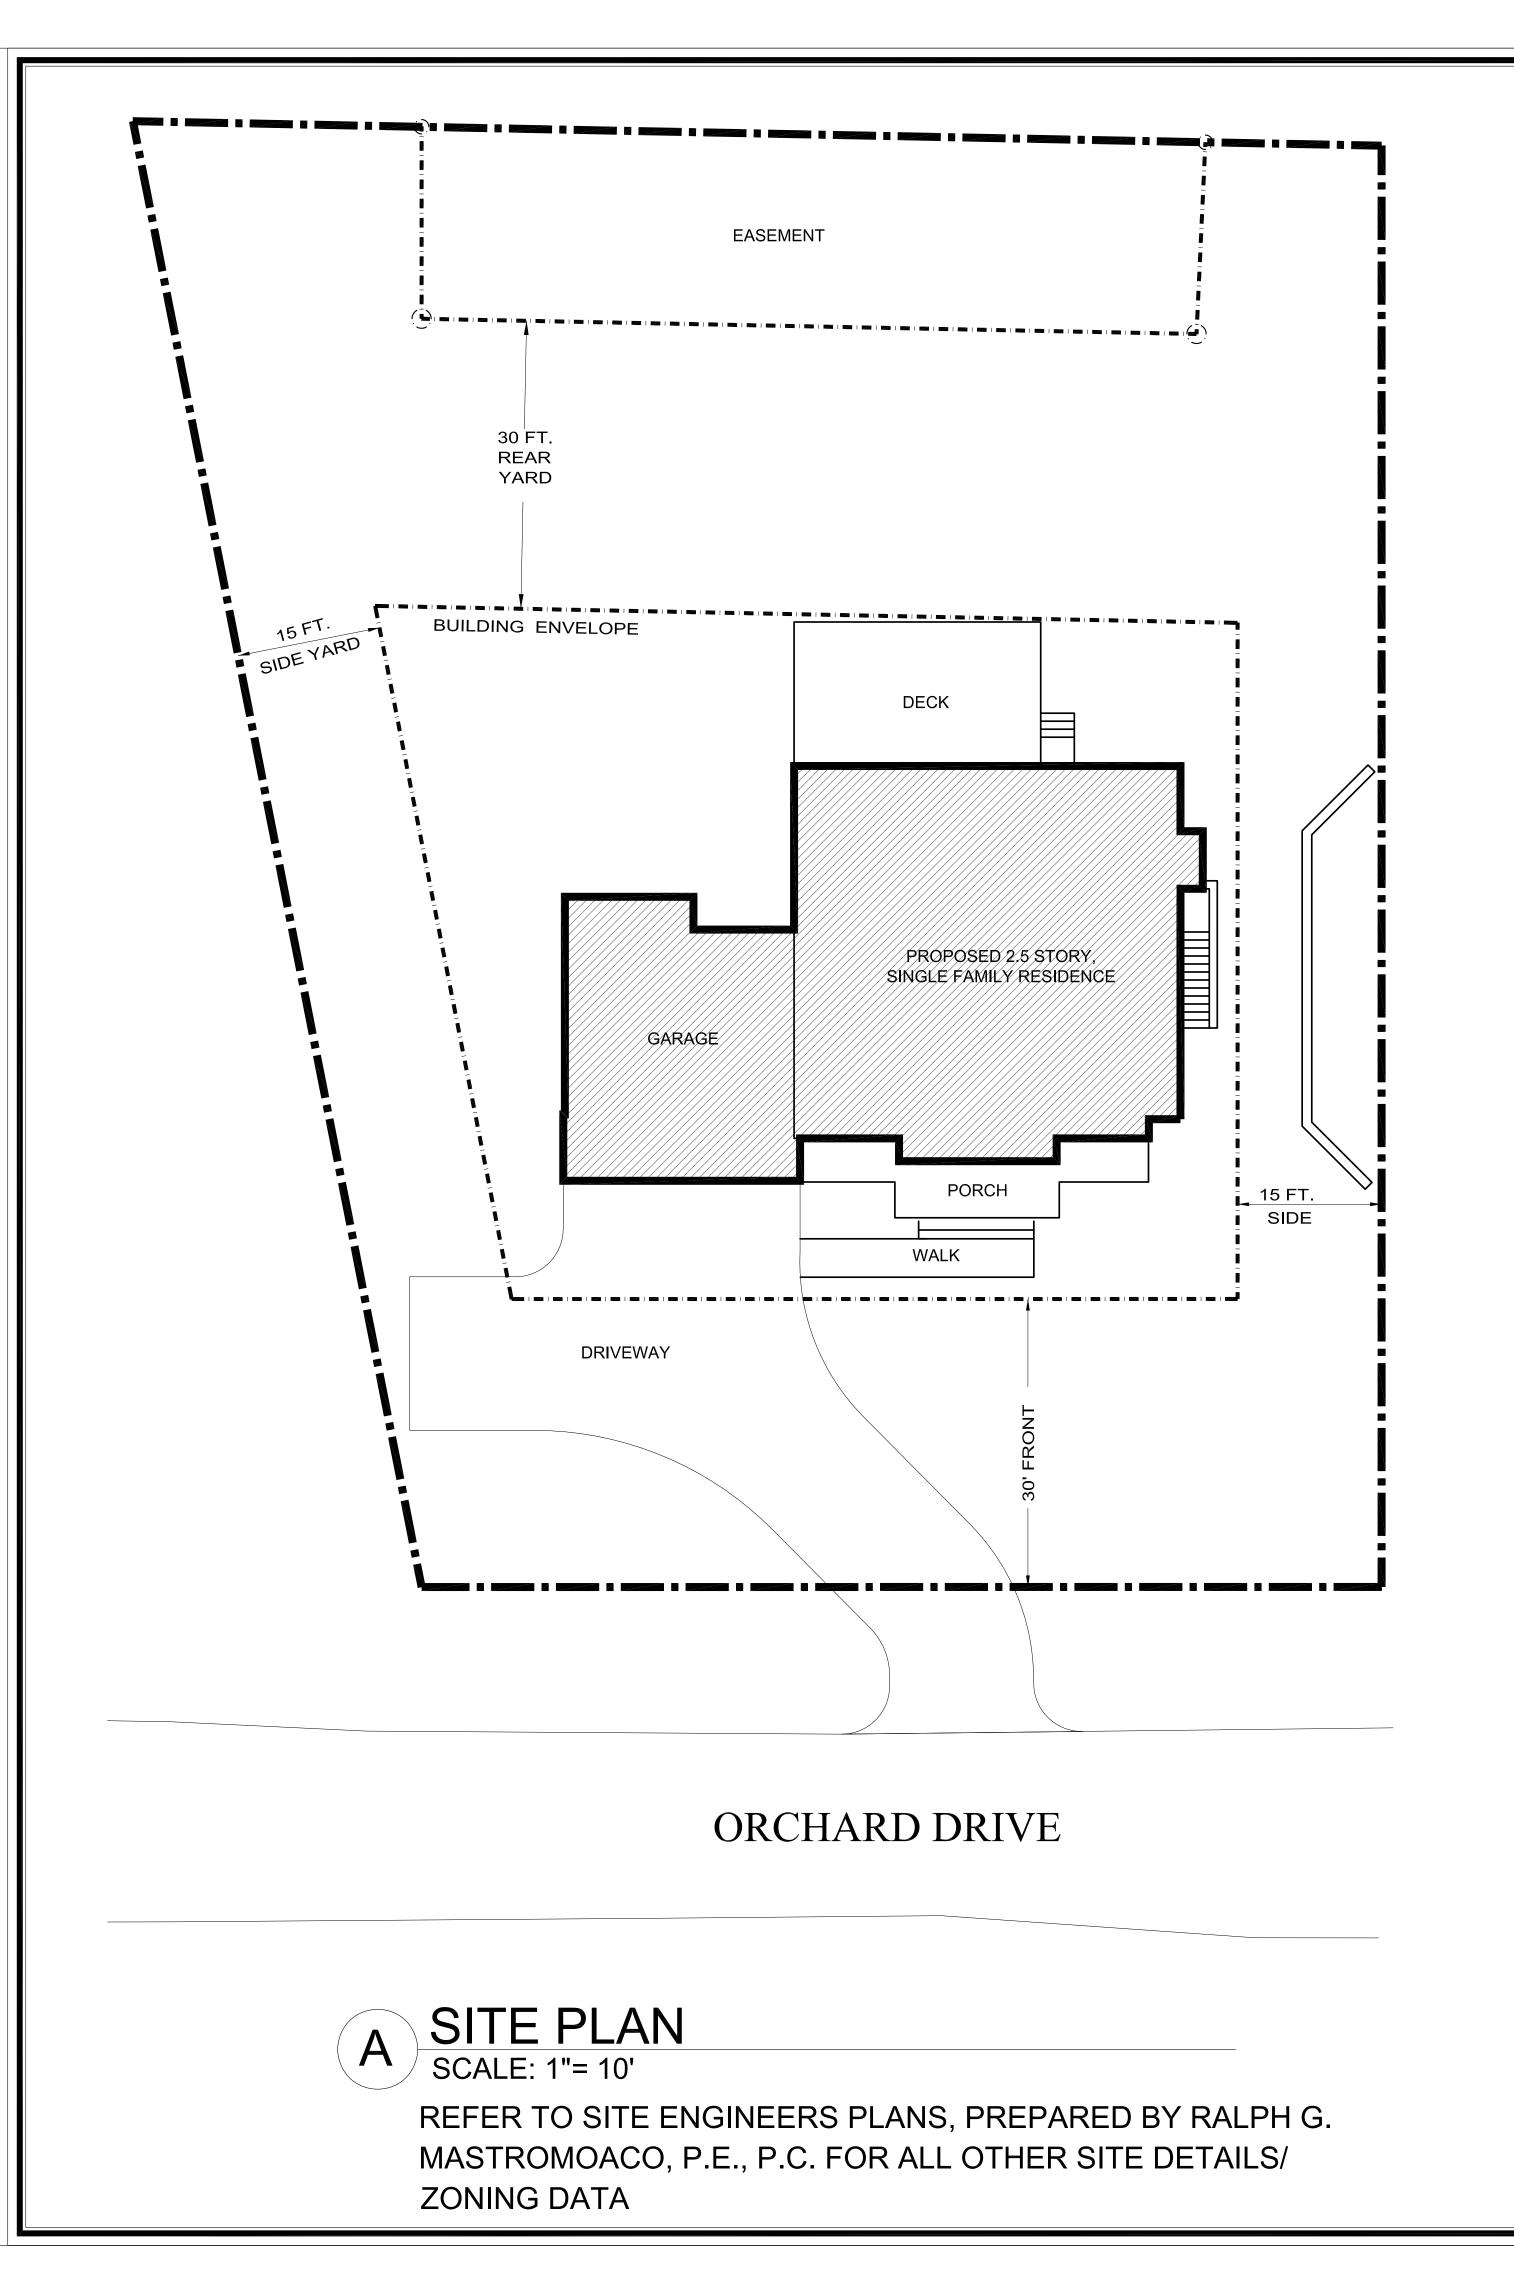

A1 2.33 X 6 = 14

A1 2.33 X 6 = 14

A2 1.474

A2 1.474

A3 1.69.5

B1 384

B2 273

C1 62

IST FLOOR TOTAL= 2.458.5

A3 36.625 X 40.25 = 1,474

B1 13.4 X 29.42 = 394


B2 10.5 X 26 = 273

A3 2 X 36.79 = 75

A4 37 X 4.5 = 166.5

A4 37 X 4.5 = 166.5

1 1ST FLOOR AREA SCALE: 1/8"=1'-0"

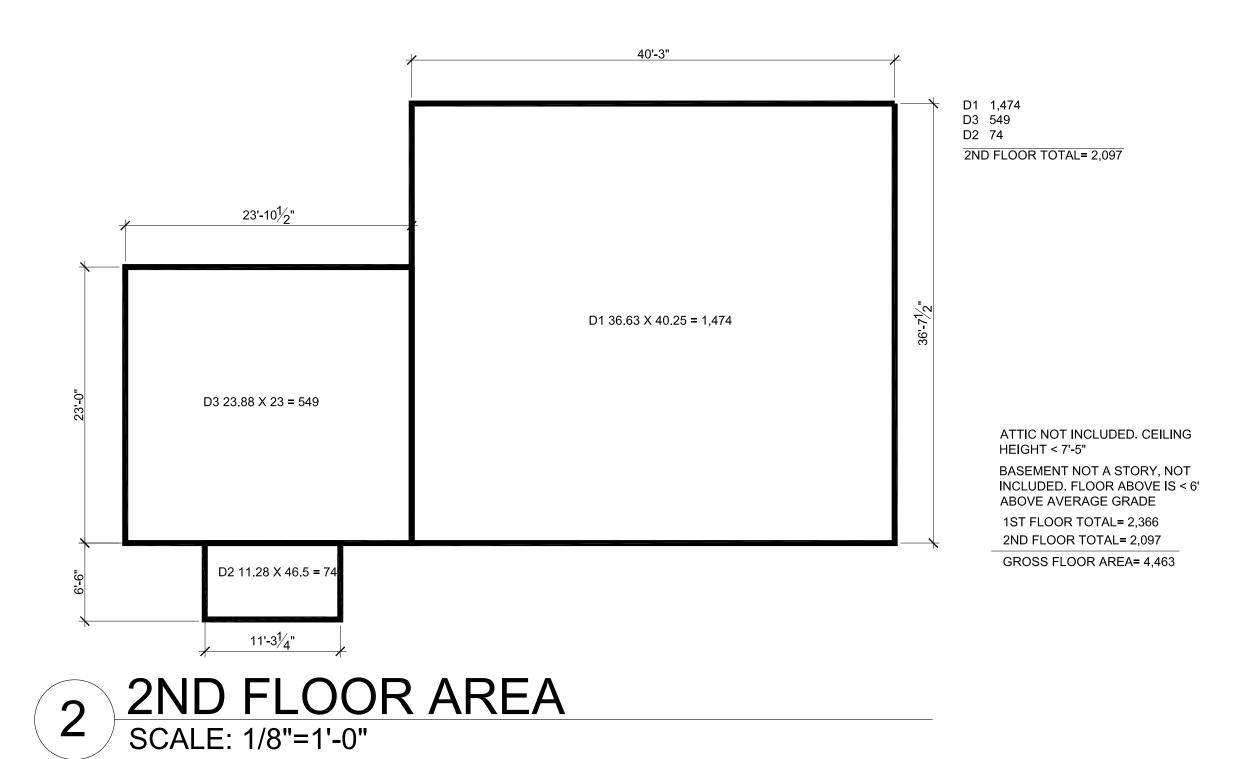

Michael Piccirillo Architecture

DO NOT SCALE DRAWINGS. REFER TO WRITTEN
MEASUREMENTS FOR ACCURANCY, OR CONTACT ARCHITECT.
CONTACT ARCHITECT IF THERE ARE ANY DISCECPENCIES.
UNAUTHORIZED ALTERATIONS OR ADDITIONS TO THIS
DRAWING IS A VIOLATION OF NEW YORK STATE EDUCATION

© Copyright 2018 MICHAEL PICCIRILLO ARCHITECTURE

No. DATE: ISSUE:

1 2/28/22 ISSUED

PROJECT NAME:

SINGLE FAMILY HOUSE

PROJECT ADDRESS:

25 ORCHARD DRIVE ARMONK, NY




MICHAEL A PICCIRILLO, AIA
345 KEAR STREET

345 KEAR STREET YORKTOWN HEIGHTS, NEW YORK

TELEPHONE: 914-368-9838 FACSIMILE: 914-368-9839 michael@mpiccirilloarchitect.com www.mpiccirilloarchitect.com

SITE PLAN

A002

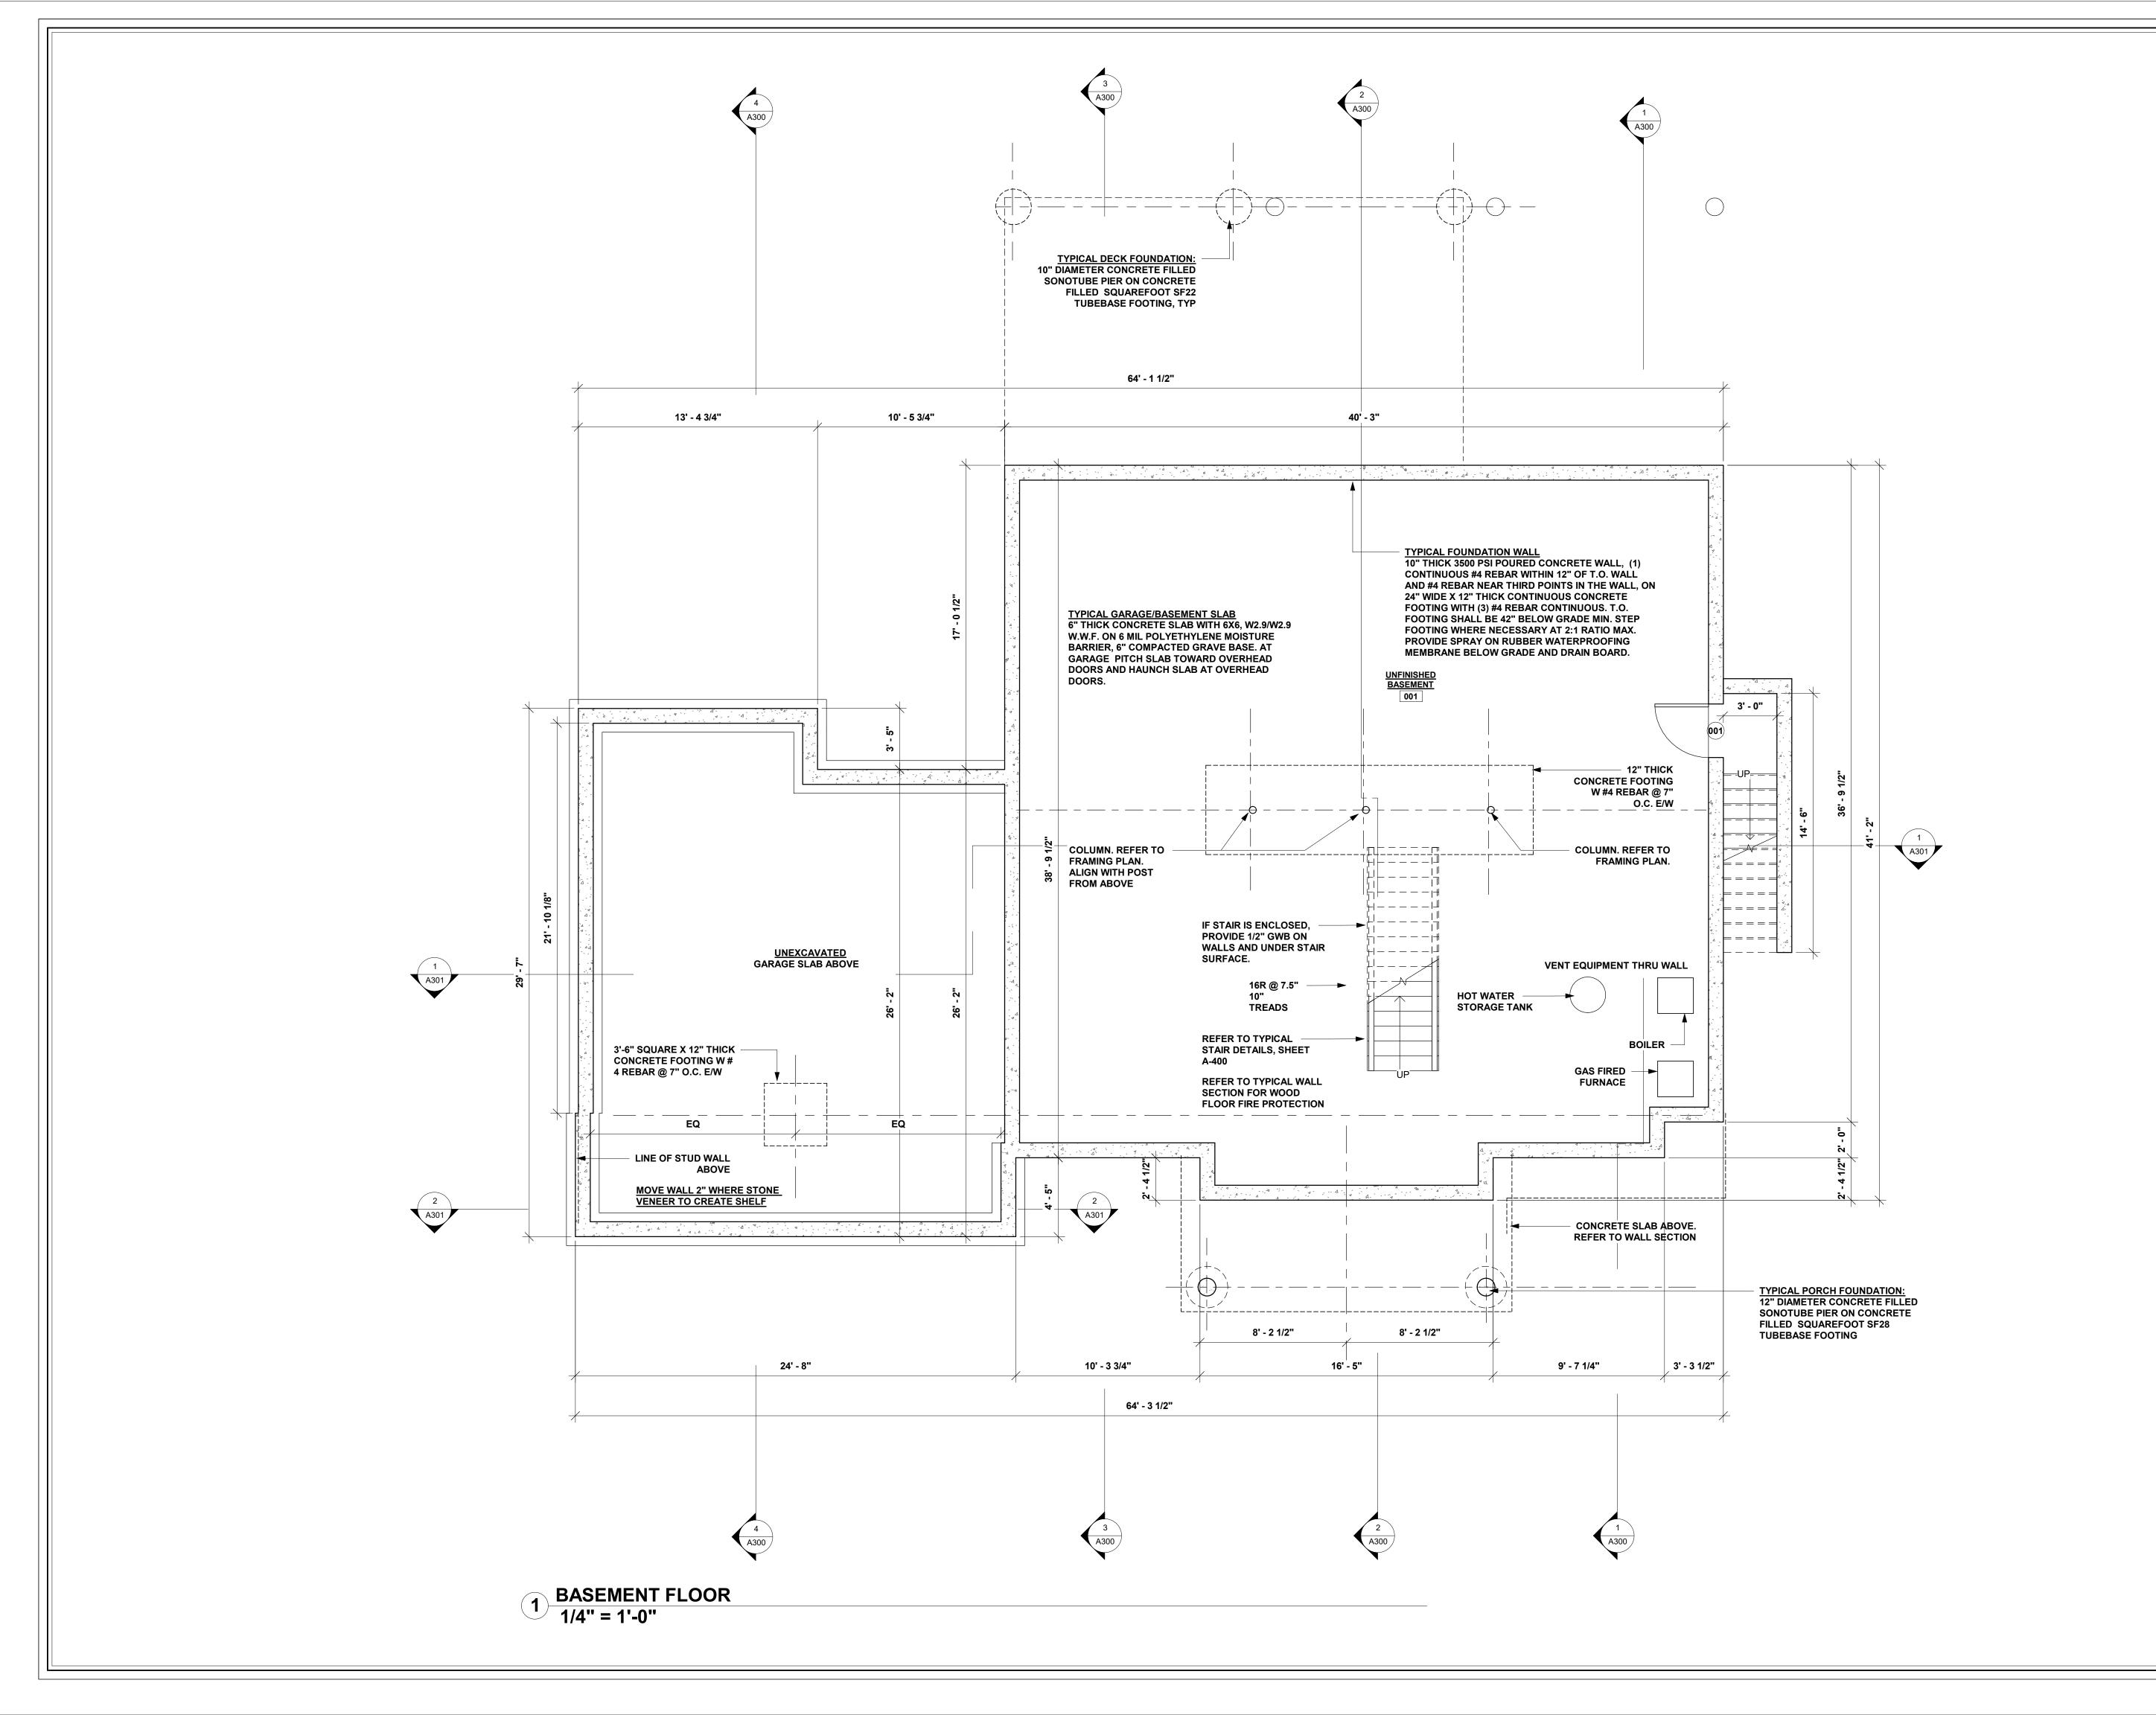



DO NOT SCALE DRAWINGS. REFER TO WRITTEN
MEASUREMENTS FOR ACCURANCY, OR CONTACT ARCHITECT.
CONTACT ARCHITECT IF THERE ARE ANY DISCECPENCIES.
UNAUTHORIZED ALTERATIONS OR ADDITIONS TO THIS
DRAWING IS A VIOLATION OF NEW YORK STATE EDUCATION

© Copyright 2020 MICHAEL PICCIRILLO ARCHITECTURE

 No.
 DATE:
 ISSUE:

 1
 2/28/22
 ISSUED

PROJECT NAME:
SINGLE FAMILY
HOUSE

PROJECT ADDRESS: 25 ORCHARD DRIVE ARMONK, NY



MICHAEL A PICCIRILLO, AIA

345 KEAR STREET YORKTOWN HEIGHTS, NEW YORK


TELEPHONE: 914-368-9838
FACSIMILE: 914-368-9839
michael@mpiccirilloarchitect.com
www.mpiccirilloarchitect.com

FOUNDATION/ BASEMENT PLAN

1/4" = 1'-0"

Drawn by
Author

Checked by
Checker
Project number

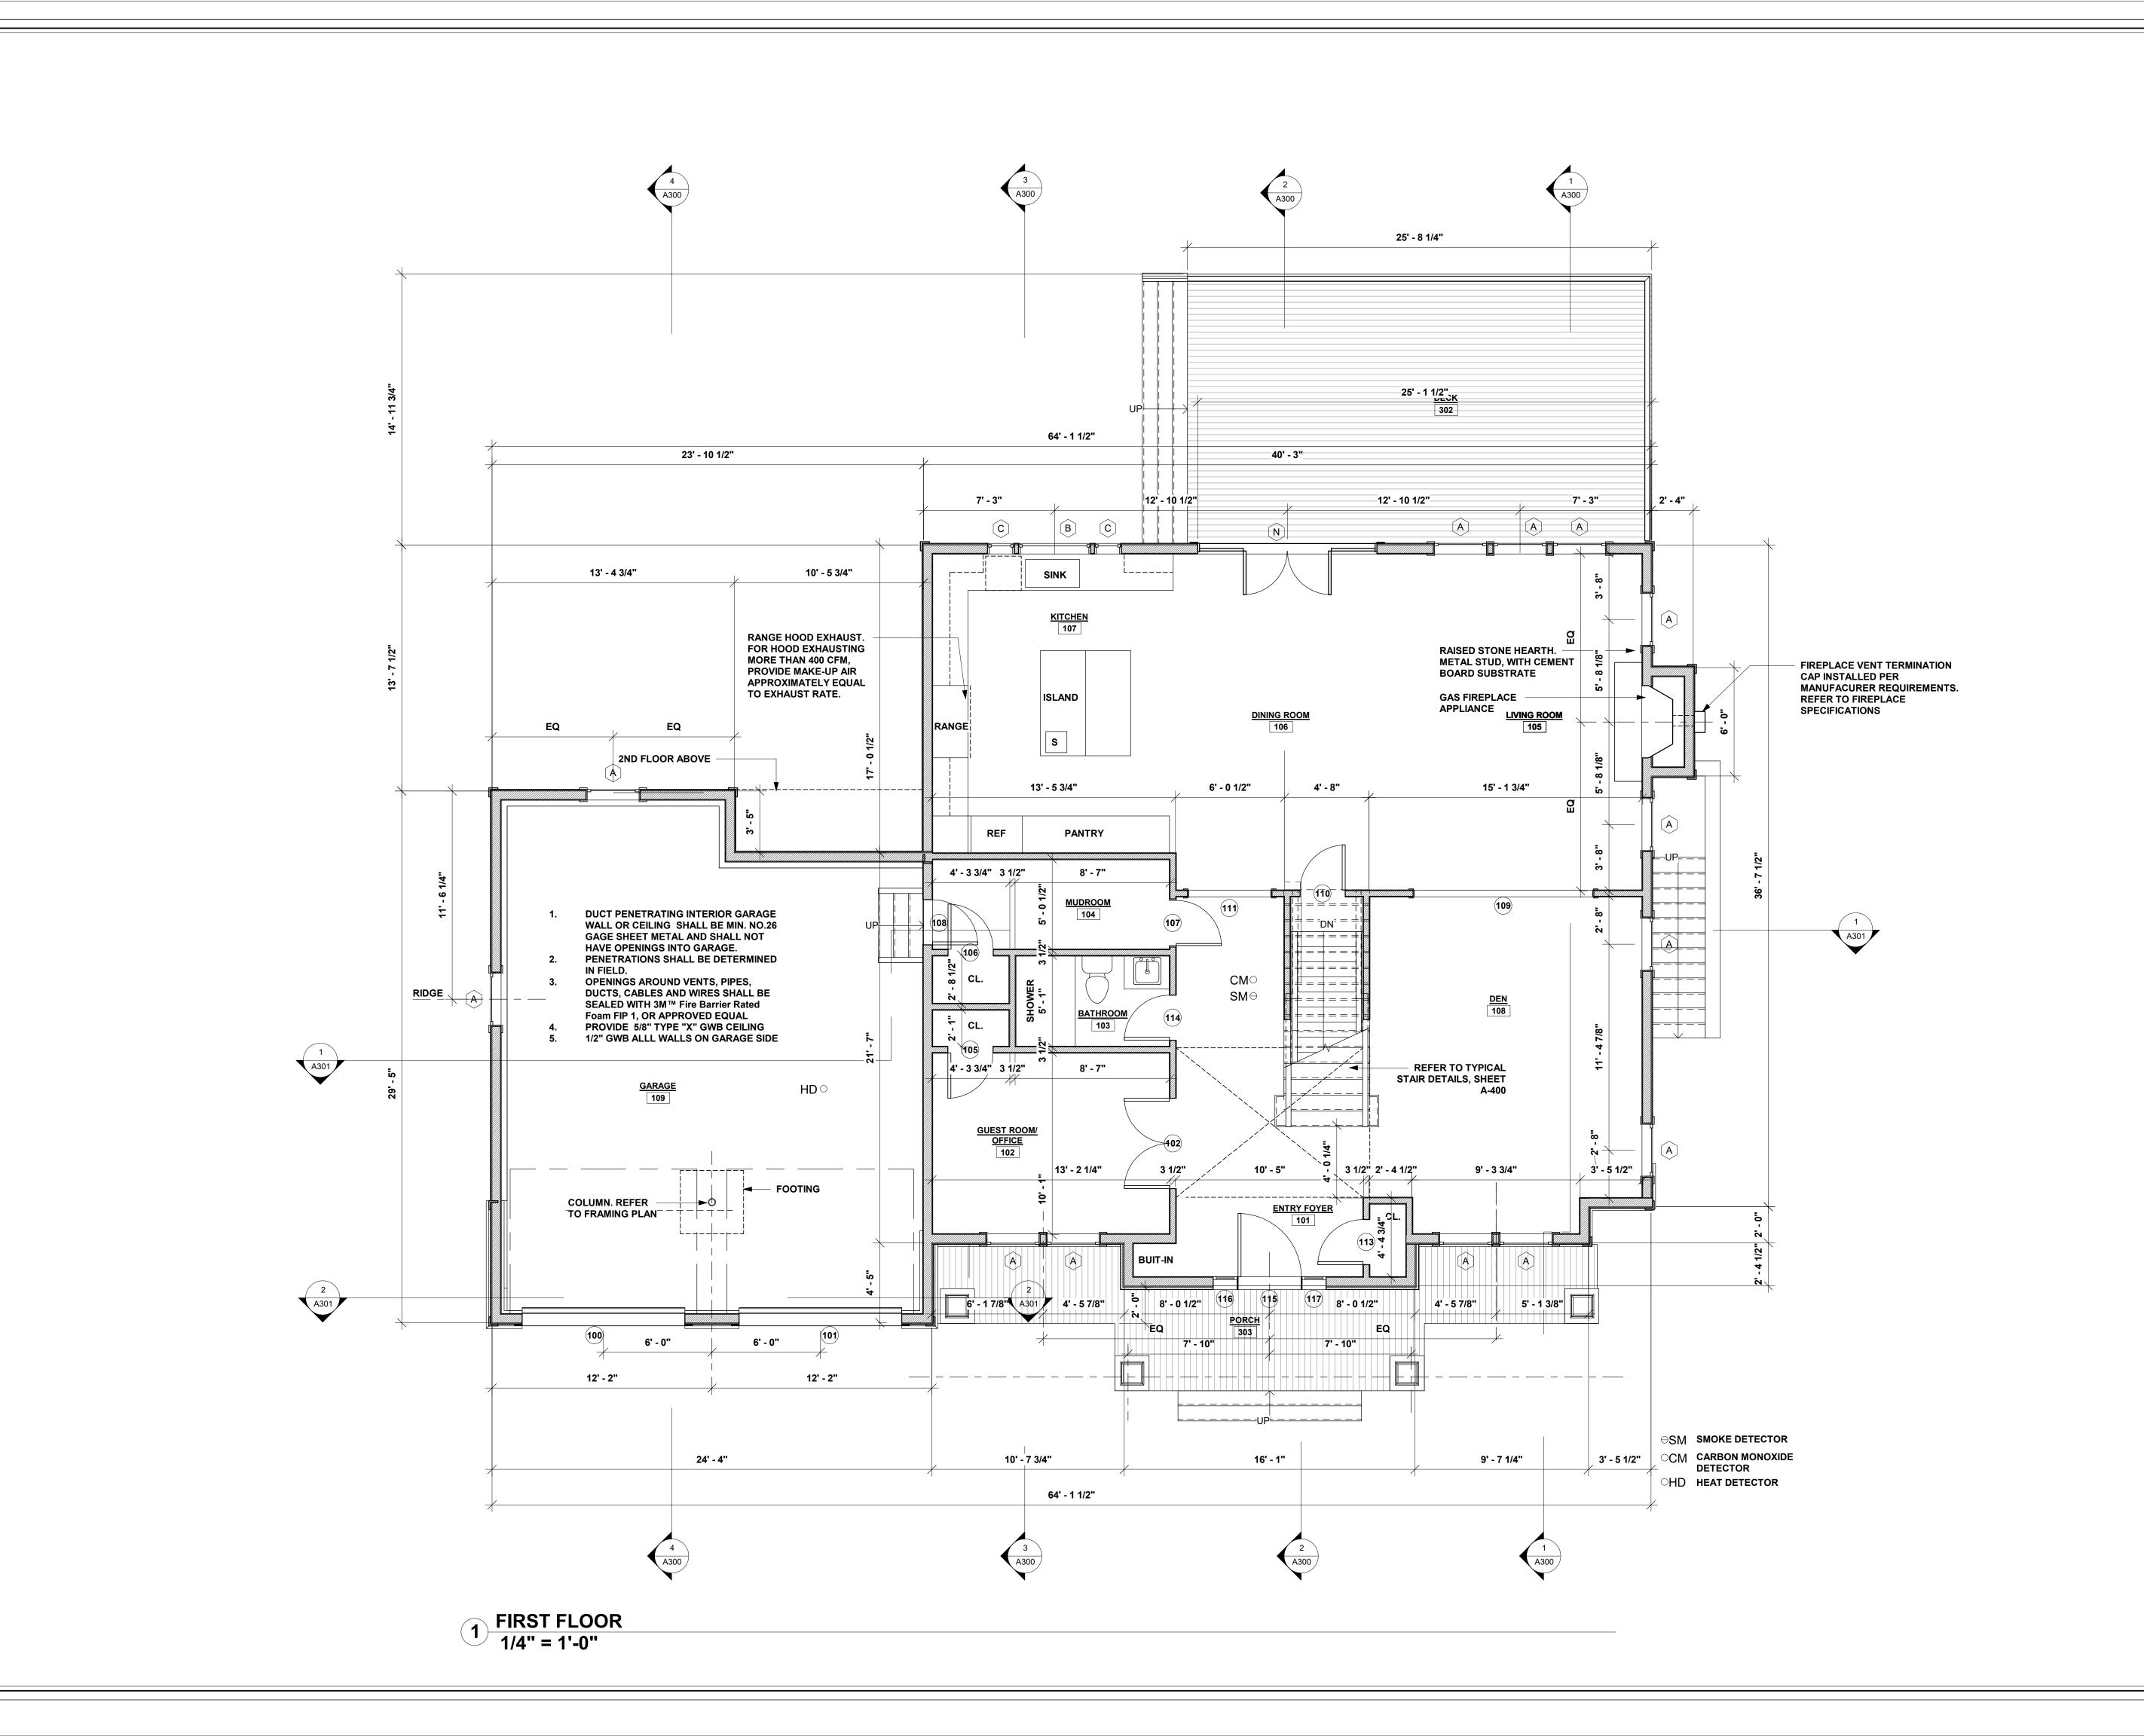



DO NOT SCALE DRAWINGS. REFER TO WRITTEN
MEASUREMENTS FOR ACCURANCY, OR CONTACT ARCHITECT.
CONTACT ARCHITECT IF THERE ARE ANY DISCECPENCIES.
UNAUTHORIZED ALTERATIONS OR ADDITIONS TO THIS
DRAWING IS A VIOLATION OF NEW YORK STATE EDUCATION

© Copyright 2020 MICHAEL PICCIRILLO ARCHITECTURE

 No.
 DATE:
 ISSUE:

 1
 2/28/22
 ISSUED

PROJECT NAME: SINGLE FAMILY HOUSE

PROJECT ADDRESS: 25 ORCHARD DRIVE ARMONK, NY



MICHAEL A PICCIRILLO, AIA

345 KEAR STREET YORKTOWN HEIGHTS, NEW YORK


TELEPHONE: 914-368-9838
FACSIMILE: 914-368-9839
michael@mpiccirilloarchitect.com
www.mpiccirilloarchitect.com

FIRST FLOOR PLAN

1/4" = 1'-0" Issue Date

Drawn by
Author
Checked by
Checker
Project number

Drawn by
Author
A 1 0 1

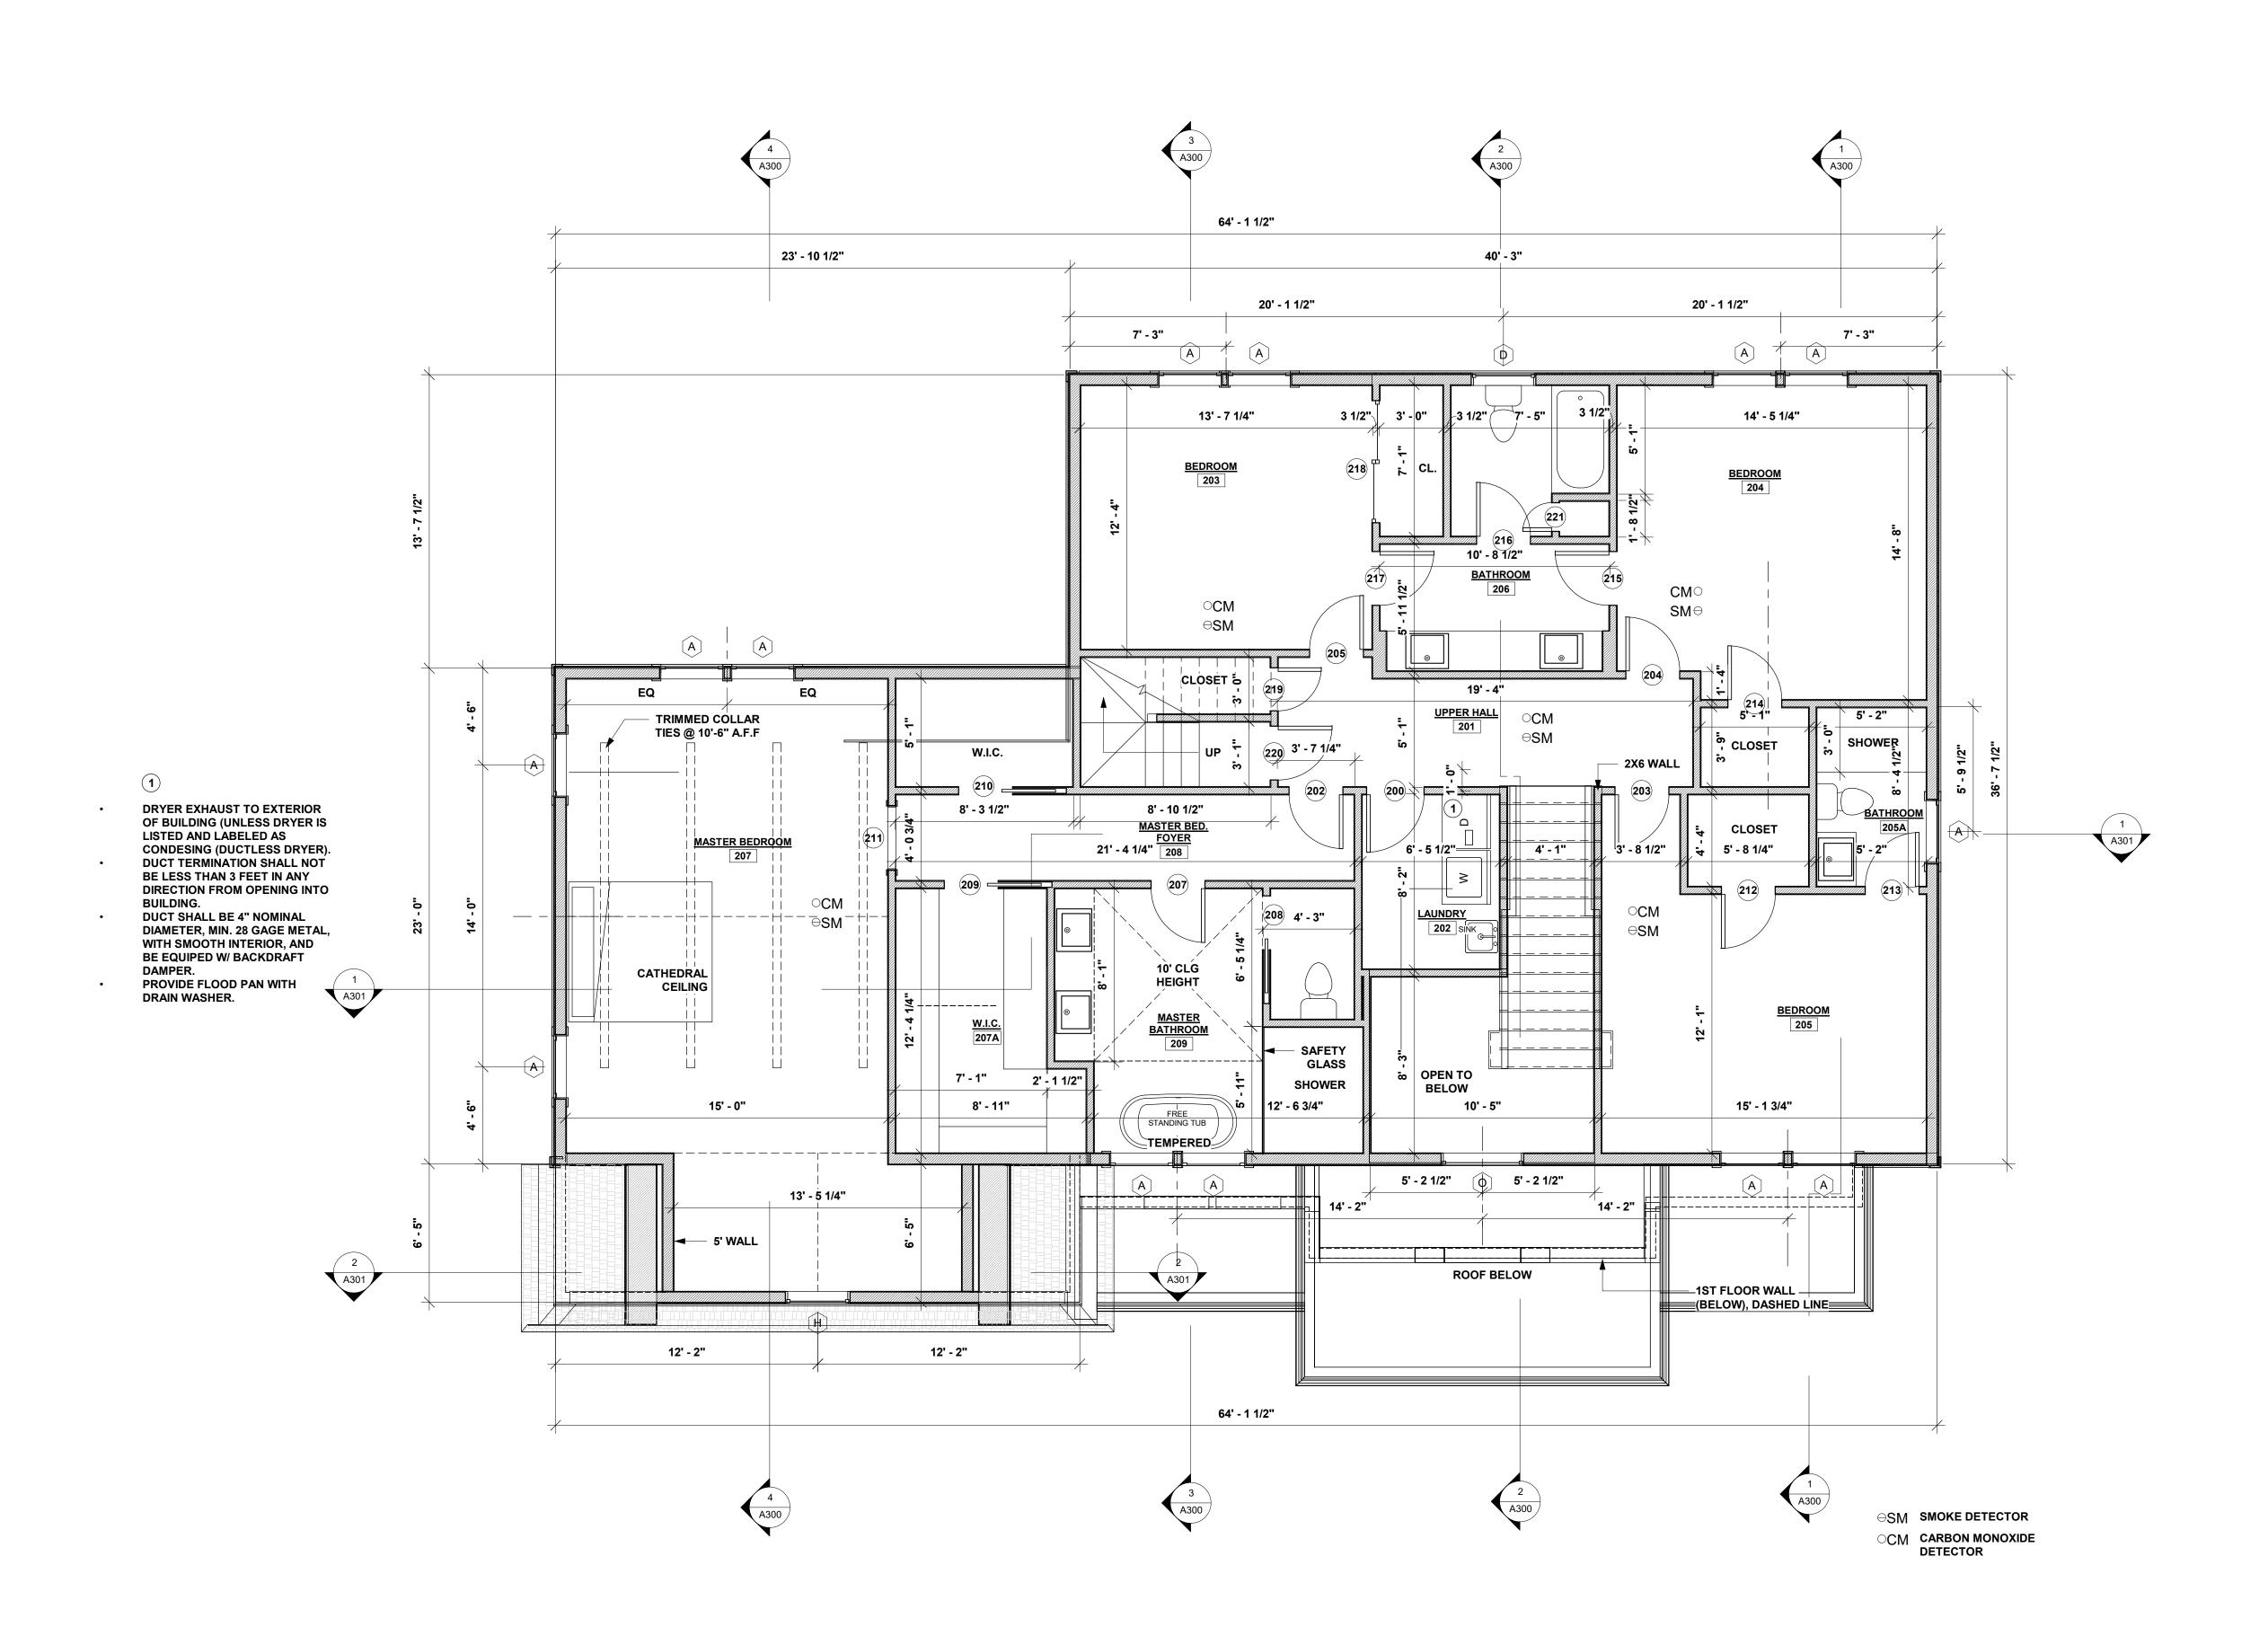

1 SECOND FLOOR 1/4" = 1'-0"

Michael Piccirillo Architecture

DO NOT SCALE DRAWINGS. REFER TO WRITTEN
MEASUREMENTS FOR ACCURANCY, OR CONTACT ARCHITECT.
CONTACT ARCHITECT IF THERE ARE ANY DISCECPENCIES.
UNAUTHORIZED ALTERATIONS OR ADDITIONS TO THIS
DRAWING IS A VIOLATION OF NEW YORK STATE EDUCATION

© Copyright 2020 MICHAEL PICCIRILLO ARCHITECTURE

 No.
 DATE:
 ISSUE:

 1
 2/28/22
 ISSUED

PROJECT NAME:
SINGLE FAMILY
HOUSE

PROJECT ADDRESS: 25 ORCHARD DRIVE ARMONK, NY



MICHAEL A PICCIRILLO, AIA

345 KEAR STREET YORKTOWN HEIGHTS, NEW YORK

TELEPHONE: 914-368-9838
FACSIMILE: 914-368-9839
michael@mpiccirilloarchitect.com
www.mpiccirilloarchitect.com


SECOND FLOOR PLAN

Scale
1/4" = 1'-0"

Drawn by
Author
Checked by
Checker
Project number

Date
Issue Date

A 102

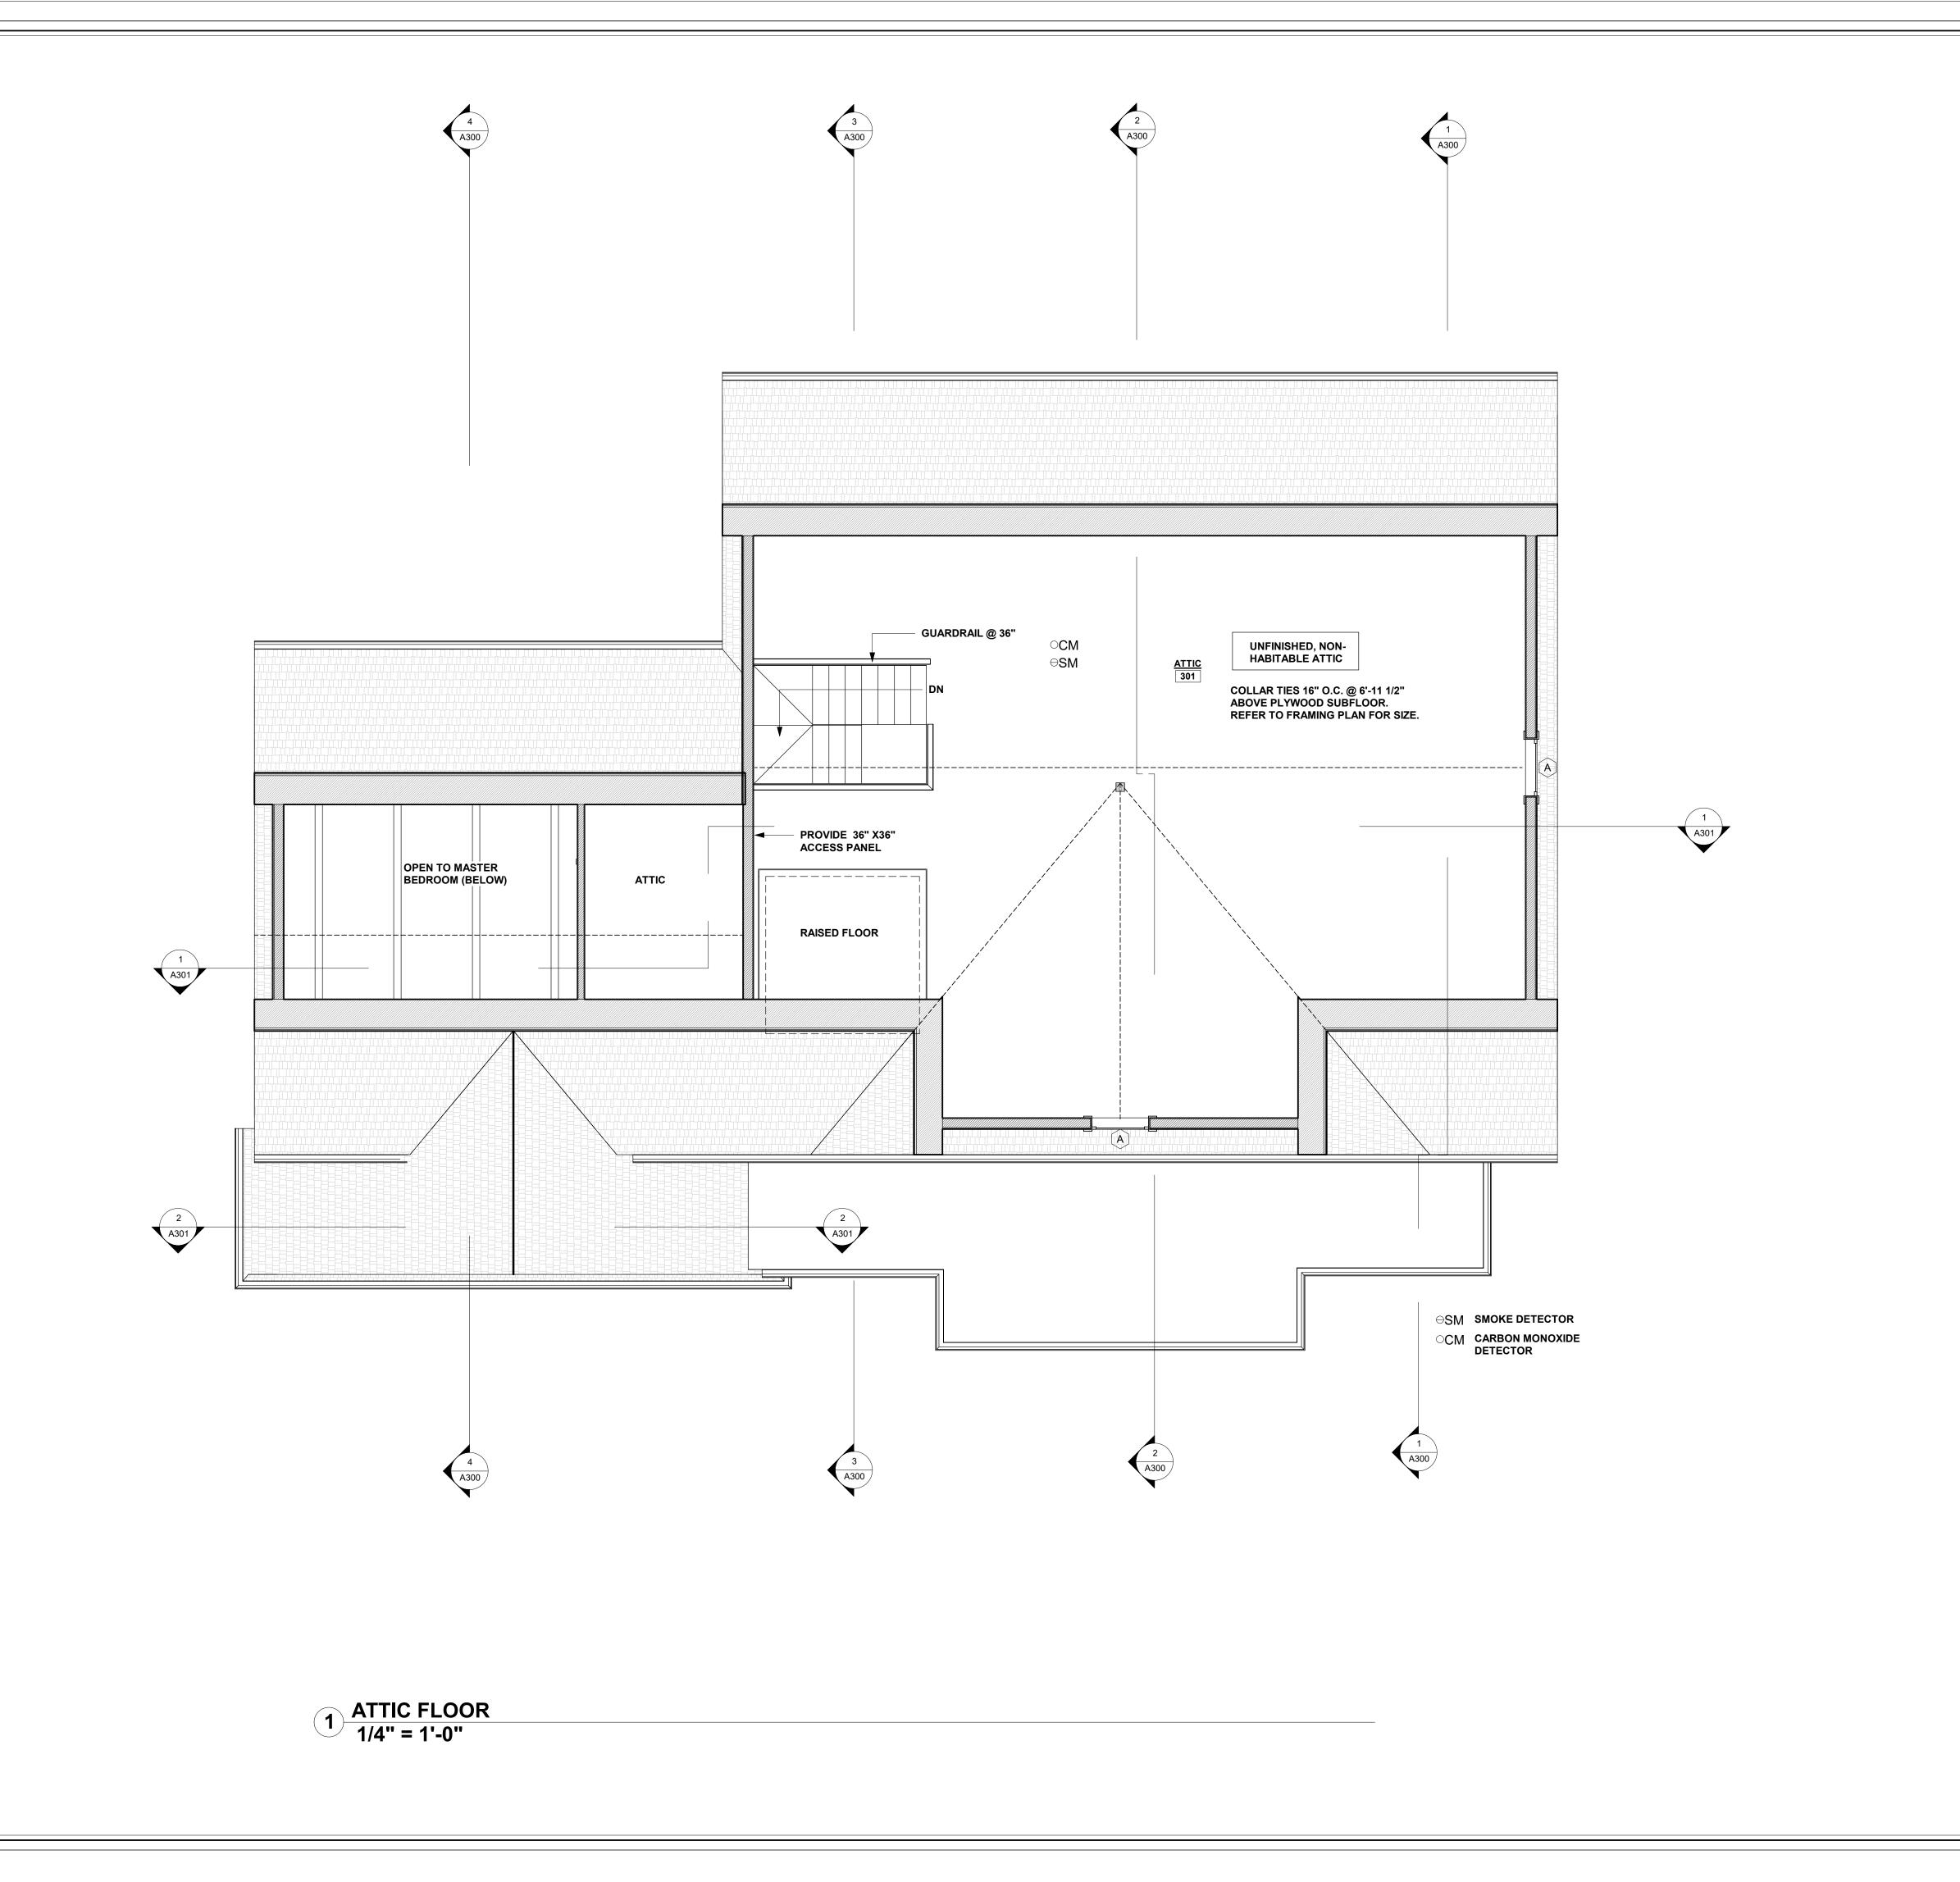



NOTE:

DO NOT SCALE DRAWINGS. REFER TO WRITTEN
MEASUREMENTS FOR ACCURANCY, OR CONTACT ARCHITECT.
CONTACT ARCHITECT IF THERE ARE ANY DISCECPENCIES.
UNAUTHORIZED ALTERATIONS OR ADDITIONS TO THIS
DRAWING IS A VIOLATION OF NEW YORK STATE EDUCATION

© Copyright 2020 MICHAEL PICCIRILLO ARCHITECTURE

 No.
 DATE:
 ISSUE:

 1
 2/28/22
 ISSUED

PROJECT NAME:
SINGLE FAMILY
HOUSE

PROJECT ADDRESS: 25 ORCHARD DRIVE ARMONK, NY



MICHAEL A PICCIRILLO, AIA

345 KEAR STREET YORKTOWN HEIGHTS, NEW YORK

TELEPHONE: 914-368-9838
FACSIMILE: 914-368-9839
michael@mpiccirilloarchitect.com
www.mpiccirilloarchitect.com


ATTIC FLOOR PLAN

Scale
1/4" = 1'-0"

Drawn by
Author
Checked by
Checker
Project number

Date
Issue Date

A 103

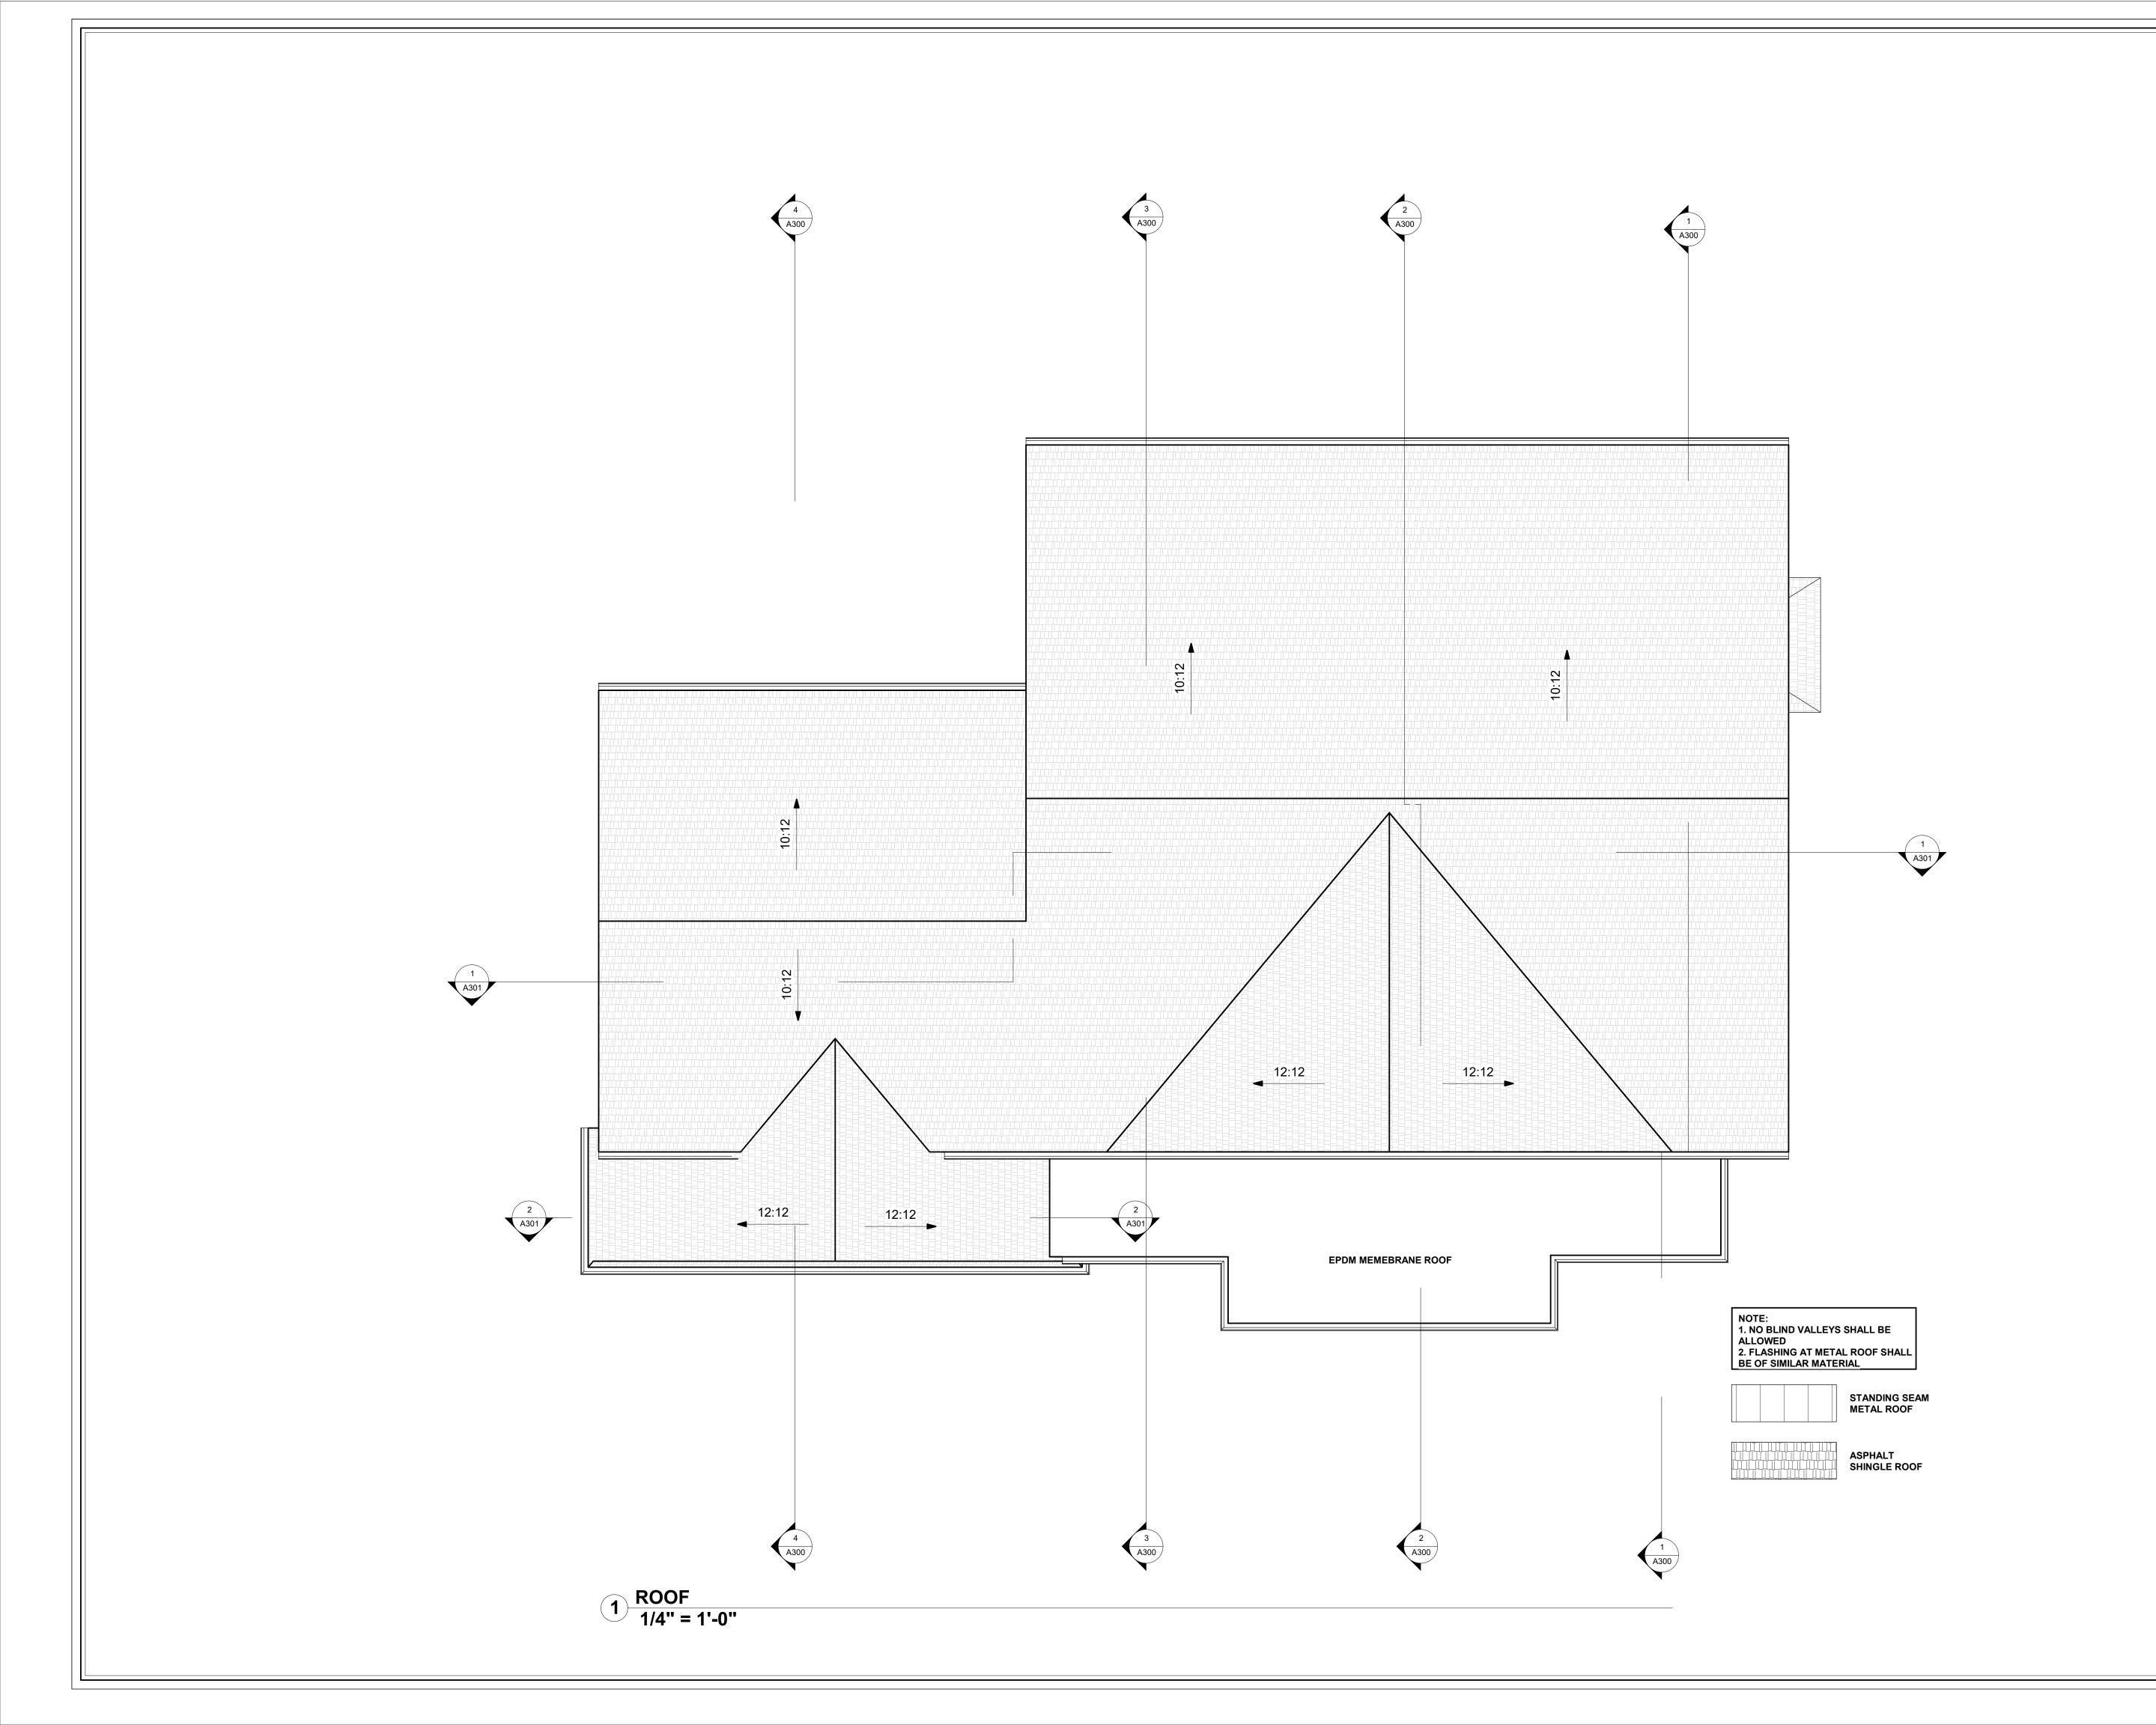



DO NOT SCALE DRAWINGS. REFER TO WRITTEN
MEASUREMENTS FOR ACCURANCY, OR CONTACT ARCHITECT.
CONTACT ARCHITECT IF THERE ARE ANY DISCECPENCIES.
UNAUTHORIZED ALTERATIONS OR ADDITIONS TO THIS
DRAWING IS A VIOLATION OF NEW YORK STATE EDUCATION

© Copyright 2020 MICHAEL PICCIRILLO ARCHITECTURE

 No.
 DATE:
 ISSUE:

 1
 2/28/22
 ISSUED

PROJECT NAME:
SINGLE FAMILY
HOUSE

PROJECT ADDRESS: 25 ORCHARD DRIVE ARMONK, NY



MICHAEL A PICCIRILLO, AIA

345 KEAR STREET YORKTOWN HEIGHTS, NEW YORK

TELEPHONE: 914-368-9838
FACSIMILE: 914-368-9839
michael@mpiccirilloarchitect.com
www.mpiccirilloarchitect.com

ROOF PLAN


Scale
1/4" = 1'-0"

Drawn by
Author
Checked by
Checker
Project number

Date
Issue Date

A 1 04



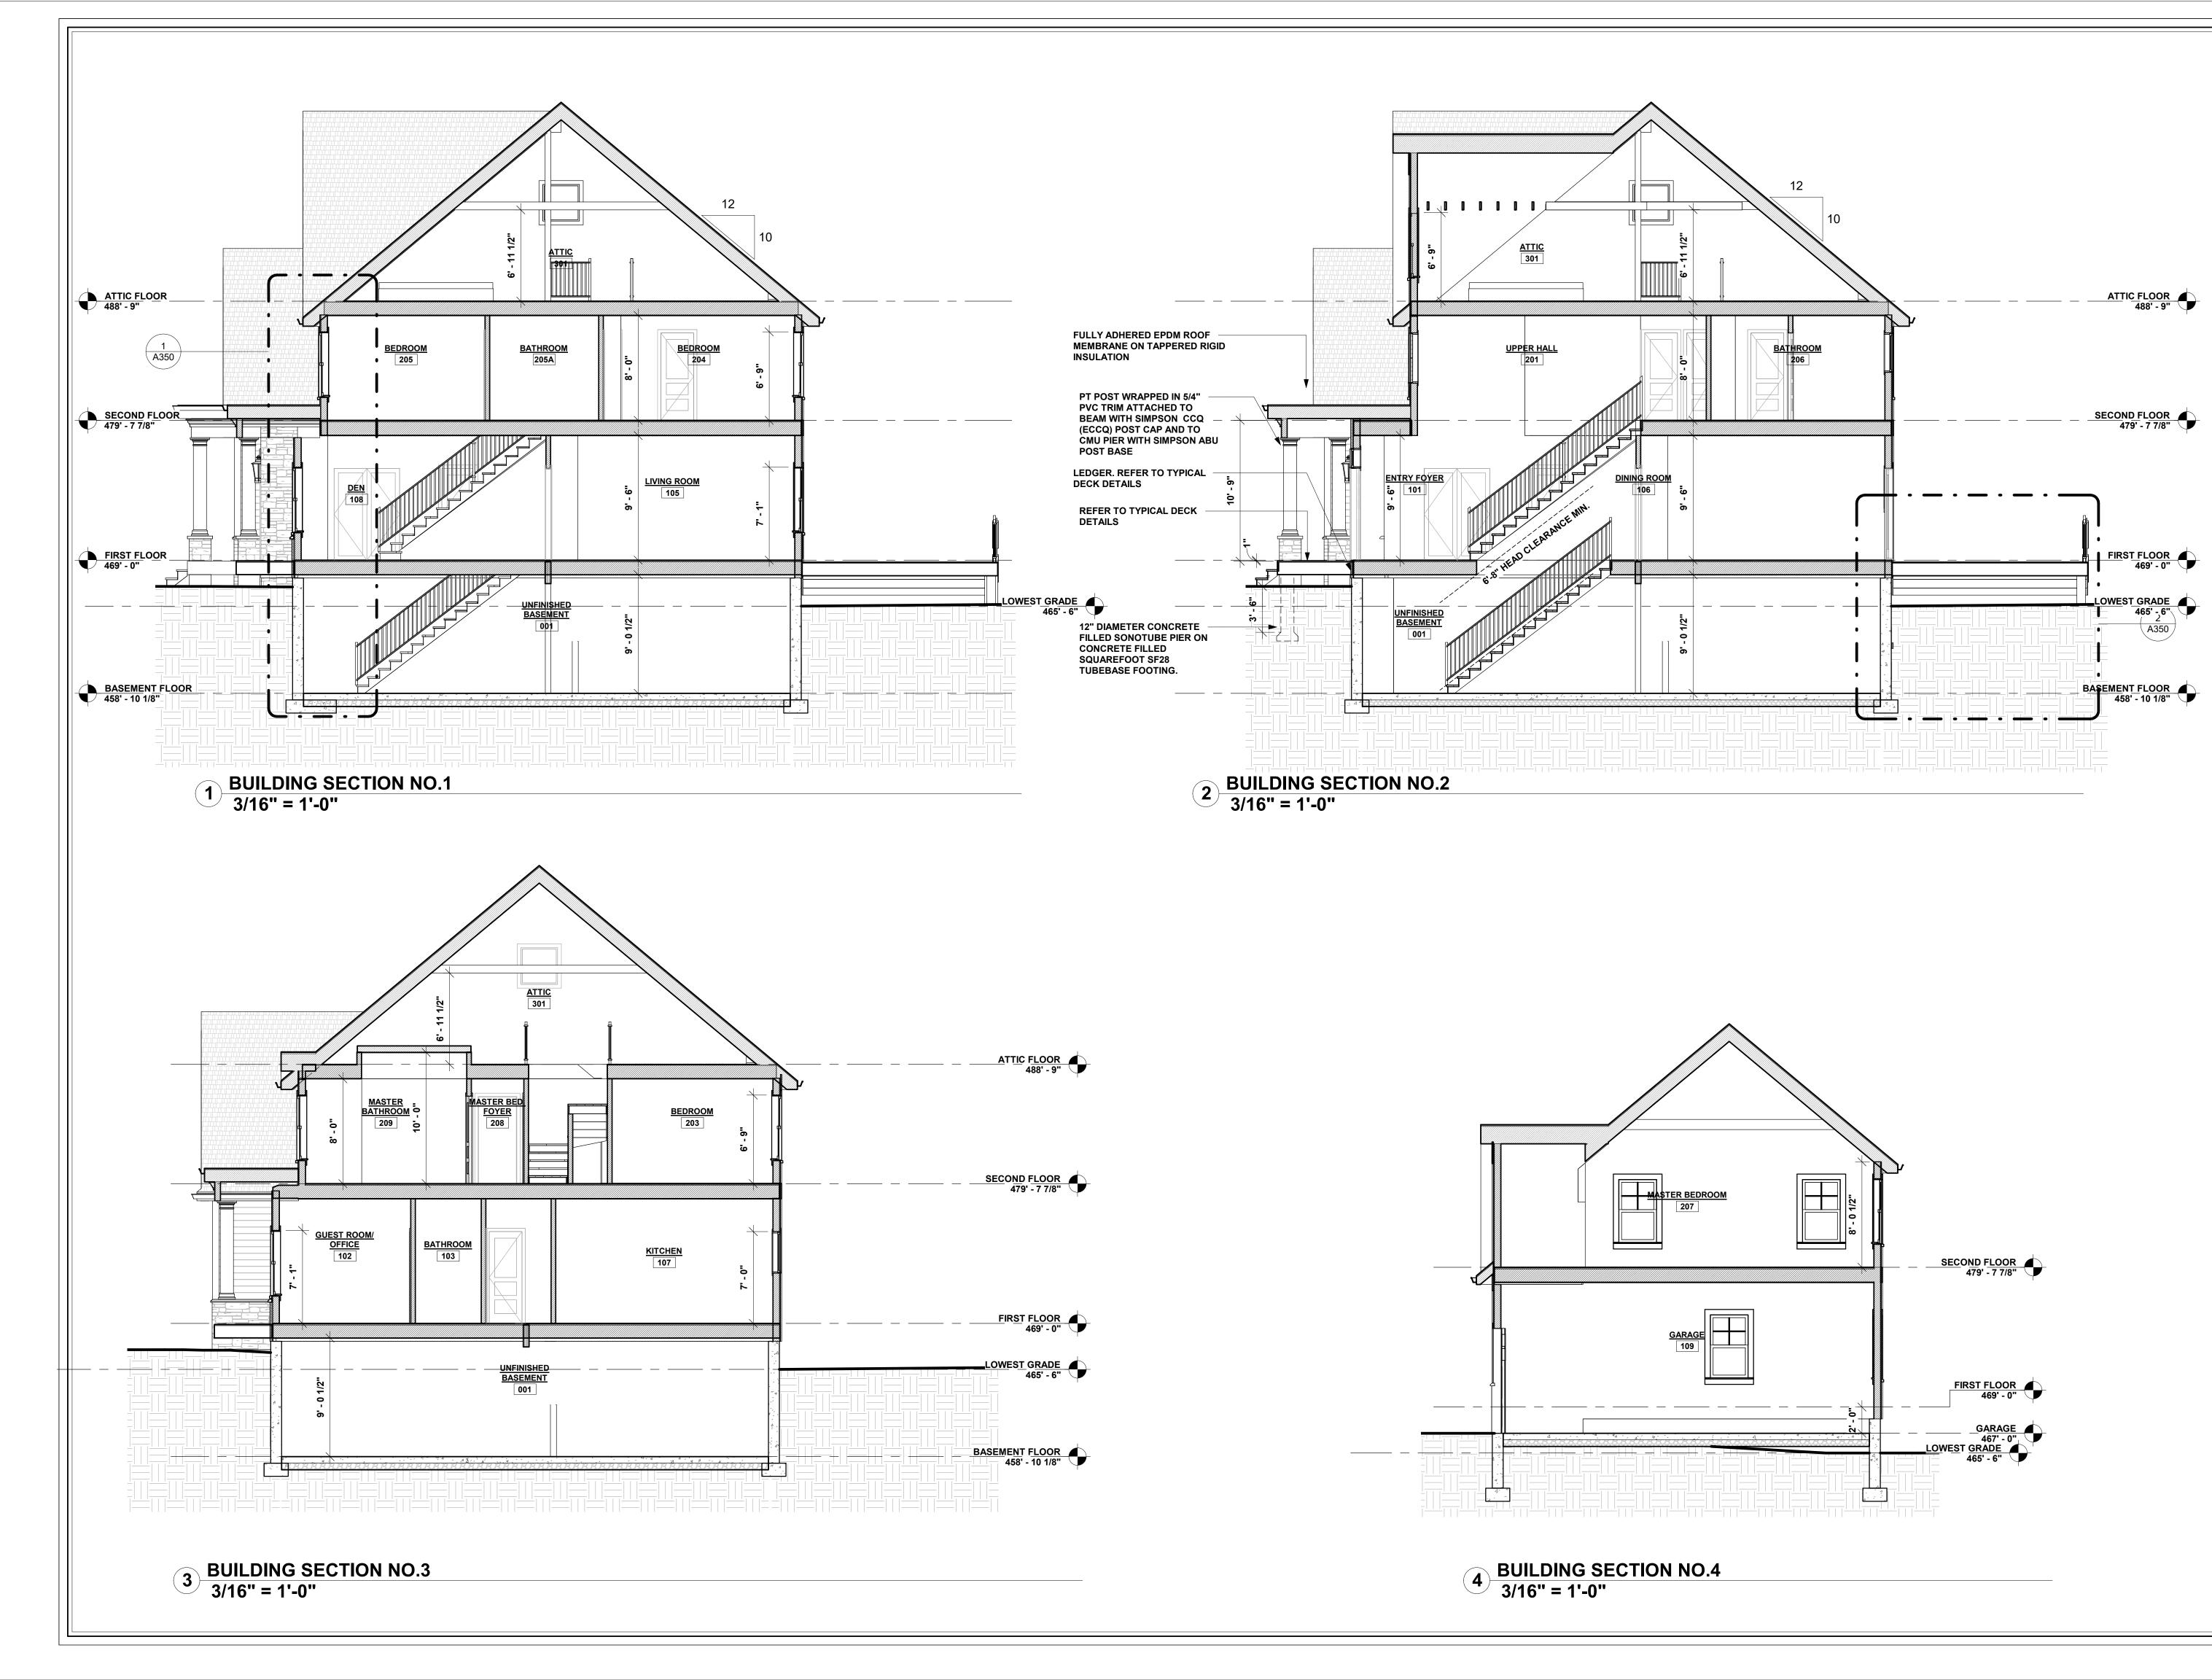

Michael Piccirillo Architecture

DO NOT SCALE DRAWINGS. REFER TO WRITTEN
MEASUREMENTS FOR ACCURANCY, OR CONTACT ARCHITECT.
CONTACT ARCHITECT IF THERE ARE ANY DISCECPENCIES.
UNAUTHORIZED ALTERATIONS OR ADDITIONS TO THIS
DRAWING IS A VIOLATION OF NEW YORK STATE EDUCATION
LAW.

© Copyright 2020 MICHAEL PICCIRILLO ARCHITECTURE

 No.
 DATE:
 ISSUE:

 1
 2/28/22
 ISSUED

PROJECT NAME: SINGLE FAMILY HOUSE

PROJECT ADDRESS: 25 ORCHARD DRIVE ARMONK, NY



MICHAEL A PICCIRILLO, AIA

345 KEAR STREET YORKTOWN HEIGHTS, NEW YORK

TELEPHONE: 914-368-9838 FACSIMILE: 914-368-9839 michael@mpiccirilloarchitect.com www.mpiccirilloarchitect.com

BUILDING SECTIONS


Scale
3/16" = 1'-0"


Drawn by
Author

Checked by
Checker
Project number


Date
Issue Date

A300

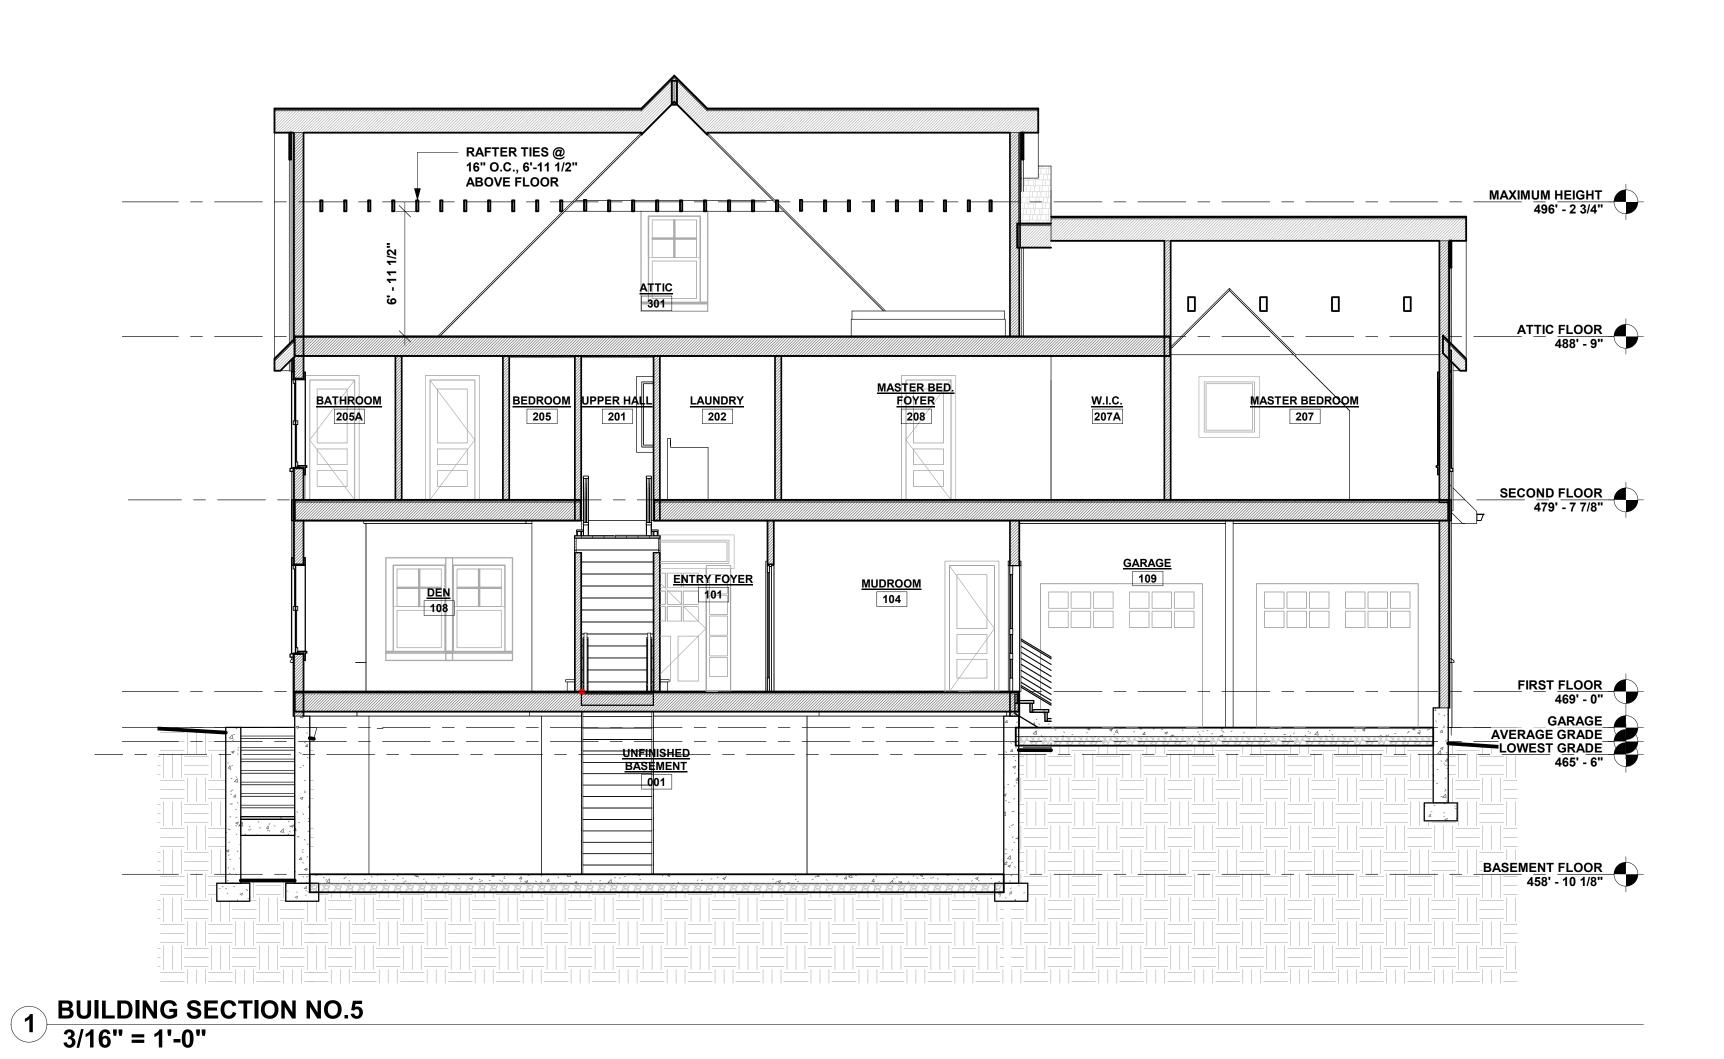

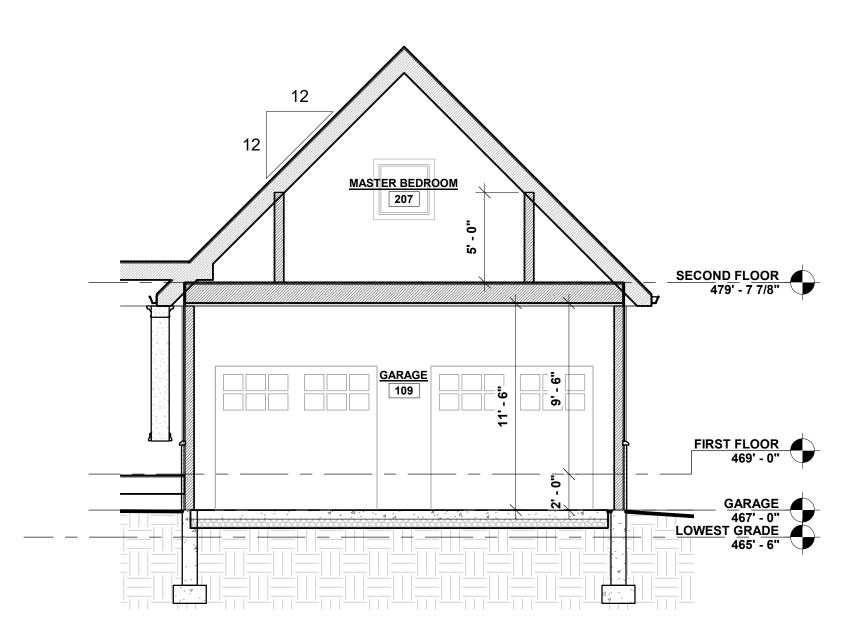

BUILDING SECTION NO.63/16" = 1'-0"

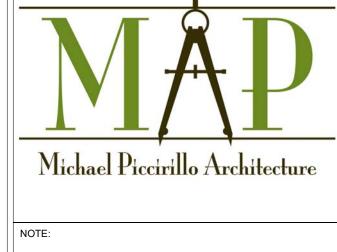

DO NOT SCALE DRAWINGS. REFER TO WRITTEN
MEASUREMENTS FOR ACCURANCY, OR CONTACT ARCHITECT.
CONTACT ARCHITECT IF THERE ARE ANY DISCECPENCIES.
UNAUTHORIZED ALTERATIONS OR ADDITIONS TO THIS
DRAWING IS A VIOLATION OF NEW YORK STATE EDUCATION
I AW

© Copyright 2020 MICHAEL PICCIRILLO ARCHITECTURE

 No.
 DATE:
 ISSUE:

 1
 2/28/22
 ISSUED

PROJECT NAME:
SINGLE FAMILY
HOUSE

PROJECT ADDRESS: 25 ORCHARD DRIVE ARMONK, NY



MICHAEL A PICCIRILLO, AIA

345 KEAR STREET YORKTOWN HEIGHTS, NEW YORK

TELEPHONE: 914-368-9838 FACSIMILE: 914-368-9839 michael@mpiccirilloarchitect.com www.mpiccirilloarchitect.com

> BUILDING SECTIONS


Scale
3/16" = 1'-0"


Drawn by
Author

Checked by
Checker
Project number

Date
Issue Date

A301

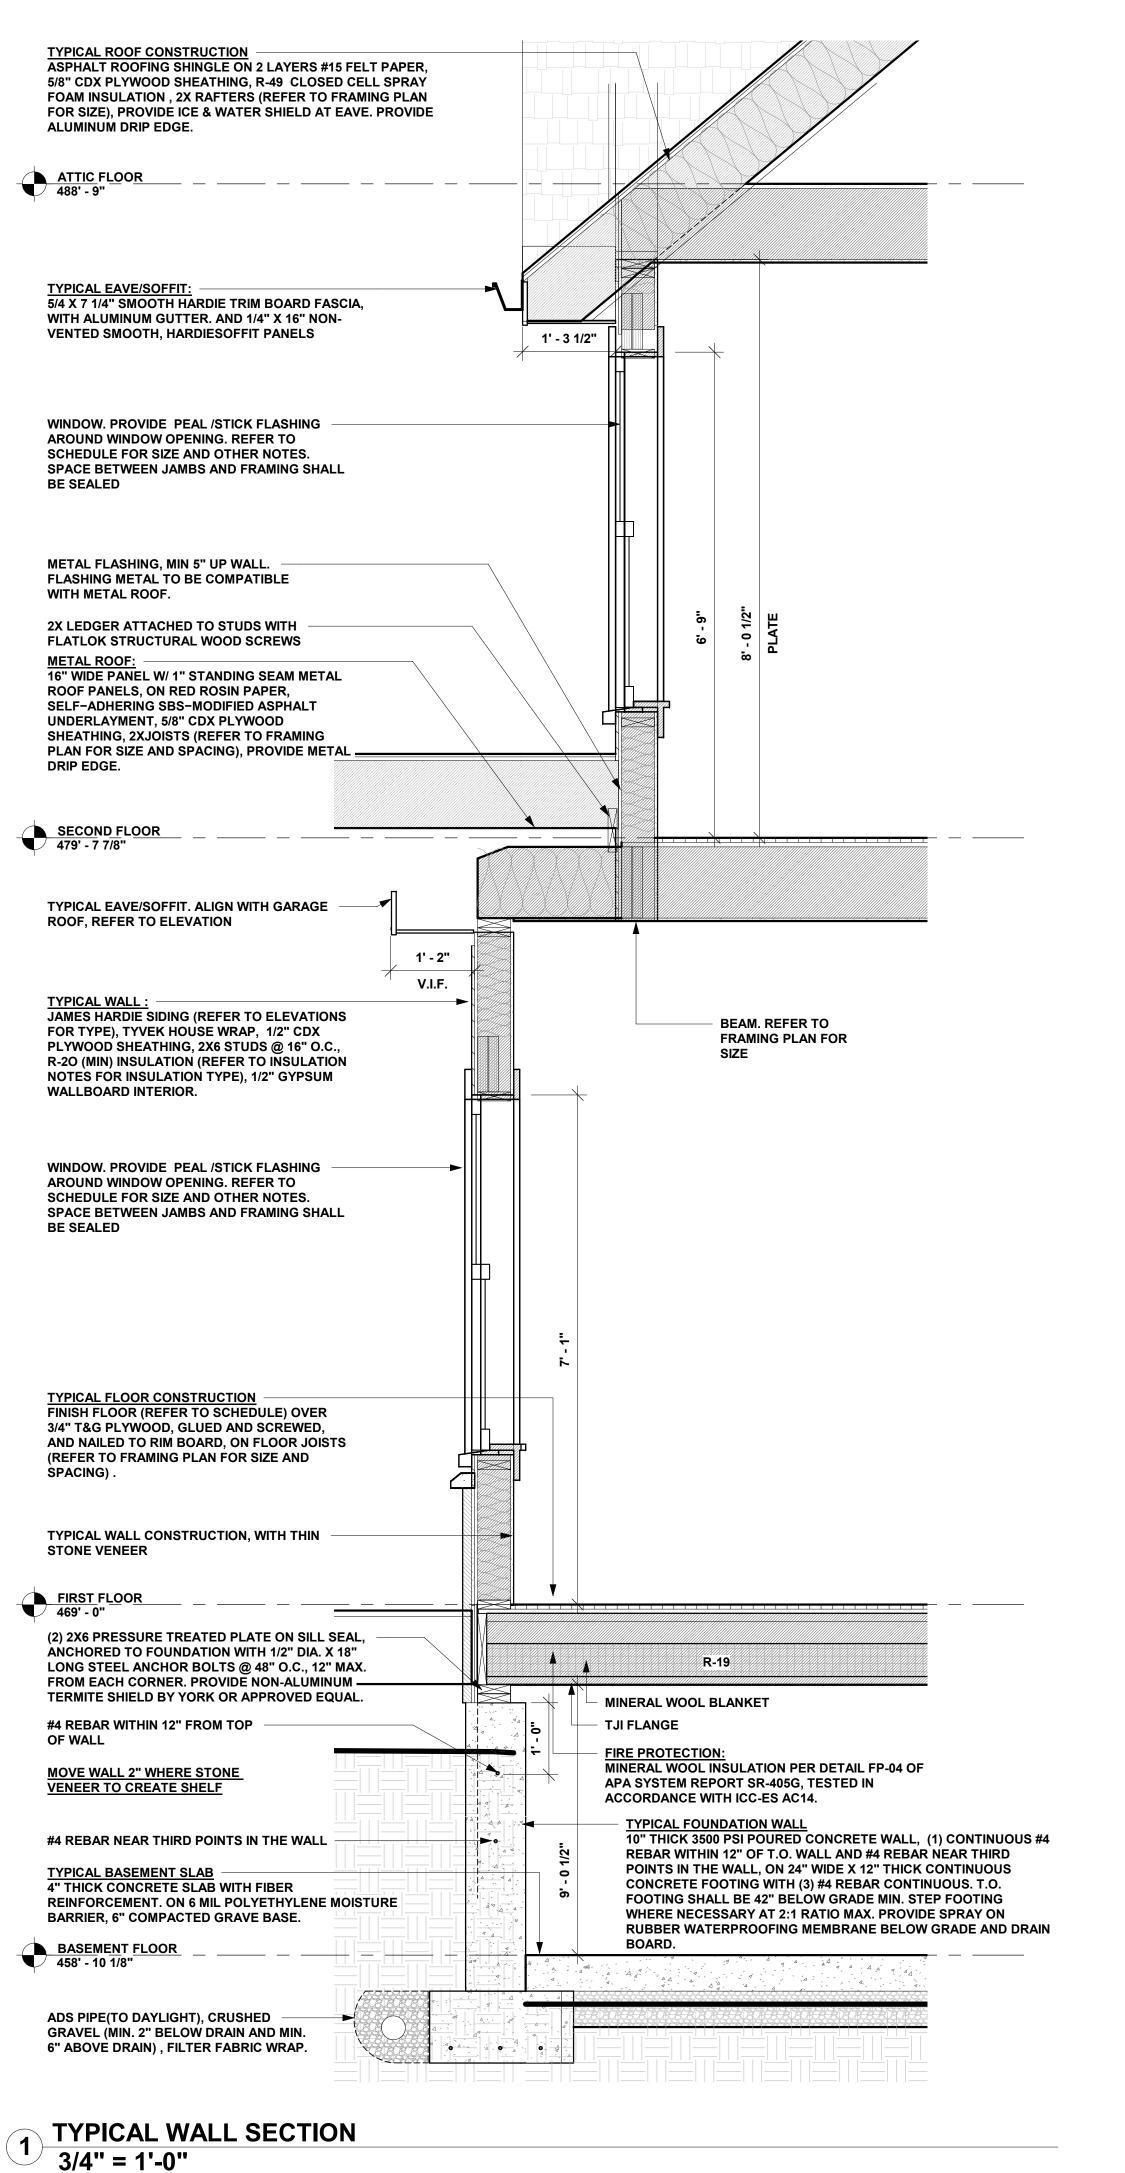

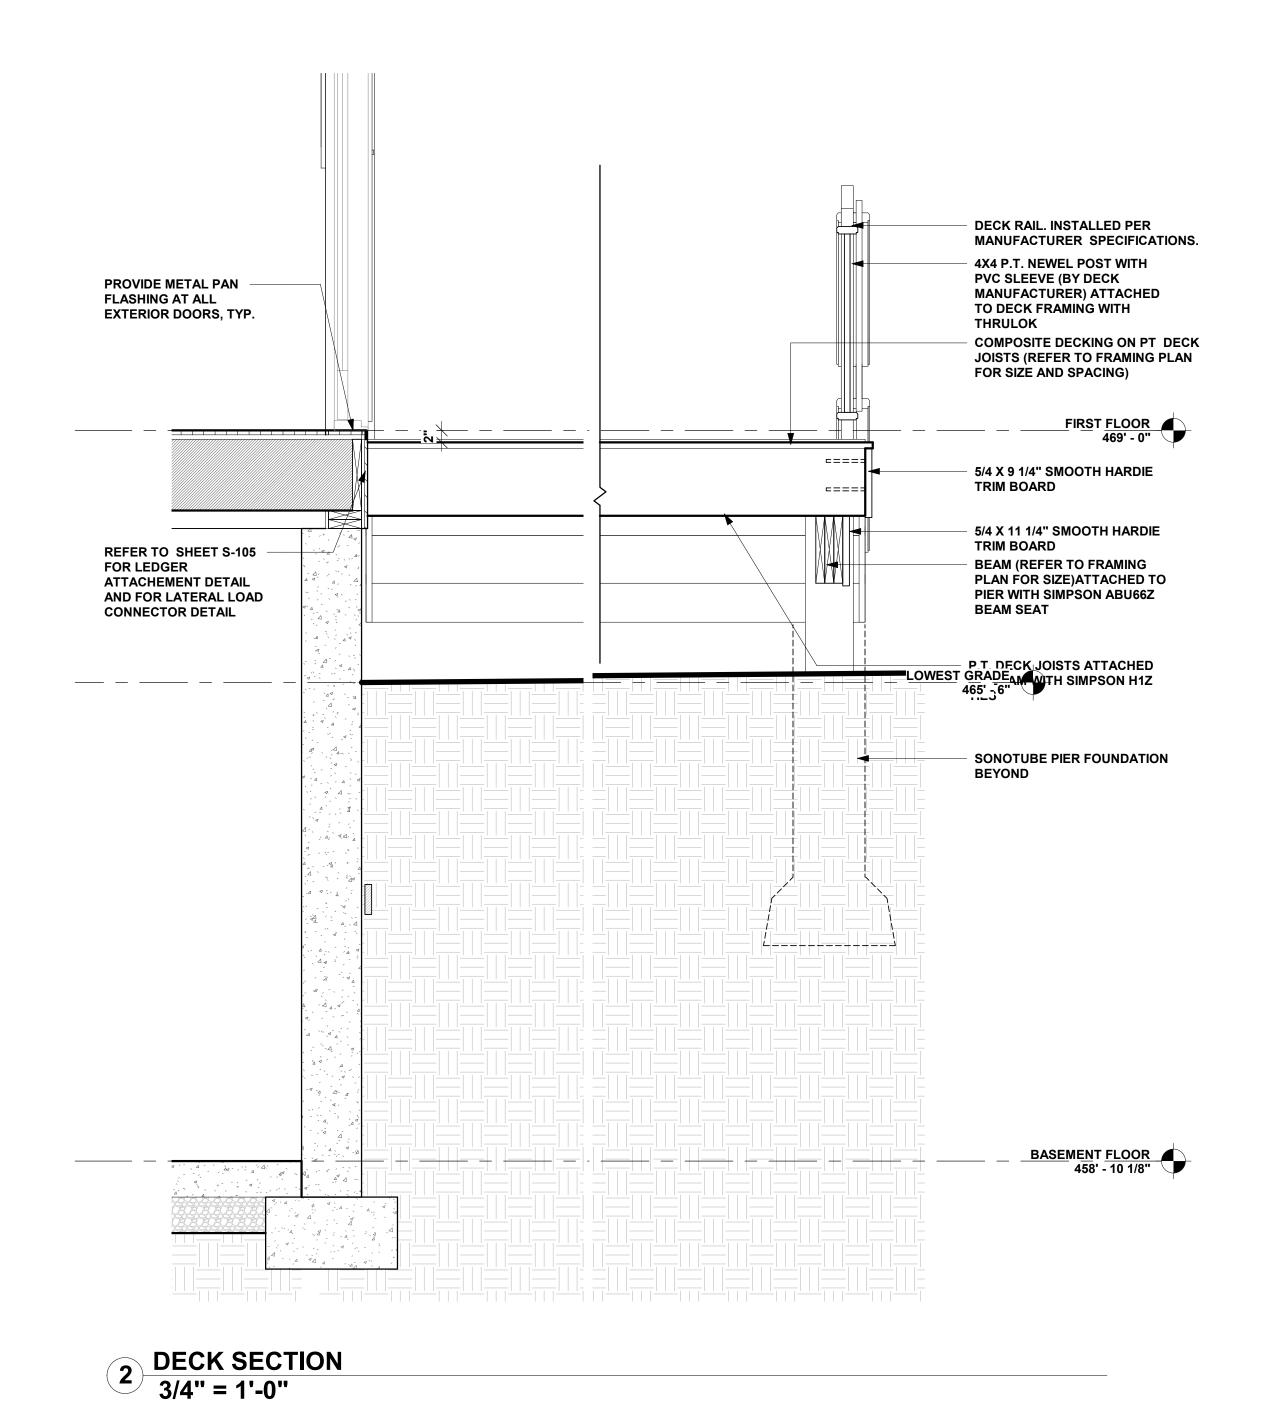

NOTE:

DO NOT SCALE DRAWINGS. REFER TO WRITTEN MEASUREMENTS FOR ACCURANCY, OR CONTACT ARCHITECT. CONTACT ARCHITECT IF THERE ARE ANY DISCECPENCIES. UNAUTHORIZED ALTERATIONS OR ADDITIONS TO THIS DRAWING IS A VIOLATION OF NEW YORK STATE EDUCATION LAW.

© Copyright 2020 MICHAEL PICCIRILLO ARCHITECTURE

Michael Piccirillo Architecture

 No.
 DATE:
 ISSUE:

 1
 2/28/22
 ISSUED

PROJECT NAME:
SINGLE FAMILY
HOUSE

PROJECT ADDRESS: 25 ORCHARD DRIVE ARMONK, NY



MICHAEL A PICCIRILLO, AIA

345 KEAR STREET YORKTOWN HEIGHTS, NEW YORK

TELEPHONE: 914-368-9838
FACSIMILE: 914-368-9839
michael@mpiccirilloarchitect.com
www.mpiccirilloarchitect.com

WALL SECTIONS


Scale
3/4" = 1'-0"

Drawn by
Author
Checked by

Date
Issue Date

A 2 5 0

Checker Project number

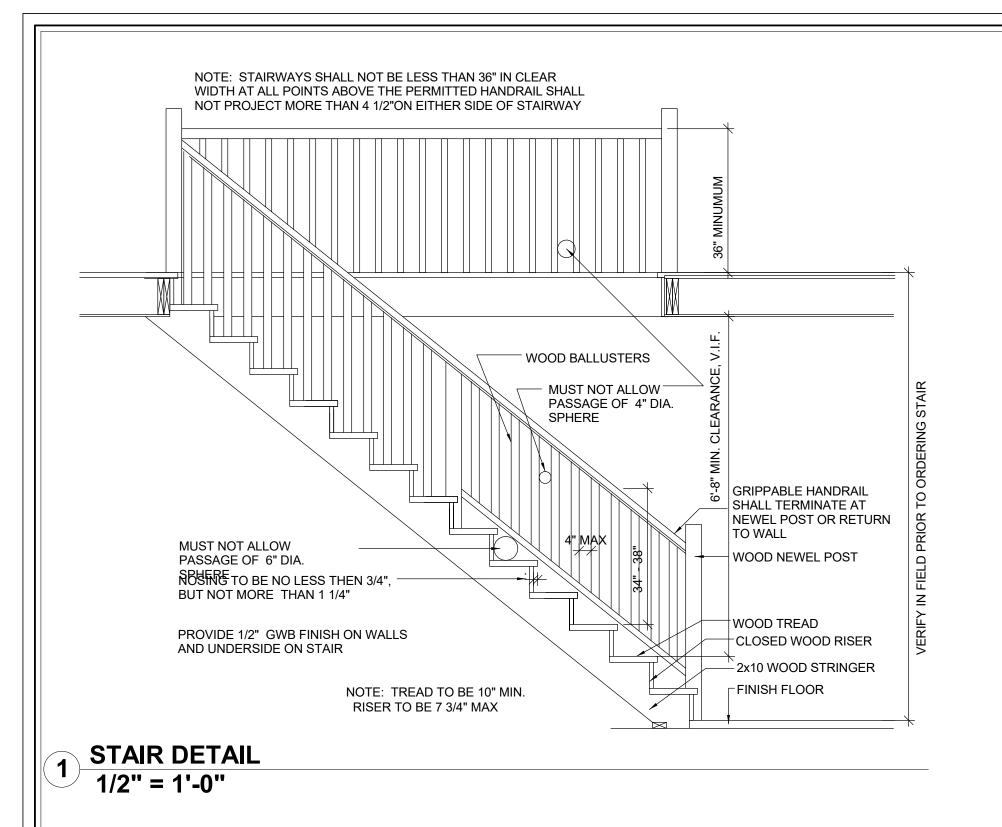


WINDOW SCHEDULE							
TAG	WIDTH	HEIGHT	OPERATION	COMMENTS			
Α	3' - 0"	5' - 0"	DOUBLE HUNG	EGRESS SIZE			
Α	3' - 0"	5' - 0"	DOUBLE HUNG	EGRESS SIZE			
Α	3' - 0"	5' - 0"	DOUBLE HUNG	EGRESS SIZE			
Α	3' - 0"	5' - 0"	DOUBLE HUNG	EGRESS SIZE			
A	3' - 0"	5' - 0"	DOUBLE HUNG	EGRESS SIZE			
Α	3' - 0"	5' - 0"	DOUBLE HUNG	EGRESS SIZE			
Α	3' - 0"	5' - 0"	DOUBLE HUNG	EGRESS SIZE			
Α	3' - 0"	5' - 0"	DOUBLE HUNG	EGRESS SIZE			
Α	3' - 0"	5' - 0"	DOUBLE HUNG	EGRESS SIZE			
Α	3' - 0"	5' - 0"	DOUBLE HUNG	EGRESS SIZE			
Α	3' - 0"	5' - 0"	DOUBLE HUNG	EGRESS SIZE			
A	3' - 0"	5' - 0"	DOUBLE HUNG	EGRESS SIZE			
A	3' - 0"	5' - 0"	DOUBLE HUNG	EGRESS SIZE			
			1				

"A" WINDOWS IN MASTER BATHROOM AND BATHROOM 205A SHALL BE TEMPERED "D" WINDOWS IN BATHROOM 206 SHALL BE TEMPERED GLASS.

	WINDOW SCHEDULE							
TAG	WIDTH	HEIGHT	OPERATION	COMMENTS				
Α	3' - 0"	5' - 0"	DOUBLE HUNG	EGRESS SIZE				
Α	3' - 0"	5' - 0"	DOUBLE HUNG	EGRESS SIZE				
Α	3' - 0"	5' - 0"	DOUBLE HUNG	EGRESS SIZE				
Α	3' - 0"	5' - 0"	DOUBLE HUNG	EGRESS SIZE				
Α	3' - 0"	5' - 0"	DOUBLE HUNG	EGRESS SIZE				
Α	3' - 0"	5' - 0"	DOUBLE HUNG	EGRESS SIZE				
Α	3' - 0"	5' - 0"	DOUBLE HUNG	EGRESS SIZE				
В	4' - 0"	3' - 2"	PICTURE					
С	1' - 6"	3' - 2"	CASEMENT					
С	1' - 6"	3' - 2"	CASEMENT					
D	3' - 0"	3' - 0"	AWNING					
E	2' - 6"	2' - 6"	AWNING					
Н	3' - 0"	3' - 0"	AWNING					
Н	3' - 0"	3' - 0"	AWNING					
N	9' - 11"	7' - 0"	FRENCH DOOR					
О	3' - 10"	3' - 10"						
S	6' - 3 1/4"	1' - 6"						

- WINDOW SIZES INDICATED ON SCHEDULE ARE NOMINAL SIZES. G.C. SHALL PROVIDE SHOP DRAWINGS WITH ACTUAL MANUFACTURER WINDOW SIZES.
- 2. WINDOWS SHALL BE INSTALLED ACCORDING TO: ASTM E-2112-07 STANDARDS FOR WINDOW AND DOOR INSTALLATION.

THE G.C. SHALL REVIEW ALL WINDOW AND DOOR ORDERS WITH THE MANUFACTURER'S REPRESENTATIVE TO COORDINATE SPECIFIED WINDOWS AND DOORS WITH INTENDED RESULTS SHOWN AND INDICATED ON DRAWINGS. G.C. SHALL PROVIDE SHOP DRAWINGS INDICATING STANDARD WINDOW MODEL SIZES FOR REVIEW AND APPROVAL BY ARCHITECT PRIOR TO ORDERING WINDOWS. G.C. ASSUMES ALL RESPONSIBILITY FOR WINDOW ORDER IF SHOP DRAWING ARE NOT APPROVED BY ARCHITECT PRIOR TO ORDERING WINDOWS

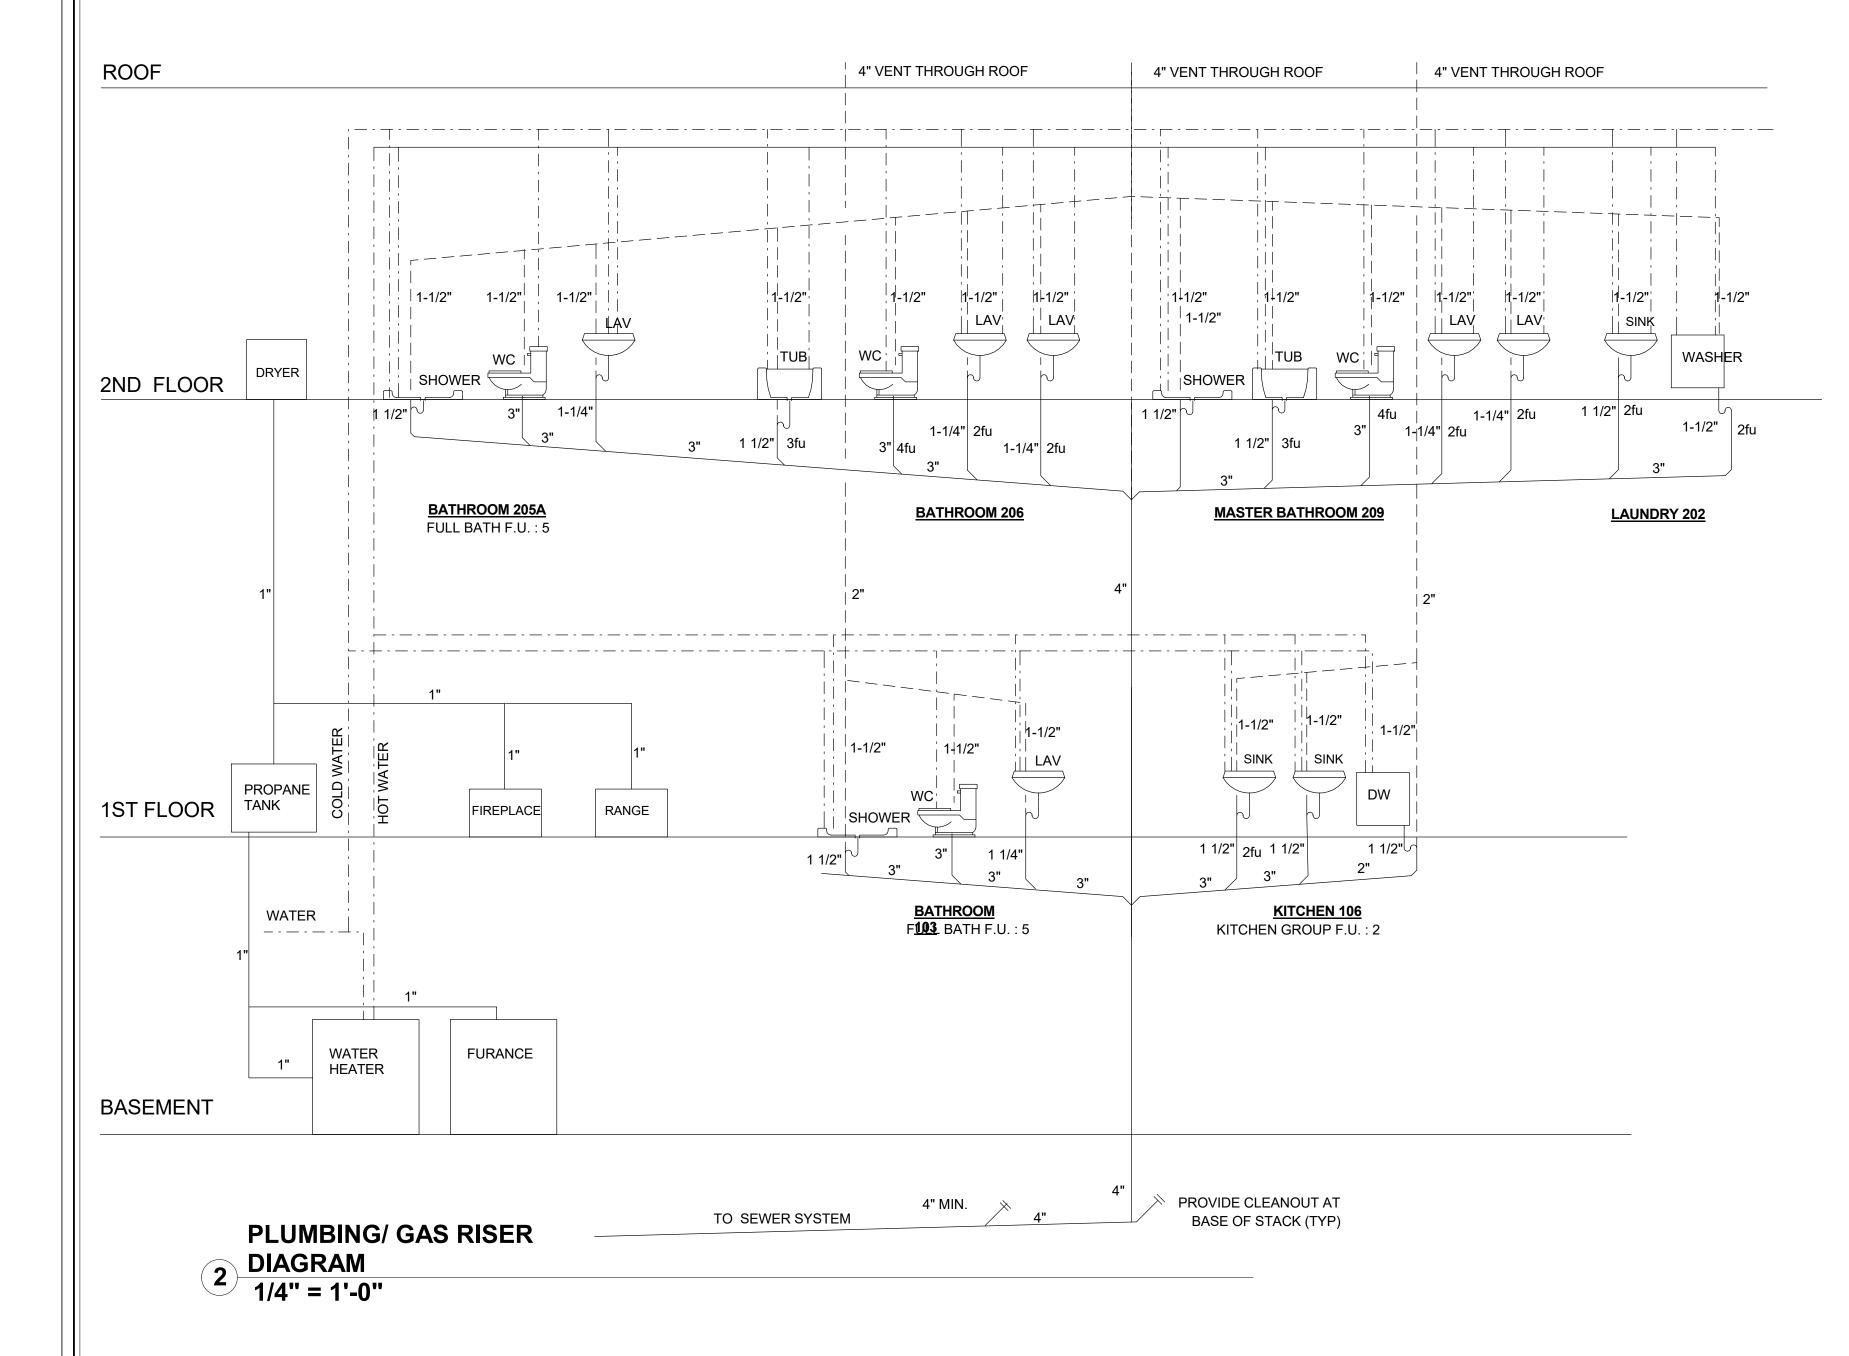

TAG	LEVEL	WIDTH	HEIGHT	OPERATION	Lock Function	COMMENTS
1710	LL V LL	VVIDITI	HEIGHT	OI EIVITOIV	EGOK I GITOGOTI	JONNIE I I I
001	BASEMENT FLOOR	3' - 0"	7' - 0"			
100	GARAGE	9' - 0"	8' - 0"	OVERHEAD GARAGE		
101	GARAGE	9' - 0"	8' - 0"	OVERHEAD GARAGE		
102	FIRST FLOOR	5' - 0"	7' - 0"	DOUBLE SWING	PRIVACY	
105	FIRST FLOOR	2' - 6"	7' - 0"	SWING	DUMMY	
106	FIRST FLOOR	2' - 6"	7' - 0"	SWING	DUMMY	
107	FIRST FLOOR	2' - 6"	7' - 0"	SWING	PASSAGE	
108	FIRST FLOOR	2' - 6"	7' - 0"	SWING	ENTRY	C LABEL W/ SELF CLOSING HINGE
109	FIRST FLOOR	10' - 0"	7' - 0"	TRIMMED OPENING	TRIMMED OPENING	
110	FIRST FLOOR	2' - 6"	7' - 0"	SWING	PASSAGE	
111	FIRST FLOOR	4' - 8"	7' - 0"	TRIMMED OPENING	TRIMMED OPENING	
113	FIRST FLOOR	2' - 6"	7' - 0"	SWING	DUMMY	
114	FIRST FLOOR	2' - 6"	7' - 0"	SWING	PRIVACY	
115	FIRST FLOOR	3' - 6"	7' - 0"	SWING	ENTRY	ENTRY SYSTEM
116	FIRST FLOOR	1' - 4"	7' - 0"	SIDE LITE		
117	FIRST FLOOR	1' - 4"	7' - 0"	SIDE LITE		
200	SECOND FLOOR	2' - 8"	6' - 8"	SWING	PASSAGE	
202	SECOND FLOOR	2' - 6"	6' - 8"	SWING	PRIVACY	
203	SECOND FLOOR	2' - 6"	6' - 8"	SWING	PRIVACY	
204	SECOND FLOOR	2' - 6"	6' - 8"	SWING	PRIVACY	
205	SECOND FLOOR	2' - 6"	6' - 8"	SWING	PRIVACY	
207	SECOND FLOOR	2' - 6"	6' - 8"	SWING	PRIVACY	
208	SECOND FLOOR	2' - 6"	6' - 8"	POCKET	PRIVACY	
209	SECOND FLOOR	2' - 6"	6' - 8"	POCKET	PASSAGE	
210	SECOND FLOOR	2' - 6"	6' - 8"	POCKET	PASSAGE	
211	SECOND FLOOR	3' - 0"	6' - 8"	TRIMMED OPENING		
212	SECOND FLOOR	2' - 6"	6' - 8"	SWING	DUMMY	
213	SECOND FLOOR	2' - 6"	6' - 8"	SWING	PRIVACY	
214	SECOND FLOOR	2' - 6"	6' - 8"	SWING	DUMMY	
215	SECOND FLOOR	2' - 6"	6' - 8"	SWING	PRIVACY	
216	SECOND FLOOR	2' - 6"	6' - 8"	SWING	PRIVACY	
217	SECOND FLOOR	2' - 6"	6' - 8"	SWING	PRIVACY	
218	SECOND FLOOR	5' - 8"	6' - 8"	SLIDING CLOSET	DUMMY	
219	SECOND FLOOR	2' - 0"	6' - 8"	SWING	DUMMY	
220	SECOND FLOOR	2' - 6"	6' - 8"	SWING	PASSAGE	

²DOORS SHALL BE MANUFACTURED BY TRUSTILE WITH THE FOLLOWING SPECIFICATIONS

- DOOR CONSTRUCTION:
- 1. 1 3/4" thick solid coar Medium Density Fiberboard (MDF), stile and rail, continuously laminated construction, sizes as noted on Door Schedule, flush panel, factory primed.
- All core materials should make door achieve STC 32 or greater to minimize sound transmission.
- Doors to have a hardwood keyed woodedge down the full length of each stile.

 Exposed woodedges that are not interlocking into door edge are not acceptable.

 Pocket/Slider doors are to be ordered with top wood edges in addition to the side keyed or

concealed wood edges

INTERIOR DOORS SHALL BE TS2020, 1 3/4" THICK, RAISED PANEL, ROMAN OGEE STICKING -DOOR 110 AND 130 SHALL BE PL134, WITH CLEAR, INSULATED GLASS. -DOORS 104 AND 105 SHALL BE PL100, WITH FROSTED GLASS GLASS. -ALL DOORS SHALL BE PAINT GRADE MDF

-POCKET DOORS SHALL HAVE A POCKET STILE AND POCKET TOP RAIL -PROVIDE POCKET DOOR HARDWARE HAWA JUNIOR 80/B MANUFACTURED BY HAFELE



DO NOT SCALE DRAWINGS. REFER TO WRITTEN
MEASUREMENTS FOR ACCURANCY, OR CONTACT ARCHITECT. CONTACT ARCHITECT IF THERE ARE ANY DISCECPENCIES. DRAWING IS A VIOLATION OF NEW YORK STATE EDUCATION

© Copyright 2020 MICHAEL PICCIRILLO ARCHITECTURE

No. DATE: 1 2/28/22 ISSUED

> PROJECT NAME: SINGLE FAMILY HOUSE

PROJECT ADDRESS: 25 ORCHARD DRIVE ARMONK, NY



MICHAEL A PICCIRILLO, AIA

345 KEAR STREET YORKTOWN HEIGHTS, NEW YORK

> TELEPHONE: 914-368-9838 FACSIMILE: 914-368-9839 michael@mpiccirilloarchitect.com www.mpiccirilloarchitect.com


DETAIL/ SCHEDULES

Issue Date As indicated Drawn by Author A400 Checked by Checker

Project number

ALL ROOMS (EXCEPT NON WALK IN CLOSETS)

- INSTALLED SO THAT NO POINT MEASURED HORIZONTALLY ALONG THE FLOOR IS LINE IN ANY WALL SPACE I IS MORE THAN 6' FROM A RECEPTACLE.
- 3. AT COUNTERTOPS, INSTALLED SO THAT NO POINT ALONG THE WALL THE WALL LINE IS MORE THAN 24", MEASURED HORIZONTALLY FROM A RECEPTACLE.
- PROVIDE 2 RECEPTACLES AT KITCHEN ISLAND
- IN BATHROOM PROVIDE GFCI RECEPTACLE AT VANITIES. 2 OUTLETS AT (2) SINKS, ONE RECEPTACLE AT SINGLE SINK.
- APPLIANCE RECEPTACLE SHALL BE WITHIN 6' OF APPLIANCE. PROVIDE ONE EXTERIOR GFCI RECEPTACLE AT FRONT AND BACK OF HOUSE.
- PROVIDE MIN. 1 RECEPTACLE IN HALLSWAY 10' OR MORE. PROVIDE RECEPTACLE FOR APPLIANCES IN LAUNDRY ROOM.
- PROVIDE MIN. 1 GFCI RECEPTACLE IN GARAGE.
- PROVIDE MIN. 1 WALL SWITCHED LIGHTING OUTLET IN EACH HABITABLE ROOM AND BATHROOM, HALLWAY, STAIRWAY, GARAGE, STORAGE, AND UTILITY SPACES
- DECORATIVE LIGHT FIXTURE IF SWITCH AND OUTLET ARE GROUPED THEN GANG TOGETHER IF OUTLET IS WITHOUT SWITCH LOCATE WITHIN BACKSPLASH - OUTLET MOUNTED - OUTLET MOUNTED VERTICALLY HORIZONTALLY IN BASE WHERE THERE IS NO BASE MOULDING B-2 MOULDING, BEHIND OUTLET MOUNTED APPLIANCES. EXTERIOR. HORIZONTALLY IN BASE

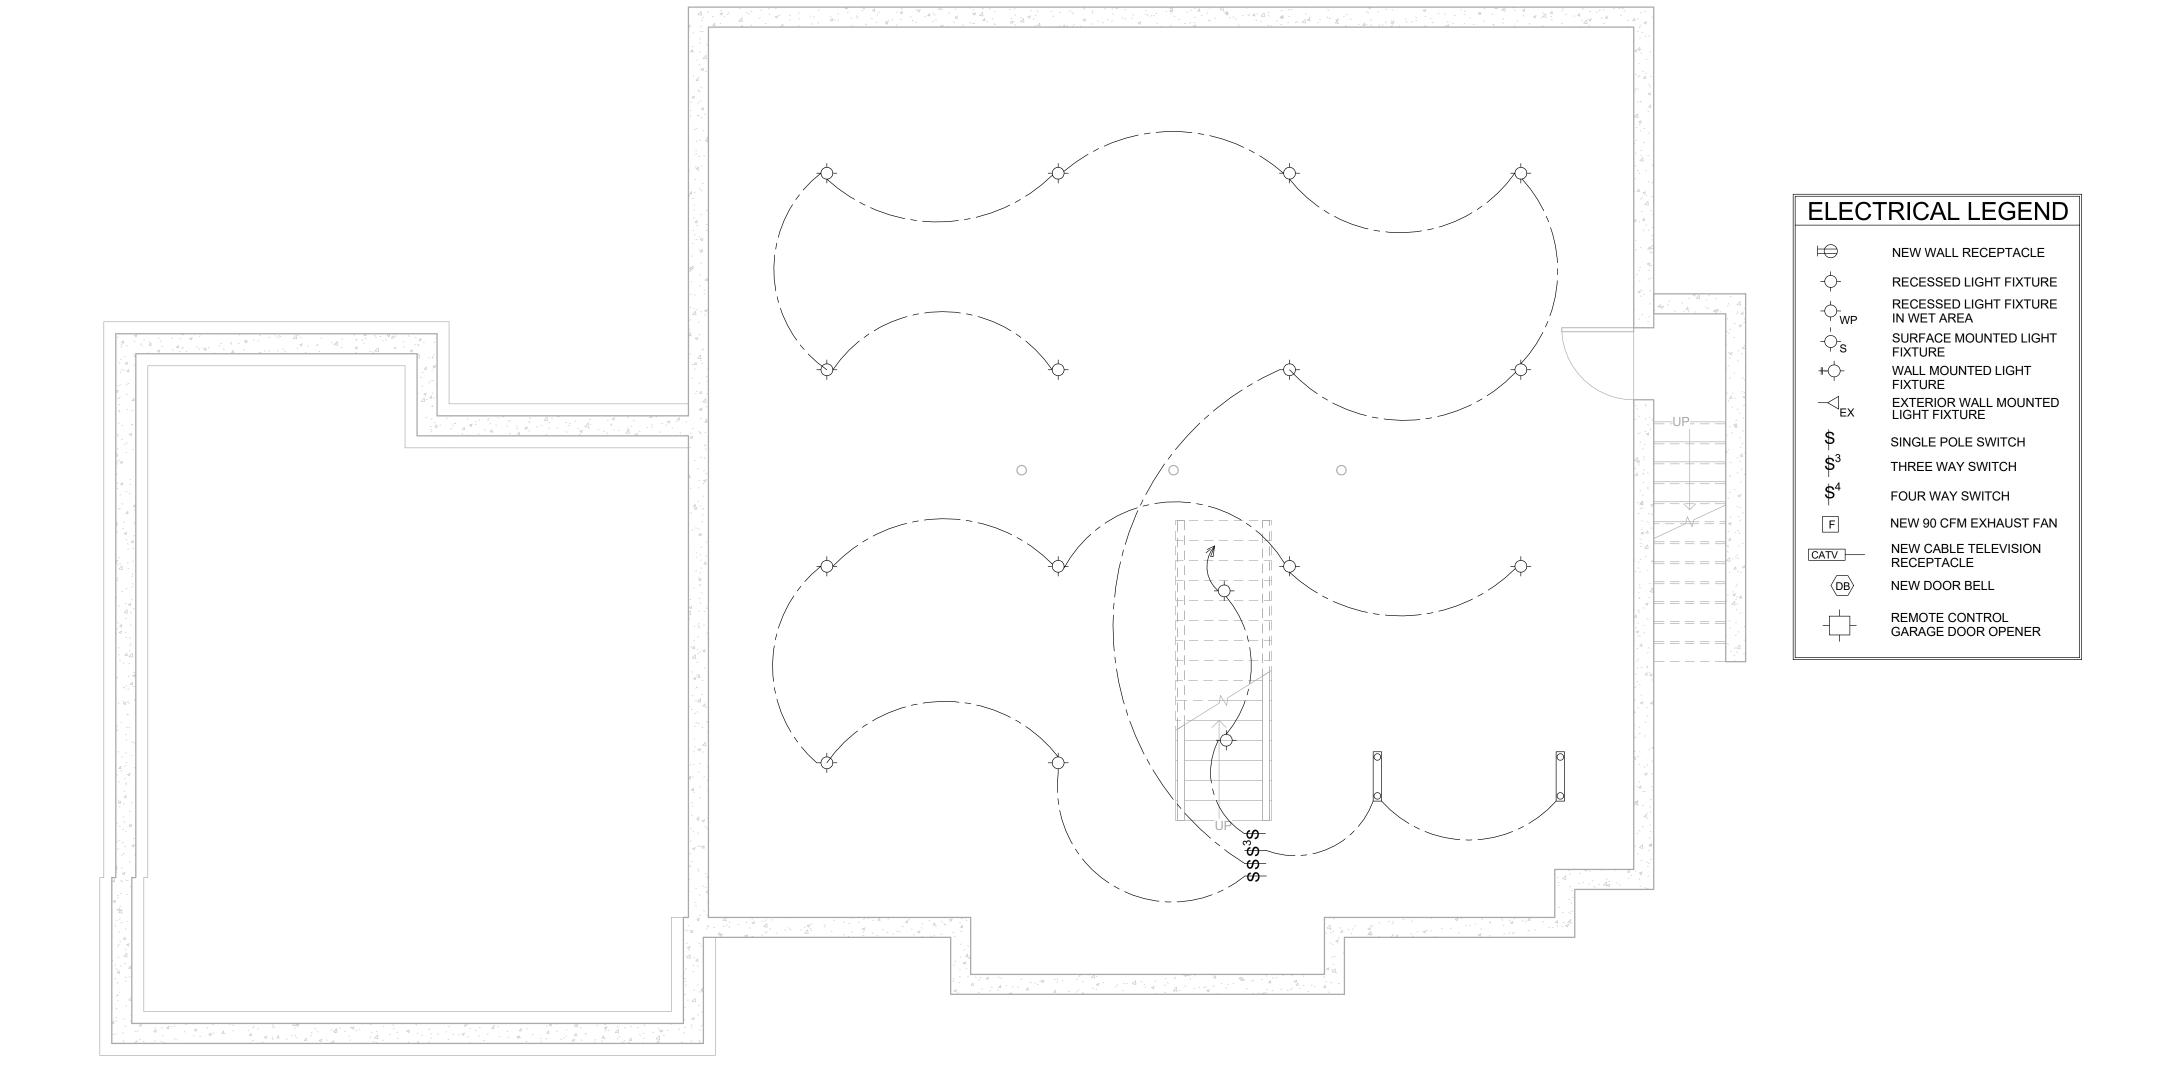

BASEMENT ELECTRICAL

1 PLAN 1/4" = 1'-0"

DIVISION 16 ELECTRICAL

General Requirements: G.C. shall provide and install all labor, materials, and equipment necessary to install wiring, related fixtures and control at existing house, new addition and alterations. Subcontractor shall coordinate work with all other

NOTE: PRIOR TO COMMENCING ANY WORK UNDER THIS SECTION THE GENERAL CONTRACTOR SHALL ARRANGE A SITE MEETING WITH THE ELECTRICAL SUB-CONTRACTOR, THE ARCHITECT AND THE OWNER. A COMPLETE WALK-THRU SHALL TAKE PLACE TO REVIEW SWITCHING, LIGHTING ETC. ON A ROOM-BY-ROOM BASIS. THIS SHALL BE DONE WELL ENOUGH IN ADVANCE OF THE WORK TO ALLOW FOR CHANGES TO MATERIAL ORDERS.

A. SCOPE OF WORK:

1. Provide 200-ampere underground service.

- 2. Intent is to provide a complete and proper system of electric wiring, conforming to the latest edition of the National Electric Code. At completion, furnish Certificate of Inspection of National Board of Fire Underwriters.
- 3. G.C. shall obtain all required permits, inspections, and underwriter approvals, certificates, etc., and all items necessary for the completion of the work specified under this Section.
- 4. THE GENERAL CONTRACTOR SHALL PROVIDE ALL **ELECTRICAL SERVICE EQUIPMENT REQUIRED BY THE** POWER COMPANYuding, but not limited to, C.T. closets, meters, transformers, primary and secondary lines, etc.
- 5. Wire for and connect all power equipment including but not limited to the following: Lighting fixture, appliances, receptacles, HVAC equipment, exhaust fans, heat and smoke detectors, Etc.
- 6. Provide outlet boxes, receptacles, switches, plates, and connections to equipment and appliances herein specified.
- 7. Provide all disconnects and switches for generator.
- 8. Provide and install all recessed light fixtures as shown on drawing; trim kit color and style to be selected, submit catalog cut for approval.
- 9. Provide I.C. housings where required.
- 10. Provide proper housings, lenses, etc. at wet locations.
- 11. Provide dimmer units as indicated on electrical drawings. Dimmers shall be slide type w/preset.
- 12. Provide and install door chime at main entry foyer door, with push buttons at both main entry and Mudroom door.
- 13. Provide 4 exterior spot lights. Location to be determined in field with owner
- 14. Provide and install all automatic garage door openers.
- 14.1. Openers shall be 3/4 HP, BELT DRIVE TYPE. Light shall turn on during garage door operation. Submit catalog cut to architect for approval. Provide exterior and internal keypad for each door.
- 15. Provide smoke detectors, heat detectors, and carbon monoxide detectors per code and as indicated on plans.
- 15.1. The smoke detectors shall be a part of the electrical system and be hard wired (line voltage) and interconnected such that if one unit is activated, all units will sound.

B. Submittals

1. Submit 1 switch, dimmer, receptacle, and cover plate of each type to be used, to the Architect for approval prior to

purchasing. C. MATERIALS

- 1. Circuits shall be BX or Romex cable installed according to Underwriter's Code. Wire for maximum voltage drop of 2 percent, but no wire to be smaller than #12. Circuits designed for 15-ampere load but sufficient in number so that initial load shall not exceed 1000 Watts.
- 2. Smoke detectors, heat detectors, and carbon monoxide detectors shall be manufactured by Simplex or equal.
- 3. Switches shall be paddle type, quiet type by leviton or equal, color to be selected.
- 4. Dimmers to be lutron divi or equal, color to be selected.
- Receptacles shall be leviton decora line or equal duplex grounded, color to be selected. height to be as shown or as directed by architect or shown on plans. special receptacles for equipment as shown on the drawings. exterior receptacles shall be waterproof type with gasketed spring covers equal to the leviton
- 6. Undercabinet lights shall be loox led 3006, manufactured by hafele Under counter power strip shall be wiremold plugmold, hardwired
- **8. RECESSED LIGHTING FIXTURES** shall be lightolier lytcaster led 4" dia. round recessed fixtures, 1000 lumens, 3500k, with clear
- 8.1. Provide sloped frame in kit for sloped ceilings.
- For wet locations provide appropriate trim

D. Execution

- 1. Obtain all required permits, pay all fees required, and provide all necessary temporary light and power during construction. All work shall be in strict compliance with governing codes and requirements.
- 2. Furnish the Owner with all required certificates upon completion of work. The entire system shall be properly grounded. Circuiting shall be provided as required to all switches, light fixtures, receptacles, appliances, equipment, etc. shown on the plans or specified herein.
- Provide any and all outlets required by codes not shown on plans. Wire size to be minimum #12, larger where required, with ground. Number of outlets per circuit as required by Code (BOCA) (NEC). Separate equipment circuits as required by Code. Provide for all outlets and switches, etc. as called for on drawings. Gang devices as shown on drawings.



Michael Piccirillo Architecture

DO NOT SCALE DRAWINGS. REFER TO WRITTEN
MEASUREMENTS FOR ACCURANCY, OR CONTACT ARCHITECT.

CONTACT ARCHITECT IF THERE ARE ANY DISCECPENCIES.

DRAWING IS A VIOLATION OF NEW YORK STATE EDUCATION

© Copyright 2020 MICHAEL PICCIRILLO ARCHITECTURE

1 2/28/22 ISSUED

PROJECT NAME: SINGLE FAMILY HOUSE

PROJECT ADDRESS: 25 ORCHARD DRIVE ARMONK, NY



MICHAEL A PICCIRILLO, AIA

345 KEAR STREET YORKTOWN HEIGHTS, NEW YORK


TELEPHONE: 914-368-9838 FACSIMILE: 914-368-9839 michael@mpiccirilloarchitect.com www.mpiccirilloarchitect.com

BASEMENT ELECTRICAL PLAN

1/4" = 1'-0" Issue Date Drawn by Author E101 Checked by Checker Project number

- ALL ROOMS (EXCEPT NON WALK IN CLOSETS).
- INSTALLED SO THAT NO POINT MEASURED HORIZONTALLY ALONG THE FLOOR IS LINE IN ANY WALL SPACE I IS MORE THAN 6' FROM A RECEPTACLE.
- AT COUNTERTOPS, INSTALLED SO THAT NO POINT ALONG THE WALL THE WALL LINE IS MORE THAN 24", MEASURED HORIZONTALLY FROM A RECEPTACLE.
- PROVIDE 2 RECEPTACLES AT KITCHEN ISLAND
- IN BATHROOM PROVIDE GFCI RECEPTACLE AT VANITIES. 2 OUTLETS AT (2) SINKS,
- ONE RECEPTACLE AT SINGLE SINK.
- PROVIDE ONE EXTERIOR GFCI RECEPTACLE AT FRONT AND BACK OF HOUSE.
- PROVIDE MIN. 1 RECEPTACLE IN HALLSWAY 10' OR MORE.
- PROVIDE MIN. 1 GFCI RECEPTACLE IN GARAGE.
- PROVIDE MIN. 1 WALL SWITCHED LIGHTING OUTLET IN EACH HABITABLE ROOM

AND BATHROOM, HALLWAY, STAIRWAY, GARAGE, STORAGE, AND UTILITY SPACES

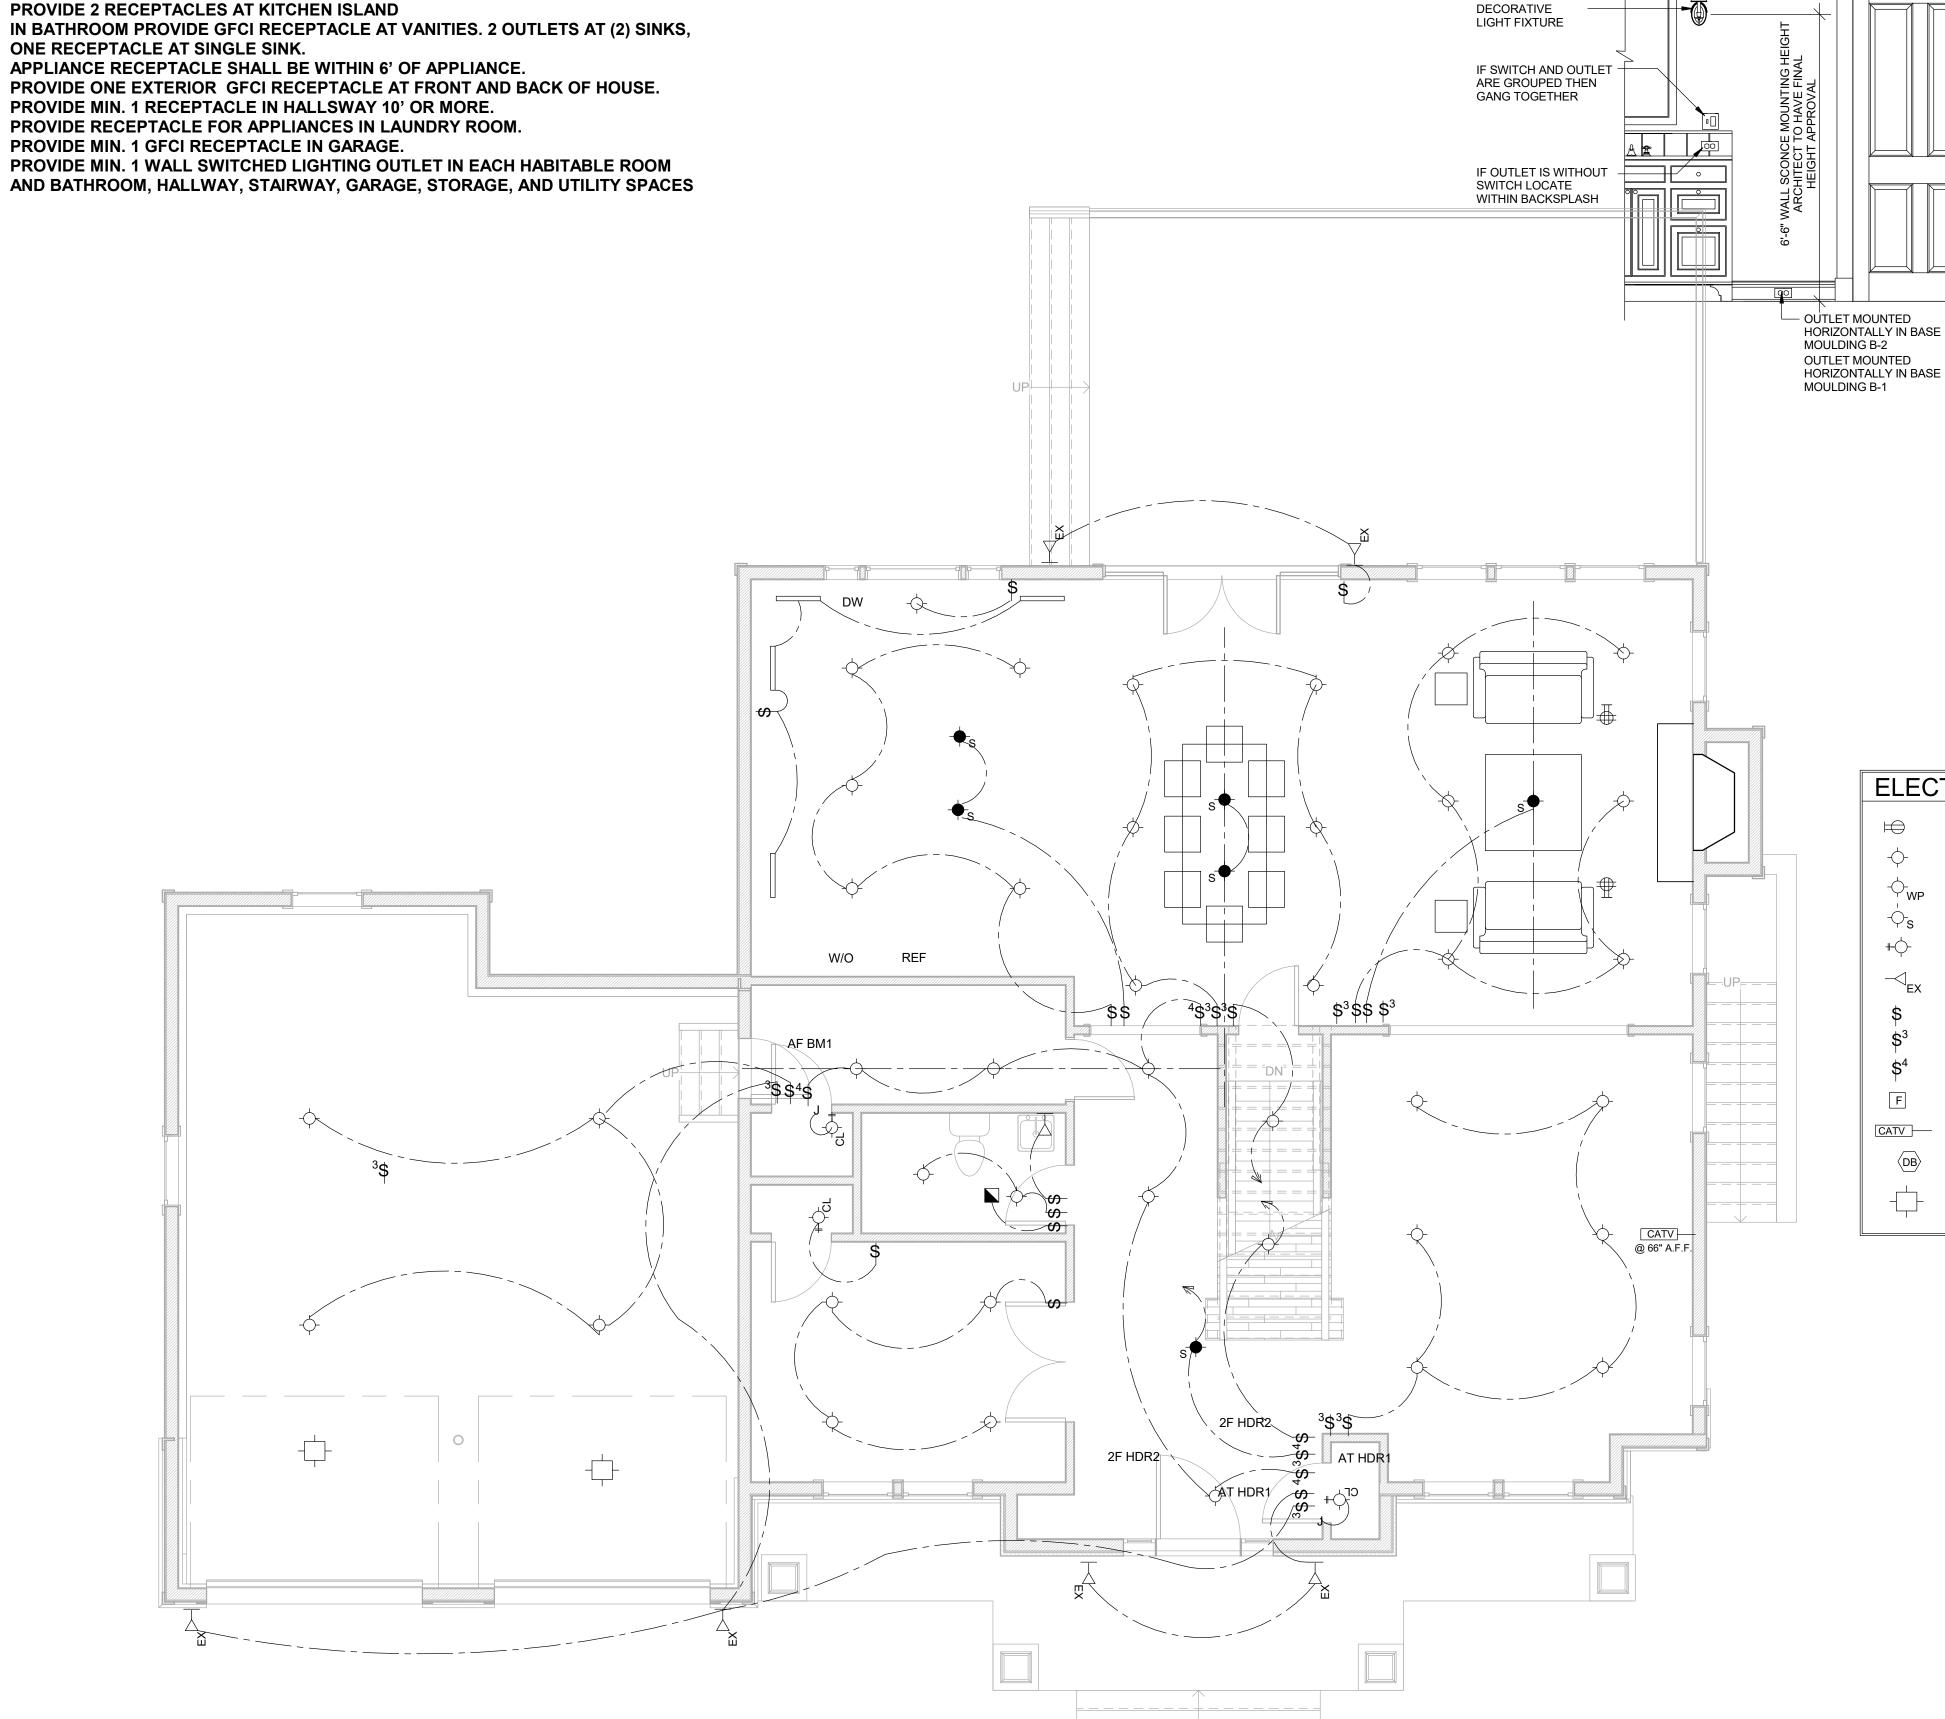

_ _ _ _ _ _ _ ____

FIRST FLOOR ELECTRICAL PLAN 1/4" = 1'-0"

DIVISION 16 ELECTRICAL

General Requirements: G.C. shall provide and install all labor, materials, and equipment necessary to install wiring, related fixtures and control at existing house, new addition and alterations. Subcontractor shall coordinate work with all other

NOTE: PRIOR TO COMMENCING ANY WORK UNDER THIS SECTION THE GENERAL CONTRACTOR SHALL ARRANGE A SITE MEETING WITH THE ELECTRICAL SUB-CONTRACTOR, THE ARCHITECT AND THE OWNER. A COMPLETE WALK-THRU SHALL TAKE PLACE TO REVIEW SWITCHING, LIGHTING ETC. ON A ROOM-BY-ROOM BASIS. THIS SHALL BE DONE WELL ENOUGH IN ADVANCE OF THE WORK TO ALLOW FOR CHANGES TO MATERIAL ORDERS.

A. SCOPE OF WORK:

- OUTLET MOUNTED VERTICALLY

WHERE THERE IS NO BASE

APPLIANCES. EXTERIOR.

MOULDING, BEHIND

ELECTRICAL LEGEND

IN WET AREA

FIXTURE

FIXTURE

NEW WALL RECEPTACLE

RECESSED LIGHT FIXTURE

RECESSED LIGHT FIXTURE

SURFACE MOUNTED LIGHT

EXTERIOR WALL MOUNTED

NEW 90 CFM EXHAUST FAN

NEW CABLE TELEVISION RECEPTACLE

GARAGE DOOR OPENER

WALL MOUNTED LIGHT

SINGLE POLE SWITCH

THREE WAY SWITCH

FOUR WAY SWITCH

NEW DOOR BELL

REMOTE CONTROL

 \bowtie

 $\neg \neg_s$

CATV

DB

1. Provide 200-ampere underground service.

- 2. Intent is to provide a complete and proper system of electric wiring, conforming to the latest edition of the National Electric Code. At completion, furnish Certificate of Inspection of National Board of Fire Underwriters.
- 3. G.C. shall obtain all required permits, inspections, and underwriter approvals, certificates, etc., and all items necessary for the completion of the work specified under this Section.
- 4. THE GENERAL CONTRACTOR SHALL PROVIDE ALL **ELECTRICAL SERVICE EQUIPMENT REQUIRED BY THE** POWER COMPANYuding, but not limited to, C.T. closets, meters, transformers, primary and secondary lines, etc.
- 5. Wire for and connect all power equipment including but not limited to the following: Lighting fixture, appliances, receptacles, HVAC equipment, exhaust fans, heat and smoke detectors, Etc.
- 6. Provide outlet boxes, receptacles, switches, plates, and connections to equipment and appliances herein specified.
- 7. Provide all disconnects and switches for generator.
- 8. Provide and install all recessed light fixtures as shown on drawing; trim kit color and style to be selected, submit catalog cut for approval.
- 9. Provide I.C. housings where required.
- 10. Provide proper housings, lenses, etc. at wet locations.
- 11. Provide dimmer units as indicated on electrical drawings. Dimmers shall be slide type w/preset.
- 12. Provide and install door chime at main entry foyer door, with push buttons at both main entry and Mudroom door.
- 13. Provide 4 exterior spot lights. Location to be determined in field with owner
- 14. Provide and install all automatic garage door openers. 14.1. Openers shall be 3/4 HP, BELT DRIVE TYPE. Light shall
 - turn on during garage door operation. Submit catalog cut to architect for approval. Provide exterior and internal keypad for each door.
- 15. Provide smoke detectors, heat detectors, and carbon monoxide detectors per code and as indicated on plans.
- 15.1. The smoke detectors shall be a part of the electrical system and be hard wired (line voltage) and interconnected such that if one unit is activated, all units will sound.

B. Submittals

1. Submit 1 switch, dimmer, receptacle, and cover plate of each type to be used, to the Architect for approval prior to

purchasing. C. MATERIALS

- 1. Circuits shall be BX or Romex cable installed according to Underwriter's Code. Wire for maximum voltage drop of 2 percent, but no wire to be smaller than #12. Circuits designed for 15-ampere load but sufficient in number so that initial load shall not exceed 1000 Watts.
- 2. Smoke detectors, heat detectors, and carbon monoxide detectors shall be manufactured by Simplex or equal.
- 3. Switches shall be paddle type, quiet type by leviton or equal, color to be selected.
- 4. Dimmers to be lutron divi or equal, color to be selected.
- Receptacles shall be leviton decora line or equal duplex grounded, color to be selected. height to be as shown or as directed by architect or shown on plans. special receptacles for equipment as shown on the drawings. exterior receptacles shall be waterproof type with gasketed spring covers equal to the leviton
- 6. Undercabinet lights shall be loox led 3006, manufactured by hafele Under counter power strip shall be wiremold plugmold, hardwired
- **8. RECESSED LIGHTING FIXTURES** shall be lightolier lytcaster led 4" dia. round recessed fixtures, 1000 lumens, 3500k, with clear
- Provide sloped frame in kit for sloped ceilings.

For wet locations provide appropriate trim

D. Execution

- 1. Obtain all required permits, pay all fees required, and provide all necessary temporary light and power during construction. All work shall be in strict compliance with governing codes and requirements.
- 2. Furnish the Owner with all required certificates upon completion of work. The entire system shall be properly grounded. Circuiting shall be provided as required to all switches, light fixtures, receptacles, appliances, equipment, etc. shown on the plans or specified herein.
- Provide any and all outlets required by codes not shown on plans. Wire size to be minimum #12, larger where required, with ground. Number of outlets per circuit as required by Code (BOCA) (NEC). Separate equipment circuits as required by Code. Provide for all outlets and switches, etc. as called for on drawings. Gang devices as shown on drawings.



Michael Piccirillo Architecture

DO NOT SCALE DRAWINGS. REFER TO WRITTEN
MEASUREMENTS FOR ACCURANCY, OR CONTACT ARCHITECT.

CONTACT ARCHITECT IF THERE ARE ANY DISCECPENCIES.

DRAWING IS A VIOLATION OF NEW YORK STATE EDUCATION

© Copyright 2020 MICHAEL PICCIRILLO ARCHITECTURE

1 2/28/22 ISSUED

PROJECT NAME: SINGLE FAMILY HOUSE

PROJECT ADDRESS: 25 ORCHARD DRIVE ARMONK, NY



MICHAEL A PICCIRILLO, AIA


345 KEAR STREET YORKTOWN HEIGHTS, NEW YORK


TELEPHONE: 914-368-9838 FACSIMILE: 914-368-9839 michael@mpiccirilloarchitect.com www.mpiccirilloarchitect.com

1ST FLOOR ELECTRICAL PLAN

1/4" = 1'-0" Issue Date Drawn by Author E102 Checked by Checker Project number

- ALL ROOMS (EXCEPT NON WALK IN CLOSETS).
- INSTALLED SO THAT NO POINT MEASURED HORIZONTALLY ALONG THE FLOOR IS
- LINE IN ANY WALL SPACE I IS MORE THAN 6' FROM A RECEPTACLE. AT COUNTERTOPS, INSTALLED SO THAT NO POINT ALONG THE WALL THE WALL
- LINE IS MORE THAN 24", MEASURED HORIZONTALLY FROM A RECEPTACLE. PROVIDE 2 RECEPTACLES AT KITCHEN ISLAND
- IN BATHROOM PROVIDE GFCI RECEPTACLE AT VANITIES. 2 OUTLETS AT (2) SINKS,
- ONE RECEPTACLE AT SINGLE SINK.
- APPLIANCE RECEPTACLE SHALL BE WITHIN 6' OF APPLIANCE. PROVIDE ONE EXTERIOR GFCI RECEPTACLE AT FRONT AND BACK OF HOUSE.
- PROVIDE MIN. 1 RECEPTACLE IN HALLSWAY 10' OR MORE.
- PROVIDE RECEPTACLE FOR APPLIANCES IN LAUNDRY ROOM.
- PROVIDE MIN. 1 GFCI RECEPTACLE IN GARAGE.
- PROVIDE MIN. 1 WALL SWITCHED LIGHTING OUTLET IN EACH HABITABLE ROOM AND BATHROOM, HALLWAY, STAIRWAY, GARAGE, STORAGE, AND UTILITY SPACES

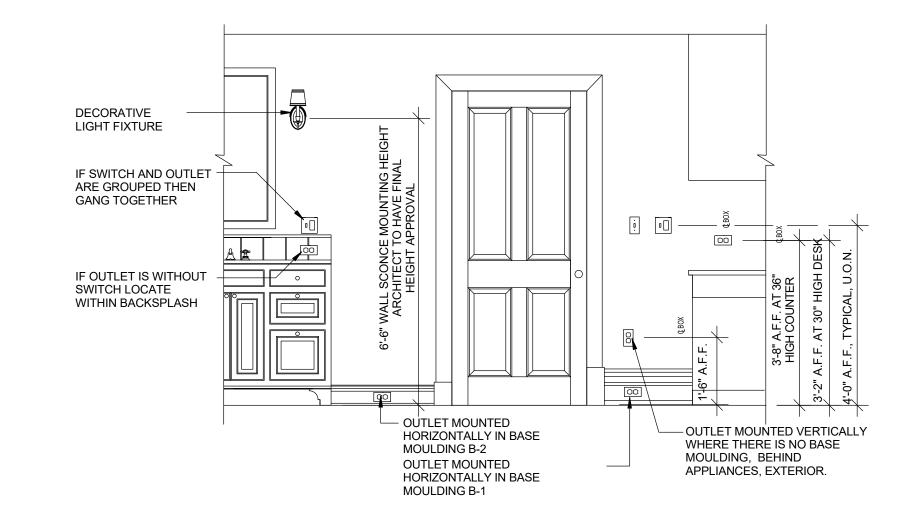

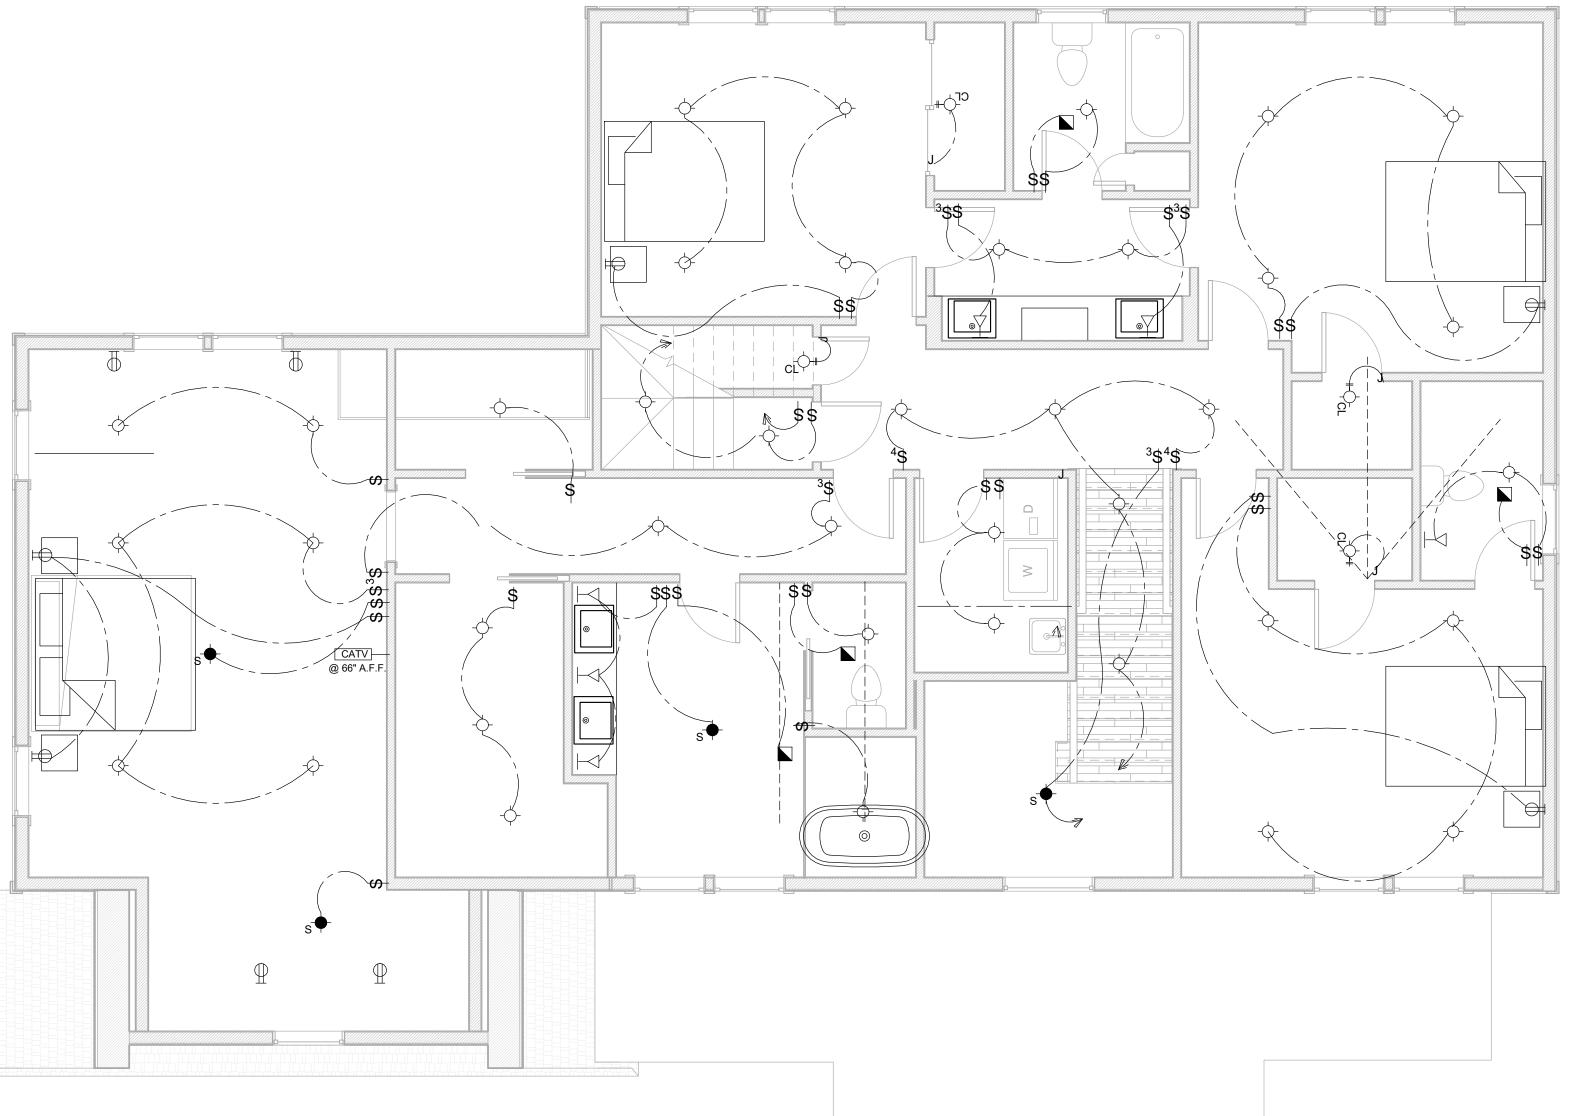

SECOND FLOOR 1 ELECTRICAL PLAN 1/4" = 1'-0"

ELECTRICAL LEGEND

 \bowtie NEW WALL RECEPTACLE RECESSED LIGHT FIXTURE RECESSED LIGHT FIXTURE IN WET AREA SURFACE MOUNTED LIGHT $\neg \neg_s$

FIXTURE WALL MOUNTED LIGHT **FIXTURE** EXTERIOR WALL MOUNTED SINGLE POLE SWITCH

THREE WAY SWITCH FOUR WAY SWITCH

NEW 90 CFM EXHAUST FAN NEW CABLE TELEVISION RECEPTACLE CATV

(DB) **NEW DOOR BELL**

REMOTE CONTROL

GARAGE DOOR OPENER

DIVISION 16 ELECTRICAL

General Requirements: G.C. shall provide and install all labor, materials, and equipment necessary to install wiring, related fixtures and control at existing house, new addition and alterations. Subcontractor shall coordinate work with all other

NOTE: PRIOR TO COMMENCING ANY WORK UNDER THIS SECTION THE GENERAL CONTRACTOR SHALL ARRANGE A SITE MEETING WITH THE ELECTRICAL SUB-CONTRACTOR, THE ARCHITECT AND THE OWNER. A COMPLETE WALK-THRU SHALL TAKE PLACE TO REVIEW SWITCHING, LIGHTING ETC. ON A ROOM-BY-ROOM BASIS. THIS SHALL BE DONE WELL ENOUGH IN ADVANCE OF THE WORK TO ALLOW FOR CHANGES TO MATERIAL ORDERS.

A. SCOPE OF WORK:

- 1. Provide 200-ampere underground service.
- 2. Intent is to provide a complete and proper system of electric wiring, conforming to the latest edition of the National Electric Code. At completion, furnish Certificate of Inspection of National Board of Fire Underwriters.
- 3. G.C. shall obtain all required permits, inspections, and underwriter approvals, certificates, etc., and all items necessary for the completion of the work specified under this Section.
- 4. THE GENERAL CONTRACTOR SHALL PROVIDE ALL **ELECTRICAL SERVICE EQUIPMENT REQUIRED BY THE** POWER COMPANYuding, but not limited to, C.T. closets, meters, transformers, primary and secondary lines, etc.
- 5. Wire for and connect all power equipment including but not limited to the following: Lighting fixture, appliances, receptacles, HVAC equipment, exhaust fans, heat and smoke detectors, Etc.
- 6. Provide outlet boxes, receptacles, switches, plates, and connections to equipment and appliances herein specified.
- 7. Provide all disconnects and switches for generator.
- 8. Provide and install all recessed light fixtures as shown on drawing; trim kit color and style to be selected, submit catalog cut for approval.
- 9. Provide I.C. housings where required.
- 10. Provide proper housings, lenses, etc. at wet locations.
- 11. Provide dimmer units as indicated on electrical drawings. Dimmers shall be slide type w/preset.
- 12. Provide and install door chime at main entry foyer door, with push buttons at both main entry and Mudroom door.
- 13. Provide 4 exterior spot lights. Location to be determined in field with owner
- 14. Provide and install all automatic garage door openers.
- 14.1. Openers shall be 3/4 HP, BELT DRIVE TYPE. Light shall turn on during garage door operation. Submit catalog cut to architect for approval. Provide exterior and internal keypad for each door.
- 15. Provide smoke detectors, heat detectors, and carbon monoxide detectors per code and as indicated on plans.
- 15.1. The smoke detectors shall be a part of the electrical system and be hard wired (line voltage) and interconnected such that if one unit is activated, all units will sound.

B. Submittals

Submit 1 switch, dimmer, receptacle, and cover plate of each type to be used, to the Architect for approval prior to

purchasing. C. MATERIALS

- 1. Circuits shall be BX or Romex cable installed according to Underwriter's Code. Wire for maximum voltage drop of 2 percent, but no wire to be smaller than #12. Circuits designed for 15-ampere load but sufficient in number so that initial load shall not exceed 1000 Watts.
- 2. Smoke detectors, heat detectors, and carbon monoxide detectors
- shall be manufactured by Simplex or equal. Switches - shall be paddle type, quiet type by leviton or equal, color to be selected.
- 4. Dimmers to be lutron divi or equal, color to be selected.
- Receptacles shall be leviton decora line or equal duplex grounded, color to be selected. height to be as shown or as directed by architect or shown on plans. special receptacles for equipment as shown on the drawings. exterior receptacles shall be waterproof type with gasketed spring covers equal to the leviton
- 6. Undercabinet lights shall be loox led 3006, manufactured by hafele Under counter power strip shall be wiremold plugmold, hardwired
- **RECESSED LIGHTING FIXTURES** shall be lightolier lytcaster led 4" dia. round recessed fixtures, 1000 lumens, 3500k, with clear
- Provide sloped frame in kit for sloped ceilings. For wet locations provide appropriate trim

D. Execution

- Obtain all required permits, pay all fees required, and provide all necessary temporary light and power during construction. All work shall be in strict compliance with governing codes and requirements.
- 2. Furnish the Owner with all required certificates upon completion of work. The entire system shall be properly grounded. Circuiting shall be provided as required to all switches, light fixtures, receptacles, appliances, equipment, etc. shown on the plans or specified herein.
- Provide any and all outlets required by codes not shown on plans. Wire size to be minimum #12, larger where required, with ground. Number of outlets per circuit as required by Code (BOCA) (NEC). Separate equipment circuits as required by Code. Provide for all outlets and switches, etc. as called for on drawings. Gang devices as shown on drawings.



DO NOT SCALE DRAWINGS. REFER TO WRITTEN
MEASUREMENTS FOR ACCURANCY, OR CONTACT ARCHITECT.

CONTACT ARCHITECT IF THERE ARE ANY DISCECPENCIES.

DRAWING IS A VIOLATION OF NEW YORK STATE EDUCATION

© Copyright 2020 MICHAEL PICCIRILLO ARCHITECTURE

1 2/28/22 ISSUED

PROJECT NAME: SINGLE FAMILY HOUSE

PROJECT ADDRESS: 25 ORCHARD DRIVE ARMONK, NY



MICHAEL A PICCIRILLO, AIA


345 KEAR STREET YORKTOWN HEIGHTS, NEW YORK


> TELEPHONE: 914-368-9838 FACSIMILE: 914-368-9839 michael@mpiccirilloarchitect.com www.mpiccirilloarchitect.com

SECOND FLOOR ELECTRICAL PLAN

1/4" = 1'-0" Issue Date Drawn by Author E103 Checked by Checker Project number

- ALL ROOMS (EXCEPT NON WALK IN CLOSETS).
- INSTALLED SO THAT NO POINT MEASURED HORIZONTALLY ALONG THE FLOOR IS LINE IN ANY WALL SPACE I IS MORE THAN 6' FROM A RECEPTACLE.
- AT COUNTERTOPS, INSTALLED SO THAT NO POINT ALONG THE WALL THE WALL
- LINE IS MORE THAN 24", MEASURED HORIZONTALLY FROM A RECEPTACLE.
- PROVIDE 2 RECEPTACLES AT KITCHEN ISLAND
- IN BATHROOM PROVIDE GFCI RECEPTACLE AT VANITIES. 2 OUTLETS AT (2) SINKS,
- ONE RECEPTACLE AT SINGLE SINK.
- APPLIANCE RECEPTACLE SHALL BE WITHIN 6' OF APPLIANCE. PROVIDE ONE EXTERIOR GFCI RECEPTACLE AT FRONT AND BACK OF HOUSE.
- PROVIDE MIN. 1 RECEPTACLE IN HALLSWAY 10' OR MORE.
- PROVIDE RECEPTACLE FOR APPLIANCES IN LAUNDRY ROOM.
- PROVIDE MIN. 1 GFCI RECEPTACLE IN GARAGE.
- PROVIDE MIN. 1 WALL SWITCHED LIGHTING OUTLET IN EACH HABITABLE ROOM
- AND BATHROOM, HALLWAY, STAIRWAY, GARAGE, STORAGE, AND UTILITY SPACES

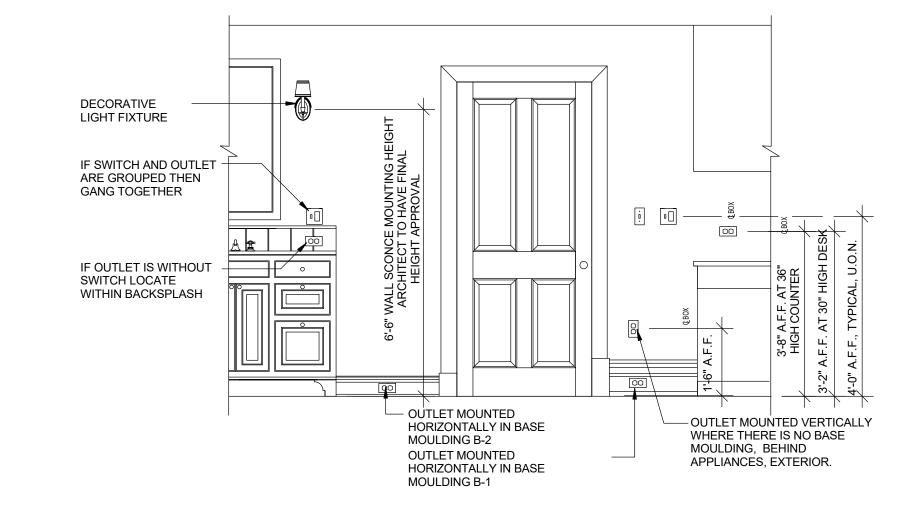

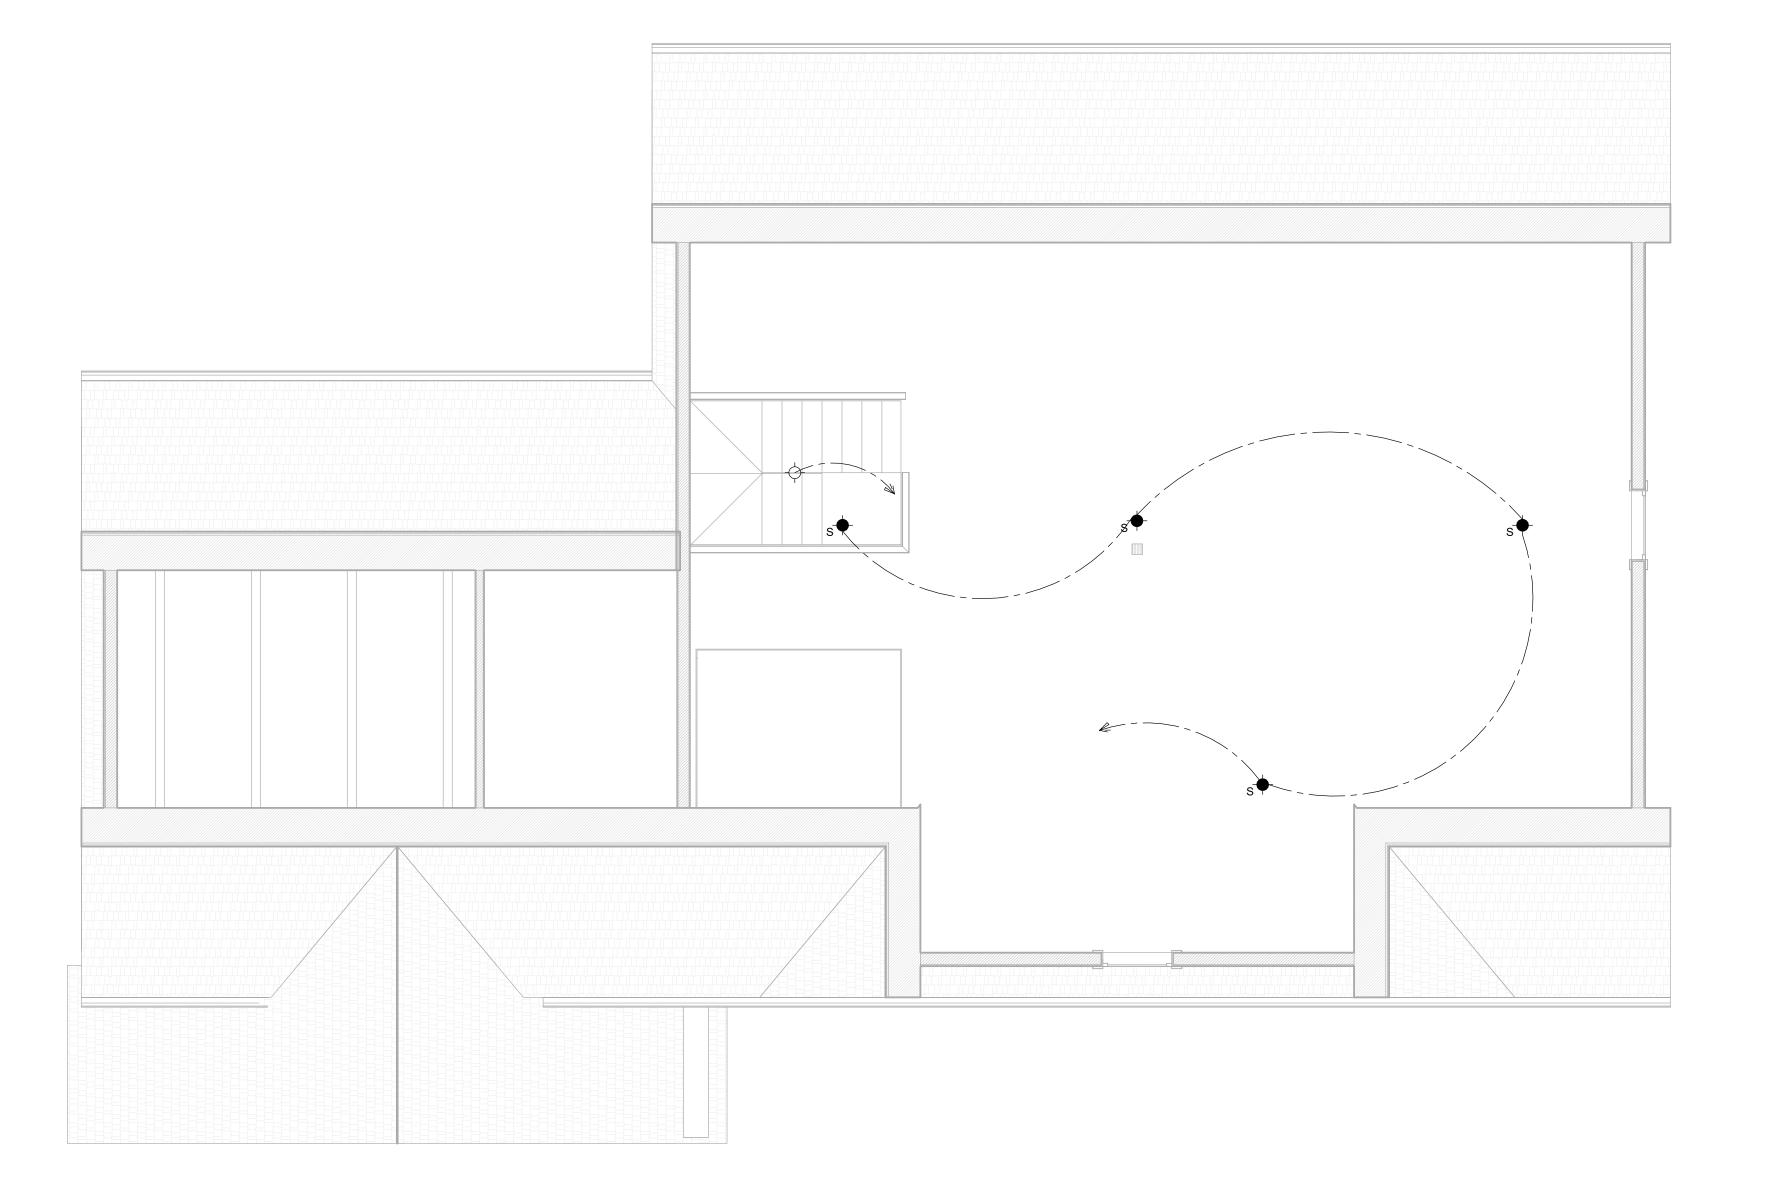

ELECTRICAL LEGEND

 \bowtie NEW WALL RECEPTACLE RECESSED LIGHT FIXTURE RECESSED LIGHT FIXTURE IN WET AREA SURFACE MOUNTED LIGHT $\neg \neg_s$ **FIXTURE** WALL MOUNTED LIGHT **FIXTURE** EXTERIOR WALL MOUNTED

SINGLE POLE SWITCH THREE WAY SWITCH FOUR WAY SWITCH

NEW 90 CFM EXHAUST FAN NEW CABLE TELEVISION RECEPTACLE CATV

(DB) NEW DOOR BELL

> REMOTE CONTROL GARAGE DOOR OPENER

DIVISION 16 ELECTRICAL

General Requirements: G.C. shall provide and install all labor, materials, and equipment necessary to install wiring, related fixtures and control at existing house, new addition and alterations. Subcontractor shall coordinate work with all other

NOTE: PRIOR TO COMMENCING ANY WORK UNDER THIS SECTION THE GENERAL CONTRACTOR SHALL ARRANGE A SITE MEETING WITH THE ELECTRICAL SUB-CONTRACTOR, THE ARCHITECT AND THE OWNER. A COMPLETE WALK-THRU SHALL TAKE PLACE TO REVIEW SWITCHING, LIGHTING ETC. ON A ROOM-BY-ROOM BASIS. THIS SHALL BE DONE WELL ENOUGH IN ADVANCE OF THE WORK TO ALLOW FOR CHANGES TO MATERIAL ORDERS.

A. SCOPE OF WORK:

- 1. Provide 200-ampere underground service.
- 2. Intent is to provide a complete and proper system of electric wiring, conforming to the latest edition of the National Electric Code. At completion, furnish Certificate of Inspection of National Board of Fire Underwriters.
- 3. G.C. shall obtain all required permits, inspections, and underwriter approvals, certificates, etc., and all items necessary for the completion of the work specified under this Section.
- 4. THE GENERAL CONTRACTOR SHALL PROVIDE ALL **ELECTRICAL SERVICE EQUIPMENT REQUIRED BY THE** POWER COMPANYuding, but not limited to, C.T. closets, meters, transformers, primary and secondary lines, etc.
- 5. Wire for and connect all power equipment including but not limited to the following: Lighting fixture, appliances, receptacles, HVAC equipment, exhaust fans, heat and smoke detectors, Etc.
- 6. Provide outlet boxes, receptacles, switches, plates, and connections to equipment and appliances herein specified.
- 7. Provide all disconnects and switches for generator.
- 8. Provide and install all recessed light fixtures as shown on drawing; trim kit color and style to be selected, submit catalog cut for approval.
- 9. Provide I.C. housings where required.
- 10. Provide proper housings, lenses, etc. at wet locations.
- 11. Provide dimmer units as indicated on electrical drawings. Dimmers shall be slide type w/preset.
- 12. Provide and install door chime at main entry foyer door, with push buttons at both main entry and Mudroom door.
- 13. Provide 4 exterior spot lights. Location to be determined in field with owner
- 14. Provide and install all automatic garage door openers.
- 14.1. Openers shall be 3/4 HP, BELT DRIVE TYPE. Light shall turn on during garage door operation. Submit catalog cut to architect for approval. Provide exterior and internal keypad for each door.
- 15. Provide smoke detectors, heat detectors, and carbon monoxide detectors per code and as indicated on plans.
- 15.1. The smoke detectors shall be a part of the electrical system and be hard wired (line voltage) and interconnected such that if one unit is activated, all units will sound.

B. Submittals

1. Submit 1 switch, dimmer, receptacle, and cover plate of each type to be used, to the Architect for approval prior to

purchasing. C. MATERIALS

- 1. Circuits shall be BX or Romex cable installed according to Underwriter's Code. Wire for maximum voltage drop of 2 percent, but no wire to be smaller than #12. Circuits designed for 15-ampere load but sufficient in number so that initial load shall not exceed 1000 Watts.
- 2. Smoke detectors, heat detectors, and carbon monoxide detectors shall be manufactured by Simplex or equal.
- 3. Switches shall be paddle type, quiet type by leviton or equal, color to be selected.
- 4. Dimmers to be lutron divi or equal, color to be selected.
- Receptacles shall be leviton decora line or equal duplex grounded, color to be selected. height to be as shown or as directed by architect or shown on plans. special receptacles for equipment as shown on the drawings. exterior receptacles shall be waterproof type with gasketed spring covers equal to the leviton
- 6. Undercabinet lights shall be loox led 3006, manufactured by hafele Under counter power strip shall be wiremold plugmold, hardwired
- 8. **RECESSED LIGHTING FIXTURES** shall be lightolier lytcaster led 4" dia. round recessed fixtures, 1000 lumens, 3500k, with clear
- 8.1. Provide sloped frame in kit for sloped ceilings. For wet locations provide appropriate trim

D. Execution

- 1. Obtain all required permits, pay all fees required, and provide all necessary temporary light and power during construction. All work shall be in strict compliance with governing codes and
- requirements. 2. Furnish the Owner with all required certificates upon completion of work. The entire system shall be properly grounded. Circuiting shall be provided as required to all switches, light fixtures, receptacles, appliances, equipment, etc. shown on the plans or specified herein.
- 3. Provide any and all outlets required by codes not shown on plans. Wire size to be minimum #12, larger where required, with ground. Number of outlets per circuit as required by Code (BOCA) (NEC). Separate equipment circuits as required by Code. Provide for all outlets and switches, etc. as called for on drawings. Gang devices as shown on drawings.



Michael Piccirillo Architecture

DO NOT SCALE DRAWINGS. REFER TO WRITTEN
MEASUREMENTS FOR ACCURANCY, OR CONTACT ARCHITECT.

CONTACT ARCHITECT IF THERE ARE ANY DISCECPENCIES.

DRAWING IS A VIOLATION OF NEW YORK STATE EDUCATION

© Copyright 2020 MICHAEL PICCIRILLO ARCHITECTURE

1 2/28/22 ISSUED

PROJECT NAME: SINGLE FAMILY HOUSE

PROJECT ADDRESS: 25 ORCHARD DRIVE ARMONK, NY



MICHAEL A PICCIRILLO, AIA

345 KEAR STREET YORKTOWN HEIGHTS, NEW YORK


TELEPHONE: 914-368-9838 FACSIMILE: 914-368-9839 michael@mpiccirilloarchitect.com www.mpiccirilloarchitect.com

ATTIC ELECTRICAL PLAN

Issue Date

cale 1/4" = 1'-0"	Date
rawn by	
uthor	
hecked by	- 1
necker	

Project number

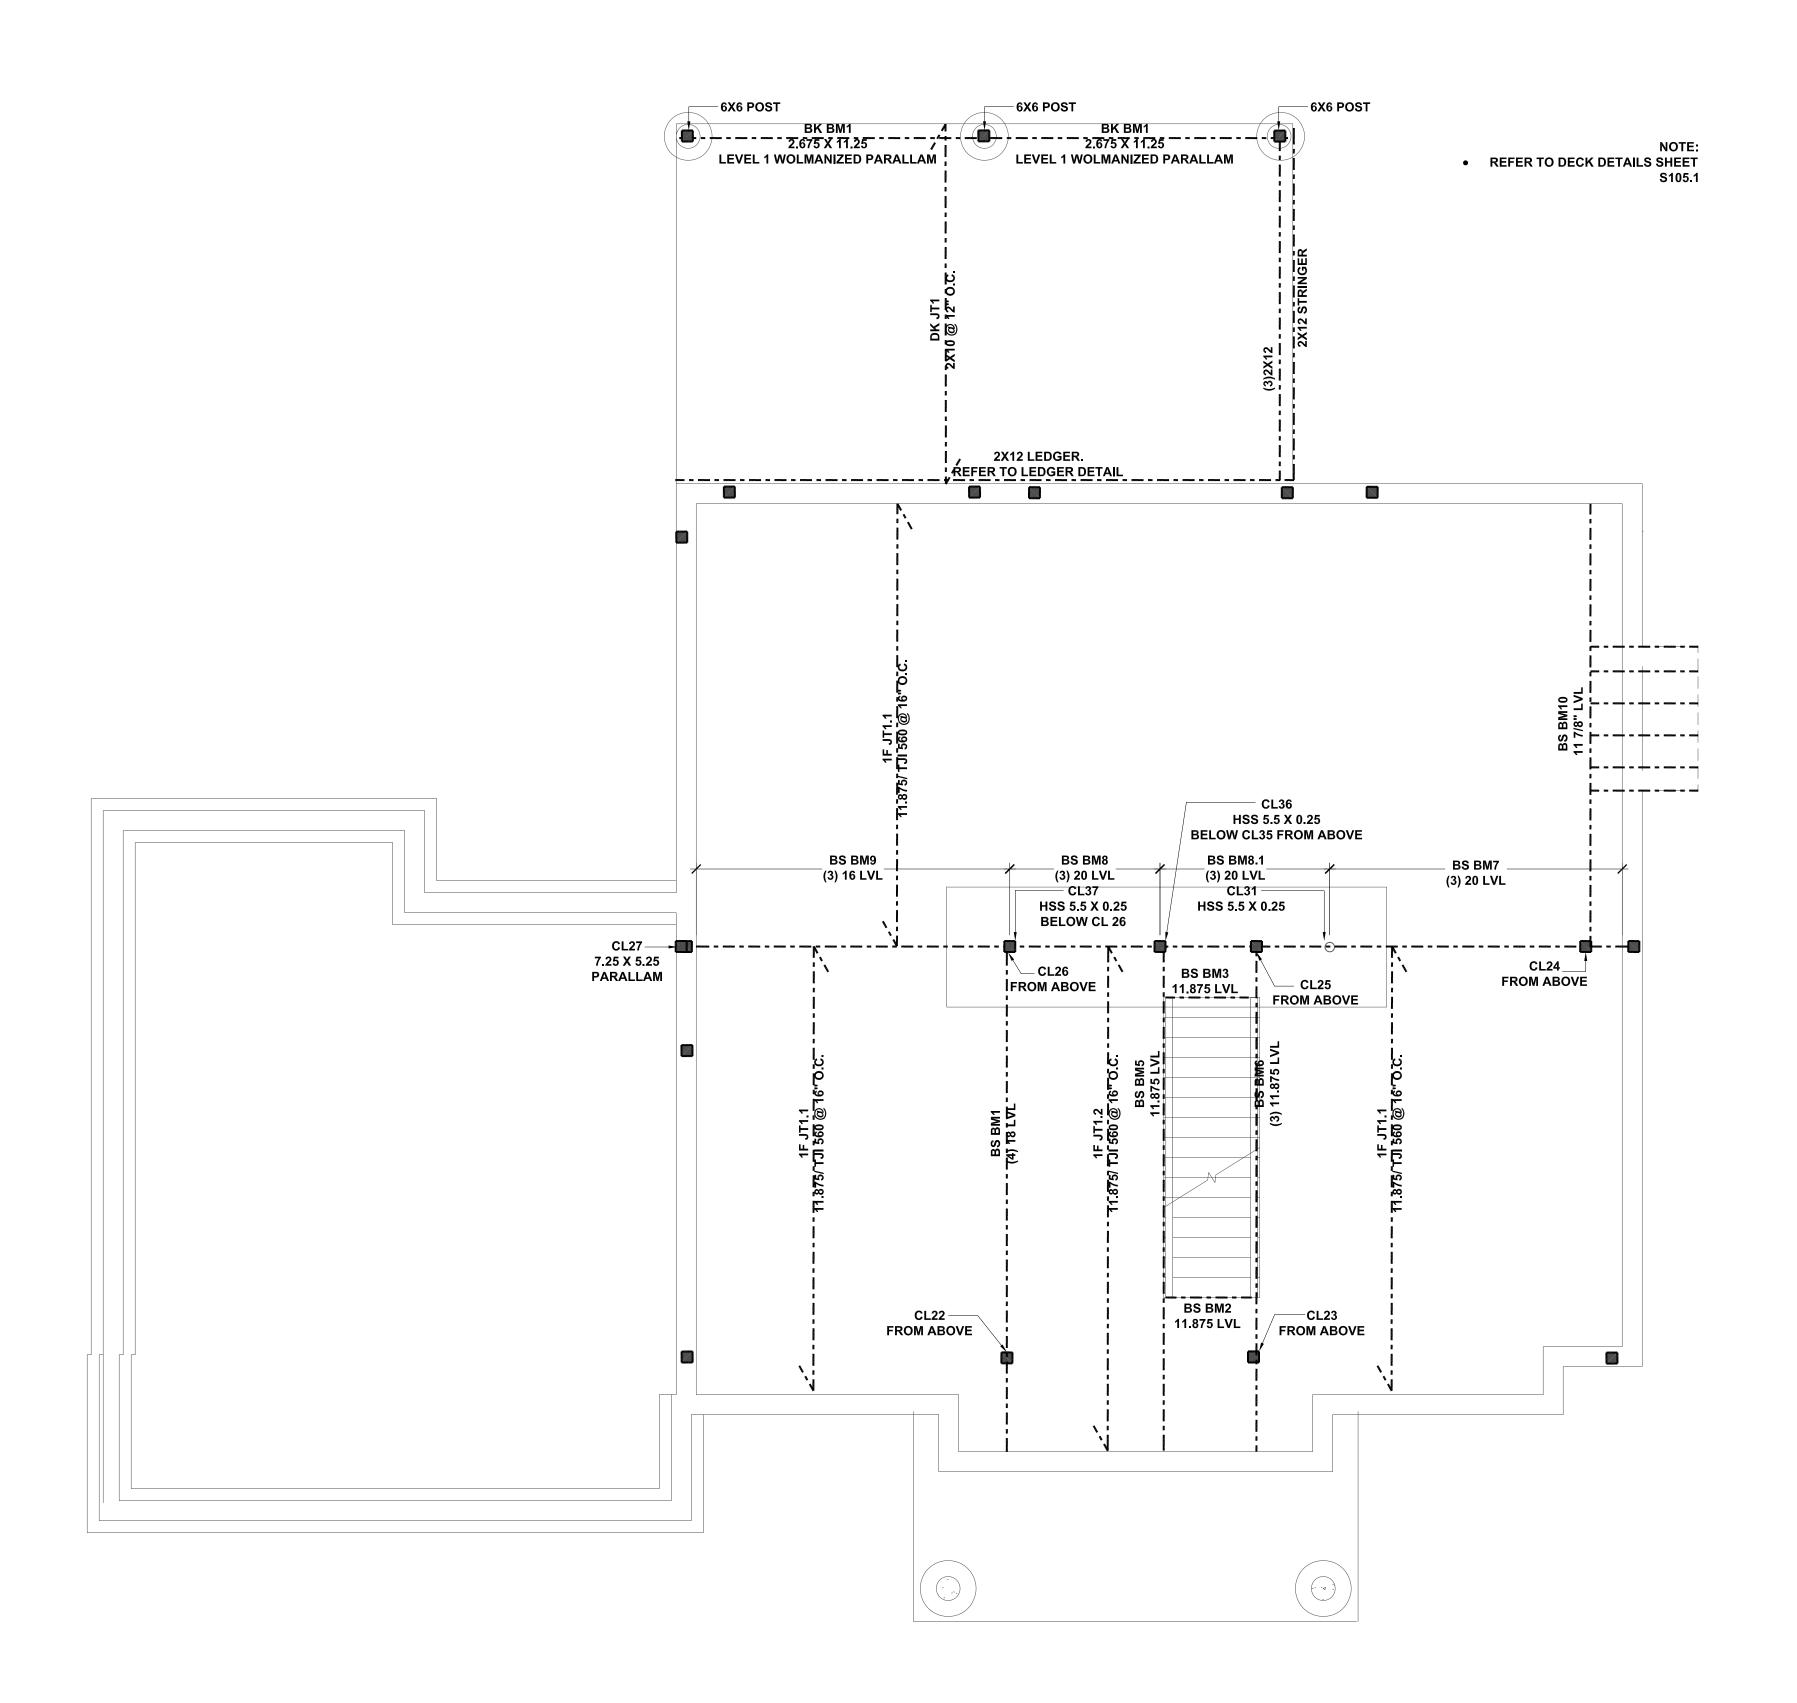



- ALL MULTI-MEMBER BEAMS SHALL FASTENED TOGETHER WITH FLATLOK STRUCTURAL WOOD
- SCREW.

 2. ALL MULTI MEMBER STUD POSTS SHALL BE NAILED
- TOGETHER.
- 3. REFER TO DECK DETAILS FOR DECK AND PORCH LEDGER ATTACHMENT TO HOUSE.
- 4. ALL FRAMING MEMBERS SHALL BE CONNECTED WITH METAL CONNECTORS, MANUFACTURED BY SIMPSON.



NOTE:

DO NOT SCALE DRAWINGS. REFER TO WRITTEN
MEASUREMENTS FOR ACCURANCY, OR CONTACT ARCHITECT
CONTACT ARCHITECT IF THERE ARE ANY DISCECPENCIES.
UNAUTHORIZED ALTERATIONS OR ADDITIONS TO THIS
DRAWING IS A VIOLATION OF NEW YORK STATE EDUCATION

© Copyright 2018 MICHAEL PICCIRILLO ARCHITECTURE


No.	DATE:	ISSUE:	
1	6/16/21	ISSUED	
	<u> </u>		_

PROJECT NAME:

Project Name

PROJECT ADDRESS:

25 ORCHARD DRIVE ARMONK, NY

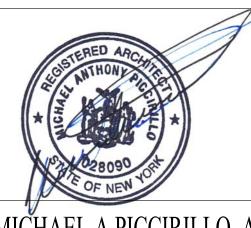


MICHAEL A PICCIRILLO, AIA

345 KEAR STREET
YORKTOWN HEIGHTS, NEW YORK

TELEPHONE: 914-368-9838
FACSIMILE: 914-368-9839
michael@mpiccirilloarchitect.com
www.mpiccirilloarchitect.com

FRAMING PLANS

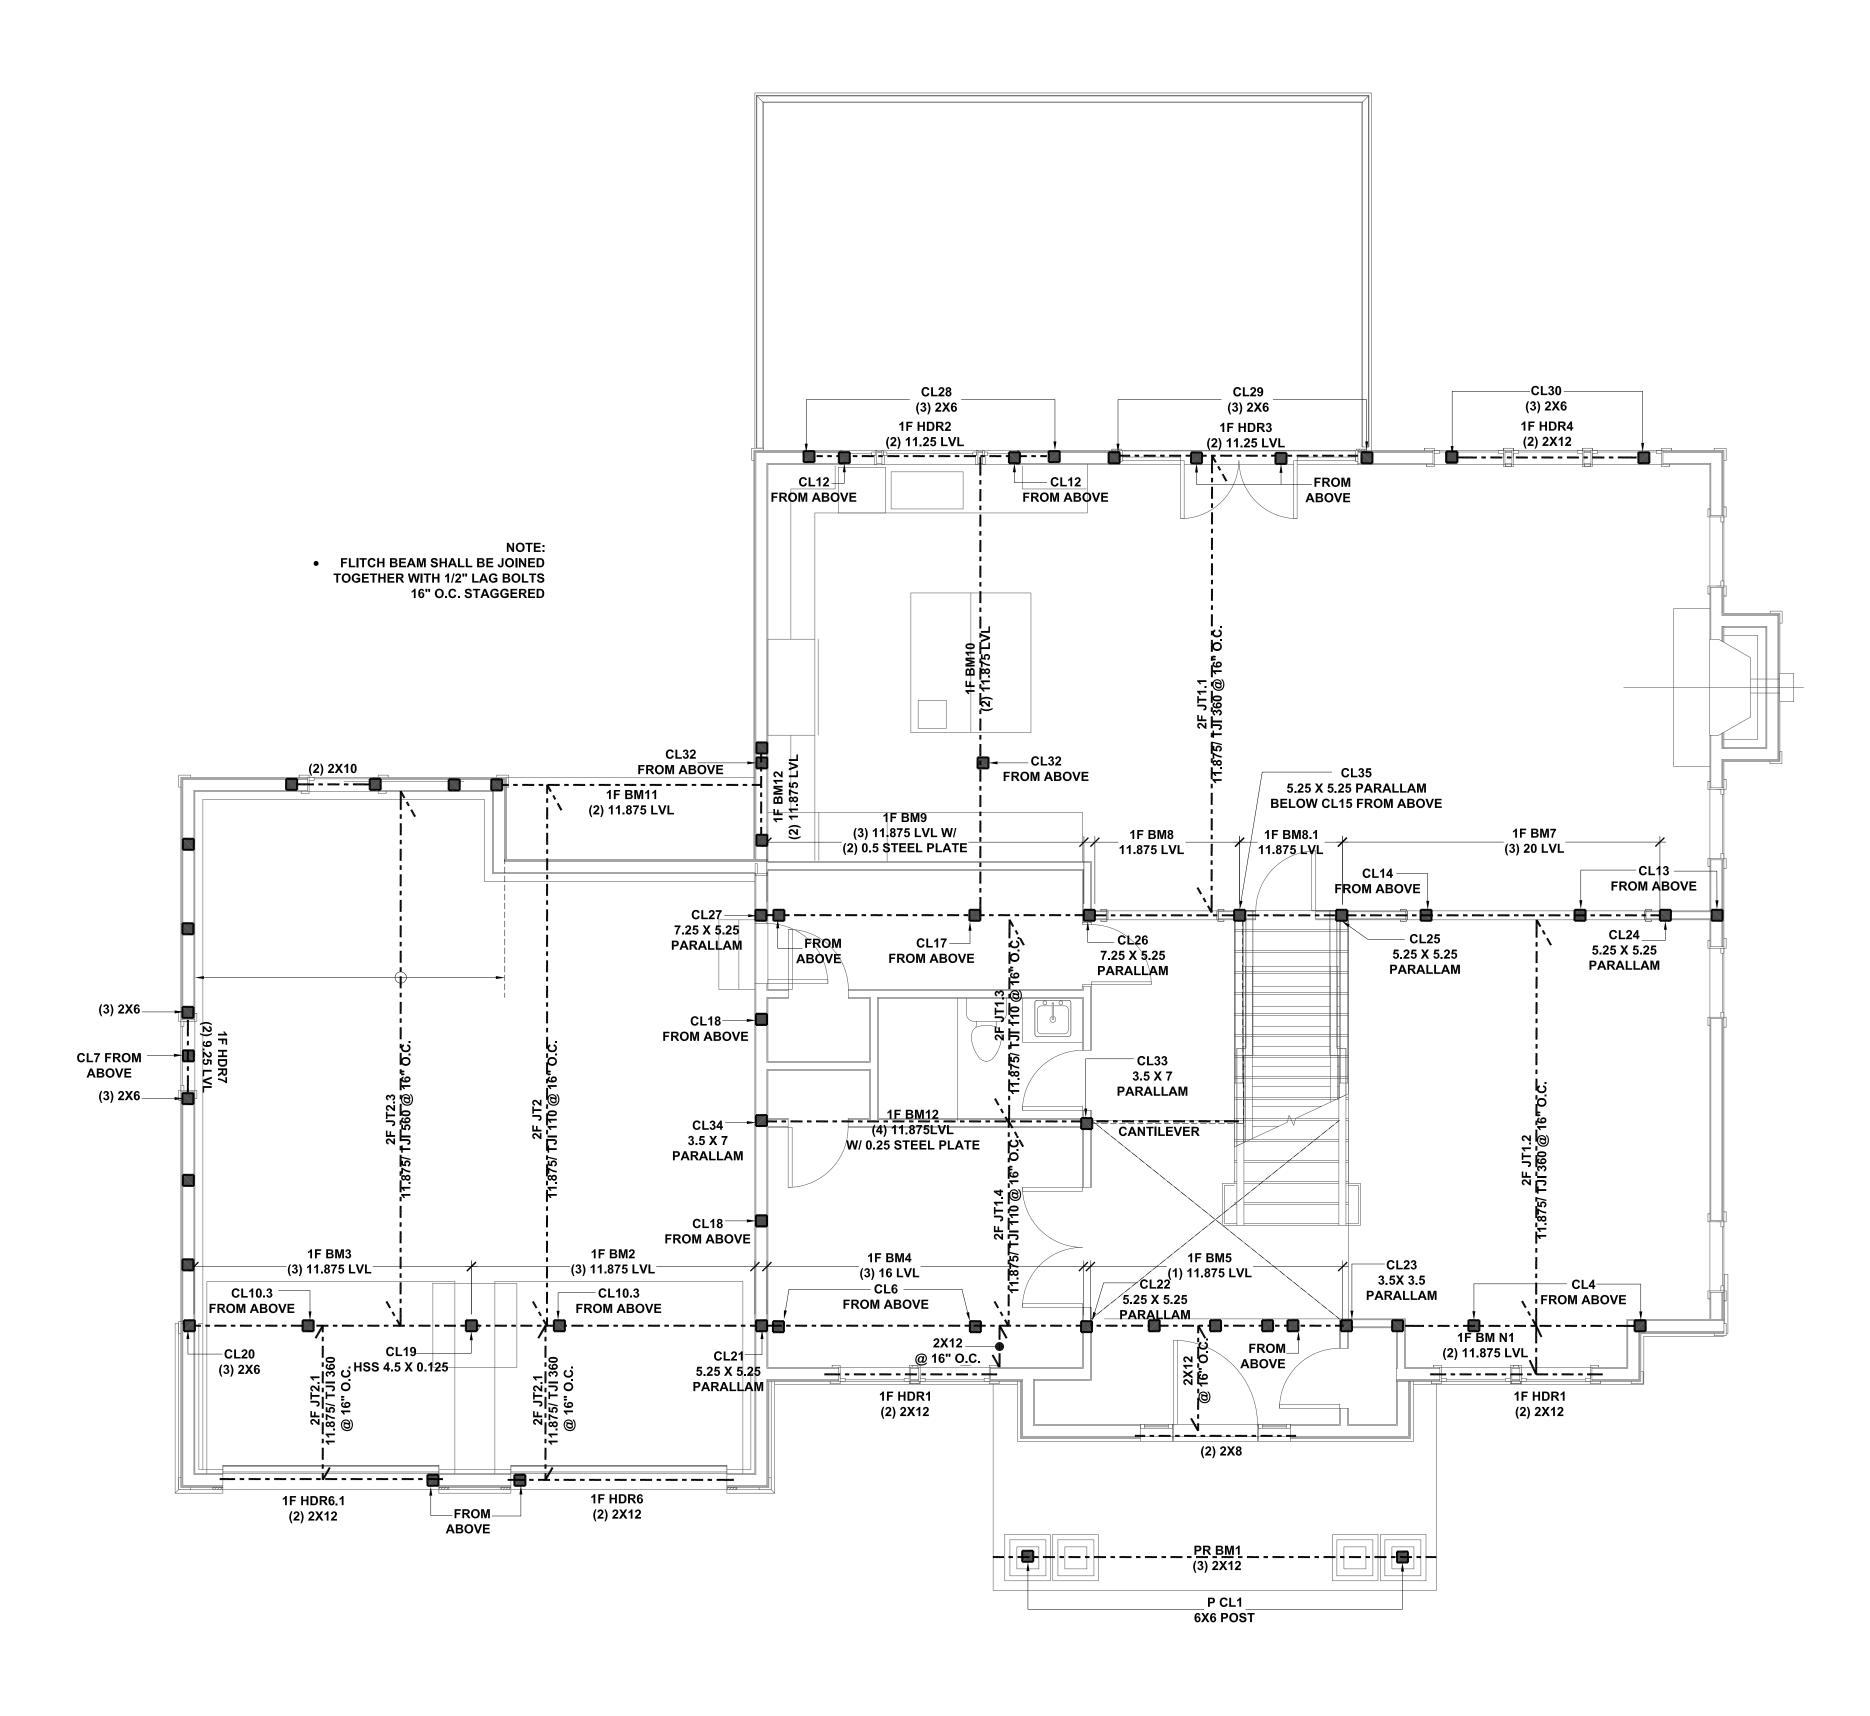



- 1. ALL MULTI-MEMBER BEAMS SHALL FASTENED TOGETHER WITH FLATLOK STRUCTURAL WOOD
- 2. ALL MULTI MEMBER STUD POSTS SHALL BE NAILED
- 3. REFER TO DECK DETAILS FOR DECK AND PORCH
- LEDGER ATTACHMENT TO HOUSE.

4. ALL FRAMING MEMBERS SHALL BE CONNECTED WITH METAL CONNECTORS, MANUFACTURED BY SIMPSON.



DO NOT SCALE DRAWINGS. REFER TO WRITTEN MEASUREMENTS FOR ACCURANCY, OR CONTACT ARCHITECT CONTACT ARCHITECT IF THERE ARE ANY DISCECPENCIES. UNAUTHORIZED ALTERATIONS OR ADDITIONS TO THIS DRAWING IS A VIOLATION OF NEW YORK STATE EDUCATION

© Copyright 2018 MICHAEL PICCIRILLO ARCHITECTURE

ISSUED 1 6/16/21

PROJECT NAME:

Project Name

PROJECT ADDRESS:

25 ORCHARD DRIVE ARMONK, NY



MICHAEL A PICCIRILLO, AIA 345 KEAR STREET YORKTOWN HEIGHTS, NEW YORK


> TELEPHONE: 914-368-9838 FACSIMILE: 914-368-9839 michael@mpiccirilloarchitect.com www.mpiccirilloarchitect.com

> > FRAMING **PLANS**



DO NOT SCALE DRAWINGS. REFER TO WRITTEN
MEASUREMENTS FOR ACCURANCY, OR CONTACT ARCHITECT CONTACT ARCHITECT IF THERE ARE ANY DISCECPENCIES.
UNAUTHORIZED ALTERATIONS OR ADDITIONS TO THIS
DRAWING IS A VIOLATION OF NEW YORK STATE EDUCATION

© Copyright 2018 MICHAEL PICCIRILLO ARCHITECTURE

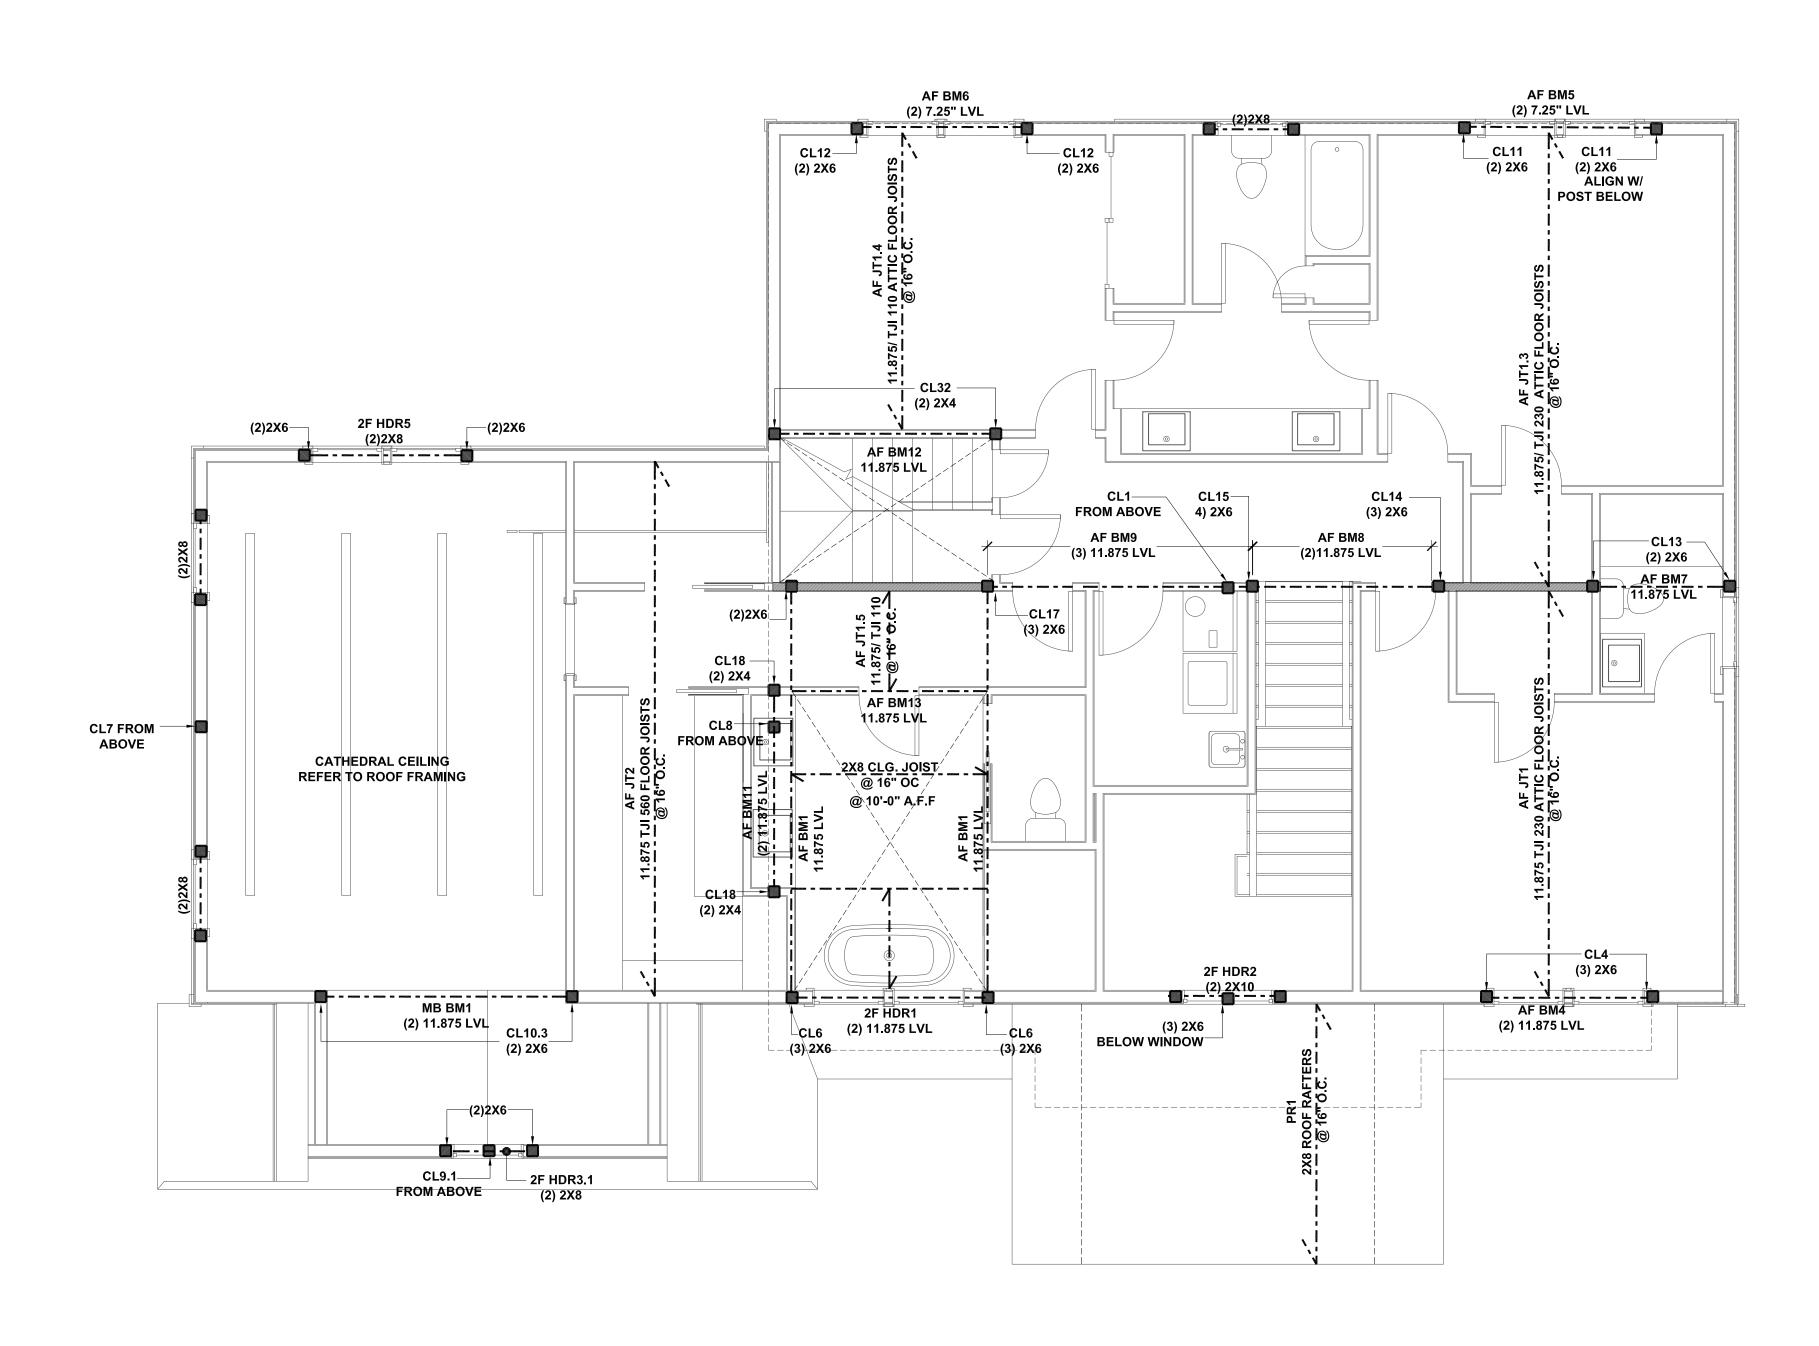

C ATTIC FLOOR FRAMING PLAN SCALE: 1/4" = 1'-0"

- 1. ALL MULTI-MEMBER BEAMS SHALL FASTENED TOGETHER WITH FLATLOK STRUCTURAL WOOD
- 2. ALL MULTI MEMBER STUD POSTS SHALL BE NAILED
- TOGETHER.
- REFER TO DECK DETAILS FOR DECK AND PORCH LEDGER ATTACHMENT TO HOUSE.
 ALL FRAMING MEMBERS SHALL BE CONNECTED WITH METAL CONNECTORS, MANUFACTURED BY SIMPSON.

No.	DATE:	ISSUE:	
1	6/16/21	ISSUED	
	-		

PROJECT NAME:

Project Name

PROJECT ADDRESS:

25 ORCHARD DRIVE ARMONK, NY



345 KEAR STREET YORKTOWN HEIGHTS, NEW YORK


TELEPHONE: 914-368-9838 FACSIMILE: 914-368-9839 michael@mpiccirilloarchitect.com www.mpiccirilloarchitect.com

> FRAMING **PLANS**



DO NOT SCALE DRAWINGS. REFER TO WRITTEN
MEASUREMENTS FOR ACCURANCY, OR CONTACT ARCHITECT.
CONTACT ARCHITECT IF THERE ARE ANY DISCECPENCIES.
UNAUTHORIZED ALTERATIONS OR ADDITIONS TO THIS
DRAWING IS A VIOLATION OF NEW YORK STATE EDUCATION

© Copyright 2018 MICHAEL PICCIRILLO ARCHITECTURE

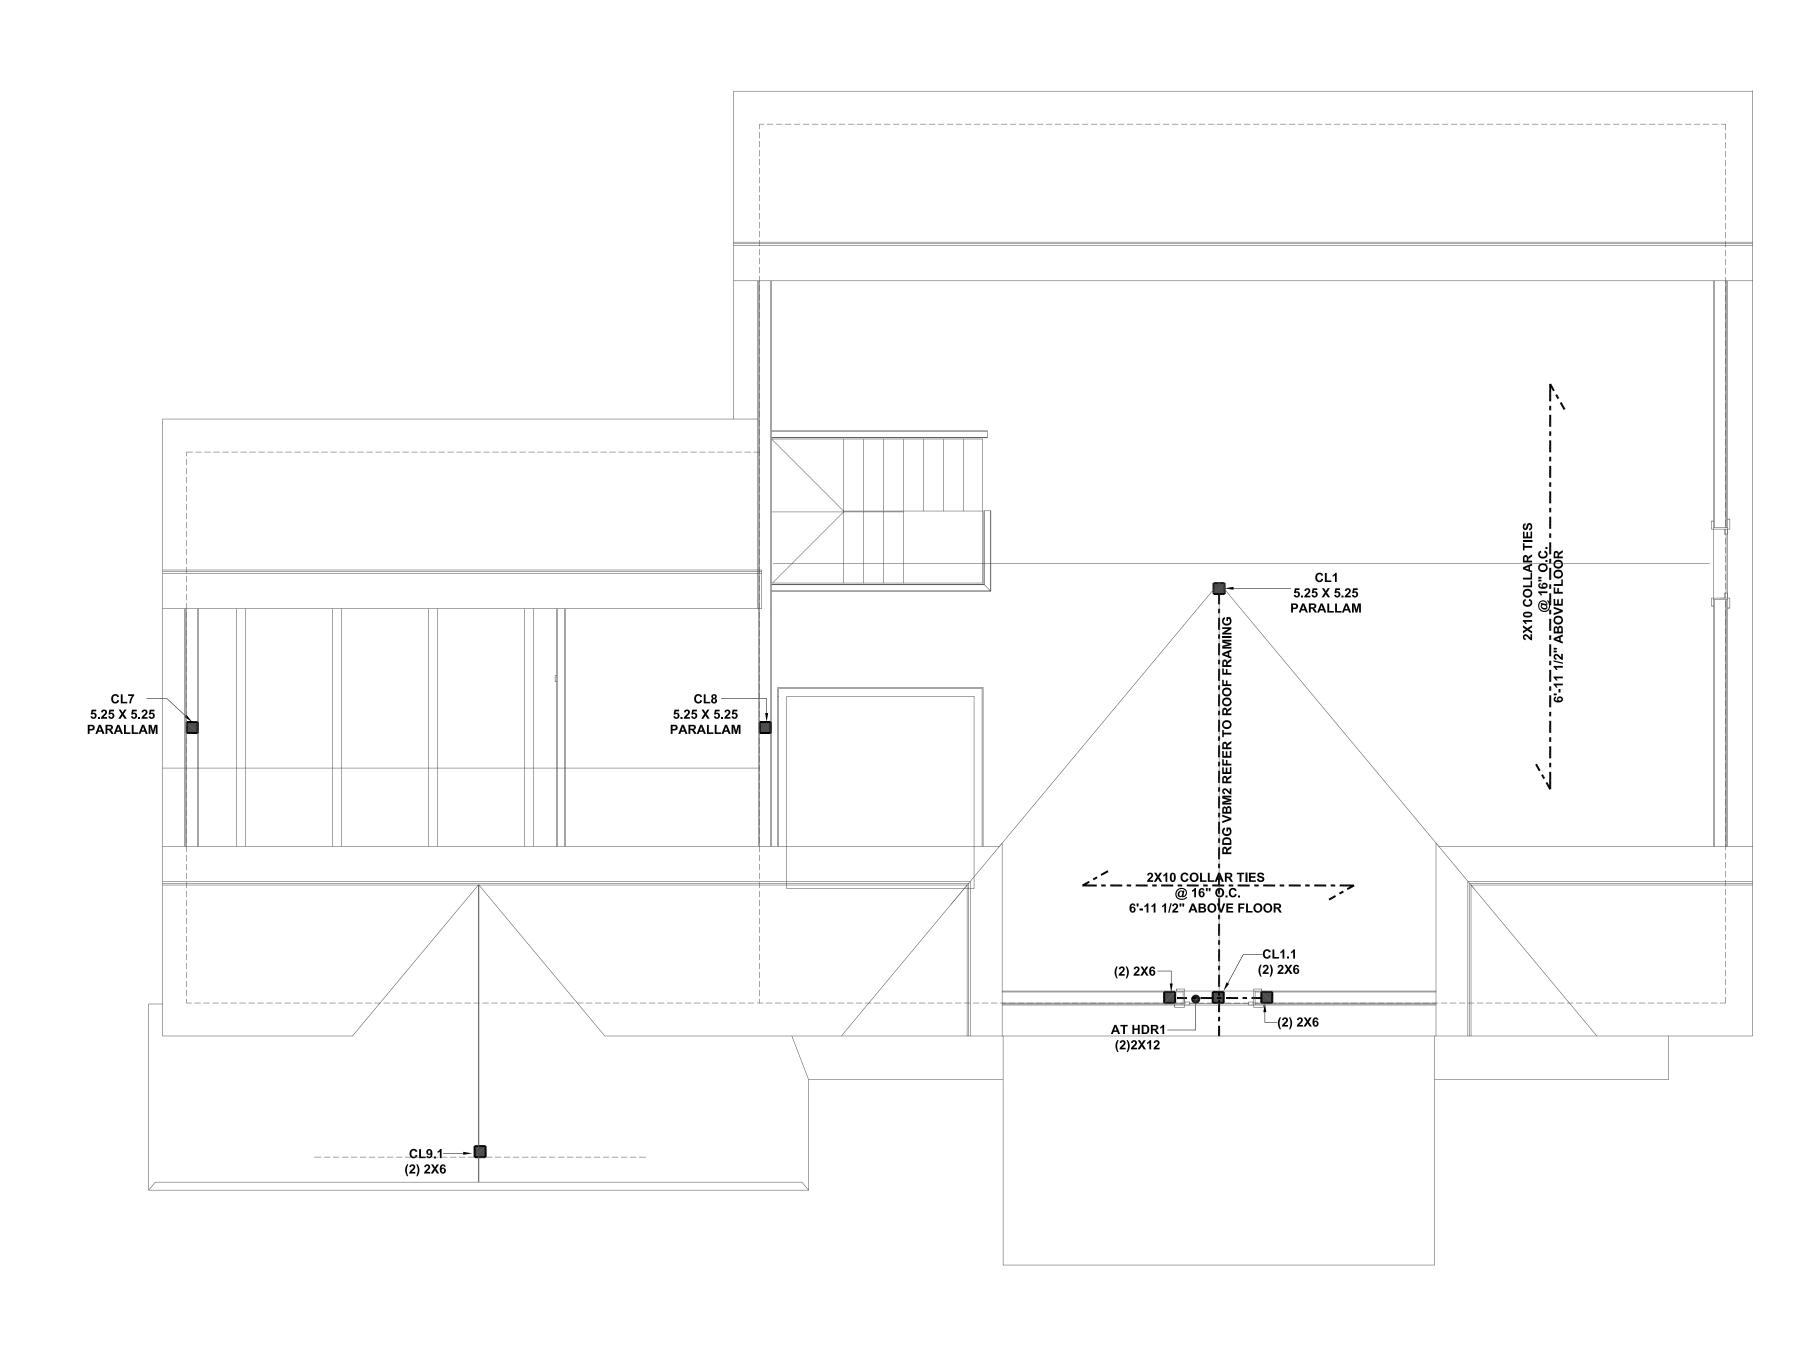

ATTIC CEILING FRAMING PLAN

SCALE: 1/4" = 1'-0"

- ALL MULTI-MEMBER BEAMS SHALL FASTENED TOGETHER WITH FLATLOK STRUCTURAL WOOD

- TOGETHER WITH FLATLOK STRUCTURAL WOOD SCREW.

 2. ALL MULTI MEMBER STUD POSTS SHALL BE NAILED TOGETHER.

 3. REFER TO DECK DETAILS FOR DECK AND PORCH LEDGER ATTACHMENT TO HOUSE.

 4. ALL FRAMING MEMBERS SHALL BE CONNECTED WITH METAL CONNECTORS, MANUFACTURED BY SIMPSON.


No.	DATE:	ISSUE:	
1	6/16/21	ISSUED	
	-		

PROJECT NAME:

Project Name

PROJECT ADDRESS:

25 ORCHARD DRIVE ARMONK, NY

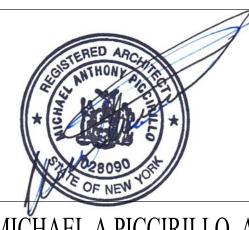

MICHAEL A PICCIRILLO, AIA 345 KEAR STREET YORKTOWN HEIGHTS, NEW YORK


TELEPHONE: 914-368-9838 FACSIMILE: 914-368-9839 michael@mpiccirilloarchitect.com www.mpiccirilloarchitect.com


> FRAMING **PLANS**



DO NOT SCALE DRAWINGS. REFER TO WRITTEN
MEASUREMENTS FOR ACCURANCY, OR CONTACT ARCHITECT.
CONTACT ARCHITECT IF THERE ARE ANY DISCECPENCIES.
UNAUTHORIZED ALTERATIONS OR ADDITIONS TO THIS
DRAWING IS A VIOLATION OF NEW YORK STATE EDUCATION

© Copyright 2018 MICHAEL PICCIRILLO ARCHITECTURE

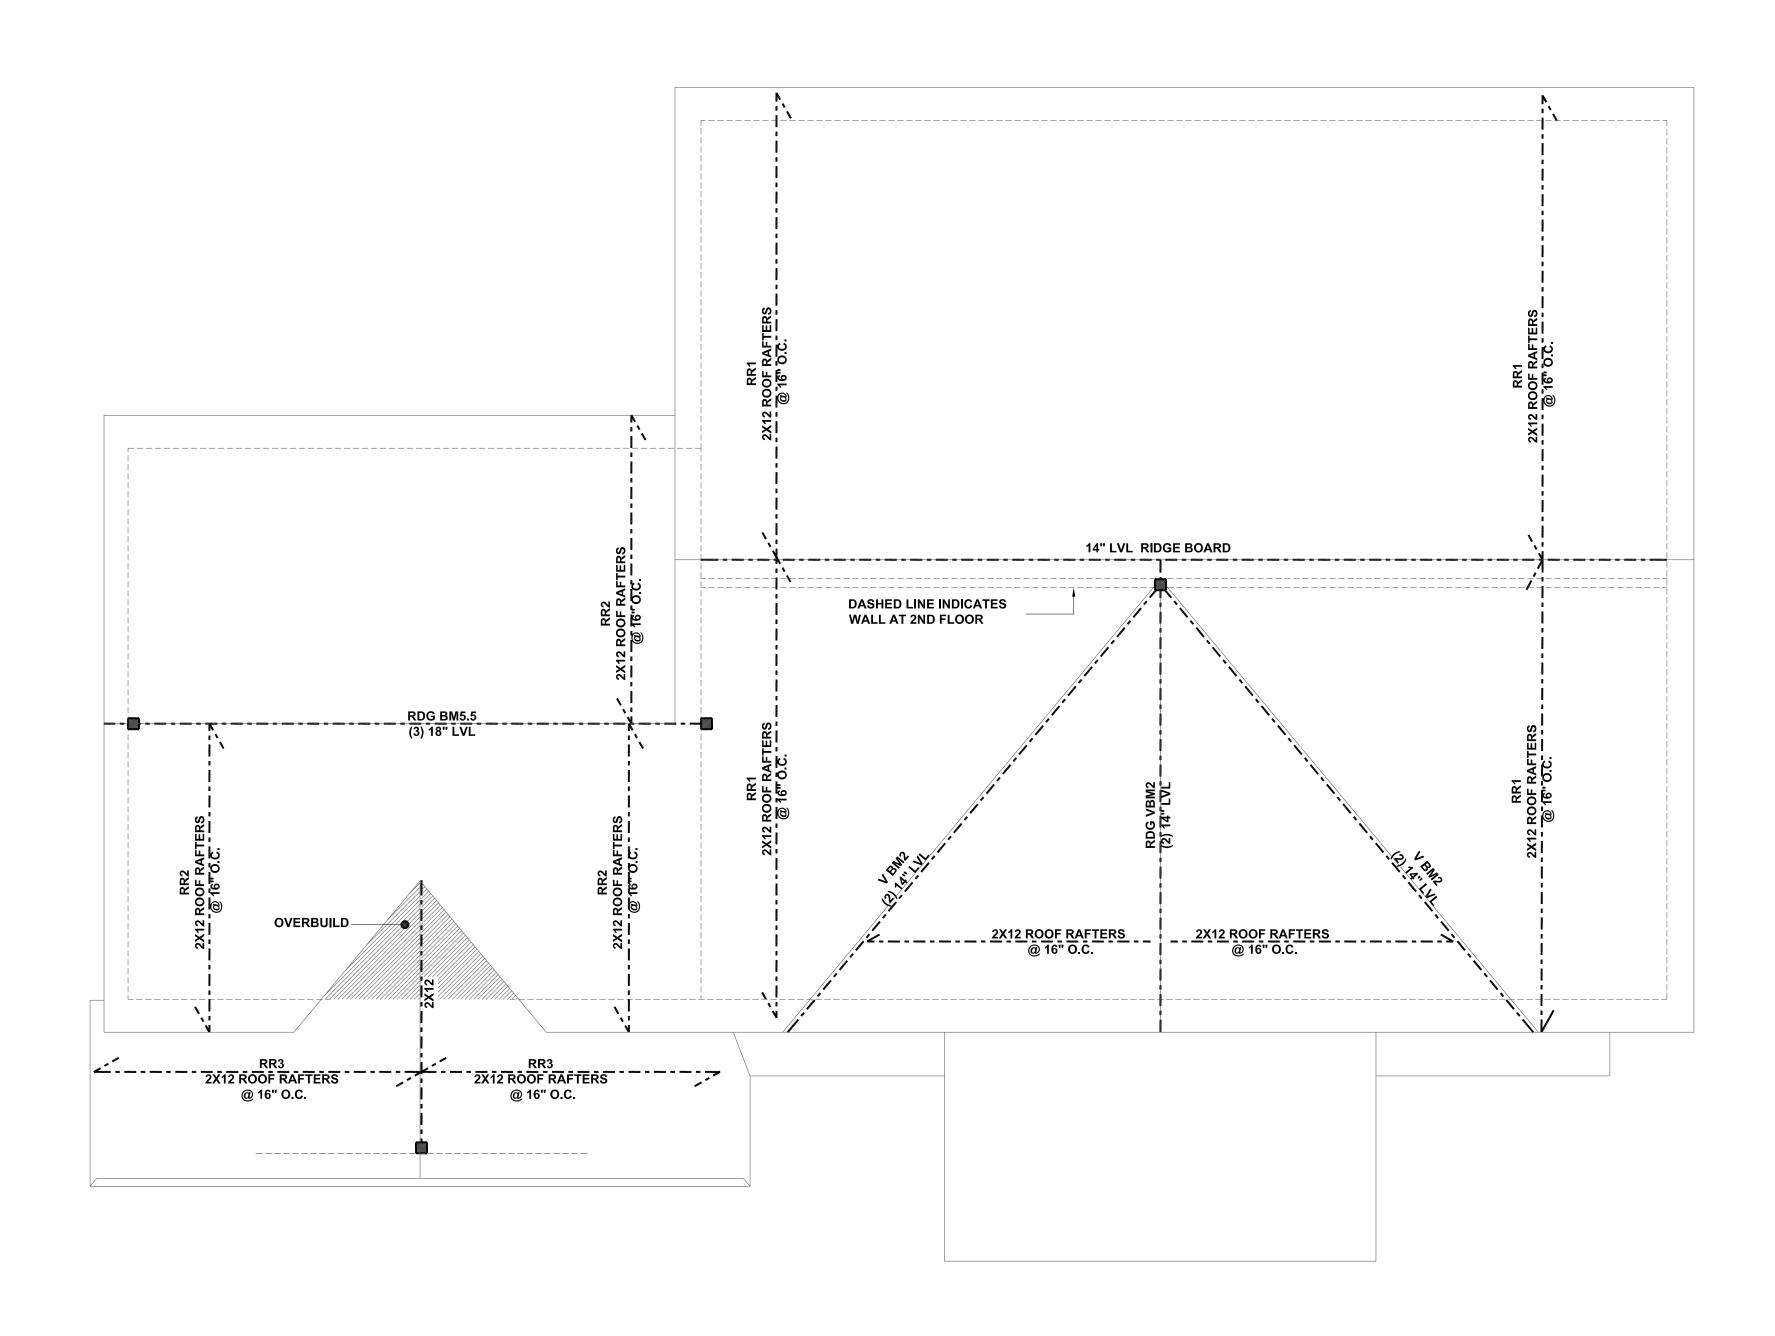

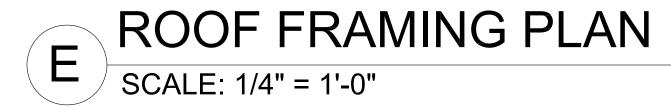

- 1. ALL MULTI-MEMBER BEAMS SHALL FASTENED TOGETHER WITH FLATLOK STRUCTURAL WOOD
- 2. ALL MULTI MEMBER STUD POSTS SHALL BE NAILED
- TOGETHER.
- REFER TO DECK DETAILS FOR DECK AND PORCH LEDGER ATTACHMENT TO HOUSE.
 ALL FRAMING MEMBERS SHALL BE CONNECTED WITH METAL CONNECTORS, MANUFACTURED BY SIMPSON.


No.	DATE:	ISSUE:	
1	6/16/21	ISSUED	

PROJECT NAME:

Project Name

PROJECT ADDRESS:


25 ORCHARD DRIVE ARMONK, NY

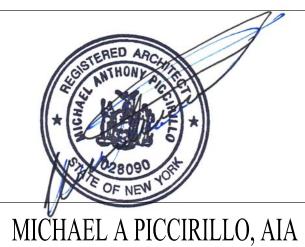


345 KEAR STREET YORKTOWN HEIGHTS, NEW YORK

TELEPHONE: 914-368-9838 FACSIMILE: 914-368-9839 michael@mpiccirilloarchitect.com www.mpiccirilloarchitect.com


> FRAMING **PLANS**

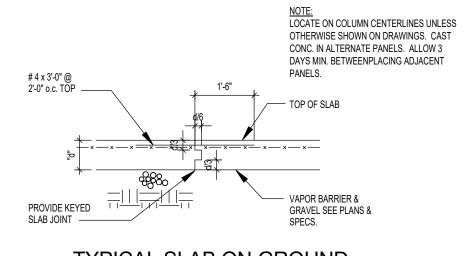


TYPICAL SLAB ON GROUND **CONSTRUCTION JOINT DETAIL**

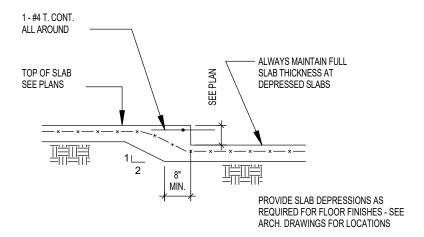


TYPICAL SLAB DEPRESSION SLAB ON

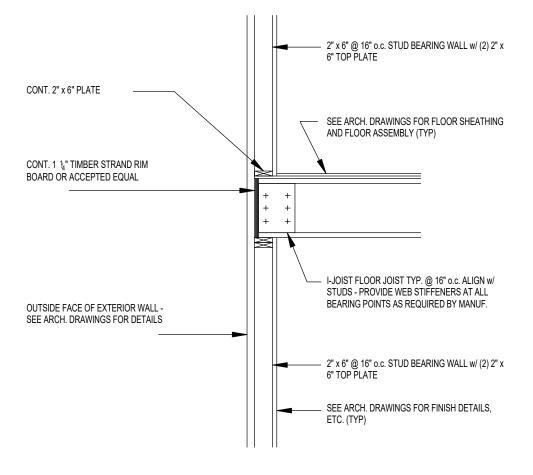

TYPICAL EXTERIOR BEARING WALL DETAIL AT FLOOR

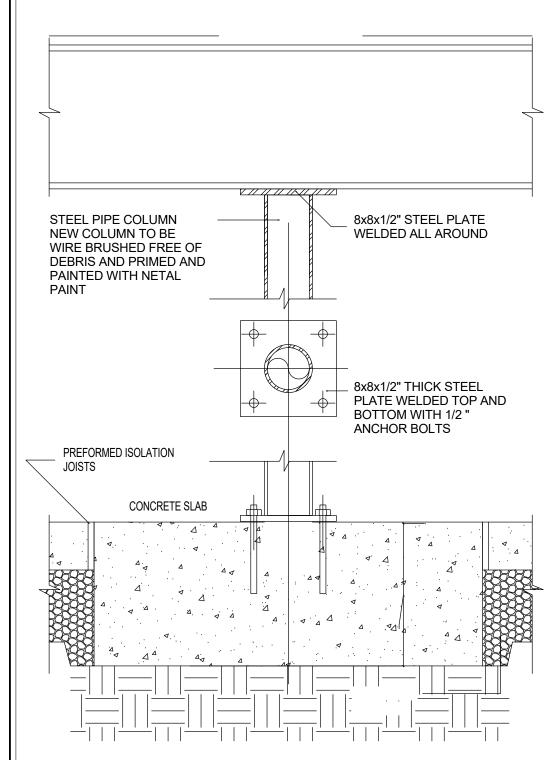


PIPE COLUMN DETAIL

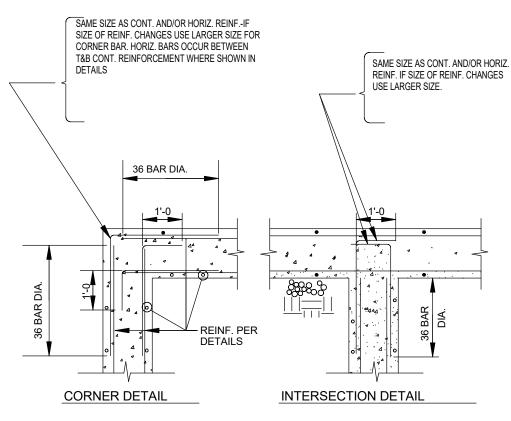


REINFORCEMENT LAPPING DETAILS

THIS DETAIL IS APPLICABLE TO ALL CONCRETE WALLS AND MUST BE REPEATED ON CONCRETE REINFORCEMENT SHOP

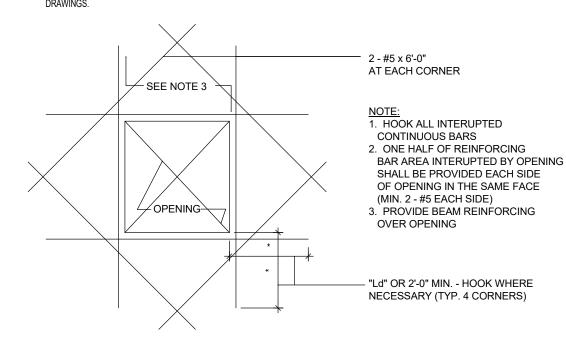

TYPICAL DETAIL OF OPENING IN CONCRETE WALLS DETAIL

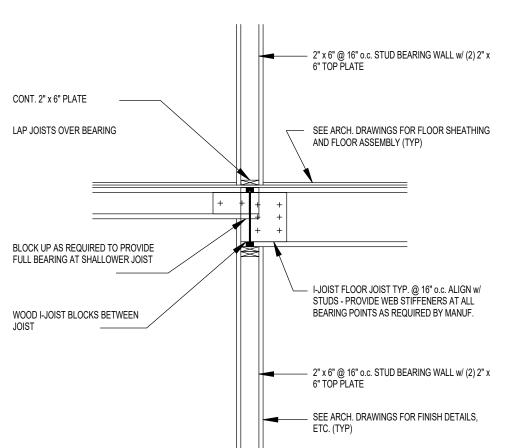

SLAB ON GROUND DETAIL

- 6" CRUSHED STONE OR

GRAVEL WELL TAMPED

"D"-12" MIN.

STEPPED FOOTING DETAIL

— 2" MAX. - ROUND

HOLES WITHOUT

2xDIAMETER OF

1/3 SPAN

FOR HOLES 2" TO 4.5"(MAX.)

EA. SIDE LAG BOLTED TO BM.

SLAB CONTROL JOINTS (C.J.) 3/16" WIDE SAWCUT BY T/4 DEEP W/ BACKER ROD AND SEALANT SHOW LOCATIONS ON SHOP

- 2-#5 CONT. UNDER

PART'N. AND DUCT

REINF. BEAM w/ L3x3x1/4 x 48" LONG TOP & BOTTOM

LARGEST HOLE (MIN.)

REINF. SHOWN

ALLOWED HOLE

ALLOWABLE HOLES IN BEAMS

PARTITIONS CAN BE MASONRY OR


STUD WALLS

PROV. SAME DETAIL AT

DUCTS IN SLAB

NOTE: DIMENSION OF POUR OF SLAB ON GROUND SHALL NOT EXCEED 20 ft. (MAX.) PLACE SECTIONS IN ALTERNATE STRIPS-ALLOW A MIN. 24 HRS. BEFORE

TYPICAL INTERIOR BEARING WALL DETAIL AT **FLOOR**

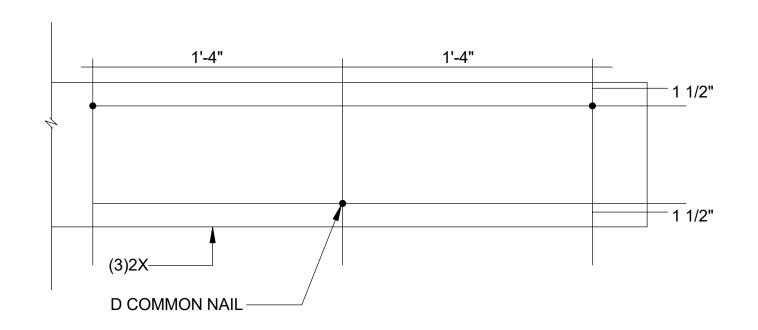

- PROVIDE NAILS ON BOTH SIDES OF BEAM, STAGGER FASTENERS ON THE SECOND SIDE SO THEY FALL HALFWAY BETWEEN FASTENERS ON THE FIRST SIDE
- ALL NAILS SHALL PENETRATE ALL LAMINATIONS AND AT LEASOF OUTERMOST LAMINATION

NAILED BUILT-UP BEAM/ HEADER DETAIL

- CONT. WALL

(2-#6 MIN.)

EDGE OF

- 1. Foundations have been designed to bear on undisturbed medium dense to very dense native sand soils. Assumed maximum bearing values are 4,000 pounds per square foot.
- 2. Should it be necessary to lower footings, elevations of adjacent footings shall be adjusted to limit stepping to 1 vertical to 2 horizontal. Place lowest footing first. See "STEPPED FOOTING DETAIL."
- 3. Keep footing bottoms well drained until footings are in place. Pump as required. 4. Do not backfill against retaining walls unless walls are shored or until concrete has attained specified 28 day
- 5. Construction joints in walls shall be no more than 50 feet apart and no less than 4 feet from any pier. Reinforcement shall be continuous through construction joints. Do not use horizontal construction joints. See
- 6. Slabs on ground shall be placed in alternative strip fashion to minimize shrinkage. Maximum place dimensions shall not exceed 20 feet.
- 7. Provide all necessary shoring, sheeting and bracing for deep footing excavations.
- 8. All retaining walls shall have 12" of free-draining granular backfill behind wall full height. Provide control joints in retaining walls evenly spaced no more than 30 feet o. c.
- 9. See "CONCRETE" notes for additional requirements.

CONCRETE:


- 1. All concrete design and placement shall comply with the latest edition of the ACI 301, "Specification for Structural Concrete for Buildings". Hot weather concreting shall be in accordance with ACI 305. Cold weather concreting shall be in accordance with ACI 306. All other applicable codes shall also
- 2. Concrete shall be normal weight concrete except light weight concrete shall be used for slabs on steel deck unless noted otherwise. Concrete shall develop a minimum compressive strength of 3,000 psi at 28 days for foundations and 4,000 psi with a minimum of 4% air entrainment for all other concrete. (Including slabs on ground).
- 3. Reinforcement shall be deformed intermediate grade new billet steel conforming to ASTM Designation A-615, Grade 60. Welded wire fabric shall conform to ASTM A-185. The use of polypropylene fibers may only be <u>inseddition</u> to mesh and reinforcement called out for slabs.
- 4. Follow ACI rules as to ties, anchorage, splices, concrete coverage and reinforcement supports.
- 5. Reinforcement marked "CONTINUOUS" (CONT.) shall be lapped 36 bar diameters at splices and
- 6. Construction joints shall be located at points of zero shear. No construction joints shall be located in

corners, and hooked at non-continuous ends or extended 36 bar diameters unless otherwise noted.


- members carrying a concentrated load. Provide shear bars as directed by the Engineer. Locations of construction joints shall be accepted by the Engineer.
- 7. Provide sleeves and box out for openings for mechanical trades. For size and location of all openings, see architectural and mechanical drawings in addition to structural drawings. Openings shall be placed so as not to affect the strength of the structural members.
- 8. Contractor shall verify dimensions and locations of all openings, pipe sleeves, anchor bolts, etc., as required by all trades, before concrete is placed.
- 9. See Concrete specifications for additional requirements.

PLYWOOD/GYP BOARD SHEATHING NOTES

- 1. All plywood construction shall be in accordance with the American Plywood Association (APA) specifications.
- 2. All roof panel sheathing shall be "(NOM.) type CDX, exp. I APA rated sheathing. Suitable edge support shall be provided by use of panel clips or blocking between framing. Unless otherwise noted connect roof sheathing with 8d common nails at 6" o.c. at supported panel edges and 6" o.c. at intermediate supports.
- 3. All floor sheathing shall be34" (NOM.) APA rated sturd-I-floor, exp. I, with tongue and groove edge. Unless otherwise noted connect floor sheathing with 10d common nails spaced 6" o.c. at supported edges and 12" o.c. at intermediate supports. Field-glue using adhesives meeting APA specification AFG-01, applied in accordance with the manufacturer's recommendations.
- 4. All wall panel sheathing shall bel2" (NOM.) type CDX. exp. I APA rated sheathing. Unless otherwise indicated, connect wall sheathing with 10d common nails spaced 6" o.c. at supported panel edges and 12" o.c. at intermediate supports
- 5. Install all plywood sheathing with the long dimension of the panel across supports and with panel continuous over two or more spans. Stagger panel end joints. All spacing at panel ends and edges unless otherwise recommened by the sheathing manufacturer.
- 6. All nailing shall be carefully driven and not overdriven. The use of staples and pnuematic nail guns are
- 7. All ext. walls shall be sheathed on exterior side with plywood fastened with 6d common nails 6" o.c. at edges and 12" o.c. at intermediate support.
- 8. Provide 2x blocking at unsupported panel edges as follows:
- 8.1. roofs and floors only where indicated on plan walls - per the shearwall schedule

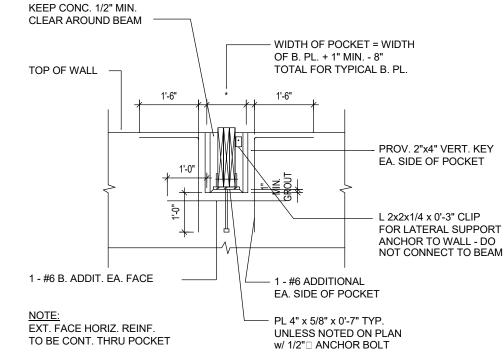

BEAM POCKET DETAIL

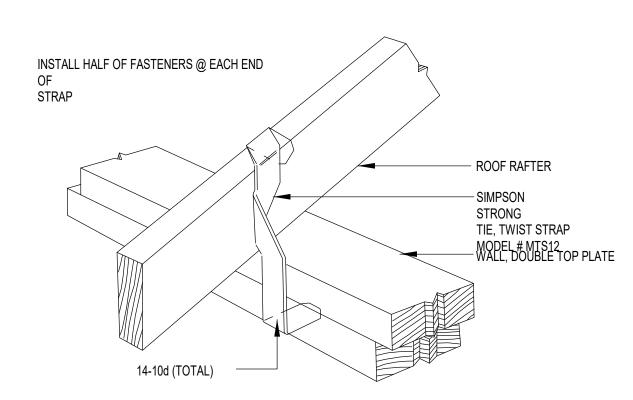

ROOF UPLIFT DETAIL

PREFABRICATED WOOD JOIST NOTES

- 1. Prefabricated wood I-joists shall be designed and furnished in accordance with a current code-accepted evaluation report. Structural capacities and design provisions shall be established and monitored in accordance with ASTM D 5055.
- 2. Wood joists shall be designed by the manufacturer to support the loads indicated per the joist loading diagrams. Unless otherwise indicated, joists shall be designed for the following:
- 2.1. Top chord loading 2.2. live load - 40 psf
- 2.3. dead load 15 psf 2.5. dead load - 5 psf
- Bottom chord loading
- 2.6. Wind load 35 psf net uplift pressure (roof joists only)
- 3. Wood I-joists shall be erected in accordance with the manufacturer's requirements. The contractor shall provide all temporary and permanent bracing as required for safe erection and performance of the joists.
- 4. Wood I-joists shall not be cut, notched, coped, drilled nor otherwise altered in any way unless specifically conduted in accordance with the manufacturer's written requirements. Do not cut flanges
- 5. Wood I-joists shall be produced by a code accepted fabricator with a minimum of five (5) years experience producing prefabricated wood joists. Quality control shall be audited by an agency accepter by the "Building Officials & Code Administrators. Inc.".
- 6. Web panels must be joined with a machined and glued vee joint to form a continuous member. All joints shall be glued using an exterior type adhesive per ASTM 2559.
- 7. Wood I-joists shall be stored in bundles in an upright position and away from ground contact. Any damage to joists shall be brought to the immediate attention of the joist supplier. Filed repair or modification of joists must not be made without the written approval by the supplier, except for trimming to correct length.
- 8. Wood I-koists shall be carefully handled to prevent damage and distortion. Each joist shall be anchored and braced, as it is erected, using blocking panels and anchorage indicated (and per the supplier's requirements). Erectore shall provide supplemental lateral bracing of the top flange until sheathing is properly nailed.
- 9. All roof joists shall be positioned with the natural camber turned up.

WOOD FRAMING NOTES

- 1. All wood framing material shall be surfaced dry and used at 19% maximum moisture content. Allowable stress requirements of all material shall be in accordance with the "schedule of required stress values", on sheet S-?.
- 2. All stud and wall framing shall be A. No. 2 grade douglas fir ("stud" grade material is strictly prohibited from use.)
- 3. All joist, rafter & misc. framing shall be No. 1 grade, Douglas Fir-L. Provide full-depth (or metal) bridging at midspan and at a maximum spacing of 8'-0" o.c. in between.
- 4. All framing exposed to the weather of in contact with masonry or concrete shall be pressure-treated in accordance with the American Wood Preservers Association specifications. Where possible, all cuts and holes due to on-site fabrication shall be brushed with 2 coats of copper naphthenate solution containing a minimum of 2% metallic copper in solution (per AWPA Std. M4).
- 5. The contractor shall carefully select lumber to be used in loadbearing applications. The length of split on the wide face of 2" nominal loadbearing framing shall be limited to less, total wide face dimension. The length of split on the wide face of 3" (nominal) and thicker lumber shall be limited the narrow face
- 6. All nailing not otherwise indicated shall be in accordance with Table R602.3(1) of the RCNYS2010
- 7. Provide double joists under all partitions which run parralel with joists and under all concentrated loads from
- 8. Provide header beams of the same size as joists of rafters to frame around openings in the plywood deck unless
- 9. Structural steel plate connectors shall conform to ASTM A-36 specifications and big! thick unless otherwise indicated. Bolts connecting wood members shall be per ASTM A-307 341ddlaæneter unless otherwise indicated. Provide washers for all bolt heads and nuts in contact with wood surfaces.
- 10. Bolt holes shall be carefully centered and drilled not more that he lost the bolt diameter. Bolted connection shall be snugged tight but not to the extent of cruching wood under washers.
- 11. Prefabricated "Micro-Lam" Lumber headers and beams shall be as manufactured by "Truss Joist MacMillan Corp.", Boise, Idaho of approved equal. Micro-lam material shall be 1.8E, southern pine. Do not cut or notch micro-lam material without the manufacturer's approval.
- 12. Prefabricated metal joist hangers, hurricane clips, hold-down anchors and other accessories shall be a manufactured by "Simpson Strong-tie Company", Tel. 800.999.5099), or approved equal. Install all accessories per the manufacturer's requirements. All steel shall have a minimum thickness of 0.04" (per ASTM A446, Grade A) and be galvanized (coating G60).
- 13. Holes and notches drilled or cut into wood framing shall conform to section R602.6 and section R502.8 of the
- 14. All plates, anchors, nails, bolts, nuts, washers, and other miscellaneous hardware shall be hot dip galvanized.

MISCELLANEOUS

- 1. The Structural drawings shall be used in conjunction with the drawings of all other disciplines and the specifications. All structural work shall be coordinated with architectural, mechanical and electrical requirements. Any discrepancies and/or interferences shall be reported immediately to the Architect so that corrective measures can be taken.
- 2. The contractor shall be responsible for complying with all safety precautions and regulations during the work The Engineer will not advise nor direct as to safety precautions.
- 3. The Engineer shall not be responsible for methods, techniques and sequences of procedures to perform the
- 4. Drawings indicate general and typical details of construction. Where conditions are not specifically shown, similar details shall be used, subject to acceptance by the Engineer.
- 5. Loads applied to the structure during construction shall not exceed the safe load-carrying capacity of the structure as indicated by the scheduled live loadings shown on the drawings.
- 6. Contractor shall be responsible for all required shoring. This structure has been designed to be self-supporting and stable after construction of the structure has been completed. The stability of the structure prior to completion is the sole responsibility of the Contractor. Job safety and construction procedures are also the sole resposibility of the Contractor. Lack of comment by the Architect/Engineer is not to be interpeted as acceptance of those aspects of the work.
- 7. No equipment shall be hung from bracing or steel deck.

SIMPSON STRONG TIE CONNECTORS:			
STRUCTURAL MEMBERS	CONNECTOR MODEL NO.		
EXTERIOR DECK			
GUARDRAIL POST TO DECK	DTT2Z		
DECK TO HOUSE LATERAL LOAD. AND REFER TO S105, LEDGER DETAIL	DTT1Z		
STAIR STRINGER	LSCZ		
STAIR TREAD	TA TREAD ANGLE		
POST BASE	ABA66Z		
POST CAP	CCT, ECCL, CCC		
FLOOR/DECK JOISTS			
JOIST HANGER (DIMENSIONAL LUMBER)	LUC 2102		
JOIST HANGER (TJI)	I ITT		
MULTI LVL HANGER	EGQ		
ROOF RAFTERS			
RAFTER TO PLATE	REFER TO ROOF UPLIFT DETAIL		
	5217112		
HIP BEAM TO PLATE	HCP		

Michael Piccirillo Architecture

DO NOT SCALE DRAWINGS. REFER TO WRITTEN

MEASUREMENTS FOR ACCURANCY, OR CONTACT ARCHITECT

CONTACT ARCHITECT IF THERE ARE ANY DISCECPENCIES.

DRAWING IS A VIOLATION OF NEW YORK STATE EDUCATION

© Copyright 2020 MICHAEL PICCIRILLO ARCHITECTURE

No. DATE: 1 2/28/22 ISSUED

PROJECT NAME: SINGLE FAMILY HOUSE

PROJECT ADDRESS: 25 ORCHARD DRIVE ARMONK, NY



MICHAEL A PICCIRILLO, AIA 345 KEAR STREET


YORKTOWN HEIGHTS, NEW YORK TELEPHONE: 914-368-9838 FACSIMILE: 914-368-9839 michael@mpiccirilloarchitect.com


www.mpiccirilloarchitect.com


FRAMING NOTES **DETAILS**

Issue Date Drawn by Author S105 Checked by Checker Project number

BEAM/POST

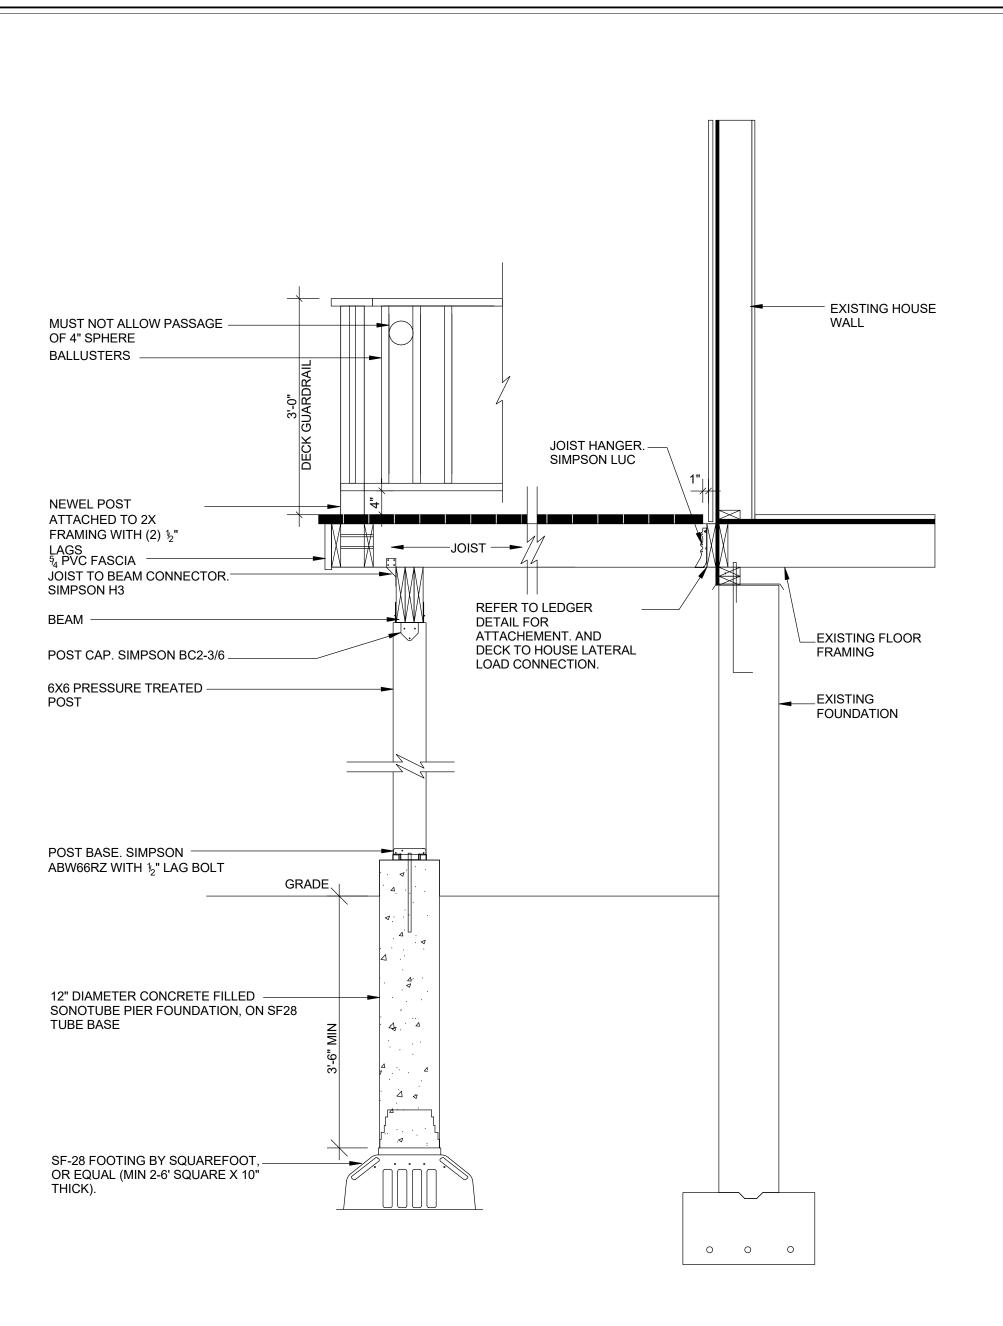

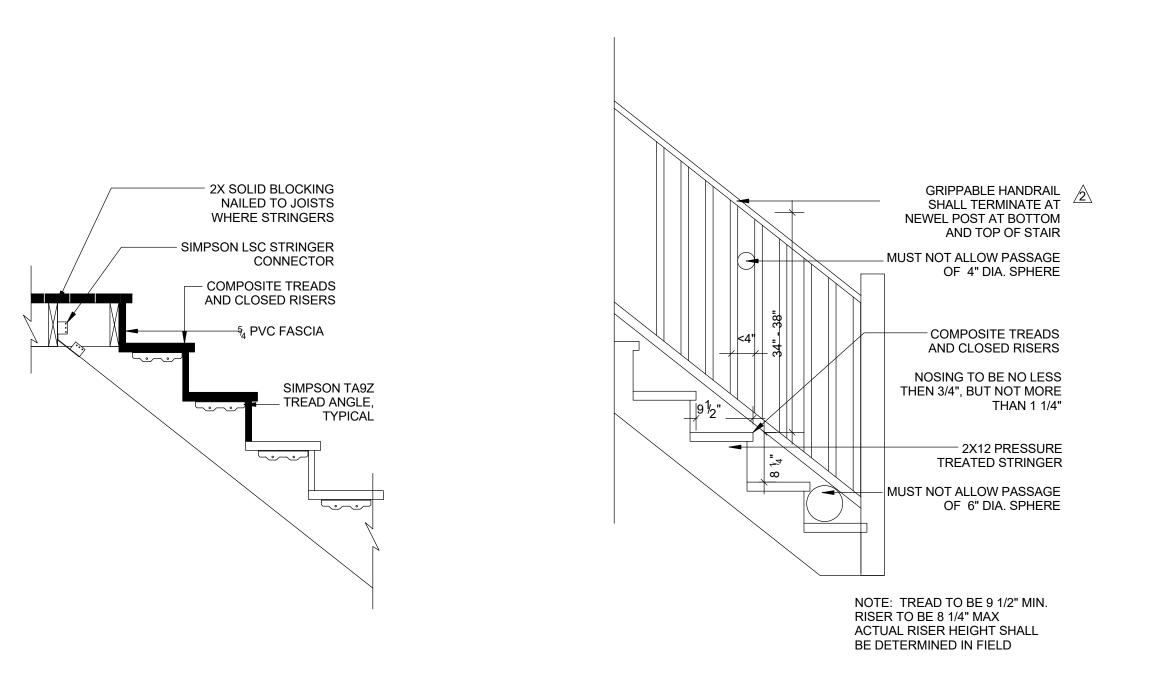

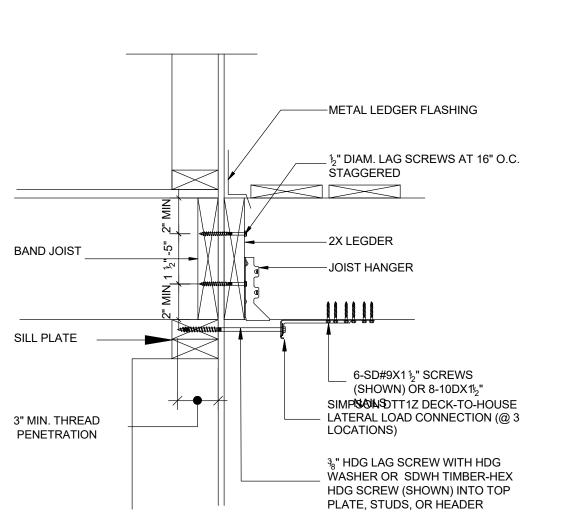



DO NOT SCALE DRAWINGS. REFER TO WRITTEN MEASUREMENTS FOR ACCURANCY, OR CONTACT ARCHITECT. CONTACT ARCHITECT IF THERE ARE ANY DISCECPENCIES. UNAUTHORIZED ALTERATIONS OR ADDITIONS TO THIS DRAWING IS A VIOLATION OF NEW YORK STATE EDUCATION LAW.

© Copyright 2020 MICHAEL PICCIRILLO ARCHITECTURE

 No.
 DATE:
 ISSUE:

 1
 2/28/22
 ISSUED

PROJECT NAME: SINGLE FAMILY HOUSE

PROJECT ADDRESS: 25 ORCHARD DRIVE ARMONK, NY




MICHAEL A PICCIRILLO, AIA


345 KEAR STREET YORKTOWN HEIGHTS, NEW YORK

TELEPHONE: 914-368-9838 FACSIMILE: 914-368-9839 michael@mpiccirilloarchitect.com www.mpiccirilloarchitect.com

DECK DETAILS

Scale	Date
	Issue Date
Drawn by	
Author	
Checked by	C1051
Checker	3103.1
Project number	

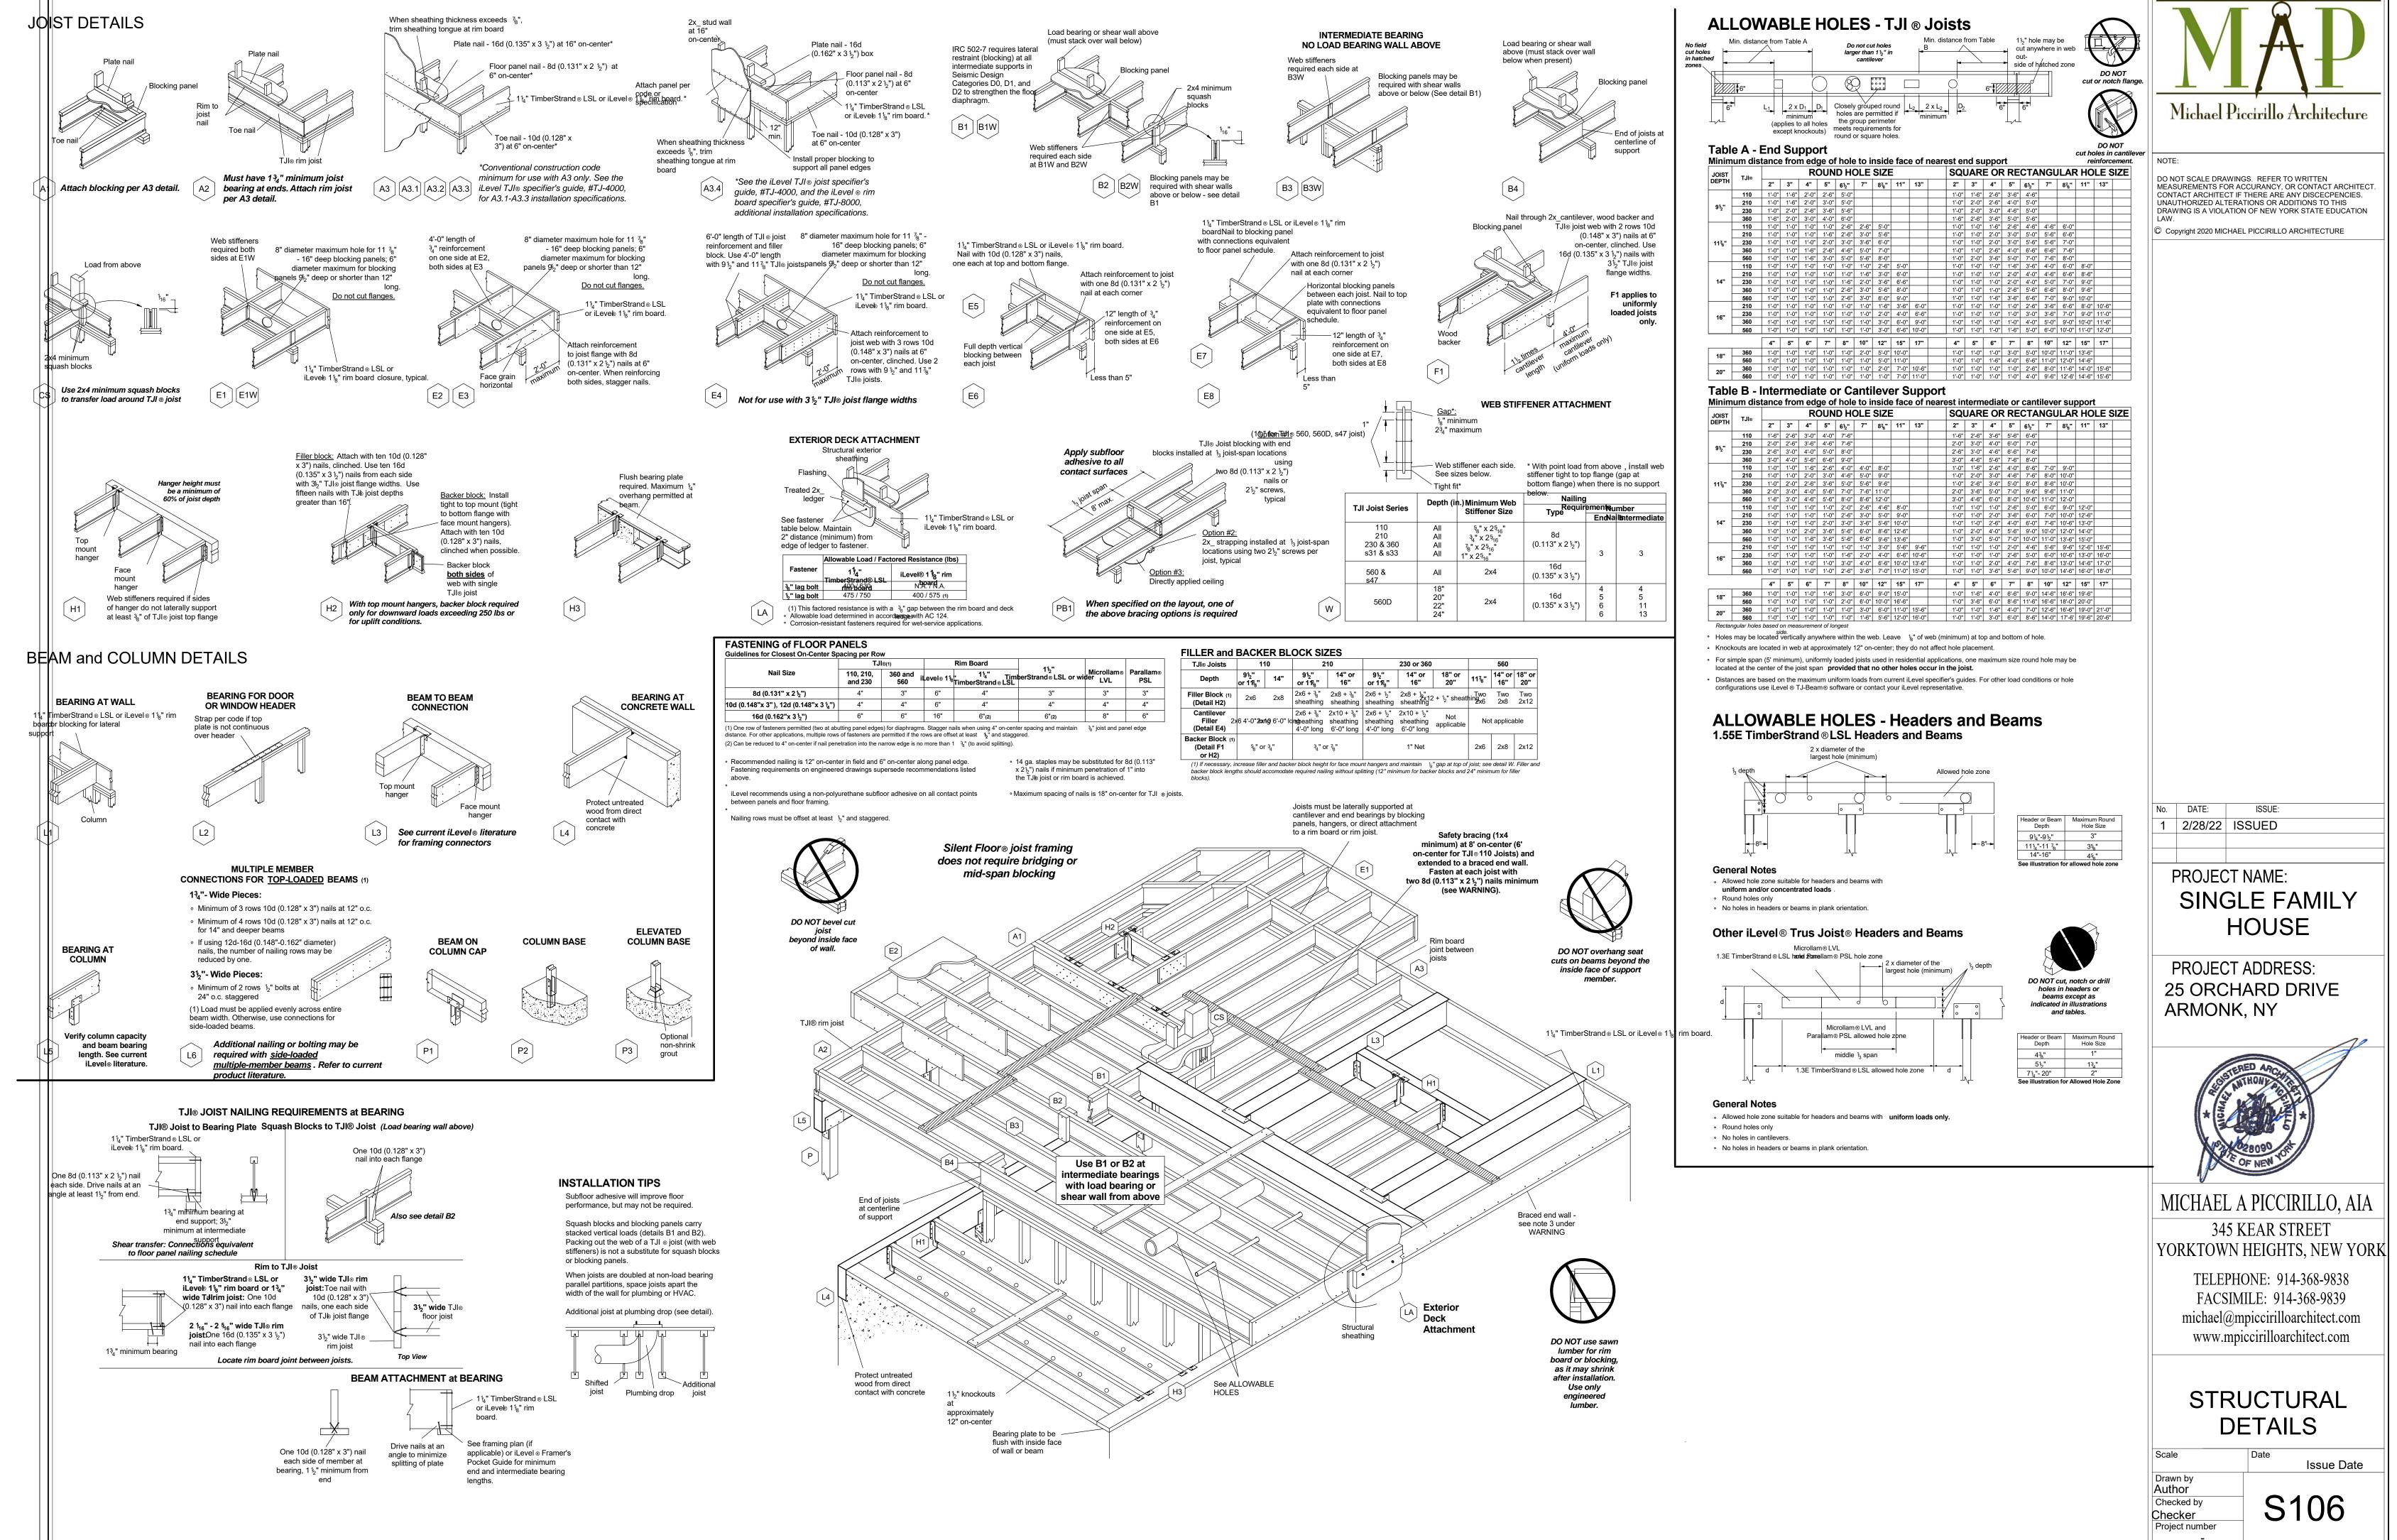

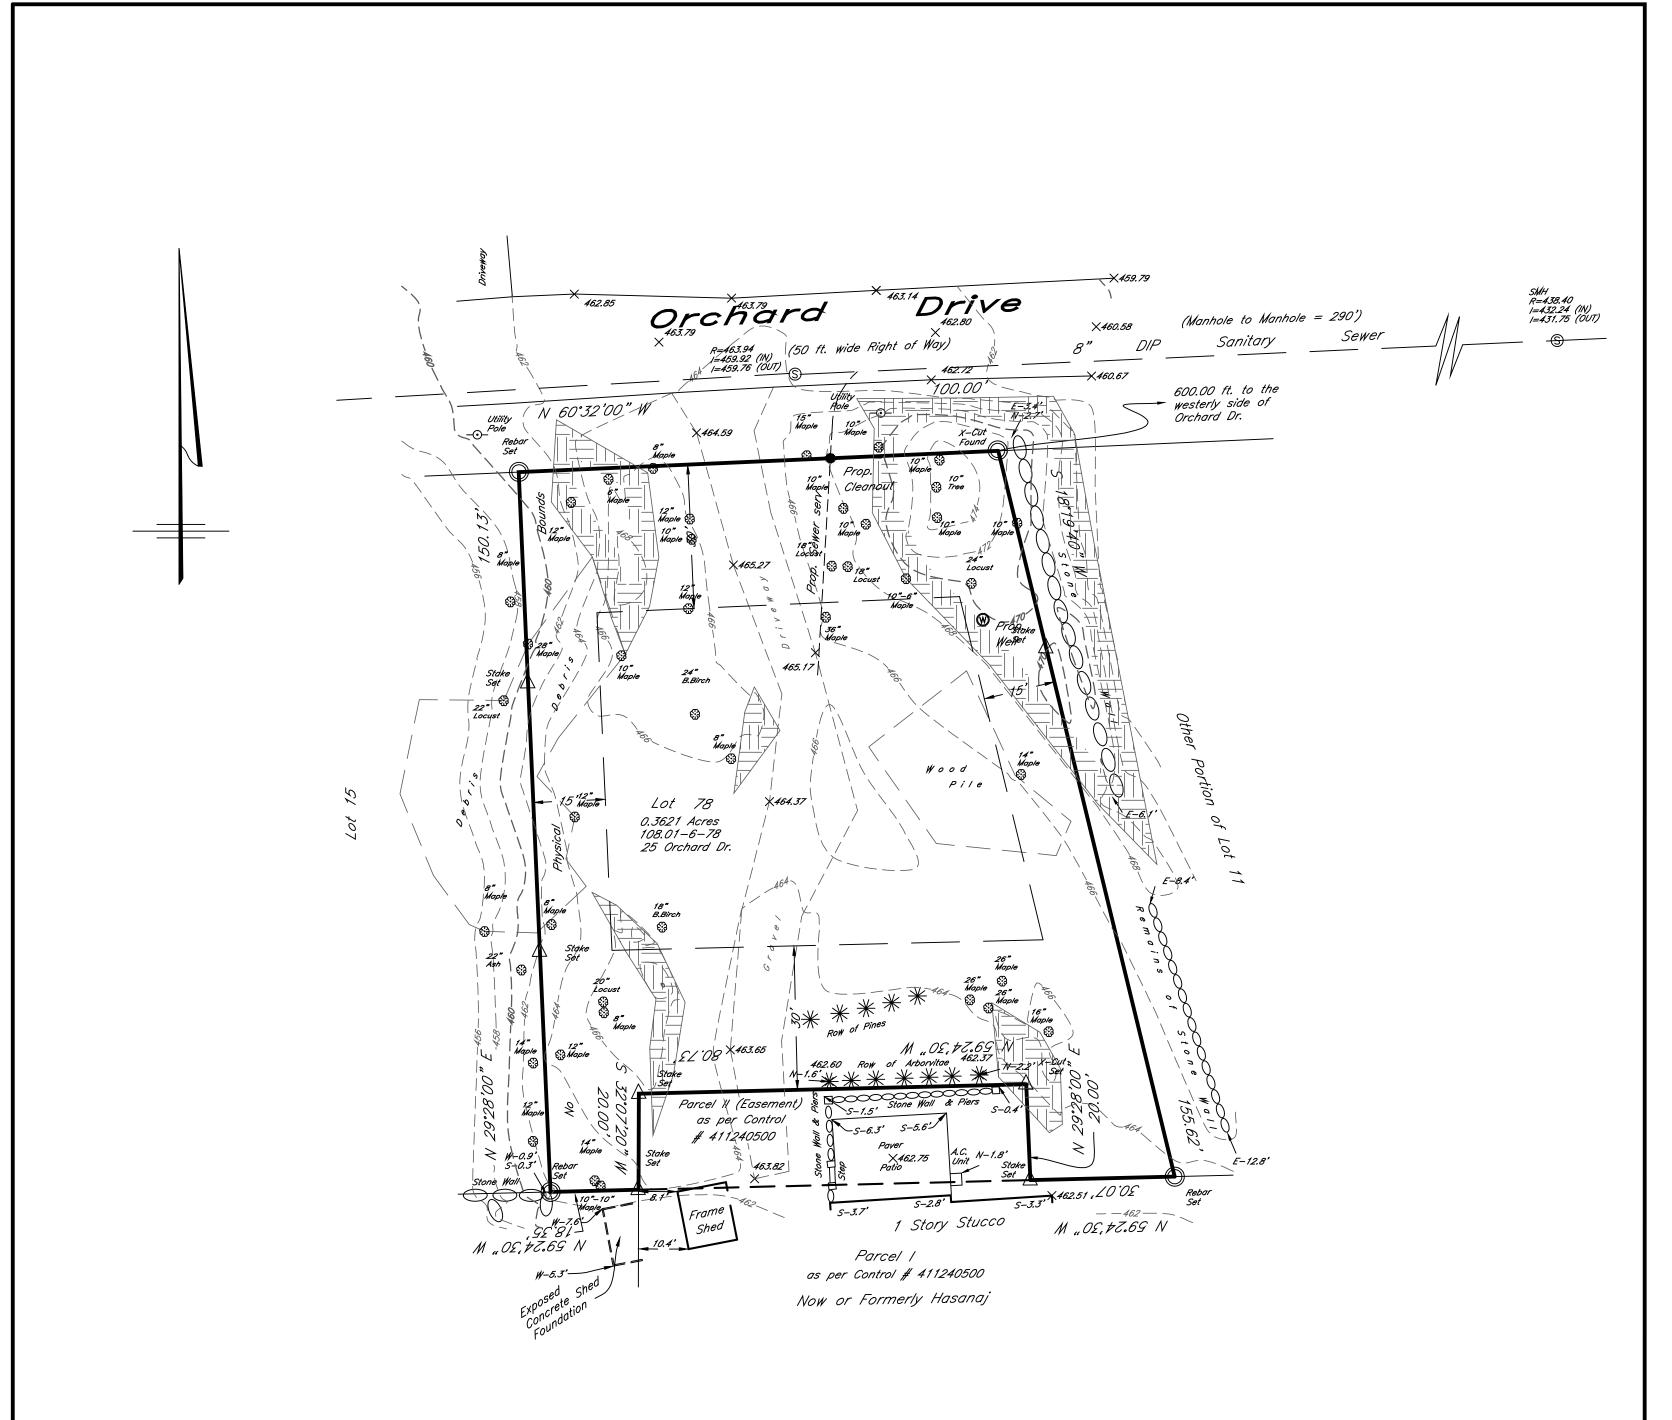

Survey of Property prepared for

Damien Development LLC

in the Town of

North Castle

Westchester County, N.Y. Scale 1"=20' Aug. 23, 2018

Revised lot area and rear property line Feb. 28, 2022.

The premises being Lot 13 and a portion of Lot 11 as shown on a map entitled "Subdivision Map of the Oak Tree Farm Development at Armonk" dated Nov. 29, 1929 and filed Dec. 13, 1929 as County Clerk Map No. 3542.

Area (Before) = 17,397 sq. ft. or 0.3994 acres Area (After) = 15,774 sq. ft. or 0.3621 acres

Vertical Datum: NAVD88

Subsurface structures and their encroachments, if any exist, are not shown hereon.

"Unauthorized alterations or additions to a survey map is a violation of section 7209, sub-division 2, of the New York State Education Law."

"Only copies of the original survey marked with the land surveyor's inked or embossed seal shall be considered a true and valid copy ."

Copyright (c) 2022 Ward Carpenter Engineers, Inc. All Rights Reserved.

"Certifications indicated hereon signify that this survey was prepared in accordance with the existing code of practice for Land Surveys adopted by the New York State Association of Professional Land Surveyors. Said certifications shall run to the person for whom the survey is prepared only, and on his behalf to the Title Company, governmental agency and lending institution listed hereon, and to the assignees of the lending institution. CERTIFICATIONS ARE NOT TRANSFERABLE TO ADDITIONAL INSTITUTIONS OR SUBSEQUENT OWNERS."

WardCarpenterEngineersInc.
76 Mamaroneck Avenue
White Plains, N.Y. 10601



TOWN OF NORTH CASTLE

WESTCHESTER COUNTY 17 Bedford Road Armonk, New York 10504-1898

PLANNING DEPARTMENT Adam R. Kaufman, AICP Director of Planning

January 29, 2019 Telephone: (914) 273-3542 Fax: (914) 273-3554 www.northcastleny.com

FLOOR AREA CALCULATIONS WORKSHEET

Applica	tion Name or Identifying Title:	Date:	
Tax Ma	p Designation or Proposed Lot No.:		
Floor A	<u>rea</u>		
1.	Total Lot Area (Net Lot Area for Lots Created After 12/13/06):	-	15,774
2.	Maximum permitted floor area (per Section 355-26.B(4)):	-	4,866.1
3.	Amount of floor area contained within first floor: o existing +1600 proposed =		1,600
4.	Amount of floor area contained within second floor: o existing + proposed =		2,097
5. _	Amount of floor area contained within garage: existing + 667 proposed =		667
6. -	Amount of floor area contained within porches capable of being enclosed: existing + proposed =		191.5
7. -	Amount of floor area contained within basement (if applicable – see definition): existing + NA proposed =		0
8. -	Amount of floor area contained within attic (if applicable – see definition): existing + NA proposed =		0
9. -	Amount of floor area contained within all accessory buildings: o existing proposed		0
10. Pro	posed flynching TWOW of thes 9=		4,555.5
and the	10 is less than dredut to the 2 year proposal complies with the Town's maximus project may project discount to the project Review Committee for review. If Line oposal does not complete the Toyn's regulations.		
<u>a.</u>	OF NEW 2	-28-2	2
Signatur	re and Seal of Professional Preparing Worksheet Da	ate	




TOWN OF NORTH CASTLE

WESTCHESTER COUNTY 17 Bedford Road Armonk, New York 10504-1898

BUILDING DEPARTMENT Robert Melillo Building/ Fire inspector

Telephone: (914) 273-3000 ext. 44 Fax: (914) 273-3554 www.northcastleny.com

GROSS LAND COVERAGE CALCULATIONS WORKSHEET				
	tion Name or Identifying Title: DAMIAN DEVELOPMENT LLC	Date: <u>2-28-2</u> 022		
Tax Ma	p Designation or Proposed Lot No.: 108.01-6-78			
Gross L	ot Coverage			
1.	Total lot Area (Net Lot Area for Lots Created After 12/13/06):	15,774		
2.	Maximum permitted gross land coverage (per Section 355-26.C(1)(b)):	5,339		
3.	BONUS maximum gross land cover (per Section 355-26.C(1)(b)):			
	Distance principal home is beyond minimum front yard setback x 10 =			
4.	TOTAL Maximum Permitted gross land coverage = Sum of lines 2 and 3	5,339		
5.	Amount of lot area covered by principal building: existing +	2,296		
6.	Amount of lot area covered by accessory buildings: existing + proposed =			
7.	Amount of lot area covered by decks: existing +	423		
8.	Amount of lot area covered by porches: existing + proposed =	274		
9.	Amount of lot area covered by driveway , parking areas and walkways: existing + proposed =	1,508		
10.	Amount of lot area covered by terraces: existing + proposed =			
11.	Amount of lot area covered by tennis court, pool and mechanical equip: existing + 3 proposed =	736		
12.	Amount of lot area covered by all other structures: existing + proposed =	92		
13.	Proposed gross land coverage: Total of Lines $5 - 12 =$	5,329		
If Line 13 is less than or equal to Line 4, your proposal complies with the Town's maximum gross land coverage regulations and the project may proceed to the Residential Project Review Committee for review. If Line 13 is greater than Line 4 your proposal does not comply with the Town's regulations, GE MAS Signature and Seal of Professional Preparing Worksheet Date				
Signature and Sear of Fidessional repaining worksheet				

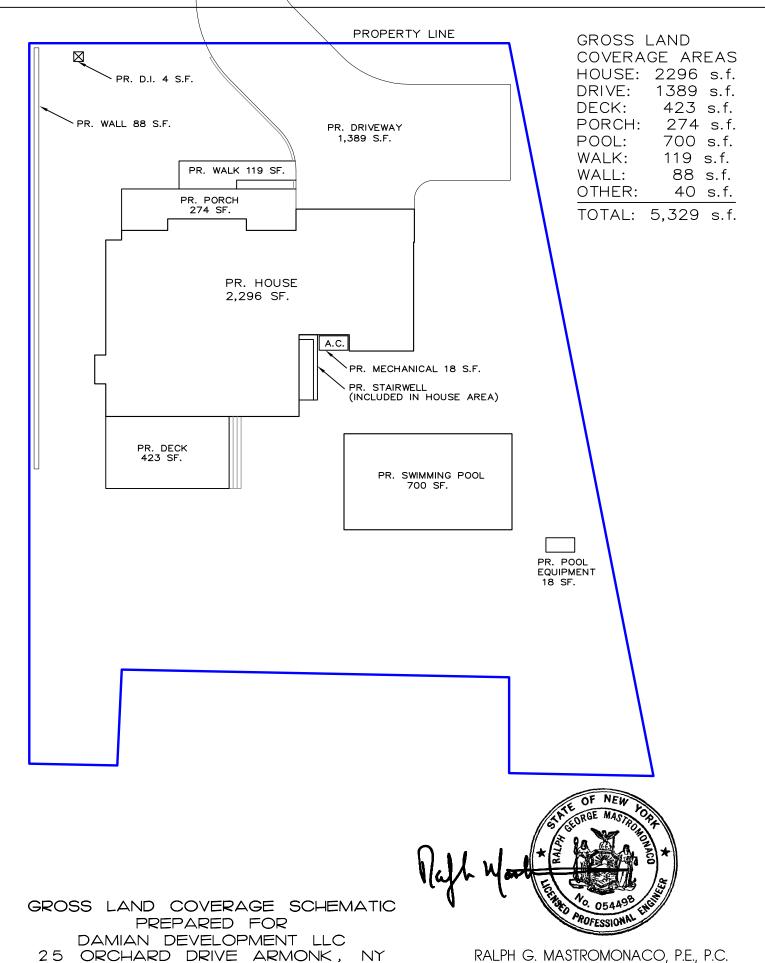

FEBRUARY 28, 2022

RALPH G. MASTROMONACO, P.E., P.C. Consulting Engineers 13 Dove Court, Croton-on-Hudson, New York 10520 (914) 271-4762 (914) 271-2820 Fax

