



# TOWN OF NORTH CASTLE

WESTCHESTER COUNTY  
17 Bedford Road  
Armonk, New York 10504-1898

RESIDENTIAL PROJECT  
REVIEW COMMITTEE  
Adam R. Kaufman AICP, Chair

Telephone: (914) 273-3000 x 43  
Fax: (914) 273-3554  
www.nortcastleny.com

## RESIDENTIAL PROJECT REVIEW COMMITTEE (RPRC) APPLICATION

### Section I- PROJECT

ADDRESS: 246 BEDFORD BANKSVILLE ROAD

### Section III- DESCRIPTION OF WORK:

Proposed in-ground pool, new patio and new prefabricated pergola

### Section III- CONTACT INFORMATION:

APPLICANT: HAYNES ARCHITECTURE PC- Thomas Haynes

ADDRESS: 287 Bowman Ave Suite 208 Purchase NY 10577

PHONE: 914-963-3838 MOBILE: \_\_\_\_\_ EMAIL: TJ@haynesdesigngroup.com

PROPERTY OWNER:

Madalyn Stillman

ADDRESS: 246 Bedford Banksville Road Bedford NY 10506

PHONE: 914-318-4394 MOBILE: \_\_\_\_\_ EMAIL: maddy1998@aol.com

PROFESSIONAL: HAYNES ARCHITECTURE PC- Thomas Haynes

ADDRESS: 287 Bowman Ave Suite 208 Purchase NY 10577

PHONE: 914-963-3838

MOBILE: \_\_\_\_\_

EMAIL: TJ@haynesdesigngroup.com

### Section IV- PROPERTY INFORMATION:

Zone: R-2A Tax ID (lot designation) 95.03-2-50



**Town of North Castle  
Residential Project Review Committee**

17 Bedford Road Armonk, New York 10504  
(914) 273-3542 (914) 273-3554 (fax)

**RPRC COMPLETENESS REVIEW FORM**

*This form represents the standard requirements for a completeness review for all Residential Project Review Committee submissions. Failure to provide all of the information requested will result in a determination that the application is incomplete.*

Project Name on Plan:

Initial Submittal  Revised Preliminary

Street Location:

Zoning District: \_\_\_\_\_ Property Acreage: \_\_\_\_\_ Tax Map Parcel ID: \_\_\_\_\_

Date: \_\_\_\_\_

**DEPARTMENTAL USE ONLY**

Date Filed: \_\_\_\_\_ Staff Name: \_\_\_\_\_

**Preliminary Plan Completeness Review Checklist**

Items marked with a "☒" are complete, items left blank "☐" are incomplete and must be completed, "NA" means not applicable.

- 1. Plan prepared by a registered architect or professional engineer
- 2. Aerial photo (Google Earth) showing the applicant's entire property and adjacent properties and streets
- 3. Map showing the applicant's entire property and adjacent properties and streets
- 4. A locator map at a convenient scale
- 5. The proposed location, use and design of all buildings and structures
- 6. Existing topography and proposed grade elevations
- 7. Location of drives
- 8. Location of all existing and proposed site improvements, including drains, culverts, retaining walls and fences

**RPRC COMPLETENESS REVIEW FORM**

Page 2

- 9. Description of method of water supply and sewage disposal and location of such facilities
- 10. The name and address of the applicant, property owner(s) if other than the applicant and of the planner, engineer, architect, surveyor and/or other professionals engaged to work
- 11. Submission of a Zoning Conformance Table depicting the plan's compliance with the minimum requirements of the Zoning District
- 12. If a tree removal permit is being sought, submission of a plan depicting the location and graphical removal status of all Town-regulated trees within the proposed area of disturbance. In addition, the tree plan shall be accompanied by a tree inventory includes a unique ID number, the species, size, health condition and removal status of each tree.
- 13. If a wetlands permit is being sought, identification of the wetland and the 100-foot wetland buffer.

More information about the items required herein can be obtained from the North Castle Planning Department. A copy of the Town Code can be obtained from Town Clerk or on the North Castle homepage: <http://www.northcastleny.com/townhall.html>

\_\_\_\_\_ On this date, all items necessary for a technical review of the proposed site plan have been submitted and constitute a COMPLETE APPLICATION.



TOWN OF NORTH CASTLE  
WESTCHESTER COUNTY  
17 Bedford Road  
Armonk, New York 10504-1898

PLANNING DEPARTMENT  
Adam R. Kaufman, AICP  
Director of Planning

Telephone: (914) 273-3542  
Fax: (914) 273-3554  
[www.northcastleny.com](http://www.northcastleny.com)

### GROSS LAND COVERAGE CALCULATIONS WORKSHEET


Application Name or Identifying Title: 246 Bedford Banksville Road Date: 04-21-2022

Tax Map Designation or Proposed Lot No.: 95.03-2-50

#### Gross Lot Coverage

1. Total lot Area (Net Lot Area for Lots Created After 12/13/06): 87,460.10 SF.
2. **Maximum** permitted gross land coverage (per Section 355-26.C(1)(b)): 13,295.50 SF.
3. **BONUS** maximum gross land cover (per Section 355-26.C(1)(b)):  
Distance principal home is beyond minimum front yard setback  
152.38' x 10 = \_\_\_\_\_ 1,523.80 SF.
4. **TOTAL Maximum Permitted gross land coverage** = Sum of lines 2 and 3 14,819.3 SF.
5. Amount of lot area covered by **principal building**:  
2,737.86 existing + 0 proposed = 2,737.86 SF.
6. Amount of lot area covered by **accessory buildings**:  
0 existing + 352 proposed = 352.0 SF.
7. Amount of lot area covered by **decks**:  
0 existing + 0 proposed = 0
8. Amount of lot area covered by **porches**:  
0 existing + 0 proposed = 0
9. Amount of lot area covered by **driveway, parking areas and walkways**:  
6,287.03 existing + 0 proposed = 6,287.03 SF.
10. Amount of lot area covered by **terraces**:  
0 existing + 0 proposed = 0
11. Amount of lot area covered by **tennis court, pool and mechanical equip**:  
0 existing + 903.42 proposed = 903.42 SF.
12. Amount of lot area covered by **all other structures**:  
1,933.53 existing + 1,766.26 proposed = 4,399.79SF.
13. Proposed **gross land coverage**: Total of Lines 5 – 12 = 14,680.10 SF.

If Line 13 is less than or equal to Line 4, your proposal **complies** with the Town's maximum gross land coverage regulations and the project may proceed to the Residential Project Review Committee for review. If Line 13 is greater than Line 4 your proposal does not comply with the Town's regulations.

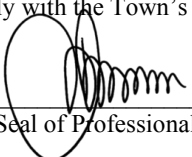  
\_\_\_\_\_  
Signature and Seal of Professional Preparing Worksheet

04-21-2022  
Date



**TOWN OF NORTH CASTLE**  
**WESTCHESTER COUNTY**  
 17 Bedford Road  
 Armonk, New York 10504-1898

**PLANNING DEPARTMENT**  
**Adam R. Kaufman, AICP**  
**Director of Planning**

January 29, 2019  
 Telephone: (914) 273-3542  
 Fax: (914) 273-3554  
[www.northcastleny.com](http://www.northcastleny.com)

**NO CHANGE TO EXISTING FLOOR AREA -NO PROPOSED WORK TO EXISTING DWELLING**  
**FLOOR AREA CALCULATIONS WORKSHEET**

Application Name or Identifying Title: 246 BEDFORD BANKSVILLE RD. Date:04-21-2022

Tax Map Designation or Proposed Lot No.: 95.03-2-50

Floor Area

1. Total Lot Area (Net Lot Area for Lots Created After 12/13/06): \_\_\_\_\_
2. **Maximum** permitted floor area (per Section 355-26.B(4)): \_\_\_\_\_
3. Amount of floor area contained within first floor:  
 - \_\_\_\_\_ existing + \_\_\_\_\_ proposed = \_\_\_\_\_
4. Amount of floor area contained within second floor:  
 - \_\_\_\_\_ existing + \_\_\_\_\_ proposed = \_\_\_\_\_
5. Amount of floor area contained within garage:  
 - \_\_\_\_\_ existing + \_\_\_\_\_ proposed = \_\_\_\_\_
6. Amount of floor area contained within porches capable of being enclosed:  
 - \_\_\_\_\_ existing + \_\_\_\_\_ proposed = \_\_\_\_\_
7. Amount of floor area contained within basement (if applicable – see definition):  
 - \_\_\_\_\_ existing + \_\_\_\_\_ proposed = \_\_\_\_\_
8. Amount of floor area contained within attic (if applicable – see definition):  
 - \_\_\_\_\_ existing + \_\_\_\_\_ proposed = \_\_\_\_\_
9. Amount of floor area contained within all accessory buildings:  
 - \_\_\_\_\_ existing + \_\_\_\_\_ proposed = \_\_\_\_\_
10. Proposed **floor area**: Total of Lines 3 – 9 = \_\_\_\_\_


If Line 10 is less than or equal to Line 2, your proposal **complies** with the Town's maximum floor area regulations and the project may proceed to the Residential Project Review Committee for review. If Line 10 is greater than Line 2 your proposal does not comply with the Town's regulations.

\_\_\_\_\_  
 Signature and Seal of Professional Preparing Worksheet

\_\_\_\_\_  
 Date





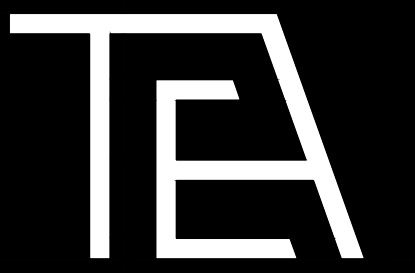

HAYNES ARCHITECTURE P.C.

570 yonkers ave. yonkers, ny 10704

p: 914.963.3838 f: 914.963.3861
e: info@haynesdesigngroup.com

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revisions:

Table with 2 columns: No., Description. Multiple empty rows for revisions.


project title:

Proposed In-ground, Pergola, Pool and Patio at:
246 BEDFORD BANKSVILLE RD.
Bedford, New York

PLOT PLAN/ SITE WORK

Professional seal and signature of Architect Thomas E. Haynes, dated 03-29-2022. Includes fields for original filing date, drawn by, checked by, and drawing no.

2181 SP.01

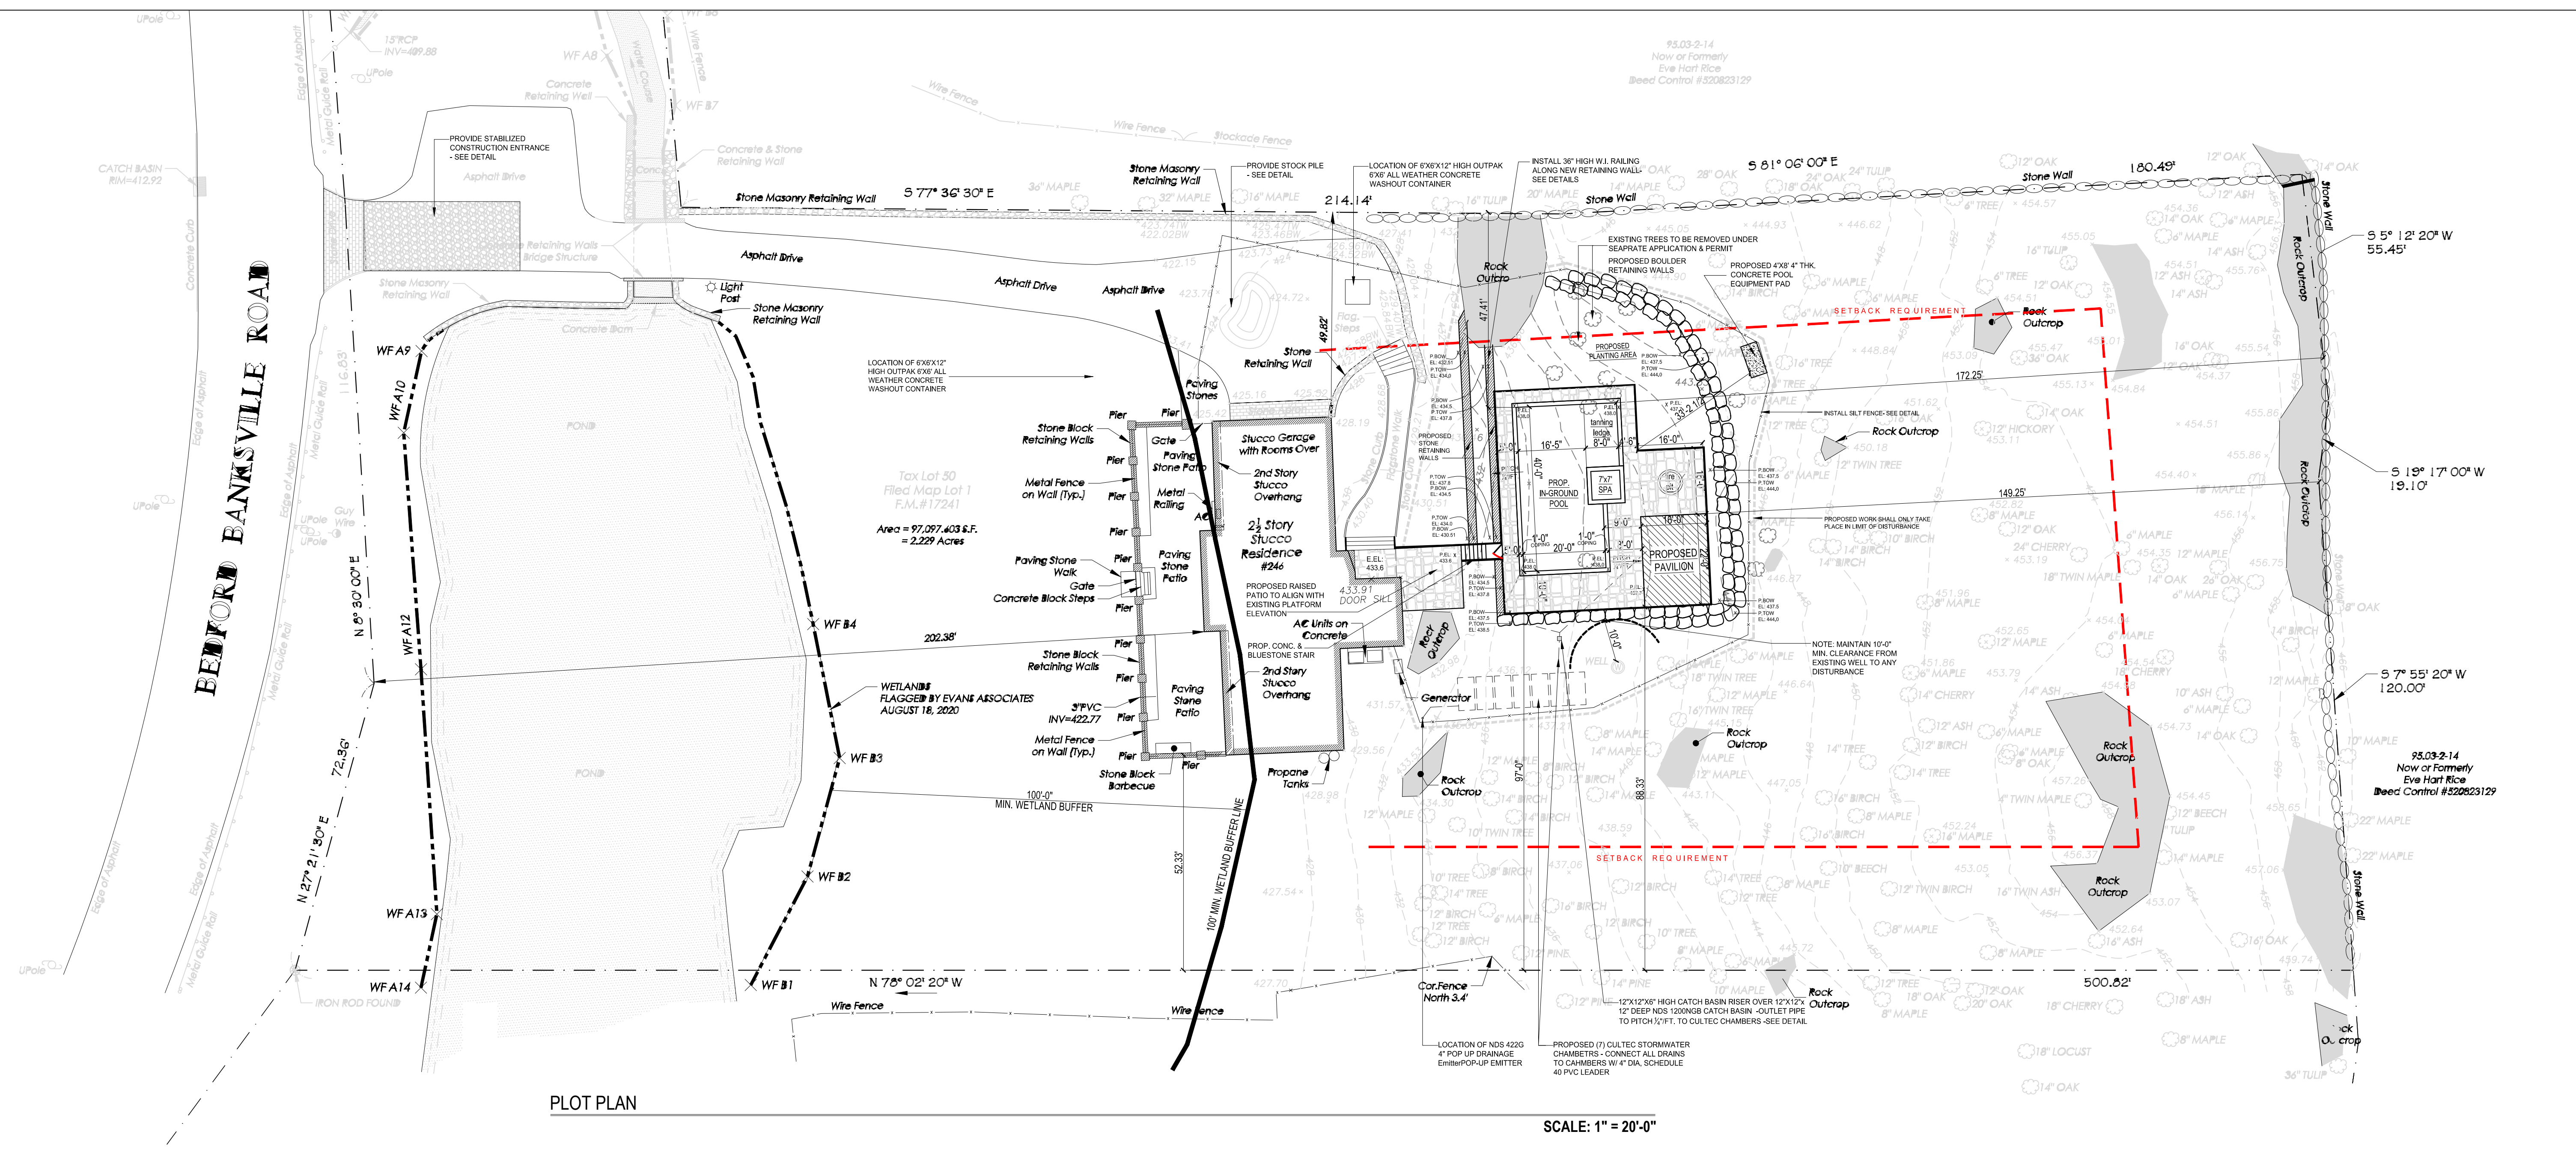

PLOT PLAN

SCALE: 1" = 20'-0"

ZONING ANALYSIS:

Zoning analysis table with sections: GENERAL INFORMATION, USE REQUIREMENTS, LOT/ BULK REQUIREMENTS, MAXIMUM DIMENSIONAL REQUIREMENTS.

NOTE: ALL MATERIAL STORED ON SITE FOR PROPOSED WORK SHALL BE STORED ON EXISTING DRIVEWAY OR GARAGE

-NO MATERIALS SHALL BE STORED IN CLOSE PROXIMITY TO EXISTING TREES
-NO TREES SHALL BE REMOVED, ALTERED OR DESTROYED DURING DURATION OF CONSTRUCTION UNDER THIS APPLICATION
\*SEPARATE APPLICATION TO BE FILED FOR TREE REMOVAL

NOTE: ALL PROPOSED CULTEC UNITS TO MAINTAIN 10'-0" MIN. FROM ALL PROPERTY LINES AND STRUCTURES

NOTE: INSTALL SILT FENCE AROUND CONSTRUCTION AREA AS REQ. - SEE DETAIL

NOTE: NEW HANDRAILS TO BE 36" HIGH AND HANDRAIL WITH BALUSTERS SPACED LESS THAN 4" CLEAR
-RAILING TO BE CONTINUOUS -WHERE HANDRAIL IS WALL MOUNTED, IT IS TO BE 36" HIGH AND 1.5" OFF WALL AND 1.5" DIAMETER-HANDRAILS TO IN COMPLIANCE W/ R311.7.8
-INSTALL AT ALL NEW STAIR LOCATIONS AS REQUIRED/ SHOWN


NOTE: CONTRACTOR TO FIELD VERIFY EXISTING CONDITIONS AND COORDINATE ACTUAL NUMBER OF RISERS/ TREADS FOR ALL NEW STAIRS AS PER CODE REQUIREMENTS / EXISTING CONDITIONS
-TREADS AND RISERS: THE MAXIMUM RISER HEIGHT SHALL BE 8 1/4 INCHES AND THE MINIMUM TREAD DEPTH SHALL BE 9 INCHES. THE RISER HEIGHT SHALL BE MEASURED VERTICALLY BETWEEN LEADING EDGES OF THE ADJACENT TREADS. THE TREAD DEPTH SHALL BE MEASURED HORIZONTALLY BETWEEN THE VERTICAL PLANES OF THE FOREMOST PROJECTION OF ADJACENT TREADS AND AT A RIGHT ANGLE TO THE TREAD'S LEADING EDGE. THE WALKING SURFACE OF TREADS AND LANDINGS OF A STAIRWAY SHALL BE SLOPED NO STEEPER THAN ONE UNIT VERTICAL IN 48 UNITS HORIZONTAL. THE GREATEST RISER HEIGHT WITHIN ANY FLIGHT OF STAIRS SHALL NOT EXCEED THE SMALLEST BY MORE THAN 3/8 INCH. THE GREATEST TREAD DEPTH WITHIN ANY FLIGHT OF STAIRS SHALL NOT EXCEED THE SMALLEST BY MORE THAN 3/8 INCH.

NOTE: POOL MUST BE EQUIPPED WITH AN APPROVED TYPE POOL ALARM WHICH IS CAPABLE OF DETECTING A CHILD ENTERING THE WATER AND GIVING AN AUDIBLE ALARM WHEN IT DETECTS A CHILD ENTERING THE WATER...
(1) Said pool may be installed or maintained in any residential district or in any nonresidential district where specifically permitted.
(2) Said pool shall be used as an accessory use to a dwelling or group of dwellings or as part of the recreational facilities of a camp, club or similar use.
(3) When accessory to a single-family residence, such pool shall be located in a rear yard only.
(4) The portion of the premises upon which such pool is located shall be entirely surrounded and enclosed with a good quality security fence which shall have a height of not less than four feet, notwithstanding any other provisions of this chapter. Said fence shall be of a type approved by the Building Inspector. All enclosures shall have railings and posts within the enclosure which shall be capable of resisting a minimum lateral load of 150 pounds applied midway between the posts and at the top of the posts, respectively. Enclosure, fence material or fabric shall be capable of withstanding a concentrated lateral load of 50 pounds applied anywhere between supports on an area 12 inches square, without failure or permanent deformation.
(5) Every gate or other opening in the fence enclosing such pool shall be self-closing and self-latching and shall be kept securely locked at all times when said pool is not in use. The latch handle on every gate shall be located within the enclosure and at least 40 inches above grade and shall be securely locked with a key, combination or other childproof lock sufficient to prevent access to the swimming pool through such gate when the swimming pool is not in use or supervised.
(6) Such pool shall be not located less than 30 feet from the side and 50 feet from rear lot lines. Any patio surrounding such pool shall not be located less than 20 feet from any lot line. Any deck surrounding such pool shall be subject to all the otherwise applicable yard requirements for buildings or structures, as applicable. There shall be no required setback between a pool and any building.
(7) Such pool shall be chemically treated in a manner sufficient to maintain the bacterial standards established by the provisions of the New York State Sanitary Code relating to public swimming pools.
(8) No loudspeaker or amplifying device shall be permitted which can be heard beyond the lot lines of the lot on which said pool is located.
(9) No lighting or spotlighting shall be permitted which will project light rays beyond the lot lines of the lot on which said pool is located.
(10) Such pool shall be equipped with an integral filtration system and filter pumps and other mechanical devices which shall be so located and constructed as not to interfere with the peace, comfort and repose of the occupant of any adjoining property.
(11) No permission shall be granted for the installation of any swimming pool unless the plans thereof meet the minimum Town of Bedford construction requirements. The plans shall show the method of disposal of filter backwash material and the method of draining the pool, and such methods and points of discharge shall be satisfactory to the Town of Bedford Department of Public Works and to the Westchester County Health Department, Division of Environmental Health Services.

DRYWELL CALCULATIONS:
REQUIRED:
REQUIRED INCHES OF RAINFALL: 5.46 INCHES
RUNOFF CURVE NUMBER OF 72 = 2.7 INCHES
5.56 INCHES - 2.7 INCHES
= 2.76 INCHES RAINFALL REQUIRED OR 0.23
PROPOSED:
PROPOSED POOL, PATIOS & PAVILION: 2,805 SQ.FT.
TOTAL INCREASE TO NET IMPERVIOUS SURFACE: 2,787.38 SQ.FT.
X .23 RUNOFF INCH.
= 641.09 CU.FT.
PROVIDED:
(7) CULTEC RECHARGER 330 XL W/ 18" GRAVEL BASE =646.1 CU.FT.
REQUIRED: 641.09 CU.FT.
PROPOSED: 646.1 CU.FT.

NOTE: METHODS OF FILTER BACKWASH MATERIAL DISPOSAL SHALL BE PROVIDED BY STRUCTURAL ENGINEER
NOTE: POOL IS TO BE IN COMPLIANCE WITH ANS/INSP16-SEE ENGINEERS DRAWINGS FOR CERTIFICATION
NOTE: POOL SHALL BE IN COMPLIANCE WITH R326.6 ENTRAPMENT PROTECTION AT POOLS AND SPAS TO PROTECTED AGAINST USER ENTRAPMENT -SEE MANUFACTURER'S DRAWINGS AND/OR SPECS FOR CERTIFICATION



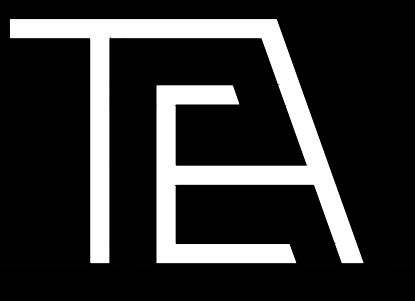

**HAYNES ARCHITECTURE P.C.**

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revisions:


project title:


**Proposed In-ground, Pergola, Pool and  
Patio at:  
246 BEDFORD BANKSVILLE RD.  
Bedford , New York**

COVERAGE ANALYSIS

Seal: Architect Thomas E. Haynes original filing date: 03-29-2022


checked by: \_\_\_\_\_  
drawing no.: \_\_\_\_\_

JOB NUMBER: 2181 SP.02

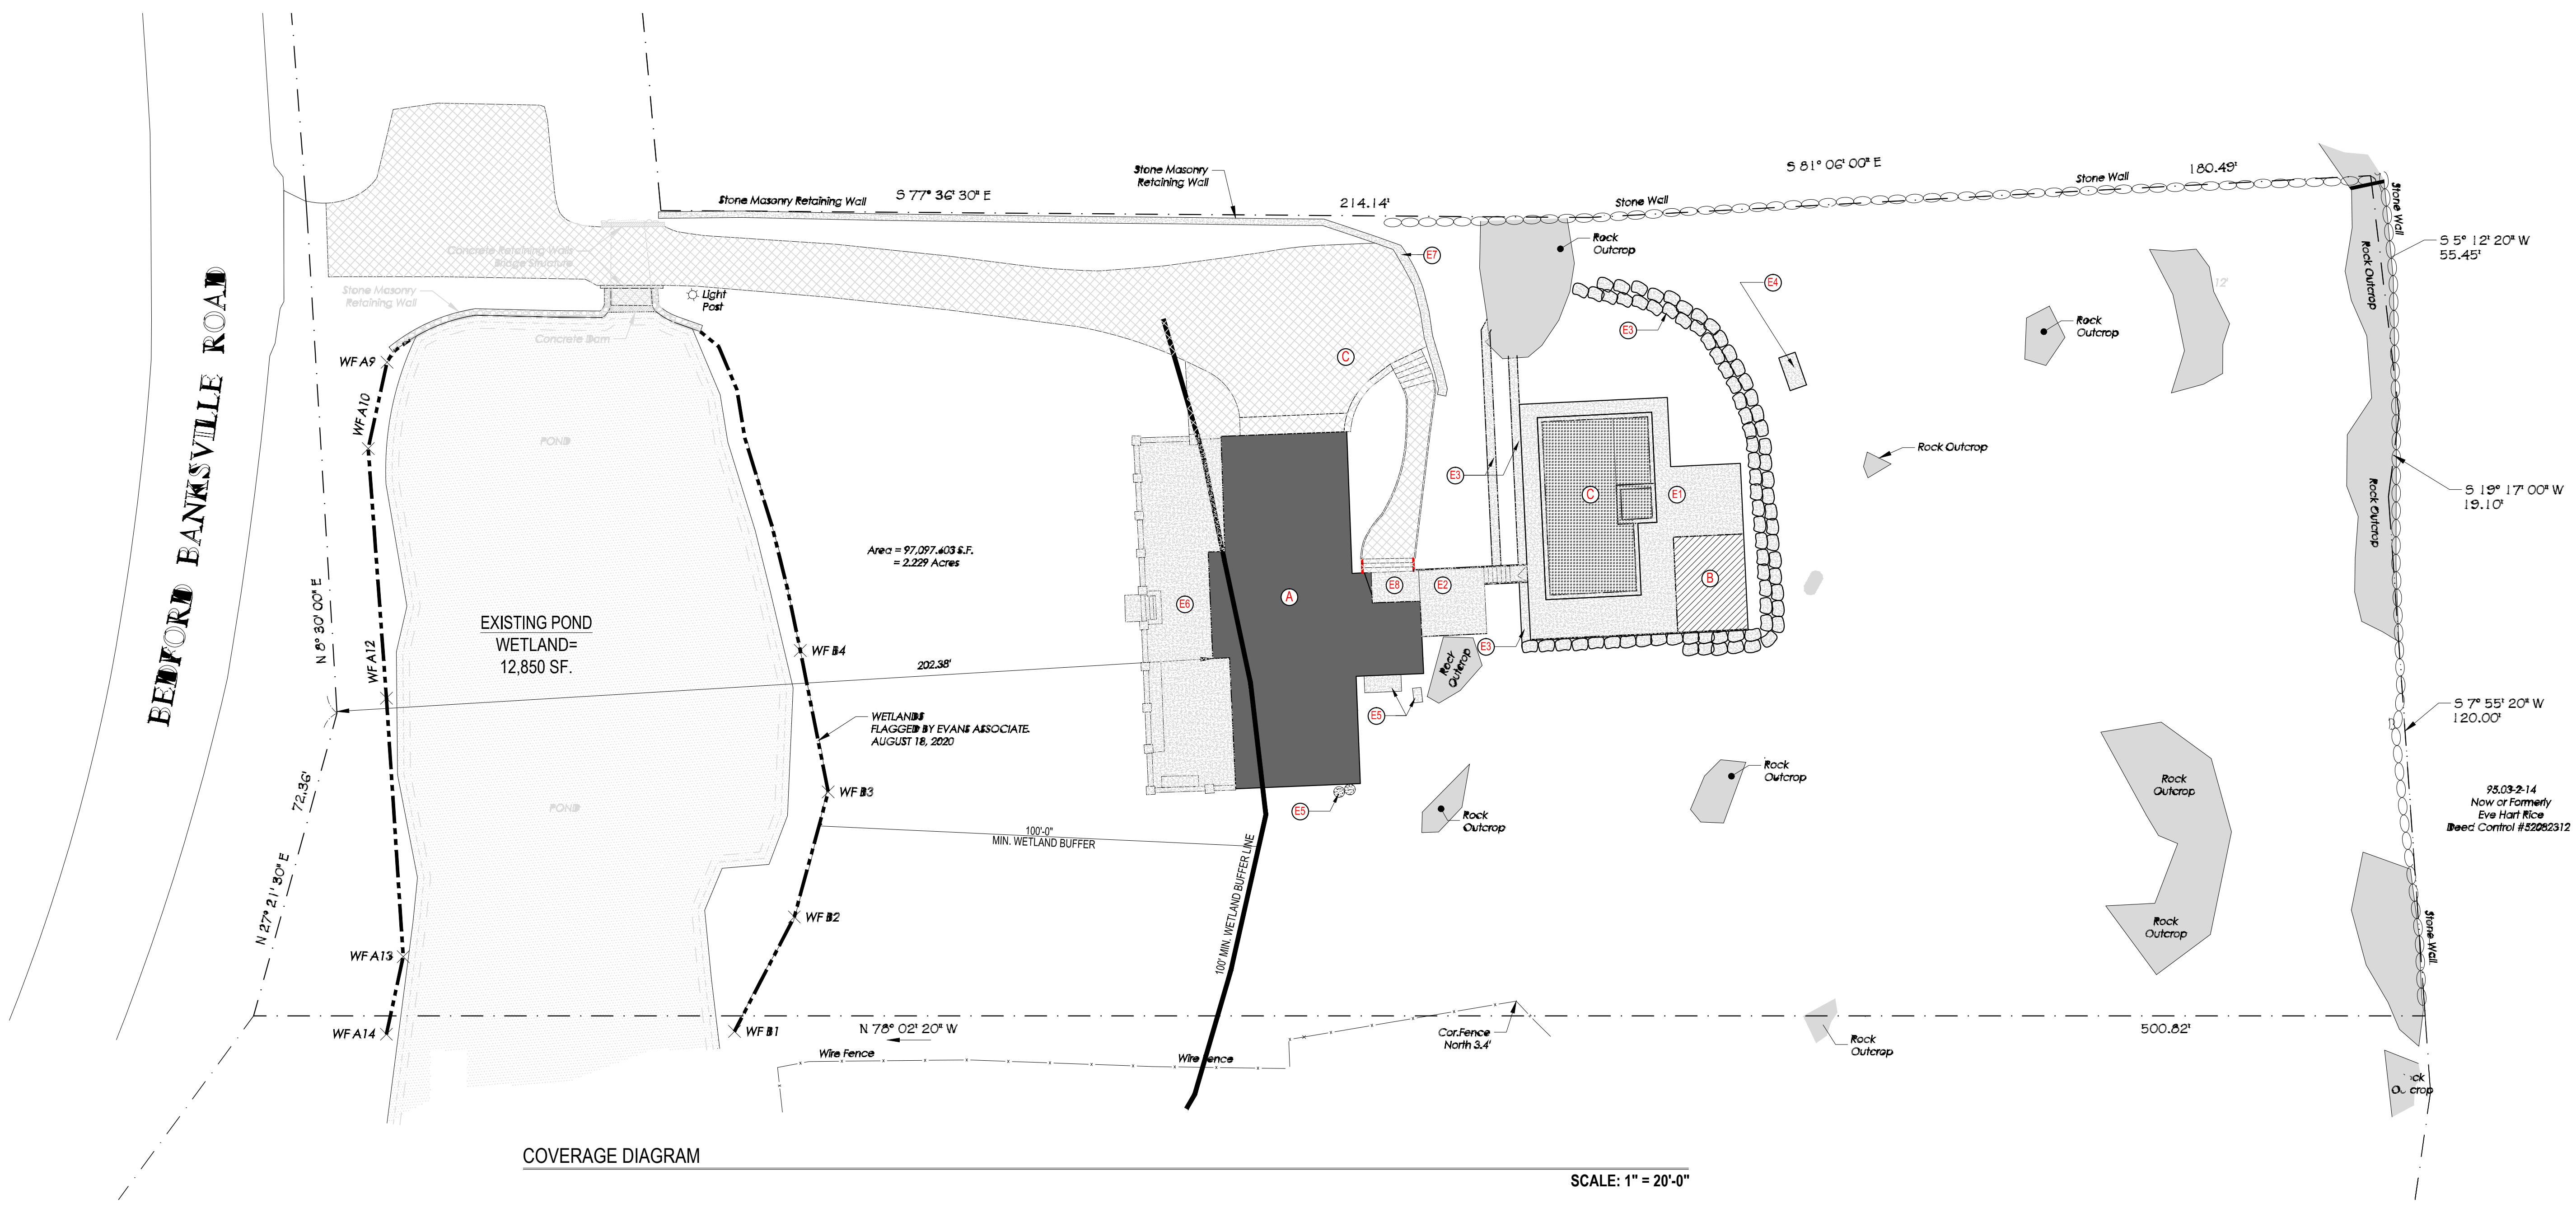


**PROPOSED COVERAGE ANALYSIS:**

TOTAL LOT AREA: 97,097.603			
**TOTAL LOT NET AREA: 87,460.10 SQ.FT.			
COLOR:	ITEM	LABEL	TOTAL
	EXISTING PRINCIPAL BUILDING	(A) 2,737.86 SQ.FT.	2,737.86 SQ.FT.
	PROPOSED ACCESSORY BUILDING (PAVILION)	(B) 352.0 SQ.FT.	352.0 SQ.FT.
	EXISTING DRIVEWAY, PARKING AREA, WALKWAY	(C) 6,287.03 SQ.FT.	6,287.03 SQ.FT.
	PROPOSED POOL	(D) 903.42 SQ.FT.	903.42 SQ.FT.
	OTHER:		4,399.79 SQ.FT.
	PROPOSED PATIO/POOL COPING	(E1) 1,225.54 SQ.FT.	4,399.79 SQ.FT.
	PROPOSED PATIO/ STAIR	(E2) 274.42 SQ.FT.	
	PROPOSED RETAINING WALL	(E3) 934.3 SQ.FT.	
	PROPOSED EQUIP. PAD	(E4) 32.0 SQ.FT.	
	EXISTING EQUIP. PADS	(E5) 49.4 SQ.FT.	
	EXISTING STONE PATIO	(E6) 1,576.85 SQ.FT.	
	EXISTING RET. WALL	(E7) 229.78 SQ.FT.	
	EXISTING PATIO	(E8) 77.5 SQ.FT.	
TOTAL COVERAGE:			

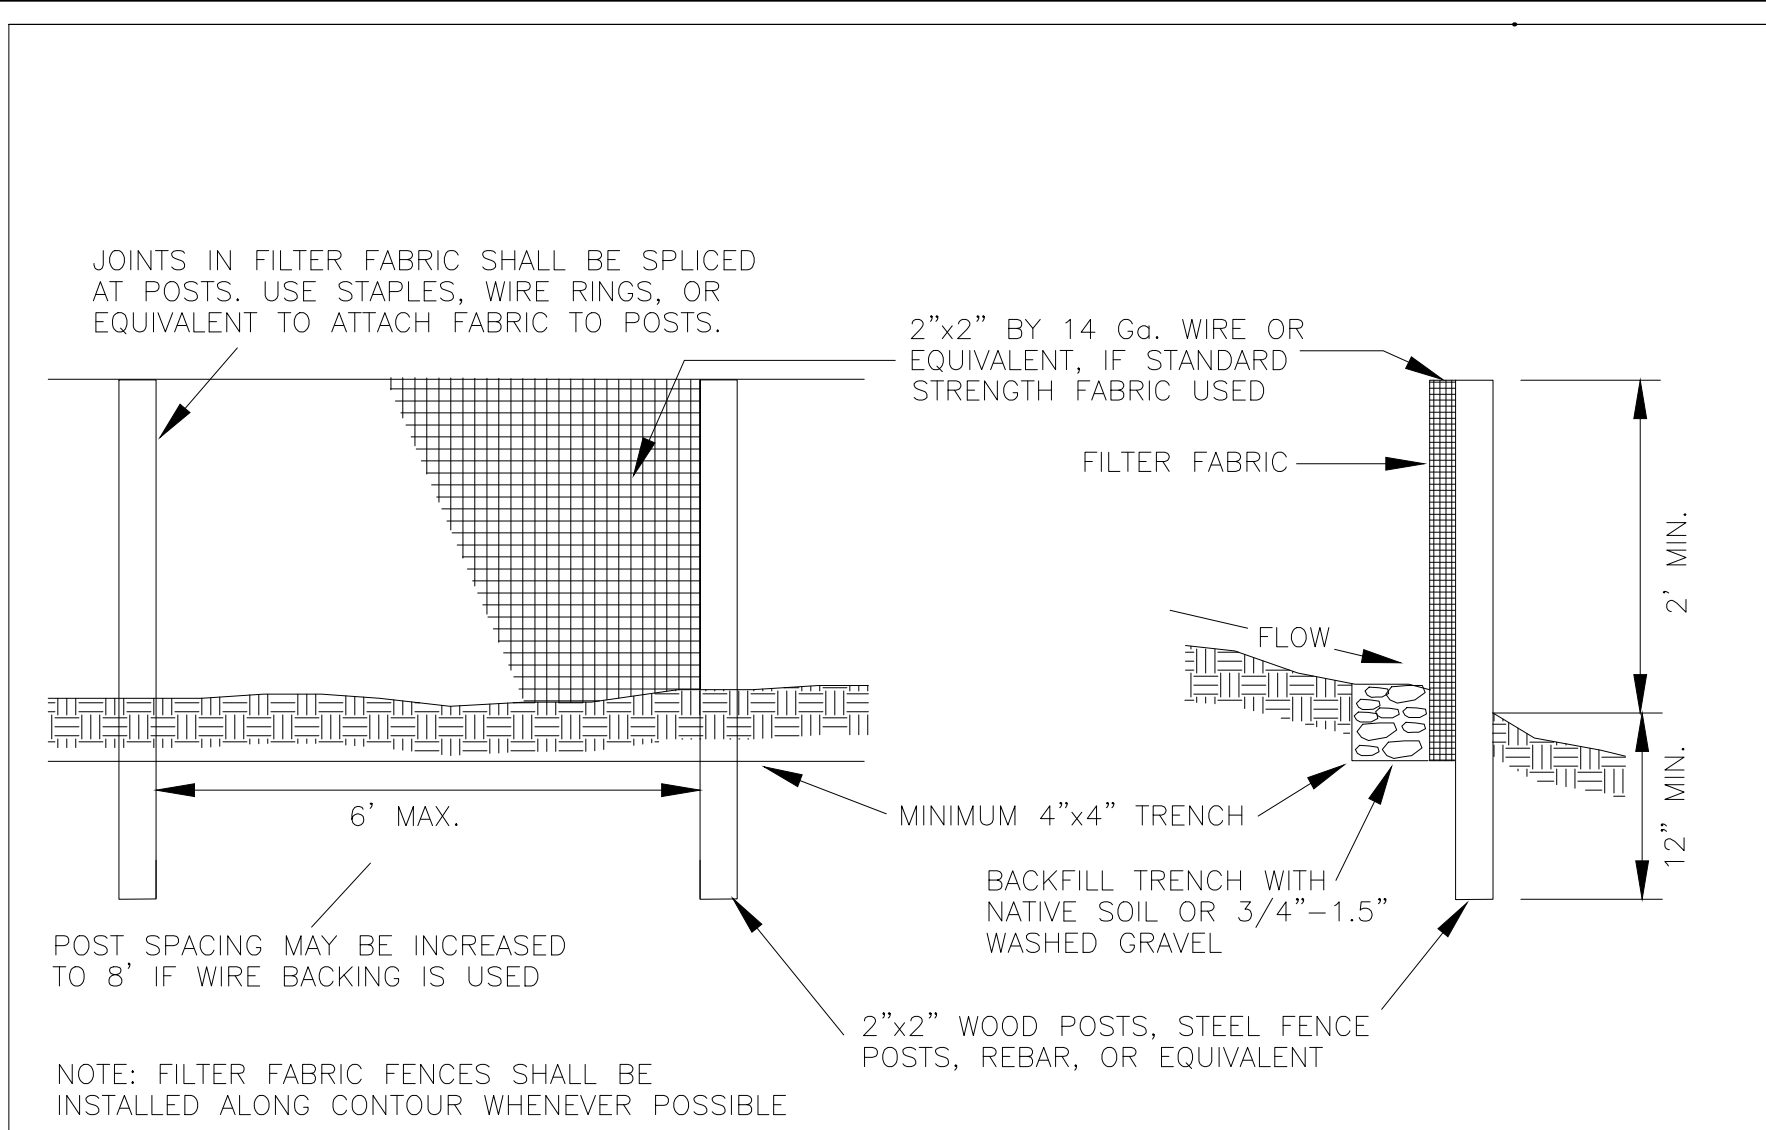


**SILT DETAIL**

SCALE: N.T.S

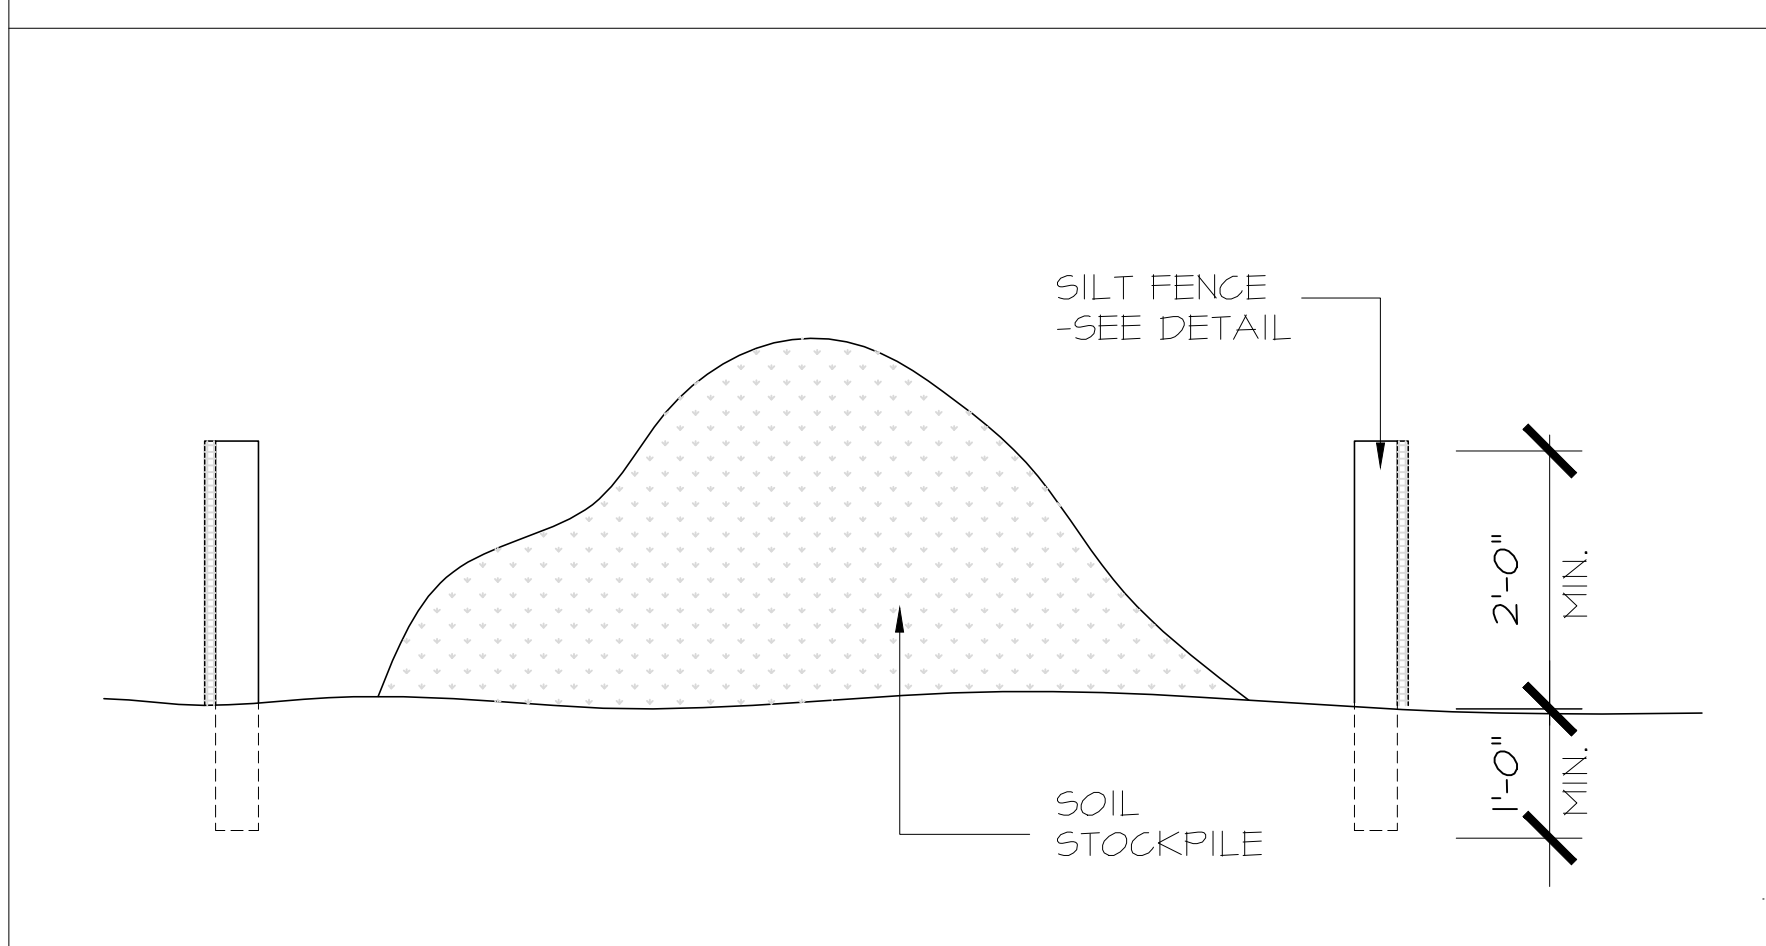


**STOCKPILE DETAIL**

SCALE: N.T.S

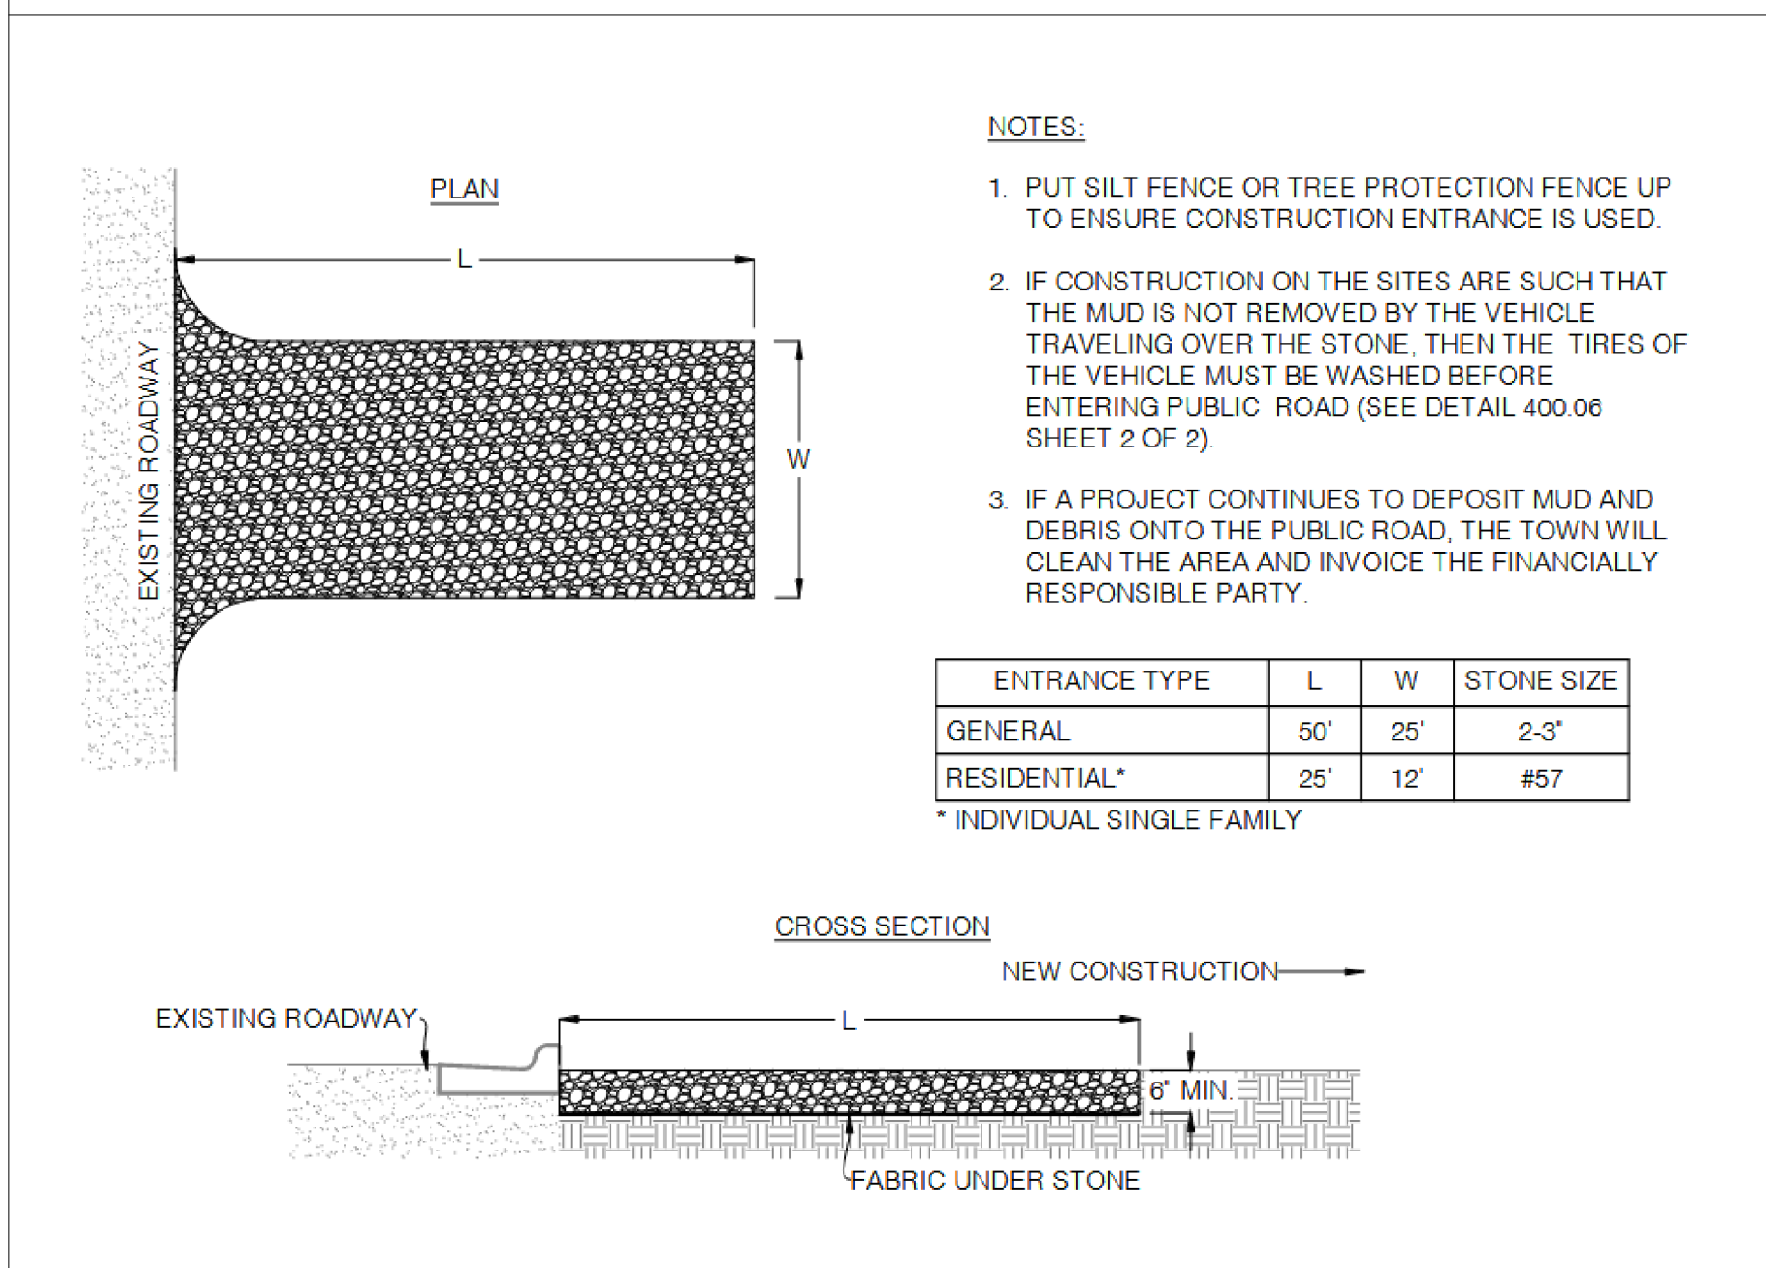


**STABILIZED CONSTRUCTION ENTRANCE DETAIL**

SCALE: N.T.S

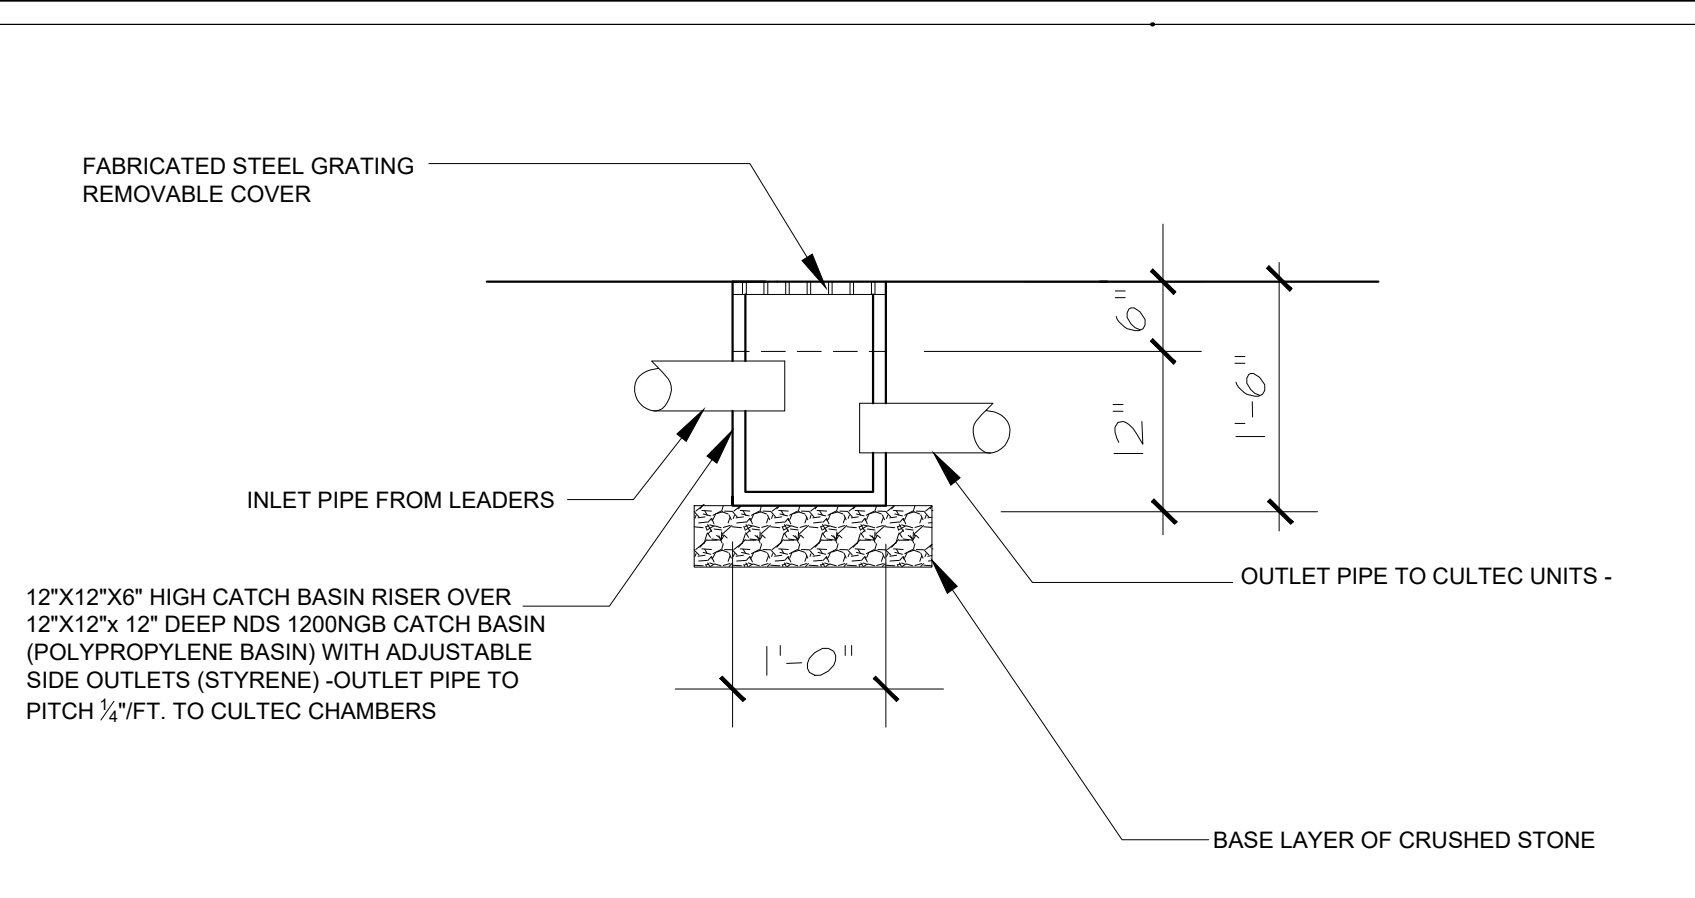


**CATCH BASIN DETAIL**

SCALE: N.T.S

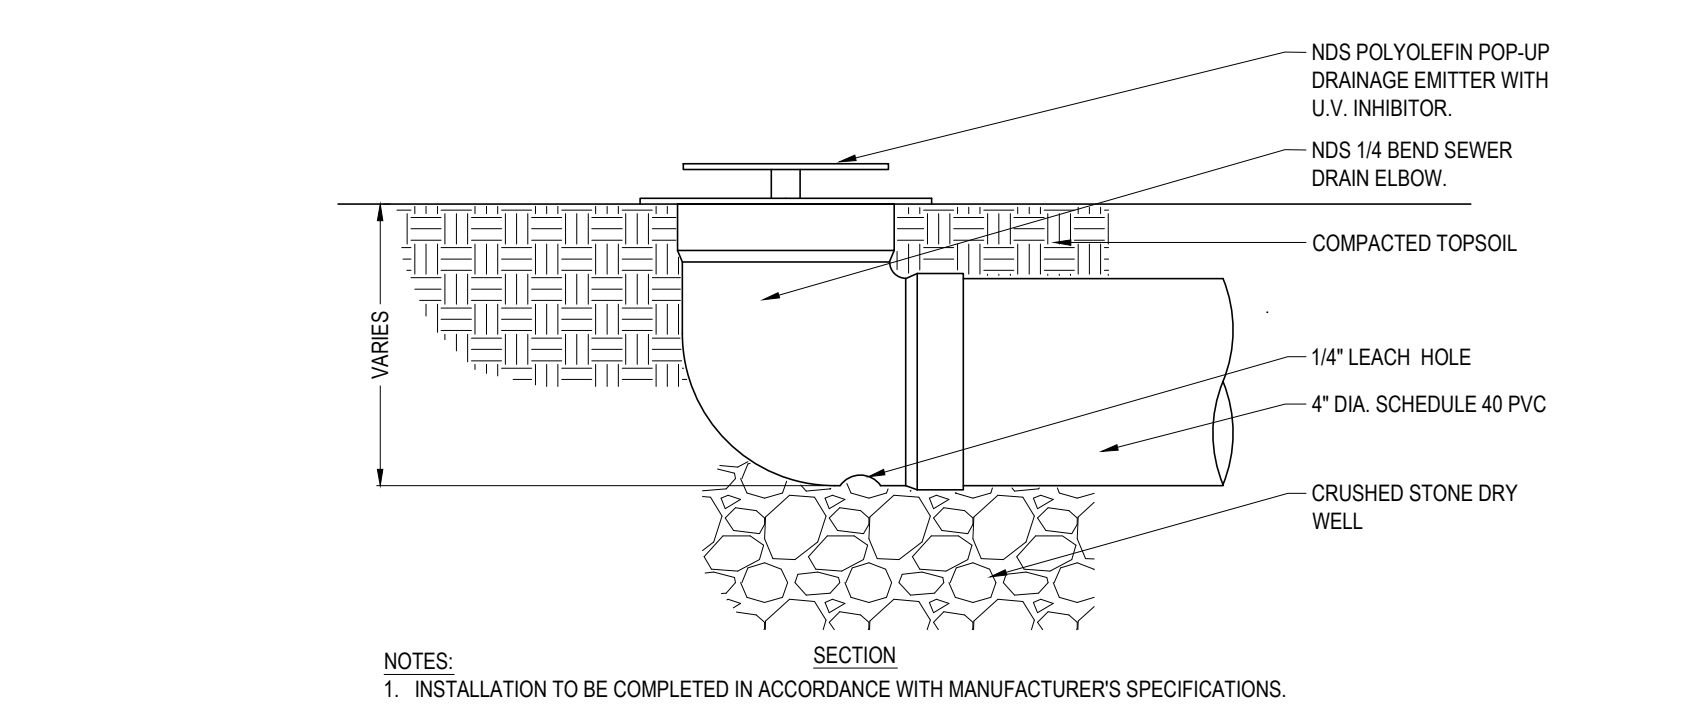

**POP UP DRAIN EMITTER**

SCALE: N.T.S

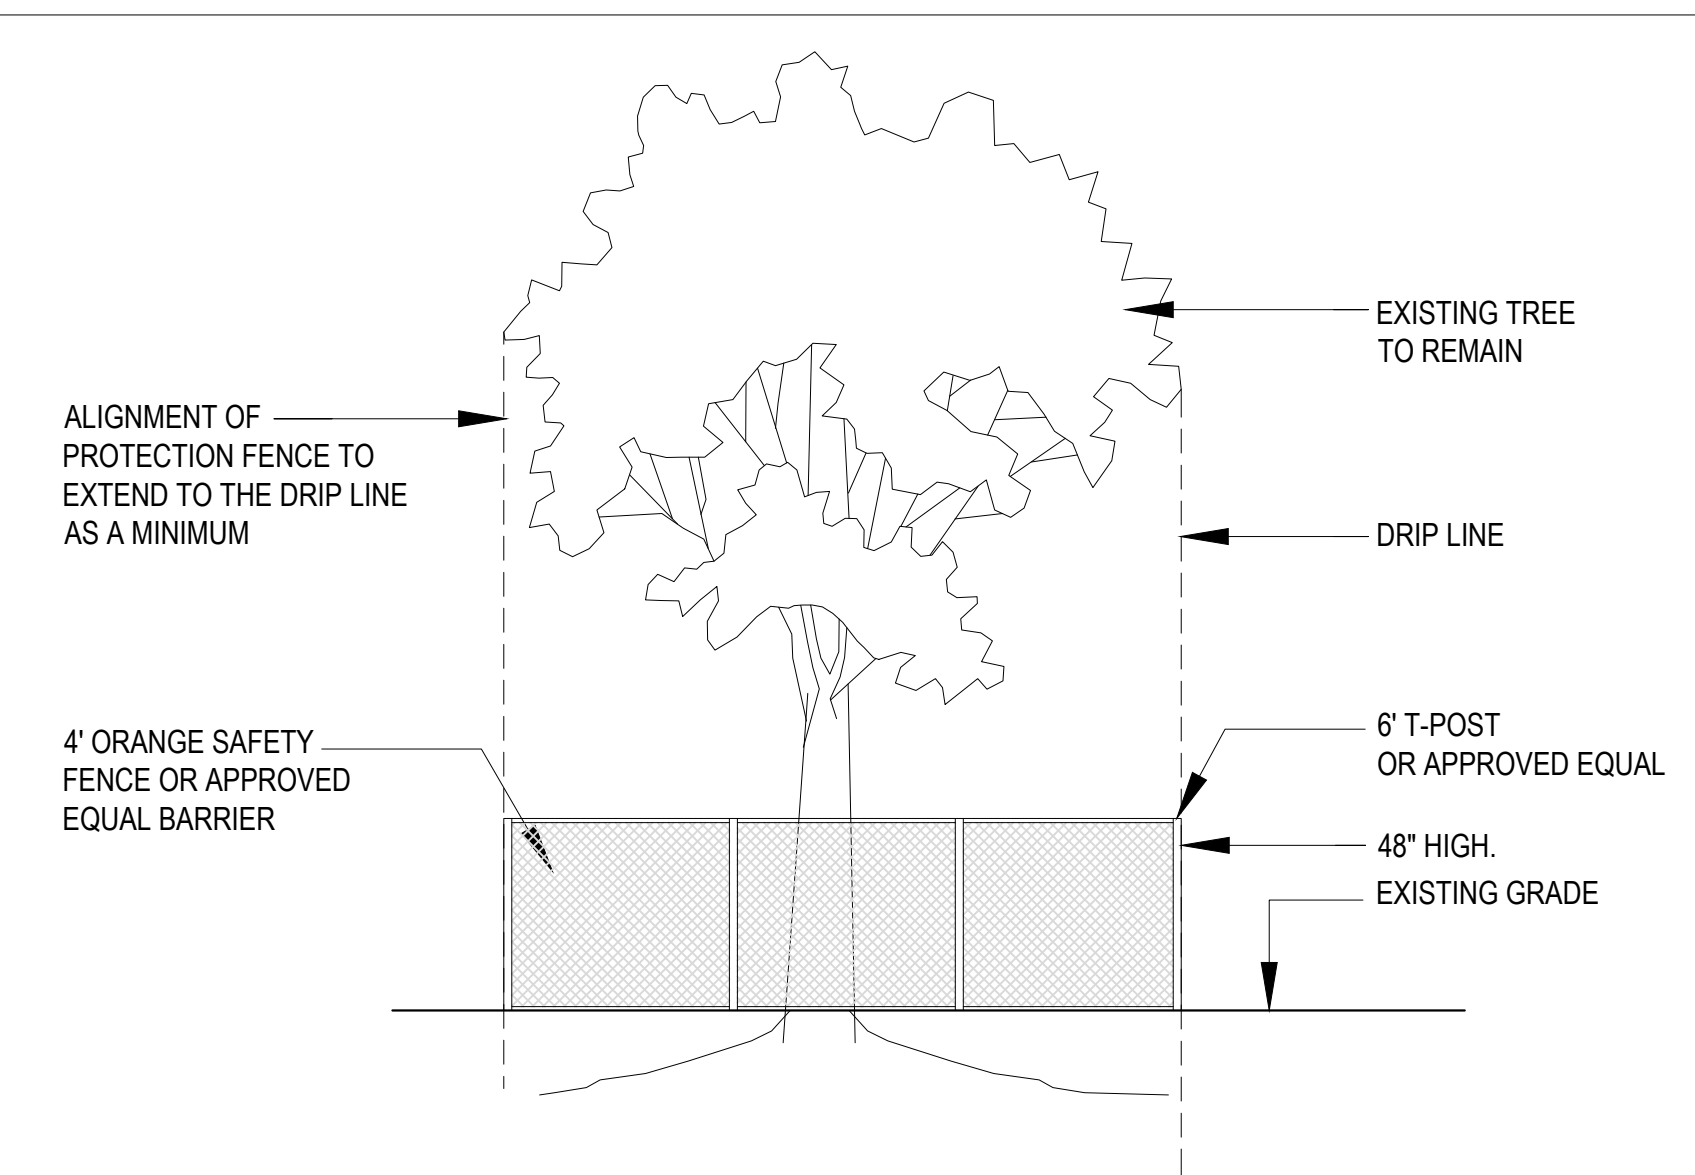


NOTE: NO GRADING, MATERIAL STORAGE OR ANY OTHER CONSTRUCTION WORK SHALL TAKE PLACE WITHIN THE PROTECTION FENCE

**TREE PROTECTION DETAIL**



SCALE: N.T.S

**CULTEC RECHARGER 330XL SPECIFICATIONS**

- GENERAL CULTEC RECHARGER 330XL CHAMBERS ARE DESIGNED FOR UNDERGROUND STORMWATER MANAGEMENT. THE CHAMBERS MAY BE USED FOR RETENTION, RECHARGING, DETENTION, CONTROLLING THE FLOW OF ON-SITE STORMWATER RUNOFF.
- CHAMBER PROPERTIES**
- THE CHAMBERS WILL BE MANUFACTURED BY CULTEC, INC. OF BROOKFIELD, CT (203-775-4416).
  - CONTACT CULTEC, INC. AT 203-775-4416 FOR SUBMITTAL PACKAGES AND TO PURCHASE PRODUCT.
  - THE NOMINAL CHAMBER DIMENSIONS OF THE CULTEC RECHARGER 330XL SHALL BE 30.5 INCHES TALL, 52 INCHES WIDE AND 102.0 INCHES LONG.
  - THE STANDARD-DUTY VERSION OF THE CHAMBER COMES STANDARD WITH A 4.75 INCH INLET/OUTLET OPENING; THE HEAVY-DUTY VERSION DOES NOT COME WITH A PRE-DRILLED INLET/OUTLET. MAXIMUM INLET OPENING IS 18 INCHES.
  - THE CHAMBER WILL HAVE 15 CORRUGATIONS.
  - THE NOMINAL STORAGE VOLUME OF THE RECHARGER 330XL WILL BE 7.459 CF/LF.
  - THE CHAMBERS WILL BE VACUUM THERMOFORMED OF BLACK HIGH MOLECULAR WEIGHT HIGH- DENSITY POLYETHYLENE (HMWDPE) IN AN ISO-9001:2000 CERTIFIED FACILITY.
  - CHAMBERS ARE MANUFACTURED WITH AN OPEN BOTTOM, INTEGRALLY FORMED END WALLS AND PERFORATED SIDEWALLS.
  - THE CHAMBERS WILL BE JOINED USING AN INTERLOCKING OVERLAPPING RIB METHOD. CONNECTIONS MUST BE FULLY SHOULDERED OVERLAPPING RIBS, HAVING NO SEPARATE COUPLINGS OR SEPARATE END WALLS.
  - THE CHAMBER'S END WALL WILL BE AN INTEGRAL PART OF THE CONTINUOUSLY FORMED UNIT. SEPARATE INLET OR END PLATES CANNOT BE USED WITH THIS UNIT.
  - ALL CHAMBERS WILL BE ARCHED IN SHAPE AND HAVE EIGHTY-TWO SIDEWALLS OF THE UNIT'S CORE TO PROMOTE INFILTRATION/EXFILTRATION.
  - CHAMBERS MUST HAVE HORIZONTAL STIFFENING FLEX REDUCTION STEPS BETWEEN THE RIBS.
  - RECHARGER 330XLHD HEAVY DUTY CHAMBERS ARE DESIGNED TO WITHSTAND AASHTO H-20 LOAD RATING (32,000 LBS. /AXLE) WHEN INSTALLED ACCORDING TO CULTEC'S MOST CURRENT INSTALLATION INSTRUCTIONS. RECHARGER 330XL HEAVY DUTY UNITS ARE DESIGNATED BY A COLORED STRIPE FORMED INTO THE PART ALONG THE LENGTH OF THE CHAMBER.
  - RECHARGER 330XL STANDARD DUTY CHAMBERS ARE DESIGNED TO WITHSTAND AASHTO H-10 LOAD RATING (16,000 LBS./AXLE) WHEN INSTALLED ACCORDING TO CULTEC'S MOST CURRENT INSTALLATION INSTRUCTIONS.
  - POLYETHYLENE CHAMBERS MUST HAVE THE ABILITY TO ACCEPT AND CARRY PIPE THROUGH ITS INTEGRALLY FORMED VERTICAL SUPPORT WALL WITHOUT THE USE OF SEPARATE PIPE HANGERS. 3 INCH ROUND DISCHARGE HOLES BORED INTO THE 4 1/2 UNITS WILL HAVE A RAISED INTEGRAL CAP AT THE TOP OF THE ARCH IN THE CENTER OF EACH UNIT TO BE USED AS AN OPTIONAL INSPECTION PORT OR CLEAN-OUT.
  - THE UNITS MAY BE TRIMMED TO CUSTOM LENGTHS BY CUTTING BACK TO ANY CORRUGATION. 18. REPEATING SUPPORT PANELS AND END WALLS OF THE ELONGATED CHAMBER SHALL BE SPACED EVERY 7.0 FEET.

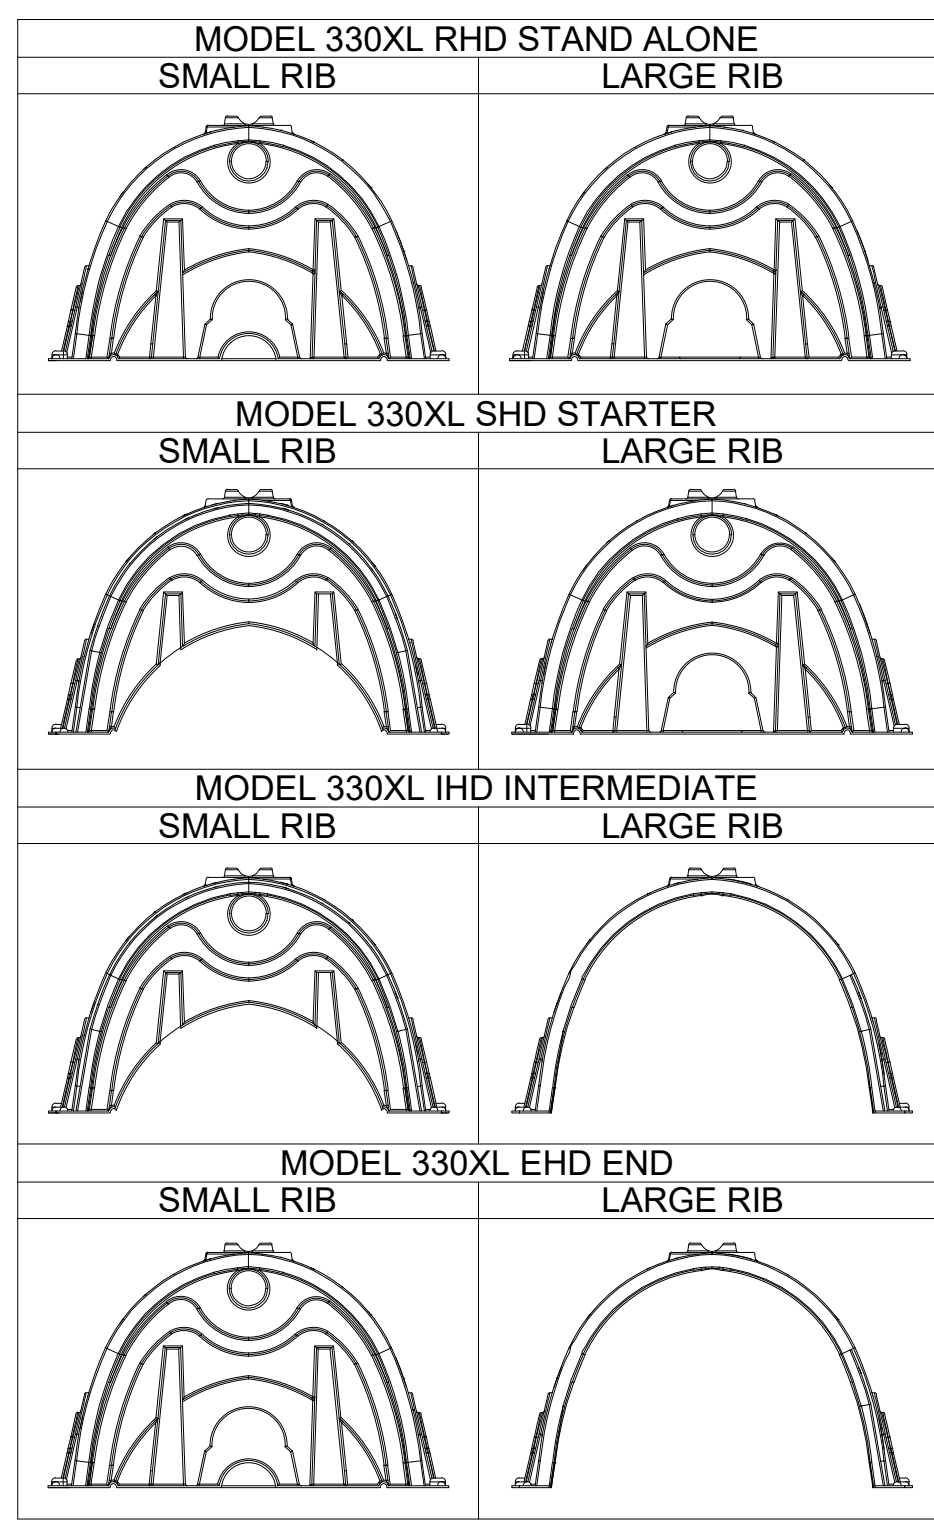

CULTEC RECHARGER 330XL HD CHAMBER STORAGE = 7.459 CF/FT  
INSTALLED LENGTH ADJUSTMENT = 1.5'  
ALL RECHARGER 330XL HD HEAVY DUTY UNITS ARE MARKED WITH A COLOR STRIPE FORMED INTO THE PART ALONG THE LENGTH OF THE CHAMBER.

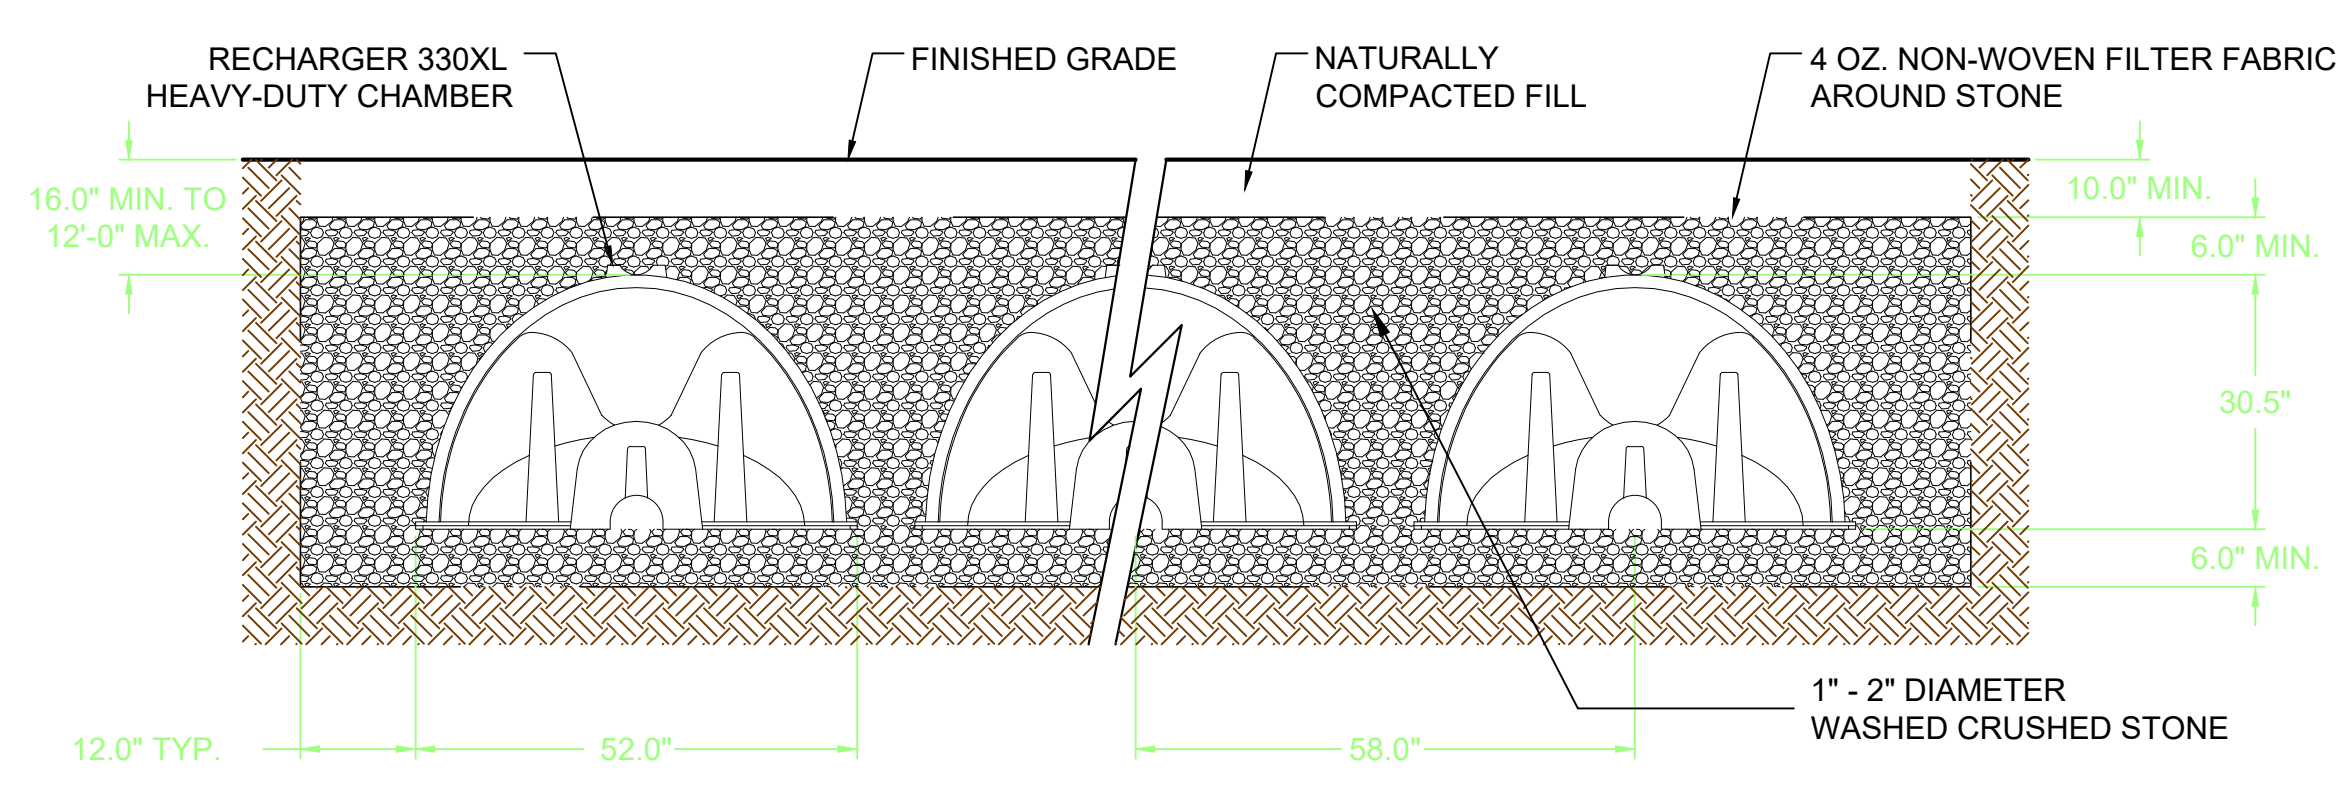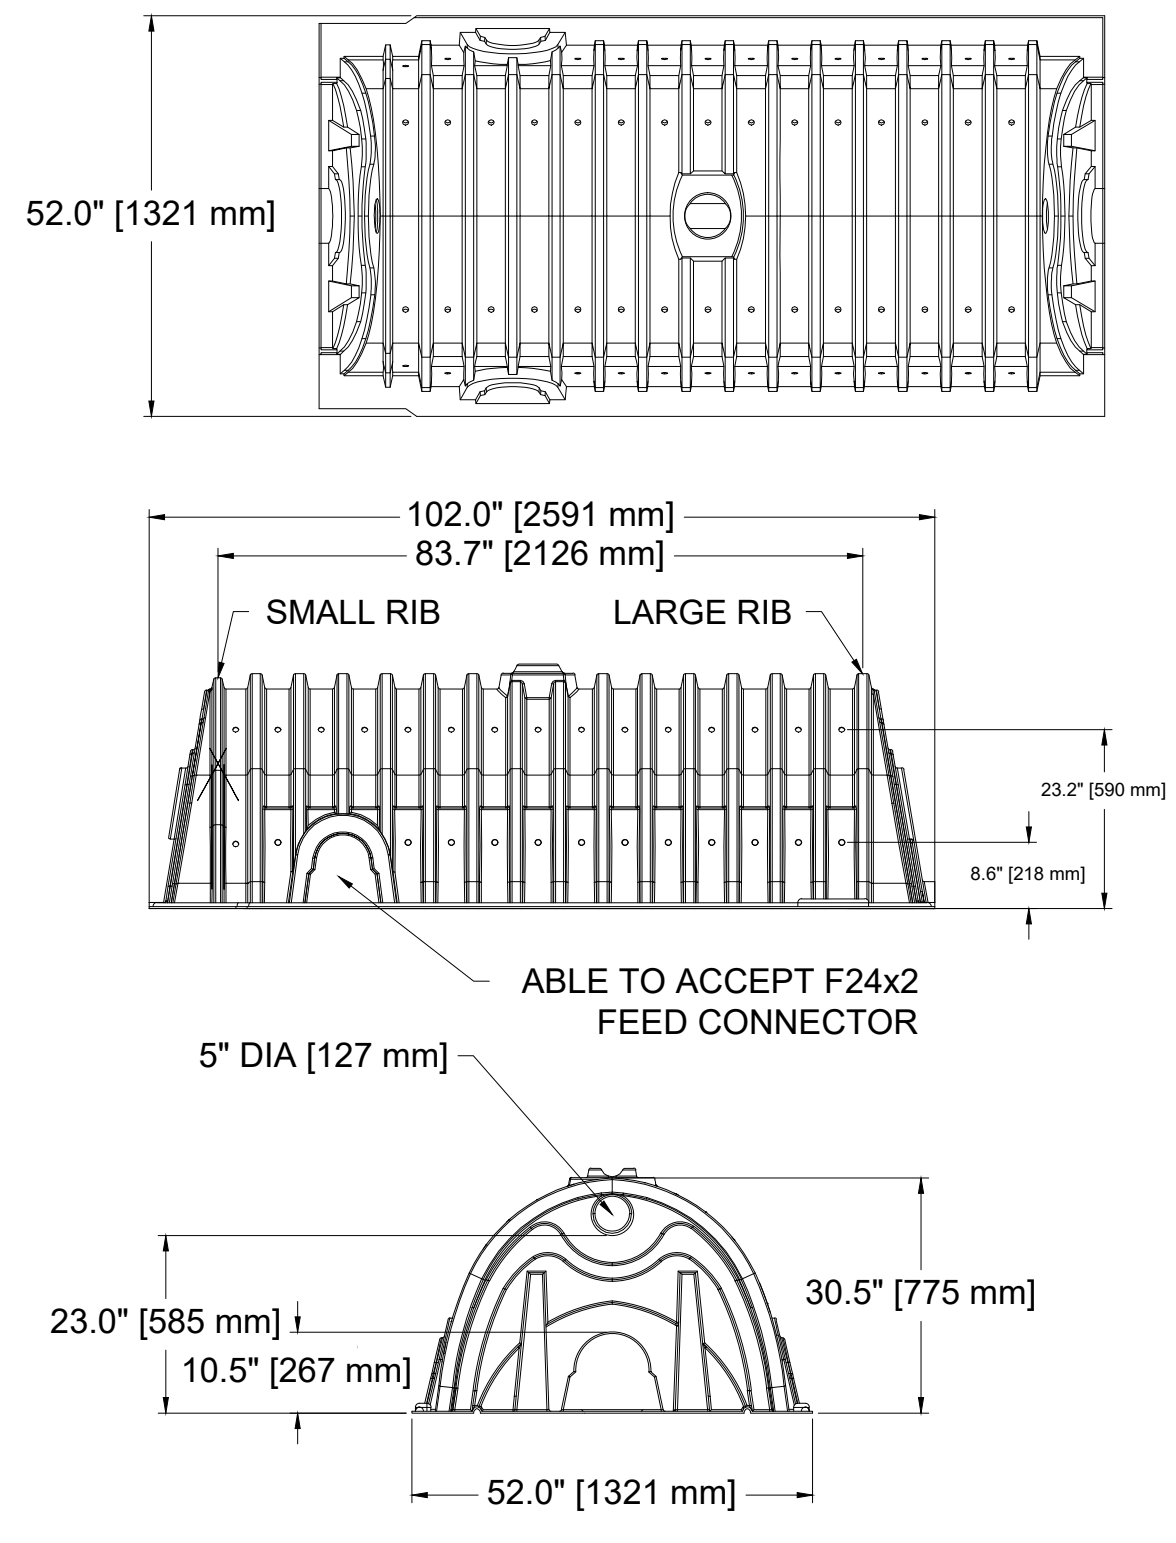

GENERAL NOTES  
RECHARGER 330XL BY CULTEC, INC. OF BROOKFIELD, CT. STORAGE PROVIDED = 7.459 CF/FT PER DESIGN UNIT. REFER TO CULTEC, INC.'S CURRENT RECOMMENDED INSTALLATION GUIDELINES.

ALL RECHARGER 330XL HEAVY DUTY UNITS ARE MARKED WITH A COLOR STRIPE FORMED INTO THE PART ALONG THE LENGTH OF THE CHAMBER. ALL RECHARGER 330XL CHAMBERS MUST BE INSTALLED IN ACCORDANCE WITH ALL APPLICABLE LOCAL, STATE AND FEDERAL REGULATIONS.



**HAYNES ARCHITECTURE P.C.**

570 yonkers ave. yonkers, ny 10704

p: 914.963.3838 f: 914.963.3861  
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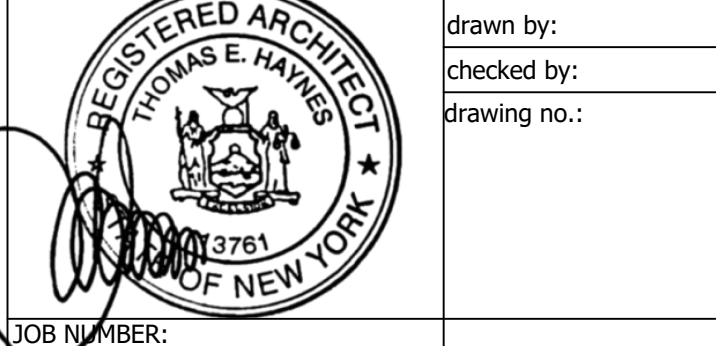
revisions:

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**Proposed In-ground, Pergola, Pool and Patio at:**  
**246 BEDFORD BANKSVILLE RD.**  
**Bedford, New York**

**DETAILS**

Seal: Architect Thomas E. Haynes original filing date: 03-29-2022




JOB NUMBER: 2181 SP.03



revisions:


project title:

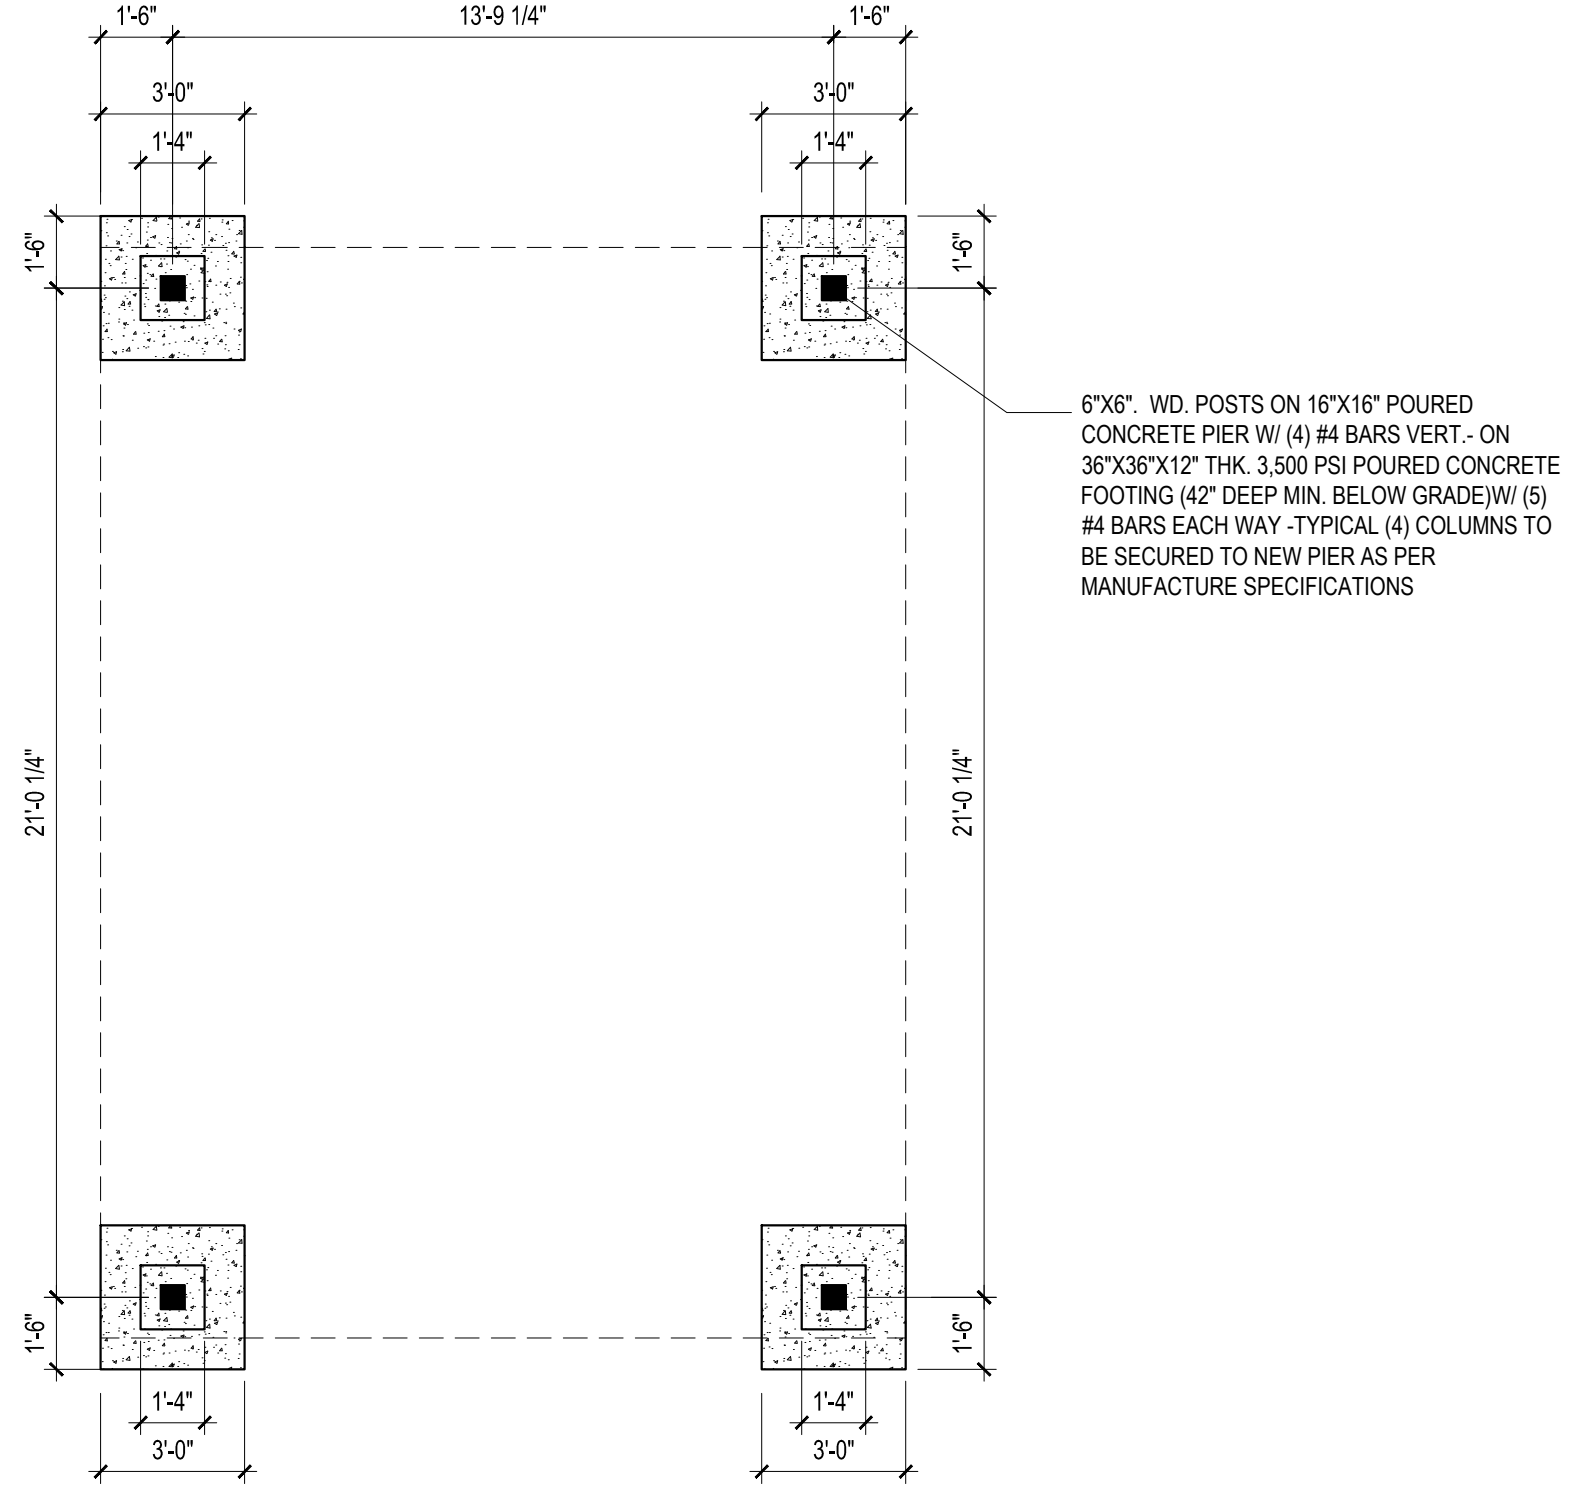

- NOTE: ALL CANOPY CONNECTIONS AND DETAILS SHALL BE PROVIDED AND INSTALL AS PER MANUFACTURE SPECIFICATIONS
- NOTE: PROVIDE SIMPSON JOIST HANGERS AT NEW WOOD JOIST TO NEW LEDGER FLUSH WOOD CONDITIONS -TYP. ALL JOISTS
- NOTE: ALL EXTERIOR WOOD TO BE PRESSURE TREATED - ALL WOOD/CONCRETE CONDITIONS TO BE PRESSURE TREATED WOOD

**PROPOSED: PERGOLA FOUNDATION PLAN**

SCALE: 1/4" = 1'-0"

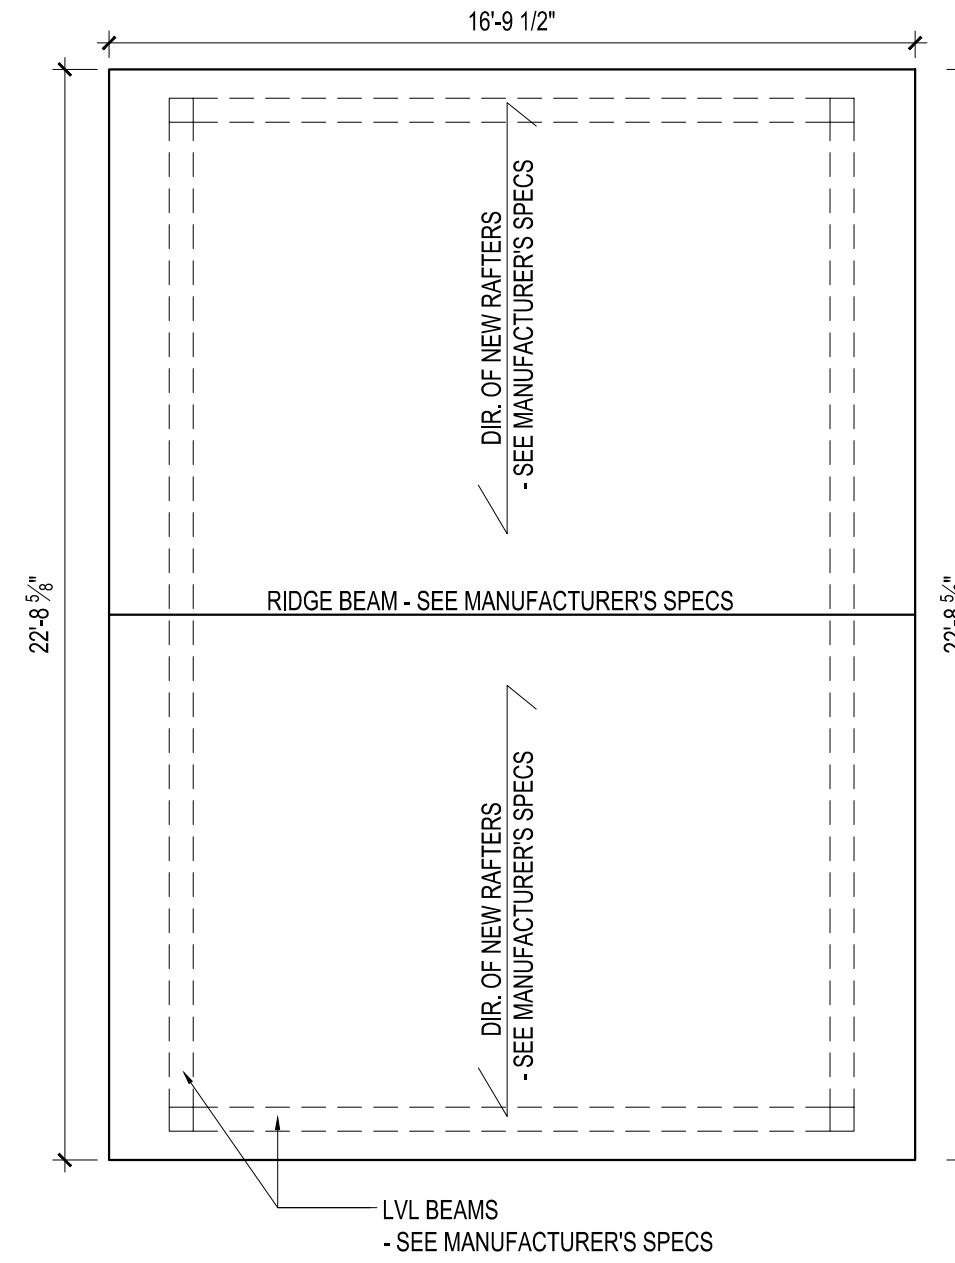

- NOTE: ALL CANOPY CONNECTIONS AND DETAILS SHALL BE PROVIDED AND INSTALL AS PER MANUFACTURE SPECIFICATIONS
- NOTE: PROVIDE SIMPSON JOIST HANGERS AT NEW WOOD JOIST TO NEW LEDGER FLUSH WOOD CONDITIONS -TYP. ALL JOISTS
- NOTE: ALL EXTERIOR WOOD TO BE PRESSURE TREATED - ALL WOOD/CONCRETE CONDITIONS TO BE PRESSURE TREATED WOOD

**PROPOSED: PERGOLA ROOF PLAN**

SCALE: 1/4" = 1'-0"

**Proposed In-ground, Pergola, Pool and Patio at:**  
**246 BEDFORD BANKSVILLE RD.**  
 Bedford, New York

PERGOLA PLANS

Seal: Architect Thomas E. Haynes original filing date: 03-29-2022



drawn by:  
checked by:  
drawing no.:

JOB NUMBER: 2181 A1.01


**Proposed In-ground, Pergola, Pool and  
Patio at:  
246 BEDFORD BANKSVILLE RD.  
Bedford, New York**

PATIO PLANS

Seal: Architect Thomas E. Haynes original filing date: 03-29-2022  
drawn by:  
checked by:  
drawing no.:




JOB NUMBER: 2181 A1.02

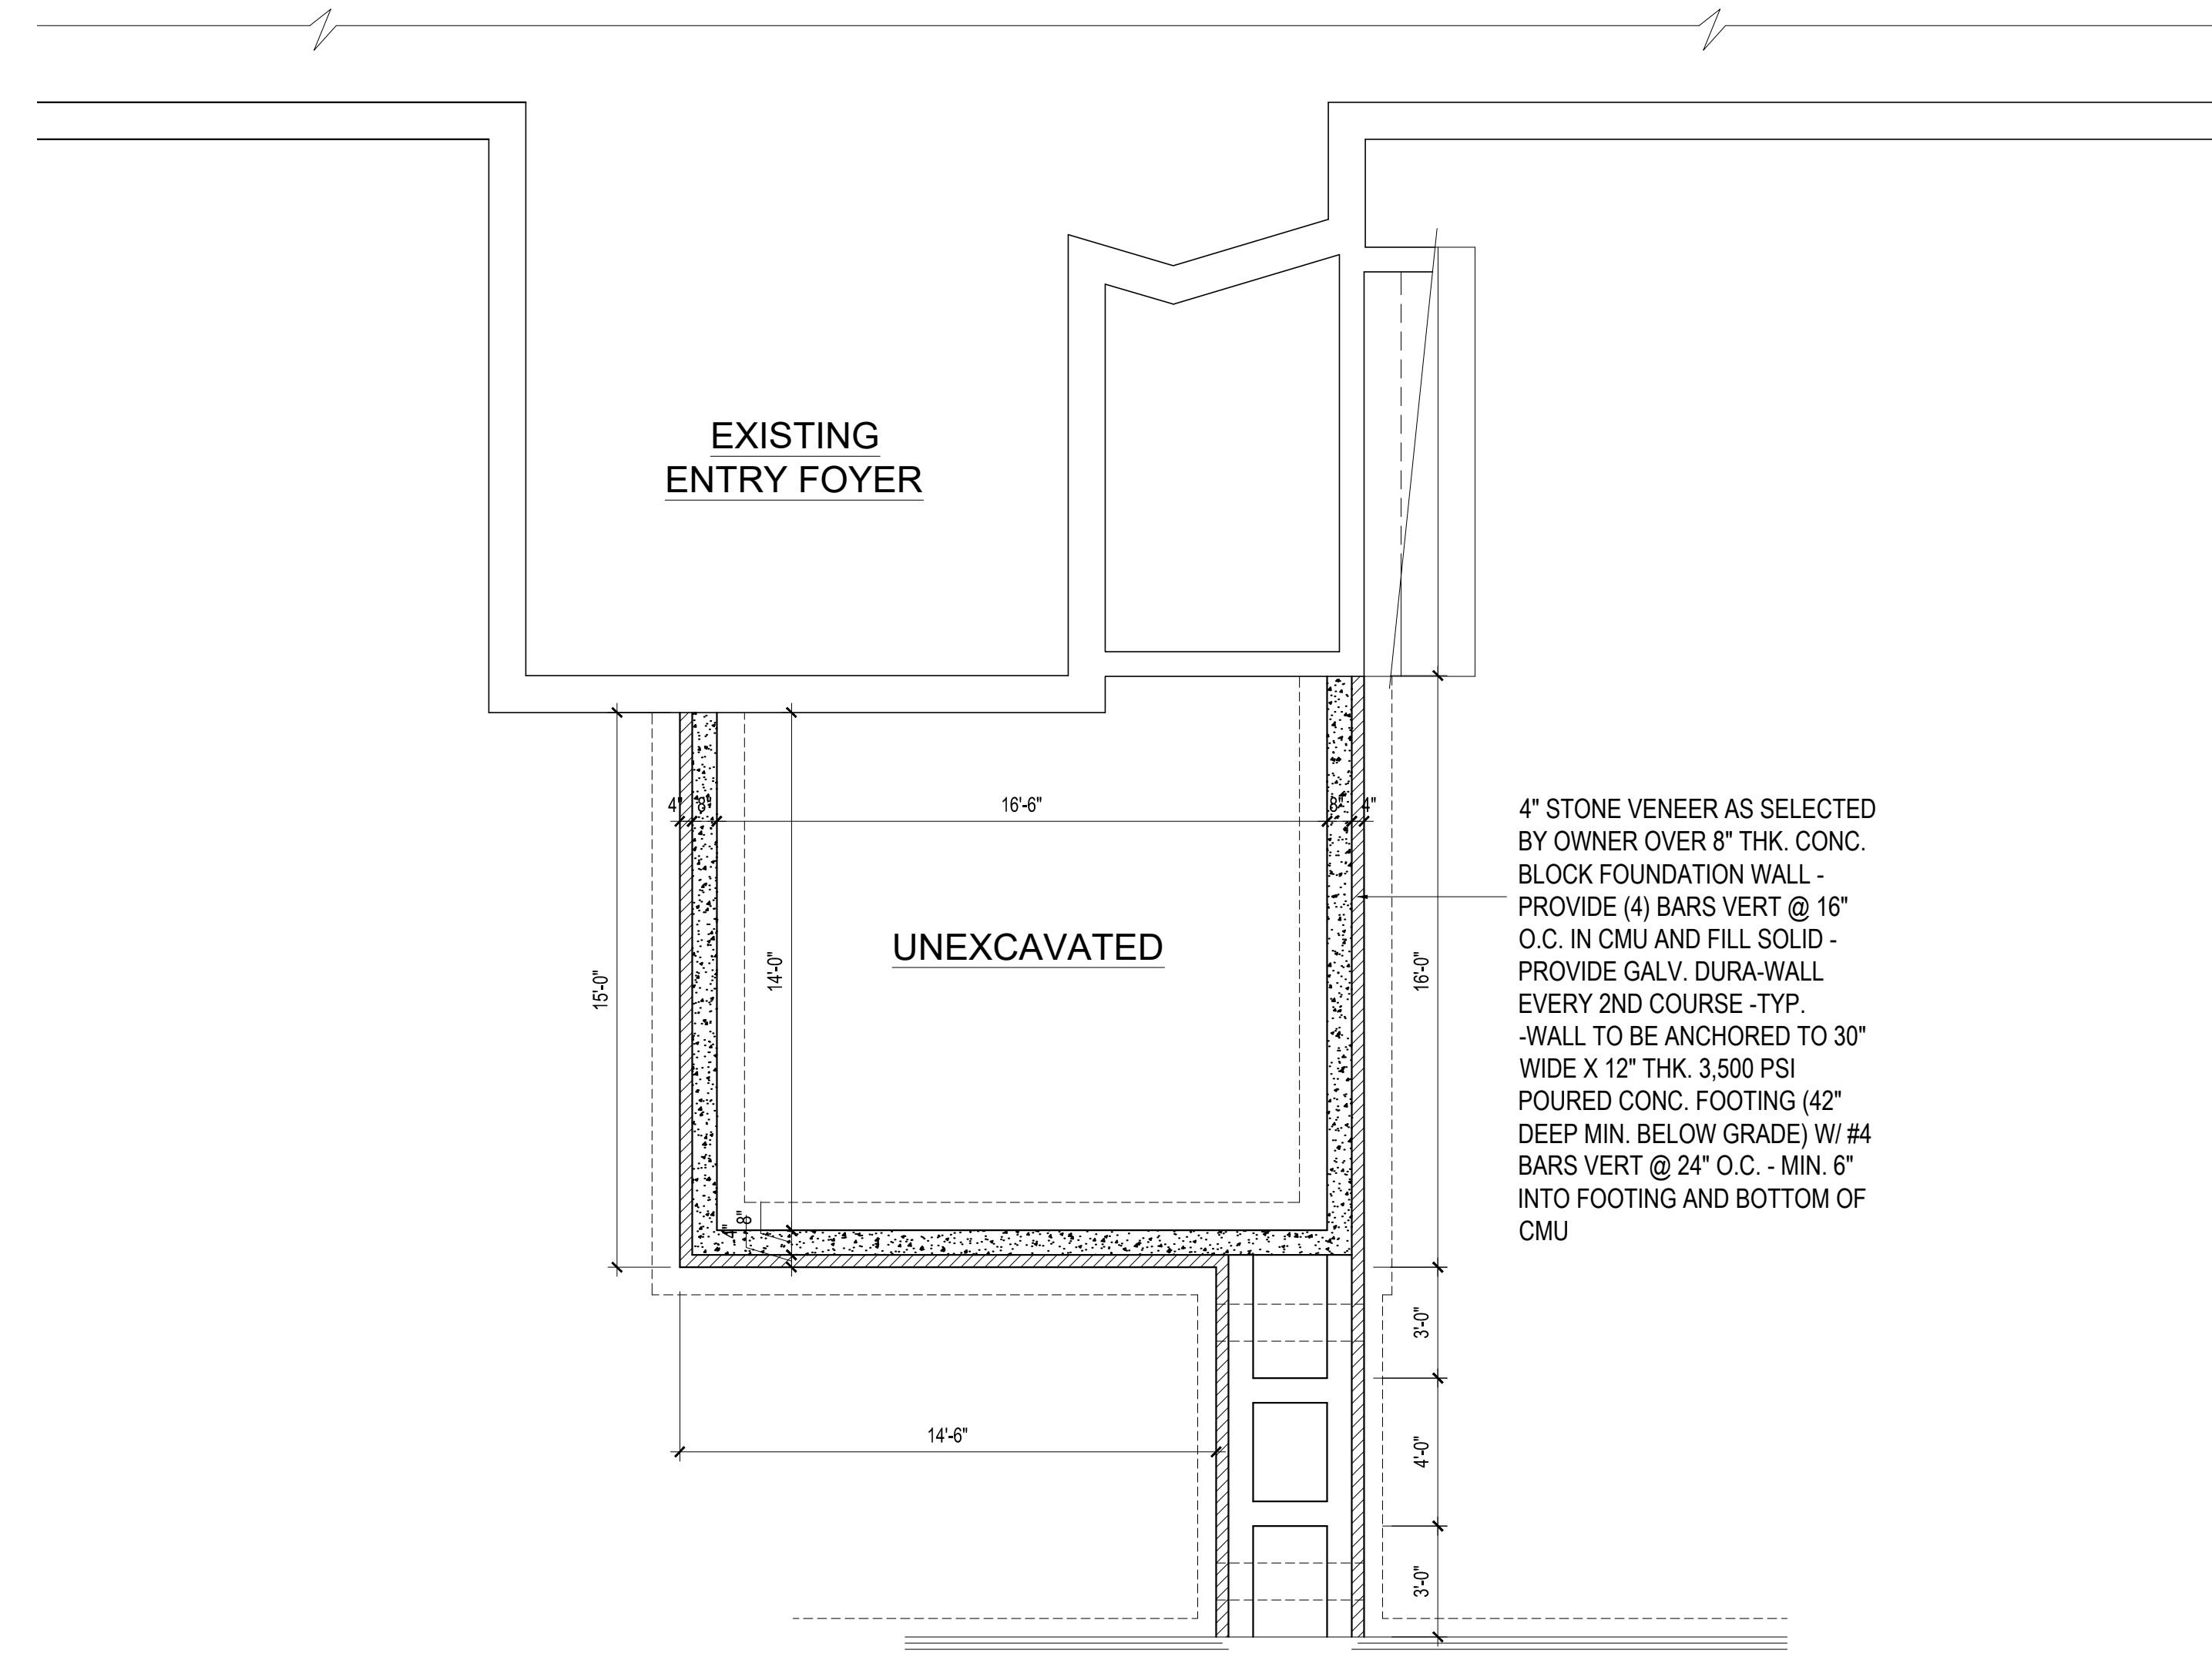


PROPOSED PATIO PLAN:

SCALE: 1/4" = 1'-0"

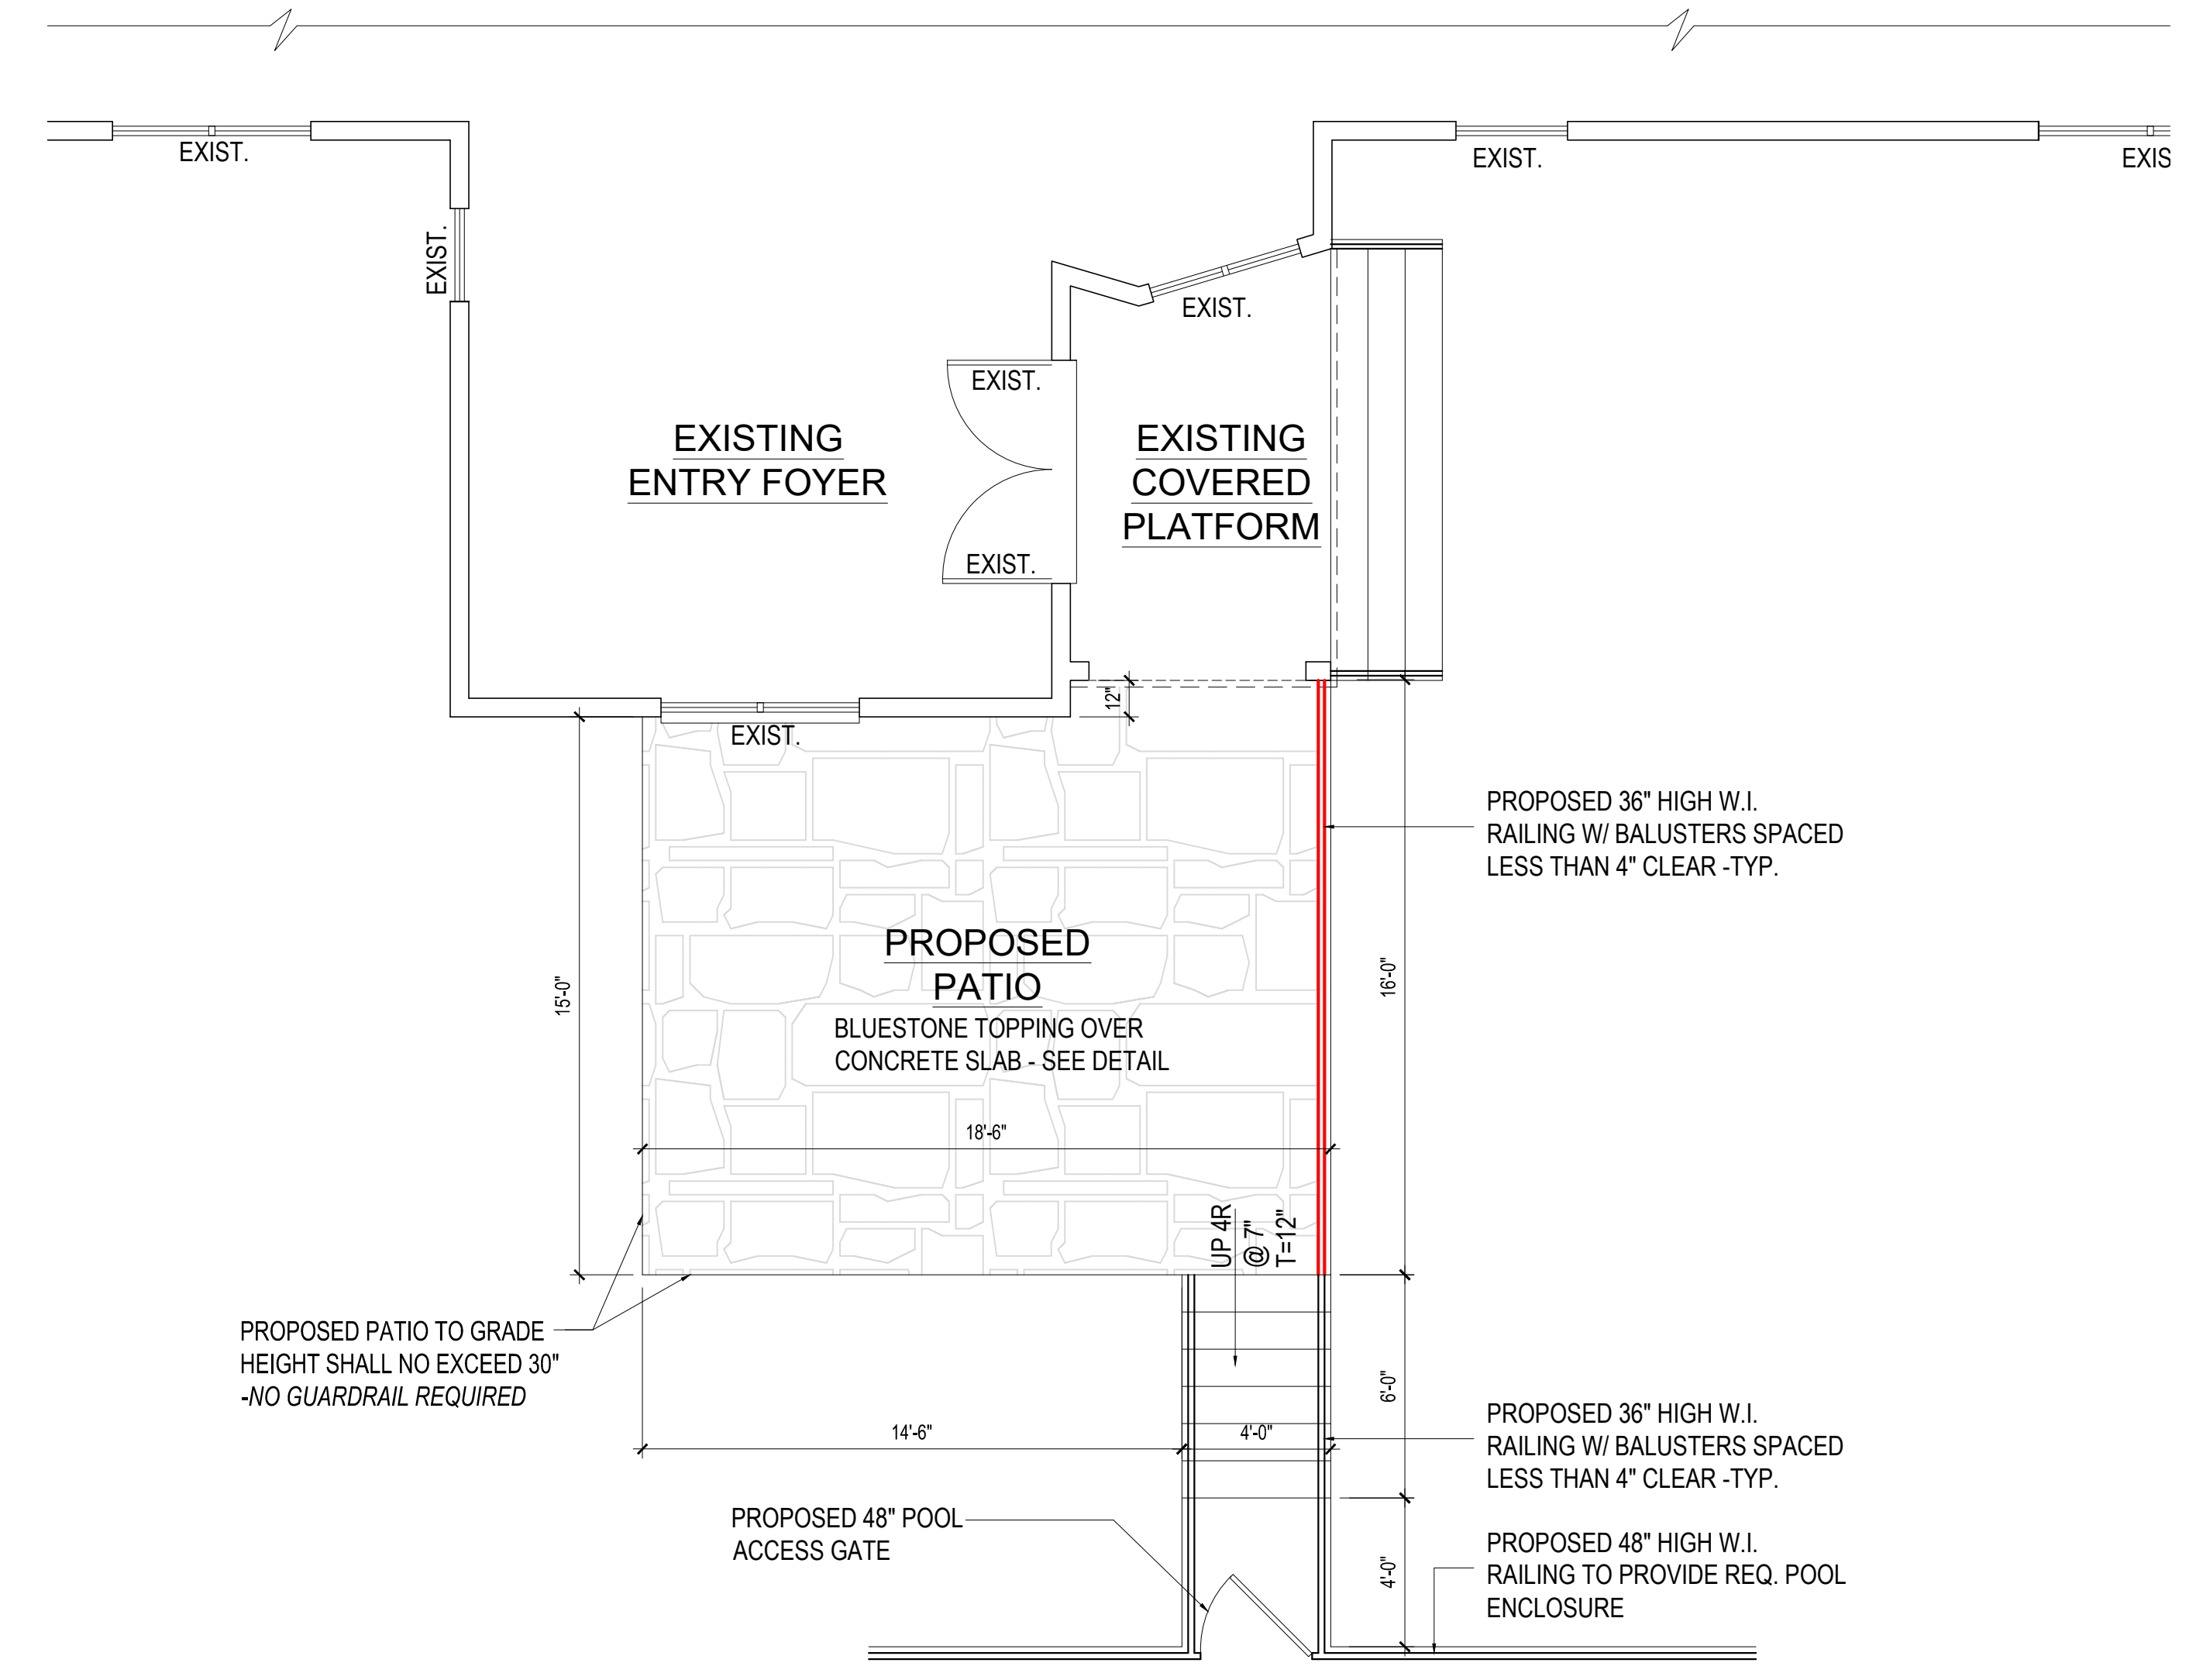

PROPOSED PATIO PLAN:

SCALE: 1/4" = 1'-0"

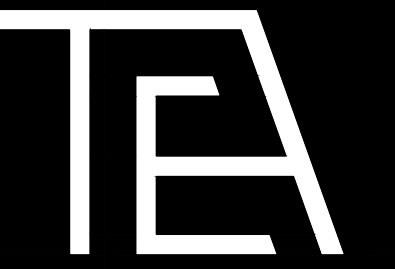

HAYNES ARCHITECTURE P.C.


570 yonkers ave. yonkers, ny 10704

p: 914.963.3838 f: 914.963.3861  
e: info@haynesdesigngroup.com

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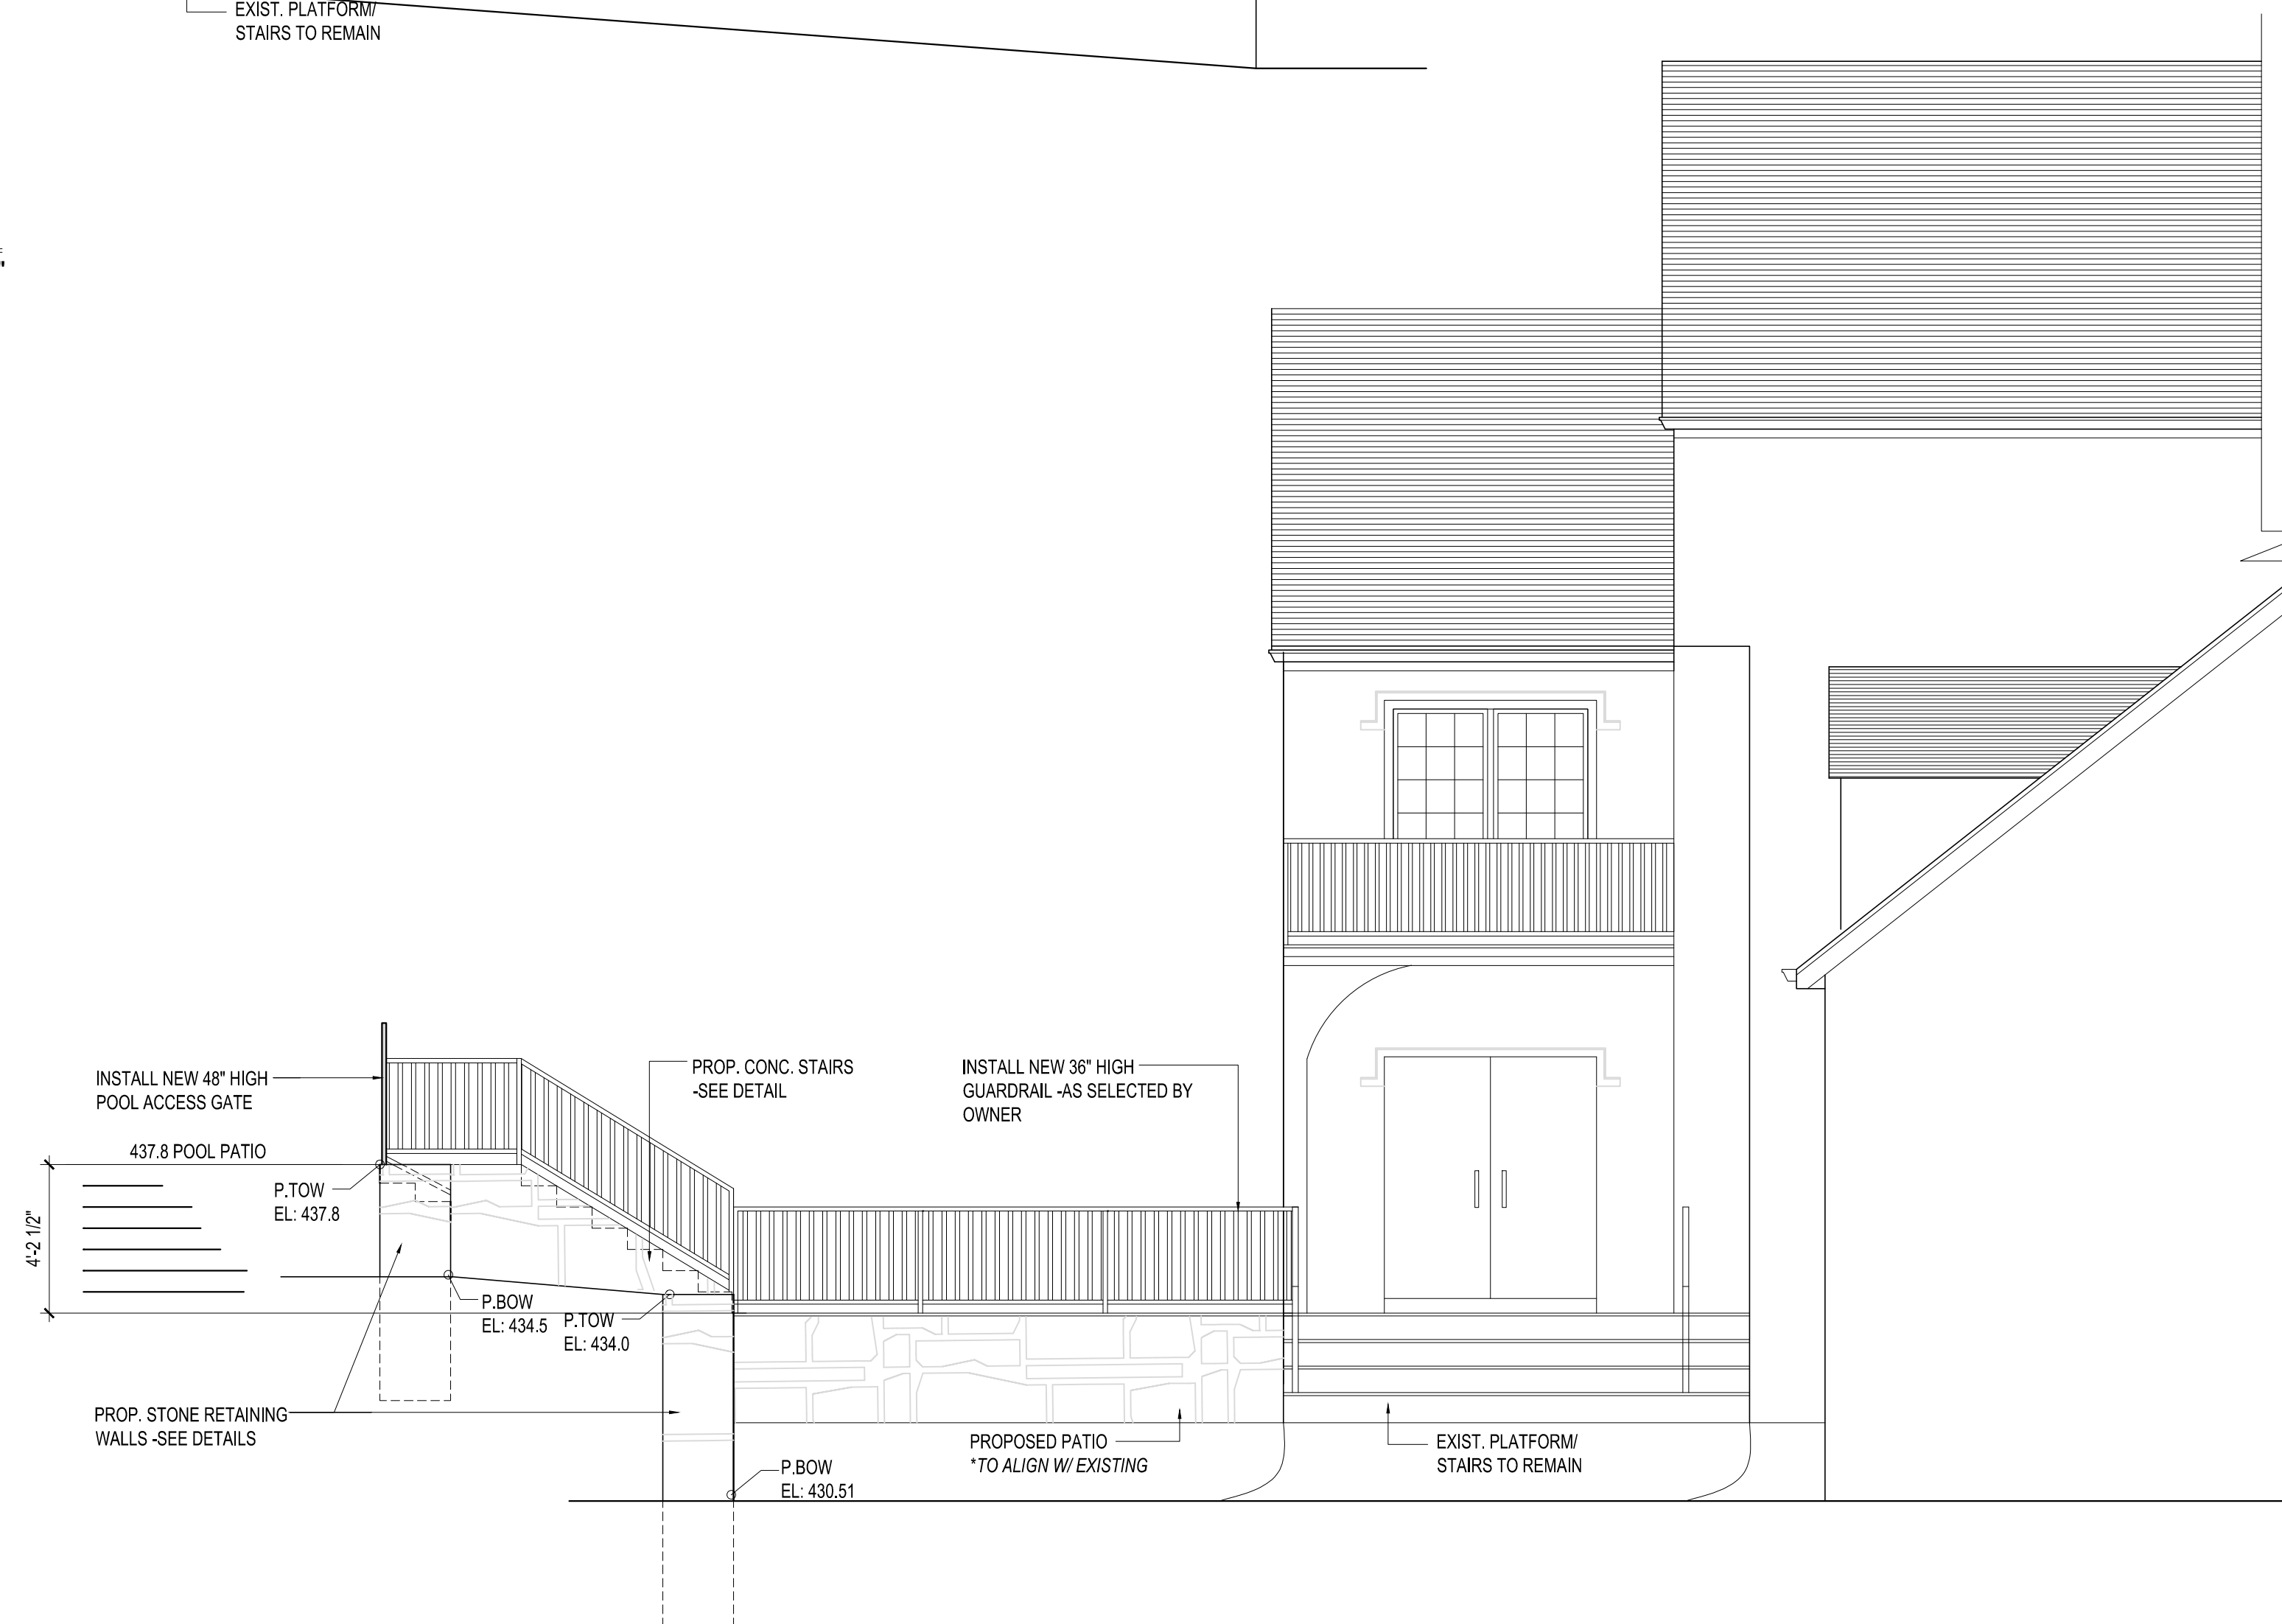
revisions:

project title:

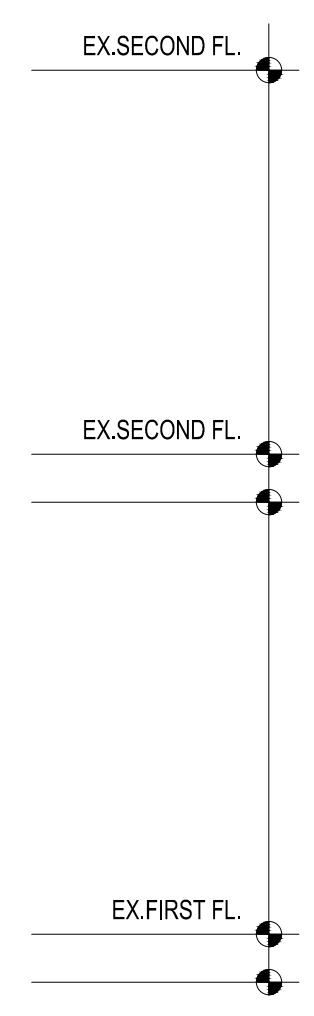

PROPOSED REAR ELEVATION

SCALE: 1/4" = 1'-0"




PROPOSED LEFT SIDE ELEVATION

SCALE: 1/4" = 1'-0"

**Proposed In-ground, Pergola, Pool and  
Patio at:**  
**246 BEDFORD BANKSVILLE RD.**  
Bedford, New York

ELEVATIONS

Seal: Architect Thomas E. Haynes original filing date: 03-29-2022

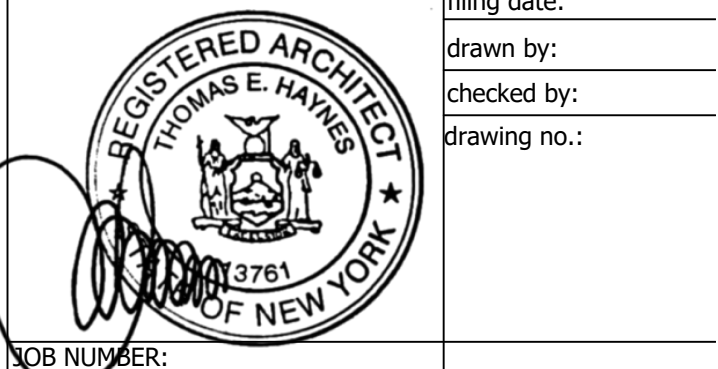


drawn by:  
checked by:  
drawing no.:

**CONSTRUCTION NOTES:**


- ALL LUMBER TO BE PRESSURE TREATED SOUTHERN PINE #1 GRADE, OR AS NOTED
- ATTACH EACH ROOF BOARD TO EACH FRAMING MEMBER w/ (3) 8d NAILS
- ALL HARDWARE TO BE GALVANIZED, POWDER-COATED OR STAINLESS STEEL, OR AS NOTED
- ALL SCREWS #10, LENGTH PER DRAWING, OR AS NOTED

**NOTES:**


THERE HAS NOT BEEN ANY MECHANICAL, ELECTRICAL OR SITE ENGINEERING PERFORMED FOR THIS PROJECT. IT SHALL BE THE RESPONSIBILITY OF OTHERS TO OBTAIN DESIGN DATA FROM A LICENSED ENGINEER FOR THESE SYSTEMS. ENGINEERING SHALL CONFORM WITH ALL APPLICABLE LOCAL AND/OR STATE BUILDING CODES AND REGULATIONS.

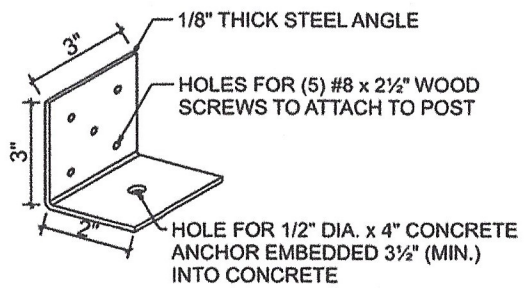


**STEEL L-BRACKET DETAIL**  
NO SCALE

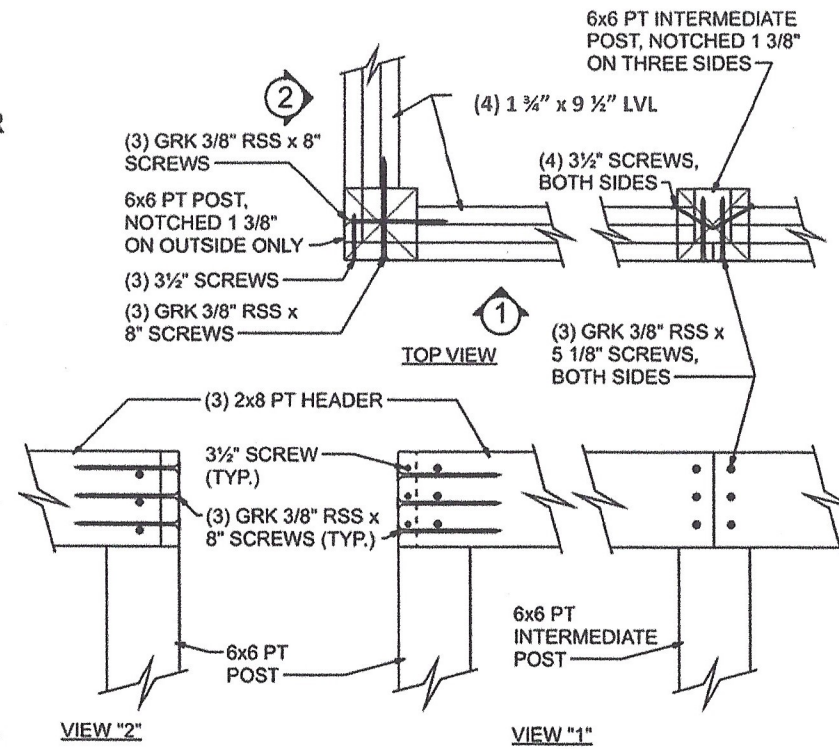


**HEADER TO POST CONNECTION DETAIL**  
NO SCALE

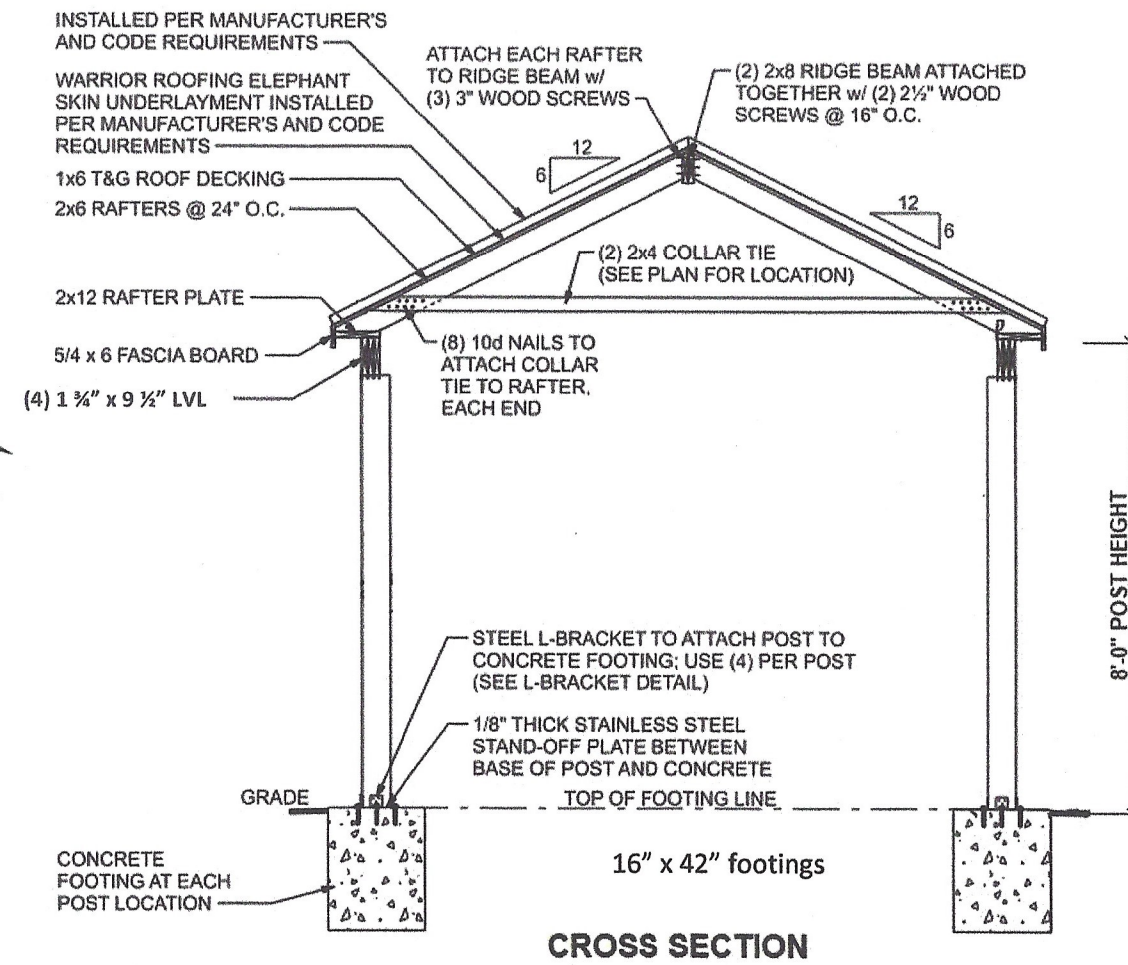


**CROSS SECTION**


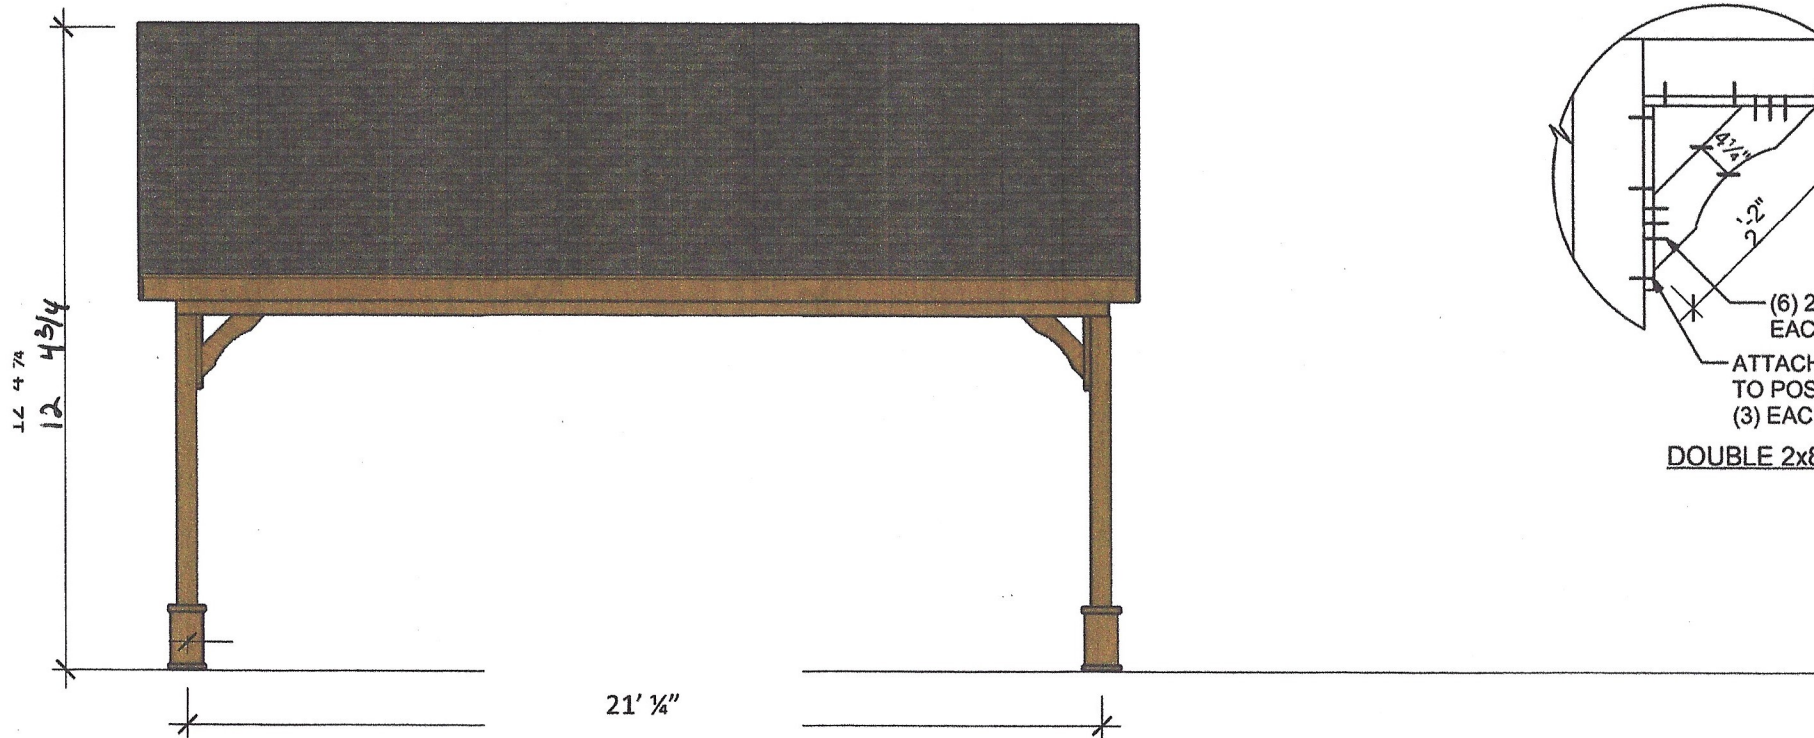


**FRONT ELEVATION**  
SCALE: 1/4" = 1'-0"

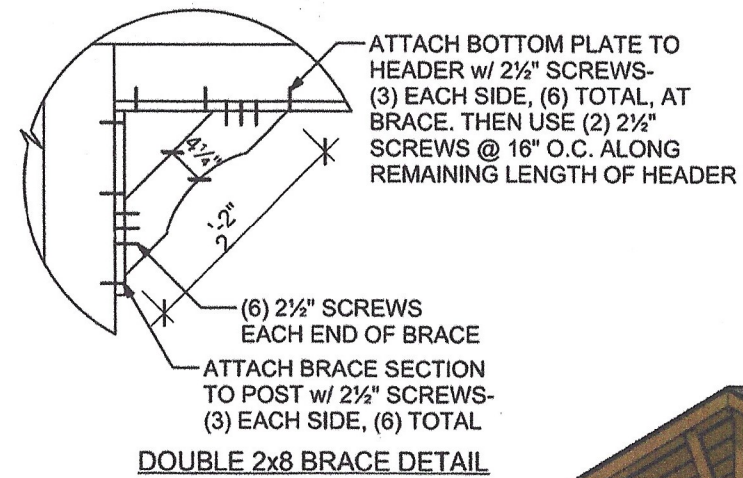


**DOUBLE 2x8 BRACE DETAIL**

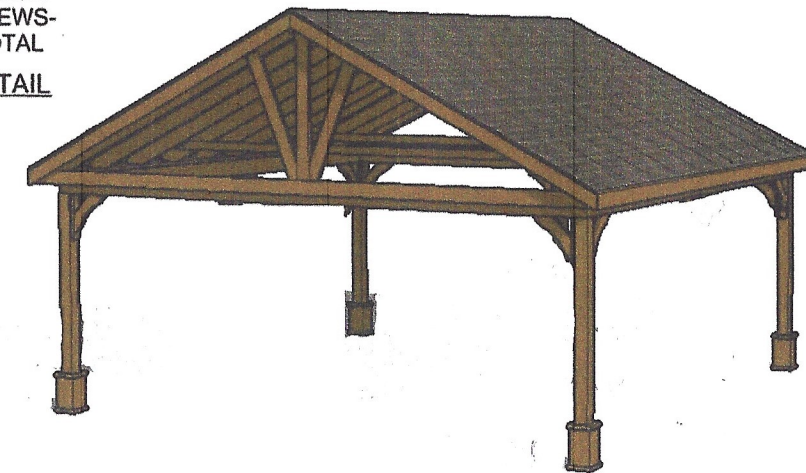

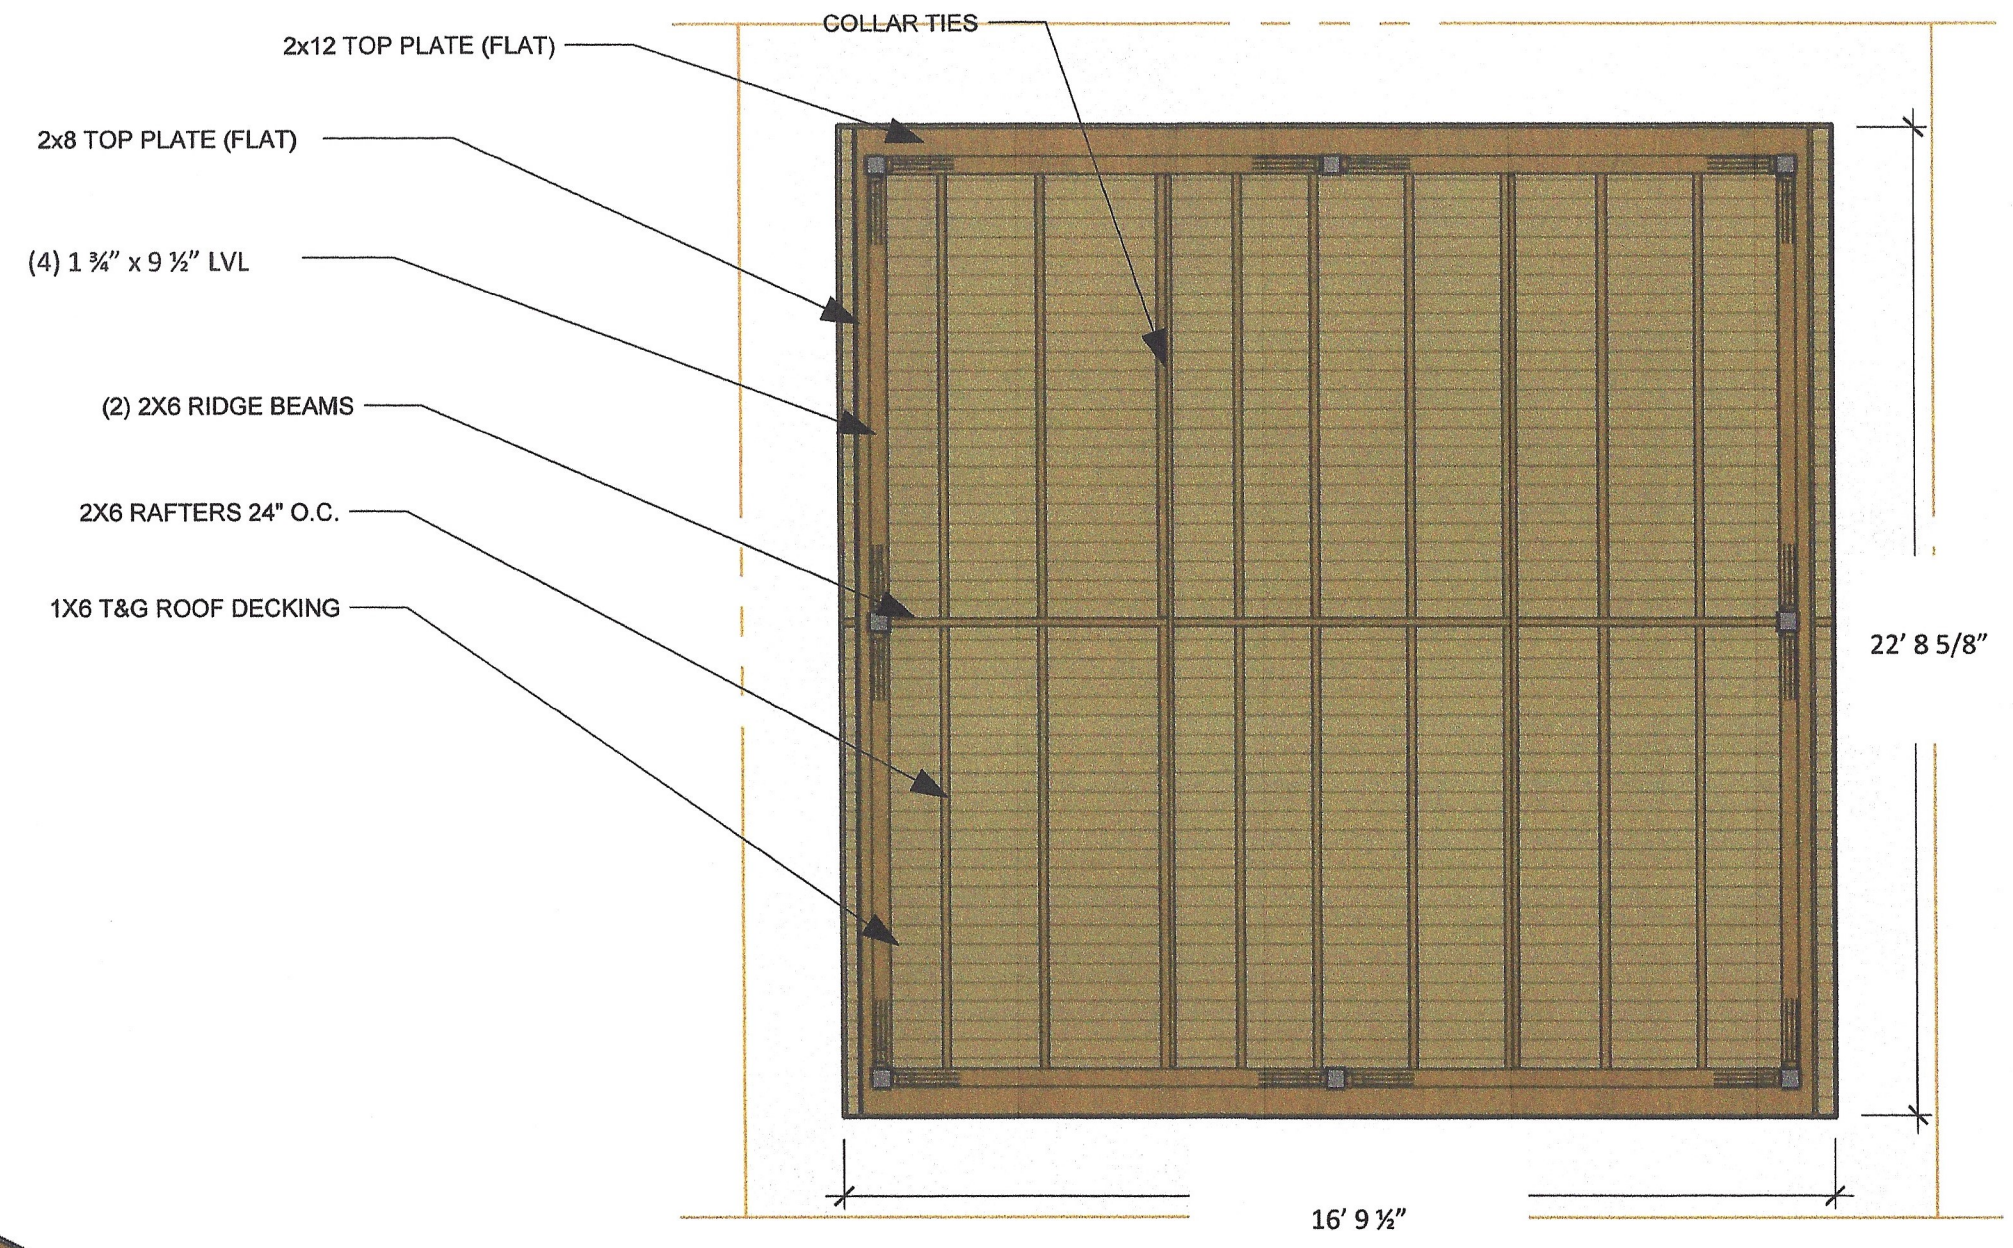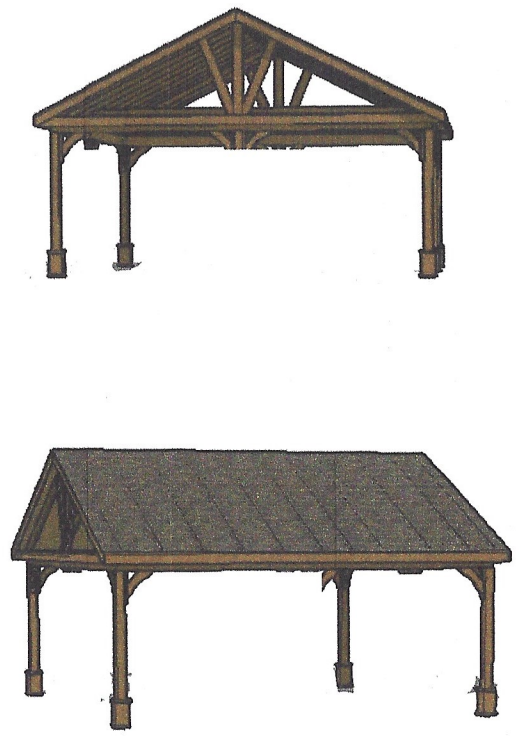


**SECTION**  
SCALE: 1/4" = 1'-0"


RAFTERS ARE FASTENED TO RAFTER PLATE w/ (5) 3" NAILS (ONE ON TOP INTO PLATE AND TWO TOE-NAILED INTO PLATE ON EACH SIDE)

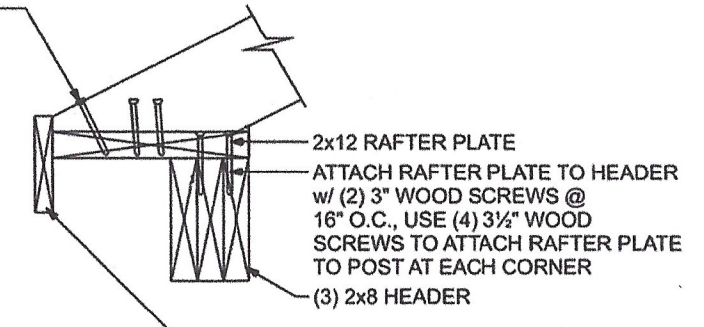


**RAFTER CONNECTION DETAIL**

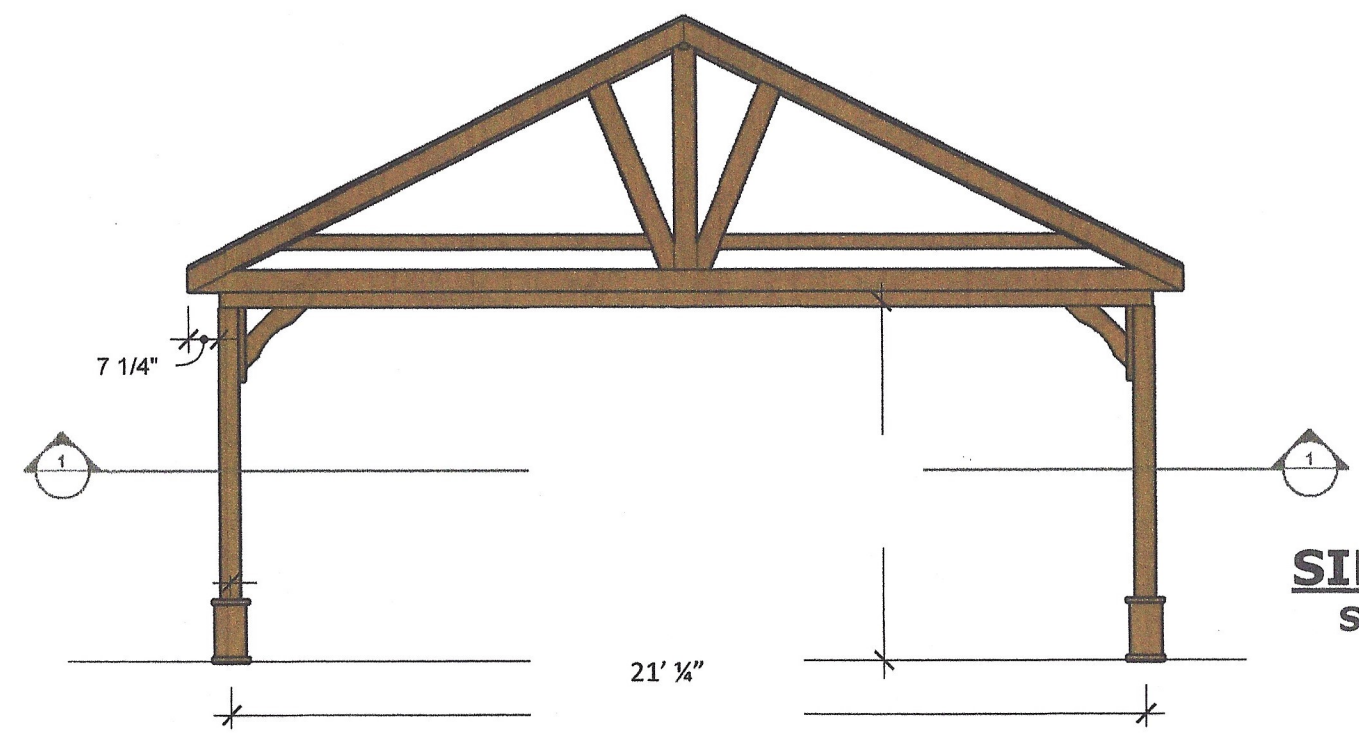




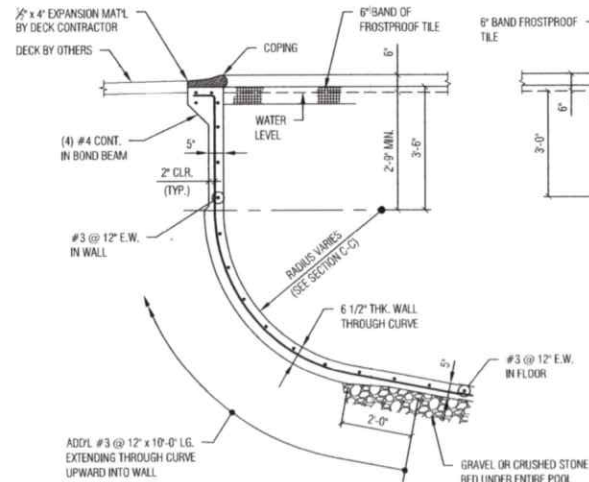


SECTION A  
DEEP END

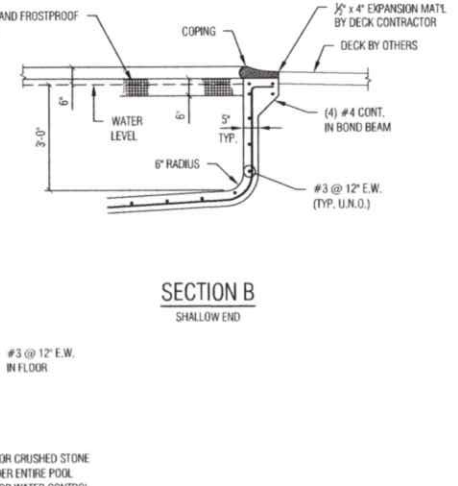

SECTION B  
SHALLOW END

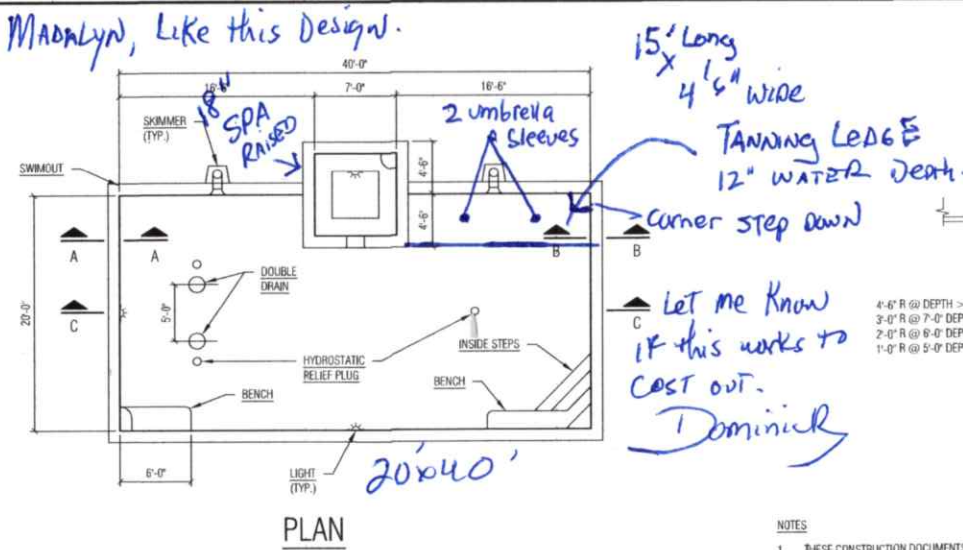

PLAN

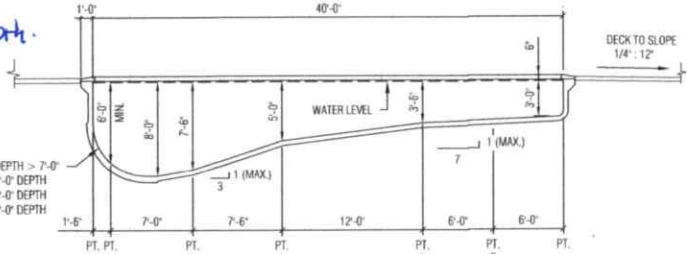


SECTION C-C

ANSI/NSPI-5


POOL TYPE	MAX DIVING BOARD LENGTH	MAX HEIGHT OVER WATER	MINIMUM DEPTHS AT POINT				MINIMUM WIDTHS AT POINT				MINIMUM LENGTHS BETWEEN POINTS								
			A	B	C	D	A	B	C	D	WA	AB	BC	CD	DE	WE			
0																			

**DIVING EQUIPMENT IS PROHIBITED**


- NOTES**
1. THESE CONSTRUCTION DOCUMENTS ARE STANDARDS AND APPLY TO ALL POOL SHAPES.
  2. POOL FLOOR TO BE PLACED ON UNDISTURBED NATURAL SOIL. NATURAL SOIL SHALL BE A WELL DRAINING GRANULAR TYPE WITH A MINIMUM ALLOWABLE BEARING CAPACITY - 2,000 PSF.
  3. POOL STRUCTURES DESIGNED IN ACCORDANCE WITH THE AMERICAN CONCRETE INSTITUTE (ACI) STANDARD FOR "BUILDING CODE REQUIREMENTS FOR REINFORCING CONCRETE - 318".
  4. PNEUMATICALLY APPLIED CONCRETE TO DEVELOP A MINIMUM COMPRESSIVE STRENGTH OF 4,000 PSI @ 28 DAYS.
  5. ALL STEEL REINFORCING SHALL BE DEFORMED BARS COMPLYING WITH AMERICAN SOCIETY FOR TESTING AND MATERIAL (ASTM) SPECIFICATION A615-40. LAP BARS A MINIMUM OF 15 INCHES.
  6. POOL SHELL CONSTRUCTION SHALL BE IN CONFORMANCE WITH ALL APPLICABLE ANSINSPOL STANDARDS, LATEST EDITIONS.
  7. ALL SUCTION DRAINS SHALL HAVE A MINIMUM SEPARATION OF 36".
  8. ALL SUCTION COVERS MUST COMPLY WITH ANSIVASME A112.19.8M.
  9. THE POOL SHELL DESIGN DOES NOT CONSIDER ANY HARDSCAPE/LANDSCAPE SURCHARGE LOADS.

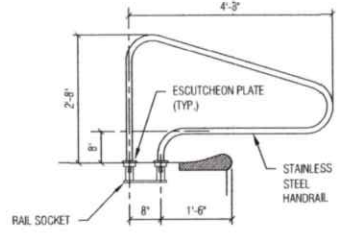


DECK MOUNTED HANDRAIL  
(OPTIONAL)

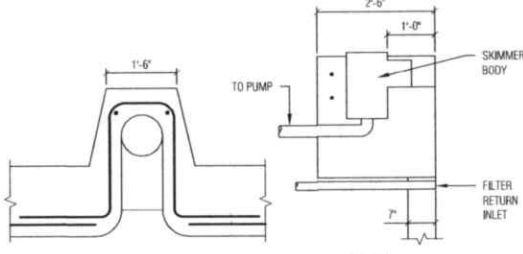


SKIMMER DETAIL

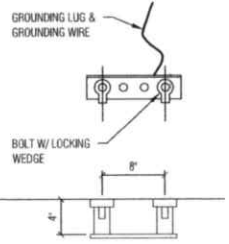


DECK MOUNTED STAIR/SPA  
RAIL SOCKET DETAIL  
(OPTIONAL)

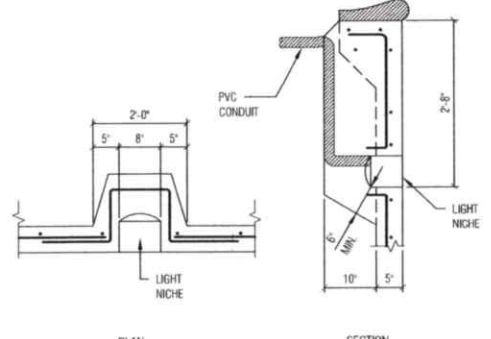


LIGHT NICHE DETAIL

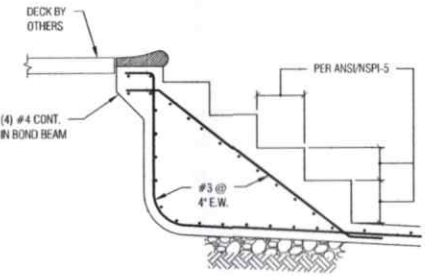

STEP DETAIL

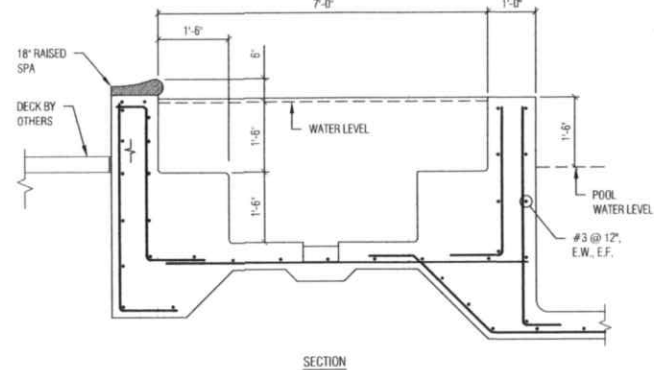

SPA DETAIL

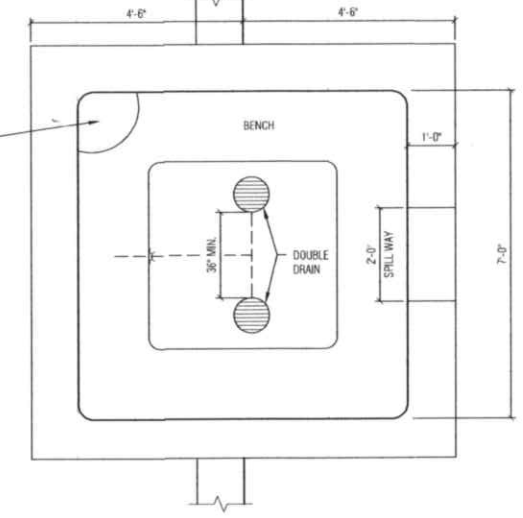

BENCH DETAIL

**engineering, LLC**  
1606 N. 18th Street  
Rear Building  
Allentown, PA 18104  
610-730-2221

**structural engineers**

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D. SCOTT BIGLEY  
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**BLUE HAVEN POOLS**  
CALVITTI POOLS AND SPAS INC.  
BLUE HAVEN POOLS & SPAS  
2273 NORTH PENN ROAD  
HATFIELD, PA 19440  
P: 732-882-4960 #6296

**JEFFREY & MADALYN STILLMAN RESIDENCE**  
246 BEDFORD BANKSVILLE ROAD  
BEDFORD, NY 10506

PROJECT

REVISION/RELEASE	ISSUED FOR CONSTRUCTION
0	11/15/2021
1	
2	
3	

DRAWING TITLE  
**CUSTOM POOL PLAN**

DESIGNED	SB
DRAWN	MS
CHECKED	SB
JOB. NO.	BHPS2136
SCALE	AS NOTED
DATE	11/15/2021

DWG. NO. **S101**  
SHEET NO. 1 OF 1 SHEET(S) REV. 0