

ADDRESS:

TOWN OF NORTH CASTLE

WESTCHESTER COUNTY 17 Bedford Road Armonk, New York 10504-1898

RESIDENTIAL PROJECT REVIEW COMMITTEE Adam R. Kaufman AICP, Chair

Section III- DESCRIPTION OF WORK:

NOW PATRO

Telephone: (914) 273-3000 x 43

Fax: (914) 273-3554

www.norteastleny.com

RESIDENTIAL PROJECT REVIEW COMMITTEE (RPRC) APPLICATION Section I- PROJECT Novikely Committee (RPRC) Application

NOVECK PEROVATION

WOODCREST DRIVE

NEW EXTENSION TO DECK

NEW HARDIE SIDING

Section III- CONTACT INFORMATION:
APPLICANT: MICHAEL PLECEPHO ARCHITETURE PLE
ADDRESS: 345 KEAR STOREST S
PHONE: 914-3160-938 MOBILE: EMAIL: MICHAEL EM PILLIPILLO ARCHITETT ION PROPERTY OWNER:
PROPERTY OWNER:
Scott Novack
ADDRESS: 43 NIVER WOODCREST DRIVE
PHONE: MORILE CITY (AC VICE
PHONE: MOBILE: 9/7. 639. 4/YEMAIL: NOVY 27/5 & GMAIL. MM
PROFESSIONAL:: MICHAEL PLUICATION APPHATONIST PLLC
ADDRESS: 345 JEERR STRAIT SUITE 203
PHONE 914-26 \$ 42-2
PHONE: 914-36 \$.4838MOBILE:
EMAIL: MICHAGO @M PICCIPILLO A PCHITOUT. CON
Section IV- PROPERTY INFORMATION:
Zone: P-ZA Tax ID (lot designation)



Town of North Castle Residential Project Review Committee

17 Bedford Road Armonk, New York 10504 (914) 273-3542 (914) 273-3554 (fax)

RPRC COMPLETENESS REVIEW FORM

This form represents the standard requirements for a completeness review for all Residential Project Review Committee submissions. Failure to provide all of the information requested will result in a determination that the application is incomplete.

The analysis of the second sec
Project Name on Plan:
— Novack Repovation
■Initial Submittal □Revised Preliminary
Street Location:43 Woodcrest Drive
Zoning District: R-2A Property Acreage: 1.12 Tax Map Parcel ID: 95.03-1-28
Date: 05-03-22
DEPARTMENTAL USE ONLY
Date Filed: Staff Name:
Preliminary Plan Completeness Review Checklist Items marked with a are complete, items left blank are incomplete and must be completed, "NA" means not applicable.
1. Plan prepared by a registered architect or professional engineer
Aerial photo (Google Earth) showing the applicant's entire property and adjacent properties and streets
β. Map showing the applicant's entire property and adjacent properties and streets
A locator map at a convenient scale
The proposed location, use and design of all buildings and structures
Existing topography and proposed grade elevations
Location of all existing and proposed site improvements, including drains, culverts, retaining walls and fences



TOWN OF NORTH CASTLE

WESTCHESTER COUNTY 17 Bedford Road Armonk, New York 10504-1898

PLANNING DEPARTMENT Adam R. Kaufman, AICP Director of Planning

Telephone: (914) 273-3542 Fax: (914) 273-3554 www.northcastleny.com

GROSS LAND COVERAGE CALCULATIONS WORKSHEET

	GROSS LAND CO	VERAGE CAECCEATI	ONS WORK	HEET
Applica	tion Name or Identifying Title:	NOVAK	Date:	1/25/22
Tax Maj	p Designation or Proposed Lot No.:	95.03-1-28		
Gross L	ot Coverage			
1.	Total lot Area (Net Lot Area for Lo		48,935	
2.	Maximum permitted gross land co		9833.75	
3.	BONUS maximum gross land cover			
8	Distance principal home is beyond o x 10 =	minimum front yard setback		0
4.	TOTAL Maximum Permitted gro	oss land coverage = Sum of lines 2	and 3	9833.75
5.	Amount of lot area covered by prin 1581 existing + 0			1,581
6.	Amount of lot area covered by acce			0
7.	Amount of lot area covered by decl 1670 existing + 17			1687
8.	Amount of lot area covered by pore o existing + o			0
9.	Amount of lot area covered by driv 1844 existing + 0	reway, parking areas and walkways _ proposed =	s:	1844
10.	Amount of lot area covered by terr o existing + o			0
11.	Amount of lot area covered by tenr o existing + o	nis court, pool and mechanical equi _ proposed =	p:	0
12.	Amount of lot area covered by all o			0
13. Prop	ose tened coverage: T	tal of Lines $5 - 12 =$		5,112
If Lingthe projection to the projection of the p		ur proposal complies with the Town roject Review Committee for review s.		
			4/25/22	
Signa	Preparing	Worksheet	Date	

NOVAK RESIDENCE RENOVATION

43 WOODCREST DRIVE ARMONK, NEW YORK 10504

ABBREVIATIONS

AB AT A.F.F ADD. A/C ALT	ANCHOR BOLT ACOUSTICAL TILE ABOVE FINISHED FLOOR ADDENDUM AIR CONDITIONING ALTERNATE	DIAM DIM DN DWG D.F.	DIAMETER DIMENSION DOWN DRAWING DRINKING FOUNTAIN	INCL. I.D. INSUL INT INV	INCLUDING INSIDE DIAMETER INSULATION INTERIOR INVERT
ALUM ANOD	ALUMINUM ANODIZED	ELEC E.W.C.	ELECTRICAL ELEC. WATER COOLER	JT	JOINT
ARCH	ARCHITECTURAL	ELEV EQ	ELEVATION EQUAL	LAM LAV	LAMINATE LAVATORY
BSMT BIT	BASEMENT BITUMINOUS	EXP EXT.	EXPOSED EXTERIOR	L.F.	LINEAR FOOT
BLKG BD	BLOCKING BOARD	EXP. JT.	EXPANSION JOINT	MTL MAS	METAL MASONRY
BLDG	BUILDING	FIN F.F.E.	FINISH FINISHED FLOOR ELEV.	MFR M.O.	MANUFACTURER MASONRY OPENING
CAB CIP	CABINET CAST IN PLACE	F.P.S.C. FLR	FIRE-PROOF, SELF-CLOSING FLOOR	MECH MIN	MECHANICAL MINIMUM
CPT C.B.	CARPET CATCH BASIN	FTG FND	FOOTING FOUNDATION	NOM	NOMINAL
CLG CEM	CEILING CEMENT	GALV	GALVANIZED	N.I.C. N.T.S.	NOT IN CONTRACT NOT TO SCALE
C.T. COL	CERAMIC TILE COLUMN	GA GYP. BD.	GAUGE GYPSUM BOARD	O.A.I.	OUTSIDE AIR INTAKE
CONC CMU	CONCRETE CONC. MASONRY UNIT	HD. WD.	HARDWOOD	O.C. O.H.	ON CENTER OVERHANG
CONST CONT	CONSTRUCTION CONTINUOUS	HDR HT	HEADER HEIGHT	OPNG OPP	OPENING OPPOSITE
C.F. C.Y.	CUBIC FEET CUBIC YARD	HM HB	HOLLOW METAL HOSE BIB	O.D. OPT	OUTSIDE DIAMETER OPTION OR OPTIONAL

NEW INTERIOR FINISHES SHALL COMPLY WITH 2020 NYS RESIDENTIA CODE -INTERIOR WALL AND CEILING FINISHES & CORRIDOR FINISHES SHALL BE A MIN CLASS "C" FLAME SPREAD AND SMOKE DEVELOPMENT INDEX -EXIT PASSAGE FINISHES SHALL BE A MIN CLASS "B" FLAME SPREAD AND SMOKE

DEVELOPMENT INDEX -INTERIOR FLOOR FINISHES SHALL COMPLY WITH THE DOC FF 1 "PILL TEST"

-EXTINGUISHERS SHALL BE SELECTED, INSTALLED, MAINTAINED IN ACCORDANCE WITH NFPA 10. -PROVIDE (1) 2-A, EXTINGUISHER FOR EACH RETAIL SPACE, AND (2) 2-A, EXTINGUISHER FOR WAREHOUSE SPACE -EXISTING SPRINKLER SYSTEM SHALL BE MODIFIED PER NEW CONSTRUCTION TO PROVIDE THE REQUIRED COVERAGE FOR NEWLY CREATED SPACES. ALL SPRINKLER WORK/MODIFICATIONS SHALL BE DONE IN ACCORDANCE WITH NFPA

-NEW MECHANICAL WORK AND ALTERATIONS TO EXISTING MECHANICAL INSTALLATIONS SHALL CONFORM TO CHAPTER 12 OF THE 2020 NYS

-HEATING AND COOLING LOADS SHALL BE DETERMINED IN ACCORDANCE WITH THE PROCEDURES DESCRIBED IN THE ASHREA/ACCA 183. -HVAC EQUIPMENT SHALL MEET THE MINIMUM EFFICIENCY REQUIREMENT OF 2020 NYS RESIDENTIAL CODE THE HEATING SYSTEM SHALL BE CAPABLE OF MAINTAINING A MINIMUM INDOOR

TEMPERATURE OF 68 DEG. F AT A POINT 3'-0" ABOVE THE FLOOR ON THE DESIGN HEATING DAY. -G.C. SHALL PROVIDE SYSTEM SPECIFICATIONS FOR ARCHITECT REVIEW. -EACH

HEATING/COOLING SYSTEM SHALL BE PROVIDED WITH THERMOSTATIC -SUPPLY AND RETURN AIR DUCTS IN UNCONDITIONED SPACES SHALL BE INSULATED WITH MIN. R-5 INSULATION -ALL EQUIPMENT SHALL BE INSTALLED PER MANUFACTURERS SPECIFICATIONS

- PROPER CLEARANCES SHALL BE MAINTAINED TO ALL INSPECTION, SERVICE, REPAIR, OR REPLACEMENT WITHOUT REMOVING ELEMENTS OF PERMANENT CONSTRUCTION.

SERVICE WATER HEATING EQUIPMENT SHALL MEET THE MINIMUM EFFICIENCY REQUIREMENT OF 2020 NYS RESIDENTIAL CODE

-ALL PLUMBING FIXTURES AND DRAINS USED TO RECIEVE OR DISCHARGE LIQUID WASTE SHALL BE DIRECTLY CONNECTED TO THE SANITARY DRAINAGE SYSTEM IN ACCORDANCE WITH 2020 NYS RESIDENTIAL CODE. -ALL PLUMBING FIXTURES AND APPLIANCES USING WATER SHALL BE CONNECTED TO THE WATER SUPPLY SYSTEM IN ACCORDANCE WITH 2015 IPC.

-THE SUPPLY LINES AND FITTINGS FOR EVERY PLUMBING FIXTURE SHALL BE INSTALLED SO AS TO PREVENT BACKFLOW IN ACCORDANCE WITH ASME A 112.18.1 -STRAINER PLATES AND DRAIN INLETS SHALL BE DESIGNED AND INSTALLED SO THAT ALL OPENINGS ARE NOT GREATER THEN 0.5" IN LEAST DIMENSION

- OPENINGS FOR PIPES MADE IN FLOORS, WALL, AND CEILINGS SHALL BE CLOSED AND PROTECTED BY INSTALLATION OF APPROVED METAL COLLARS THAT ARE FASTENED TO THE STRUCTURE. EXTERIOR WALL AND ROOF OPENINGS SHALL BE MADE WATER TIGHT WITH APPROVED FLASHING. -BURIED PIPING SHALL BE SUPPORTED THROUGHOUT ITS ENTIRE LENGTH. PIPE TRENCHES SHALL BE LINED WITH FINE GRAVEL.

-THE DEISGN OF WATER DISTRIBUTION SYSTEM SHALL CONFORM TO ACCEPTED ENGINEERING PRACTICE. METHODS UTILIZED TO DETERMINE PIPE SIZES SHALL BE APPROVED

-WATER SERVICE AND DISTRIBUTION PIPE SHALL CONFORM TO NSF 61.

-NEW ELECTRICAL COMPONENT, EQUIPMENT, AND SYSTEMS AND ALTERATIONS TO EXISTING ELECTRICAL INSTALLATIONS SHALL CONFORM TO NFPA 70.

NEW FUEL GAS WORK AND ALTERATIONS TO EXISTING FUEL GAS INSTALLATIONS SHALL CONFORM TO THE 2020 NYS RESIDENTIAL CODE.

REFERENCE SYMBOLS

INTERIOR ELEVATION

SHEET NUMBER

NAME ROOM NAME SYMBOL

100 ROOM REFERENCE I.D.

ENERGY CODE COMPLIANCE

RESIDENTIAL ENERGY EFFICIENCY

PRESCRIPTIVE REQUIREMENTS:

FENESTRATION U-FACTOR- 0.35

CEILING R-VALUE- 49

WALL R-VALUE- 20

THEIR FRAMING

RESIDENTIAL CODE.

INSULTED TO MIN. R-3

ENVELOPE)

VALUES)

FLOOR R-VALUE- 19

2020 NYS RESIDENTIAL CODE, CHAPTER 4:

(REFER TO PLANS FOR PROJECT INSULATION

-THE BUILDING THERMAL ENVELOPE SHALL BE

-WALLS AND CEILINGS SEPERATING

-RIM JOIST JUNCTION, SILL P[LATES AND

-BUILDING ENVELOPE AIR TIGHTNESS SHALL BE

TESTED IN ACCORDANCE WITH ASHREA/ASTM

- PROVIDE A MINIMUM OF ONE THERMOSTATE

-DUCTS IN ATTIC SHALL BE INSULATED TO MIN.

COMPLETELY WITHIN THE BUILDING THERMAL

-ALL DUCTS SHALL BE SEALED AND COMPLY

-HOTAND COLD WATER PIPES SHALL BE

SHOWING COMPLIANCE WITH ABOVE.

WITH M1601.3.1 OF 2020 NYS RESIDENTIAL CODE

-HEATING AND COOLING EQUIPMENT SHALL BE

SIZED IN ACCORDANCE WITH ACCA MANUAL J.

GC SHALL PROVIDE SYSTEM SPECIFICATIONS

LIGHTING FIXTURES SHALL BE HIGH-EFFICIENCY

-A MINIMUM OF 50% OF LAMPS SHALL BE IN

R-8. ALL OTHER DUCTS SHALL BE INSULATED TO

CAPABLE OF AUTOMATICALLY ADJUSTING

SPACE TEMPERATURE PER 2020 NYS

MIN. R-6 (EXCEPT DUCTS LOCATED

-ALL JOINTS, SEAMS, AND PENETRATIONS

-JOINTS AROUND DOORS/WINDOWS AND

DURABLY SEALED TO LIMIT INFILTRATION.

-UTILITY PENETRATIONS

CONDITIONED SPACE

-ATTIC ACCESS OPENINGS

CONDITIONED FROM NON

(A) GRID SYMBOL BUILDING SECTION - SHEET NUMBER ← GRID LINES

PARTIAL SECTION

BLOW-UP DETAIL SHEET NUMBER

EXTERIOR ELEVATION ● SHEET NUMBER

SPEED (MPH)

✓ WINDOW LOCATION SYMBOL

—DOOR LOCATION SYMBOL A→ WINDOW REFERENCE I.D. REVISION SYMBOL

GROUND

SNOW

LOAD

REVISION I.D.

PLASTIC LAMINATE

POLYVINYL CHLORIDE

POUNDS PER CUBIT FOOT

POUNDS PER SQUARE FOOT

POUNDS PER SQUARE INCH

REFLECTED CEILING PLAN

PLYWOOD

POLISHED

PLASTER

QUARRY TILE

REINFORCED

ROUGH OPENING

SPECIFICATION

SQUARE FOOT

SQUARE YARD

STAINLESS STEEL

REVISION

RISER

ROOM

SYMBO

REQUIRED

PLWD

P.S.I.

POL

QT

REINF

STL

SYM

— ELEVATION LEVEL LINE

WIND DESIGN

TELEPHONE

TELEVISION

TOP OF SLAB

TOP OF STEEL

TOP OF CURB

TREAD (S)

TYPICAL

URINAL

VERTICAL

WAINSCOT

WEIGHT

WOOD

WIDE, WIDTH

WITH

T.O.W. TOP OF WALL

TONGUE AND GROOVE

UNDERWRITERS LABORATORY

UNLESS NOTED OTHERWISE

VINYL COMPOSITION TILE

VAPOR BARRIER

WATER CLOSET

WATERPROOFING

WATER RESISTANT

WEATHERSTRIPPING

WELDED WIRE FABRIC

TOP AND BOTTOM

THICKNESS

THK

T&G

T.O.S.

T.O.STL

T.O.C.

UL

UR

VERT

WC

WP

W.W.F

T&B

GENERAL NOTES

1. ALL WORK SHALL CONFORM TO THE <u>2020 NYS</u> RESIDENTIAL CODE AND LOCAL CODES. ALL ELECTRICAL. SUBMITTED IN WRITING TO ARCHITECT/OWNER & PLUMBING, AND MECHANICAL WORK SHALL CONFORM TO APPROVED BY ARCHITECT/OWNER ALL NATIONAL, STATE, AND LOCAL CODES. 2. THIS LAYOUT WAS BASED ON THE GIVEN

CONFIGURATION AND FEATURES OF THE EXISITNG STRUCTURE. DIMENSIONS ARE GIVEN AS GUIDES TO ESTABLISH THE LAYOUT WITHIN THE EXISTING STRUCTURE. THE GENERAL CONTRACTOR & EACH SUBCONTRACTOR SHALL CAREFULLY SURVEY AND EXAMINE THE EXISTING STRUCTURE IN ESTABLISHING LAYOUT OF THE WORK IN ORDER TO ASSURE PROPER FIT AND ALIGNMENT OF THE NEW WORK WITH PROPER RELATIONSHIP TO EXISTING FEATURES. WHEN ESTABLISHING LAYOUT, CONTRACTOR SHALL CONTACT

CONSTRUCTION. 3. BEFORE SUBMITTING A PROPOSAL THE CONTRACTOR SHALL VISIT THE PREMISES, FAMILIARIZE THEMSELVES W/ REQUIRED. EXISTING CONDITIONS & SATISFY THEMSELVES AS TO THE NATURE AND SCOPE OF THE WORK & THE

ARCHITECT FOR APPROVAL BEFORE COMMENCING WITH

DIFFICULTIES THAT ATTEND TO ITS EXECUTION. 4. MATERIALS, WORKMANSHIP AND INSTALLATION SHALL BE IN STRICT COMPLIANCE WITH NOT ONLY THE MANUFACTURERS' PRINTED INSTRUCTIONS, BUT ALSO THE STANDARDS OF RECOGNIZED AGENCIES OR ASSOCIATIONS.

5. ALL MATERIALS SHALL BE NEW, UNLESS OTHERWISE 6. PROVIDE TEMPORARY PROTECTION OF MATERIALS

AND EQUIPMENT CONTRACTOR SHALL PROTECT EXISTING FROM DAMAGE DURING CONSTRUCTION. 8. IT IS INTENDED THAT THE CONTRACTOR PROVIDE A COMPLETE JOB. ANY OMISSIONS IN THESE GENERAL

INSTRUCTIONS OR THE OUTLINE OF WORK ARE NOT TO BE ANY AND ALL CONDITIONS WHICH MAY INTERFERE WITH CONSTRUED AS REMOVING SUCH ITEMS FROM THE RESPONSIBILITIES OF THE CONTRACTOR. 9. TIME REQUIRED TO COMPLETE THE PROJECT SHALL BE STATED IN CONTRACTOR'S PROPOSAL. AFTER AWARD 20. ALL CONSTRUCTION AND SUBCONTRACTED WORK

OF JOB, CONTRACTOR SHALL SUBMIT A CONSTRUCTION SCHEDULE FOR REVIEW, INDICATING THE SEQUENCE OF OPERATIONS AND TIME REQUIRED FOR EACH,

ESTABLISHING A TARGET DATE. 10. ALL WORK SHALL BE PERFORMED BY SKILLED AND QUALIFIED WORKMEN IN THE APPROPRIATE TRADES. CONTRACTOR SHALL KEEP SUFFICIENT WORKMEN ON THE JOB AT ALL TIMES TO PERFORM THE WORK IN THE MOST EXPEDITIOUS MANNER CONSISTENT WITH GOOD WORKMANSHIP, SOUND BUSINESS PRACTICE AND IN THE BEST INTERESTS OF THE PROJECT.

11. NO SUBSTITUTIONS WILL BE ACCEPTED UNLESS

12. CONTRACTOR SHALL PROVIDE PROPER PROTECTION FOR ALL EXISTING WORK, FURNISHINGS AND FIXTURES LIKELY TO BE DAMAGED. WHEN EXTERIOR OPENINGS ARE MADE IN EXISTING WORK, THEY SHALL BE COVERED WITH WATERTIGHT PROTECTION AT THE END OF THE DAY'S WORK. 13. PATCH, REPAIR AND REPLACE ALL EXISTING WALLS, CEILINGS AND FLOORS DAMAGED DUE TO NEW CONSTRUCTION

14. STARTING TIME AND COMPLETION FOR CONSTRUCTION IS TO BE COORDINATED WITH OWNER AND AGREED UPON BY BOTH PARTIES. 15. CONTRACTOR IS EXPECTED TO WORK ON JOB NITHOUT ANY UNREASONABLE DELAY. IF A DELAY IS TO OCCUR, NOTIFICATION TO THE OWNER SHALL BE

16. WORK PERFORMED OVER ANY SURFACE CONSTITUTES ACCEPTANCE OF THAT SURFACE FOR THE SPECIFIED QUALITY OF THE WORK BEING PERFORMED THEREON.

17. THE CONTRACTOR IS TO NOTIFY ARCHITECT IN WRITING OF ANY ADAPTATIONS TO THESE DRAWINGS OR SPECIFICATIONS REQUIRED BY LOCAL LIFE AND SAFETY CODES OR ANY OTHER GOVERNING AGENCY. 18. SINCE IT IS NOT POSSIBLE TO INDICATE ON THE DRAWINGS ALL THE EXISTING WORK TO BE REMOVED BY DASHED LINES OR NOTES, THE CONTRACTOR IS ADVISED TO ACQUAINT HIMSELF WITH THE ACTUAL CONDITIONS AT LOCATIONS WHERE ALTERATIONS

19. THE CONTRACTOR SHALL REPORT TO ARCHITECT OR OTHERWISE AFFECT OR PREVENT THE PROPER EXECUTION AND COMPLETION OF THE WORK OF THIS CONTRACT.

IS TO BE PERFORMED BY CONTRACTORS LICENSED IN THE STATE WHERE THE WORK IS BEING EXECUTED. 21. ALL CONTRACTORS ARE RESPONSIBLE TO CONFORM TO THE OWNER'S INSURANCE REQUIREMENTS AND TO PROVIDE A CERT. OF INSURANCE TO ALL PARTIES UPON AWARD OF

22. ALL CONTRACTORS ARE TO CONFORM WITH THE BUILDING OWNER'S REQUIREMENTS FOR DELIVERY TO THE SITE AND STORAGE OF ALL CONSTRUCTION MATERIALS.

23. REMOVE DEBRIS AND ABANDONED ITEMS FROM AREA AND FROM CONCEALED SPACES. CONTRACTOR TO COORDINATE REMOVAL OF DEBRIS FROM SITE SO THAT IT DOES NOT INTERFERE WITH OWNER'S ACTIVITIES. 24. PROPERLY PREPARE ALL SURFACES BEFORE APPLICATION

OF FINISHES, IN STRICT ACCORDANCE WITH THE PRINTED RECOMMENDATIONS. 25. EXECUTE PRIOR TO FINAL INSPECTION: CLEAN INTERIOR AND SITE OF THE WORK AND FROM HIS OWN EXTERIOR SURFACES EXPOSED TO VIEW, REMOVE TEMPORARY

LABELS, STAINS AND FOREIGN SUBSTANCES. CLEAN FIXTURES AND CABINETRY TO A SANITARY CONDITION. 26. PERMITS: A. GENERAL CONTRACTOR / SUBCONTRACTOR IS RESPONSIBLE FOR ALL INFORMATION AND DESIGN (INCLUDING ELECTRICAL, SPRINKLER, AND MECHANICAL) REQUIRED BY LOCAL BUILDING

OFFICIAL TO OBTAIN ALL NECESSARY BUILDING PERMITS FOR CONSTRUCTION. B. GENERAL CONTRACTOR SHALL PAY FOR ALL PERMITS REQUIRED, UNLESS OTHERWISE SPECIFIED BY OWNER. C. GENERAL CONTRACTOR SHALL OBTAIN FINAL CERTIFICATE OF OCCUPANCY UPON COMPLETION OF WORK AND SHALL FORWARD SAME TO OWNER.

27. CLEANING: A. MAINTAIN PREMISES AND PUBLIC PROPERTIES FREE FROM ACCUMULATIONS OF WASTE, DEBRIS AND RUBBISH, CAUSED BY **OPERATIONS**

B. AT COMPLETION OF WORK, REMOVE WASTE MATERIALS, RUBBISH, TOOLS, EQUIPMENT, MACHINERY AND SURPLUS MATERIALS AND CLEAN ALL SIGHT-EXPOSED SURFACES. LEAVE PROJECT CLEAN AND READY FOR OCCUPANCY. 28. WARRANTIES:

 CONTRACTOR SHALL WARRANTY THE WORK WILL BE FREE FROM DEFECTIVE MATERIALS AND WORKMANSHIP FOR A PERIOD OF ONE YEAR AFTER THE DATE OF OWNER'S ACCEPTANCE OR WITHIN SUCH PERIOD OF TIME AS MAY BE PRESCRIBED BY THE TERMS OF ANY APPLICABLE SPECIAL WARRANTY REQUIRED BY THE CONTRACT DOCUMENTS.

LICENSED AND INSURED CONTRACTOR IS RETAINED

CORRECTLY TO SUPPLY WATER ADEQUATELY.

8. LICENSED PLUMBER TO FILE PLUMBING PERMIT.

LICENSED ELECTRICAN TO FILE ELECTRICAL PERMIT

WEEKENDS AND LEGAL HOLIDAYS BETWEEN 10AM - 5PM

REPLACEMENT REQUIREMENTS UNDER 281-5.

CEILING FINISHES ARE NOT REMOVED TO THE STRUCTURE.

FEE PRIOR TO ISSUANCE OF CERTIFICATE OF OCCUPANCY.

14. ARCHITECT / ENGINEER SEAL & SIGNATURE REQUIRED ON CERTIFICATION.

DRILLING AND NOTCHING" PER THE 2020 NYS RESIDENTIAL CODE.

APPROVED AND STAMPED SET OF BUILDING PLANS MUST BE PRESENT ON SITE FOR ALL INSPECTIONS.

SHALL BE ARABIC NUMERALS OR ALPHABET LETTERS. NUMBERS SHALL NOT BE SPELLED OUT. EACH

CHARACTER SHALL NOT BE LESS THAN 4 INCHES HIGH WITH A MINIMUM STROKE WIDTH OF 0.5 INCHES.

PREMISES IDENTIFICATION REQUIRED PER F505 OF THE 2020 NYS RESIDENTIAL CODE. NEW AND EXISTING

LEGIBLE AND PLACED IN A POSITION THAT IS VISIBLE FROM THE STREET OR ROAD FRONTING THE PROPERTY

ADDRESS IDENTIFICATION CHARACTERS SHALL CONTRAST WITH THEIR BACKGROUND. ADDRESS NUMBERS

ALL CONSTRUCTION SITES SHALL CONFORM TO THE 2020 NYS RESIDENTIAL CODE PROPERTY MAINTENANCE

OR REMOVED OFFSITE IMMEDIATELY. MATERIALS SHALL BE STACKED AND ORDERLY FASHION AS TO NOT

BUILDING PERMIT UNTIL CERTIFICATE OF OCCUPANCY IS ISSUED. IF CONTRACTOR OF RECORD HAS BEEN

CODE. ALL RUBBISH GARBAGE AND CONSTRUCTION DEBRIS SHALL BE DISPOSED OF IN AN ONSITE DUMPSTER

CREATE A BLIGHT ON THE COMMUNITY. THE VILLAGE RIGHT OF WAY MUST BE KEPT CLEAR AND MAINTAINED A

A CURRENT WESTCHESTER COUNTY LICENSED AND INSURED CONTRACTOR MUST BE ON FILE WITH CURRENT

REMOVED FROM THE PROJECT, A STOP WORK ORDER WILL BE ISSUED UNTIL A NEW WESTCHESTER COUNTY

ARCHITECT / ENGINEER OF RECORD SERVICES MUST BE RETAINED UNTIL CERTIFICATE OF OCCUPANCY IS

9. HOUSE TO BE IDENTIFIED WITH TRUSS SIGN IF PRE-ENGINEERED LUMBER IS USED IN ACCORDANCE WITH TITLE

11.3. TREES IDENTIFIED TO BE REMOVED OR PROTECTED AS A RESULT OF A LAND USE BOARD DETERMINATION.

GROWING SEASONS AFTER THE ISSUANCE OF A CERTIFICATE OF OCCUPANCY OR LAND USE BOARD

REMOVAL OF ONE OR MORE TREES GREATER THAN SIX INCHES DBH THAT ARE DEAD, DYING, HAZARDOUS

OR DISEASED AS DETERMINED BY A TREE EXPERT WITHOUT A FEE AND SHALL NOT BE SUBJECT TO THE

12. COMPLY WITH THE 2020 NYS RESIDENTIAL CODE SECTION R314.1 REQUIREMENTS FOR PROPER INSTALLATION

SUPPLEMENT SMOKE ALARMS SHALL BE PERMITTED TO BE BATTERY WHERE EXISTING INTERIOR WALL OR

13. PROVIDE PROTECTION OF ADJOINING PROPERTIES PER B3307.1 OF THE 2015 INTERNATIONAL BUILDING CODE.

15. ARCHITECT / ENGINEER OF RECORD TO INSPECT AND CERTIFY FRAMING, TO INCLUDE R502.8 "CUTTING,

17. NO TEMPORARY CERTIFICATE OF OCCUPANCY PERMITTED PER THE SCARSDALE BUILDING INSPECTOR.

19. FINAL AS-BUILT SURVEY SIGNED AND SEALED BY NEW YORK STATE LICENSED LAND SURVEYOR TO BE

18. PROVIDE FINAL LOT COVERAGE CALCULATIONS WITH BREAKDOWN PRIOR TO FILING FOR CERTIFICATE OF

SUBMITTED FOR REVIEW AND APPROVAL PRIOR TO ISSUANCE OF ANY CERTIFICATE OF OCCUPANCY. THE

AS-BUILT SURVEY MUST INCLUDE ALL SITE IMPROVEMENTS (DRIVEWAYS, WALKWAYS, WALLS, PATIOS, ETC.)

OF SMOKE AND R315.1 CARBON MONOXIDE ALARMS. APPENDIX J 504.2.1 OF THE 2017 NEW YORK STATE

11.4. REMOVAL OF REPLACEMENT TREE(S) SIX INCHES OR LESS DBH THAT ARE PLANTED AS A RESULT OF A

11.5. REMOVAL OF TREE(S) DETERMINED TO BE PRESERVED BY A LAND USE BOARD FOR AT LEAST TWO

19 NYCRR PART 1265 EFFECTIVE JANUARY 1, 2015 PRIOR TO ISSUANCE OF CERTIFICATE OF OCCUPANCY.

10. USE OF OUTDOOR POWER TOOLS AND CONSTRUCTION ACTIVITY: MONDAY - FRIDAY BETWEEN 8AM - 9PM.

11. THE FOLLOWING TREE REMOVAL ACTIVITY REQUIRES A TREE REMOVAL PERMIT BY THE VILLAGE OF

SCARSDALE ENGINEERING DEPARTMENT PER VILLAGE OF SCARSDALE CODE, CHAPTER 281-4:

11.2. THE REMOVAL OF ONE OR MORE SMALL CALIPER NATIVE TREES AS IDENTIFIED UNDER 281-3A.

11.6. THE REMOVAL OF ANY TREE EXCEEDING 36 INCHES DBH, REPLACEMENT TREE REQUIRED.

11.1. THE REMOVAL OF THREE OR MORE TREES GREATER THAN SIX INCHES DBH

LAND USE BOARD DETERMINATION OR PURSUANT TO 281-11.

ON ADDITIONS AND RENOVATIONS GREATER THAN FIFTY PERCENT, PROVIDE DOCUMENTATION FROM

SCARSDALE WATER SUPERINTENDENT TO VERIFY IF EXISTING OR PROPOSED WATER LINE IS SIZED

BUILDINGS SHALL HAVE APPROVED ADDRESS IDENTIFICATION. THE ADDRESS IDENTIFICATION SHALL BE

VILLAGE OF SCARSDALE CONDITIONS:

29. CONTRACTOR AGREES THAT HE IS SKILLED AND EXPERIENCED IN THE USE AND INTERPRETATION OF PLANS AND SPECIFICATIONS. HE HAS CAREFULLY REVIEWED THE PLANS AND SPECIFICATIONS FOR HIS PROJECT AND HAS FOUND THEM TO BE FREE OF AMBIGUITIES. FURTHER, HE HAS CAREFULLY EXAMINED THE OBSERVATIONS HAS SATISFIED HIMSELF AS TO THE NATURE AND LOCATION OF THE WORK; THE CHARACTER, QUALITY, AND QUANTITY OF MATERIALS; THE DIFFICULTIES LIKELY TO BE ENCOUNTERED AND OTHER ITEMS FOUND ON THE

30. THE CONTRACTORS' EXPERIENCE, EXPERTISE AND PROFESSIONAL JUDGMENT SHALL NOT BE DISREGARDED DURING THE CONSTRUCTION PROCESS. THE CONTRACTORS' INPUT, COMMENTS AND RECOMMENDATIONS WILL BE WELCOMED AND EXPECTED BY THE OWNER AND THE ARCHITECT. CONSTRUCTION ALTERNATIVES WILL BE CONSIDERED AND EMBRACED IF THEY HAVE MERIT AND A BETTER RESULT CAN BE ACHIEVED. SUCH CHANGES MAY NOT TAKE PLACE WITHOUT THE EXPRESS APPROVAL OF THE ARCHITECT.

> ISSUED FOR PERMIT 1 07/04/21

Michael Piccirillo Architecture

DO NOT SCALE DRAWINGS. REFER TO WRITTEN MEASUREMENTS FOR ACCURANCY, OR CONTACT ARCHITECT. CONTACT ARCHITECT

UNAUTHORIZED ALTERATIONS OR ADDITIONS TO THIS DRAWING IS

A-100 DEMOLITION PLAN. FRAMING PLAN. DETAILS

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A VIOLATION OF NEW YORK STATE EDUCATION LAW.

NOTES. FLOOR PLANS,

IF THERE ARE ANY DISCECPENCIES

T-100 TITLE SHEET, NOTES

SHEET INDEX

SP-1 SITE PLAN

A-200 ELEVATION

A-302 DECK DETAILS

PROJECT NAME:

NOVAK RESIDENCE

PROJECT ADDRESS:

43 WOODCREST DRIVE ARMONK, NY 10504



MICHAEL A PICCIRILLO, AIA

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OF 11

16. ANY CHANGES TO APPROVED PLANS OR AS-BUILT PLANS WILL REQUIRE AND AMENDMENT APPLICATION AND 07-05-21 DRAWN BY: CHK'D BY: MAP

CLIMATIC AND GEOGRAPHIC DESIGN CRITERIA TABLE R301.2(1) | WINTER | ICE BARRIER AIR FLOOD HAZARDS FREEZING ANNUAL DESIGN UNDERLAYMANT DESIGN EFFECTS WIND REGION DEBRIS ZONE CATEGORY WEATHERING INDEX | TEMP TEMP REQUIREMENT TERMITE LINE 1500 OR **MODERATE** SEVERE 51.6 HEAVY LESS

CONTRACT

30 PSF | 115 MPH - 120 MPH | SMOKE ALARMS/ CARBON MONOXIDE ALARMS

TOPO SPECIAL WINDBORNE

. SMOKE DETECTORS SHALL BE INSTALLED IN ALL BEDROOMS, ADJACENT HALL, AND ONE ON EACH STORY OF DWELLING PER 2020 NYS

-ALL SMOKE ALARMS SHALL BE LISTED IN ACCORDANCE WITH UL 217 AND INSTALLED IN ACCORDANCE WITH THE PROVISIONS OF THIS CODE AND THE HOUSEHOLD FIRE WARNING **EQUIPMENT PROVISIONS OF NFPA 72.** -ALL SMOKE DETECTORS SHALL BE

INTERCONNECTED IN SUCH A MANNER THAT THE ACTUATION OF ONE ALARM WILL ACTIVATE ALL OF THE ALARMS IN THE INDIVIDUAL UNIT. THE ALARM SHALL BE CLEARLY AUDIBLE IN ALL BEDROOMS OVER BACKGROUND NOISE LEVELS WITHAL LL INTERVENING DOORS CLOSED. ALL SMOKE DETECTORS SHALL BE INSTALLED PER THE 2020 NYS RESIDENTIAL CODE, SECTION R314. 2. PROVIDE CARBON MONOXIDE DETECTORS PER 2015 THE INTERNATIONAL RESIDENTIAL CODE,

SECTION R315. 3. PROVIDE FIREBLOCKING PER THE <u>2020 NYS</u> RESIDENTIAL CODE, SECTION R602.8. PROVIDE FIRE BLOCKING IN WALL CAVITIES OR FURRED SPACES THAT EXCEED 8 FT IN HEIGHT, AROUND ALL PIPING, VENTS AND WIRING HOLES, ETC. 4. SMOKE ALARMS SHALL BE PERMITTED TO BE BATTERY OPERATED WHEN INSTALLED IN BUILDINGS WITHOUT COMMERCIAL POWER OR AN ON-SITE ELECTRICAL POWER SYSTEM, OR IN BUILDINGS WHERE EXISTING INTERIOR WALL OR CEILING FINISHES ARE NOT REMOVED TO EXPOSE THE STRUCTURE AS PER APPENDIX J 504.2.1 OF THE 2020 NYS RESIDENTIAL CODE.


ENERGY CODE NOTE: PROFESSIONAL. I ALSO CERTIFY THAT TO THE BEST OF MY PROPESSIONAL. I ALSO CENT THAT TO THE BEST OF MY PROPESSIONAL KNOWLEDGE THE BUILDING PLANS SHOWNING EN ARE IN COMPLIANCE WITH THE 2020 NYS RESIDENTIAL CODE. NATE IN COMPLIANCE WITH THE SIGNED:


PARAGRAPH R303.1 OF THE 2020 NYS RESIDENTIAL CODE.


ALL HABITABLE ROOMS HAVE BEEN PROVIDED WITH AN AGGREGATE GLAZING AREA OF NOT LESS THAN 8 PERCENT OF THE FLOOR AREA OF SUCH ROOMS. THE MINIMUM OPERABLE AREA FOR VENTILATION TO THE OUTDOORS HAVE BEEN PROVIDED AT NOT LESS THAN 4 PERCENT OF FLOOR AREA.

LIGHT AND THAT HOM NOTE THE BUILDING PLANS SHOWN HEREIN ARE IN COMPLIANCE WITH RESIDENTIAL CODE OF NEW YORK STATE. THE BUILDING PLANS DESCRIBED HEREIN COMPLIES WITH CHAPTER 3 INCLUDING

LOCATION MAP

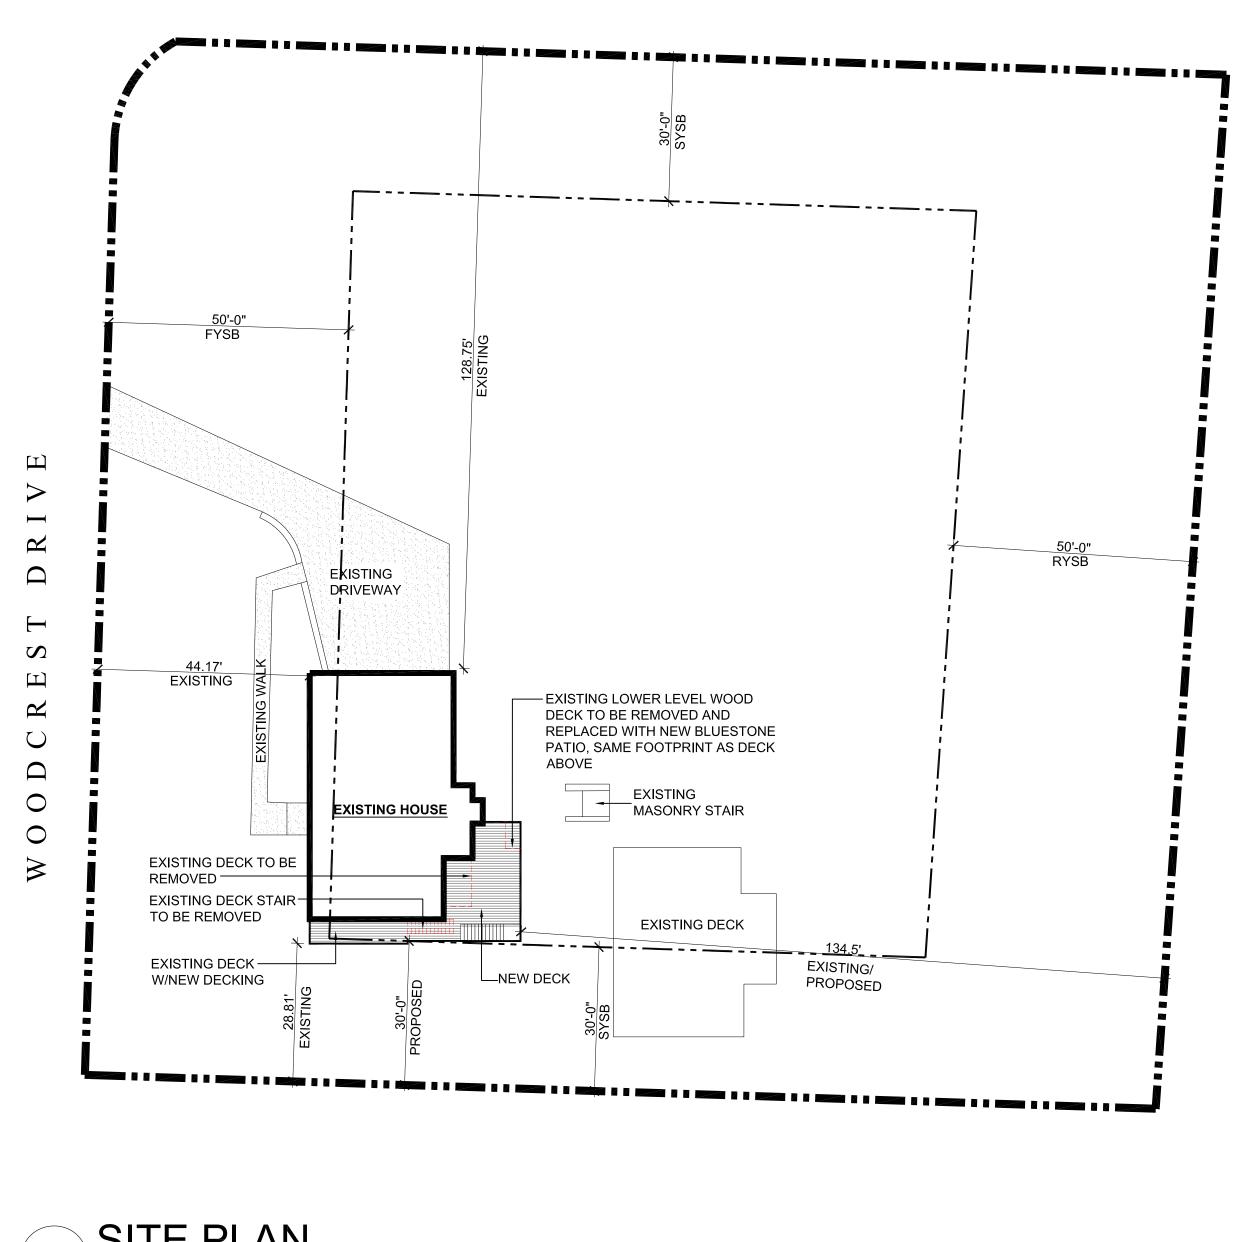


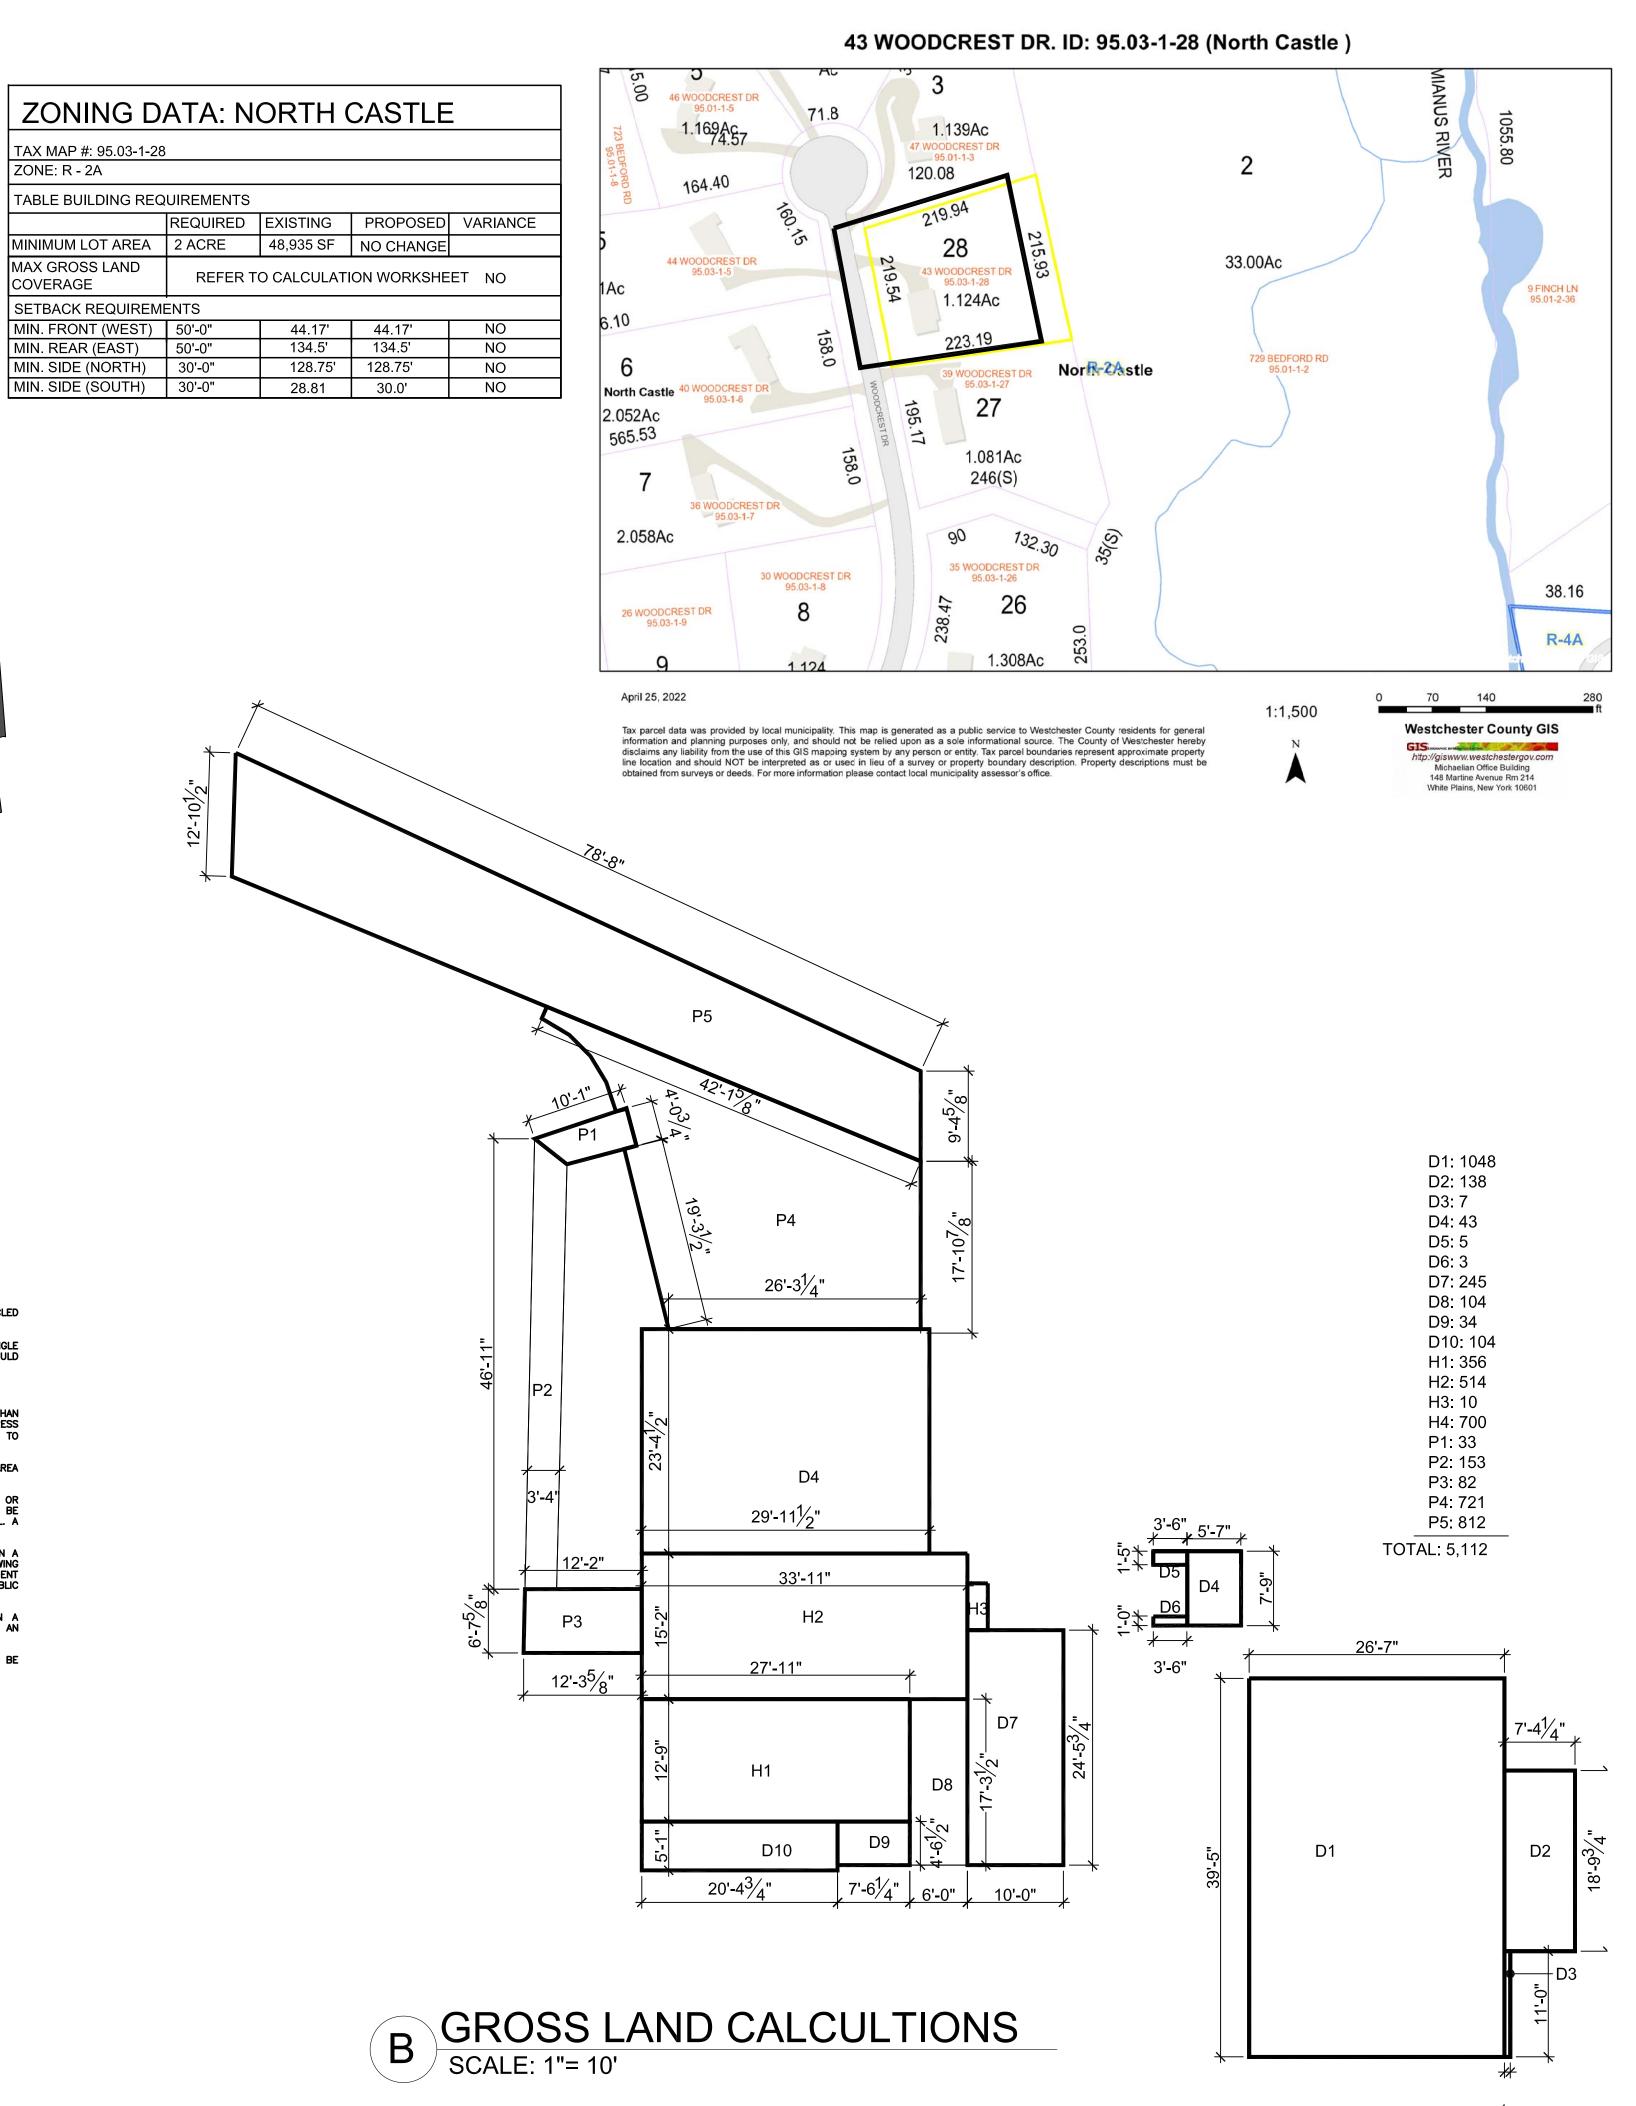

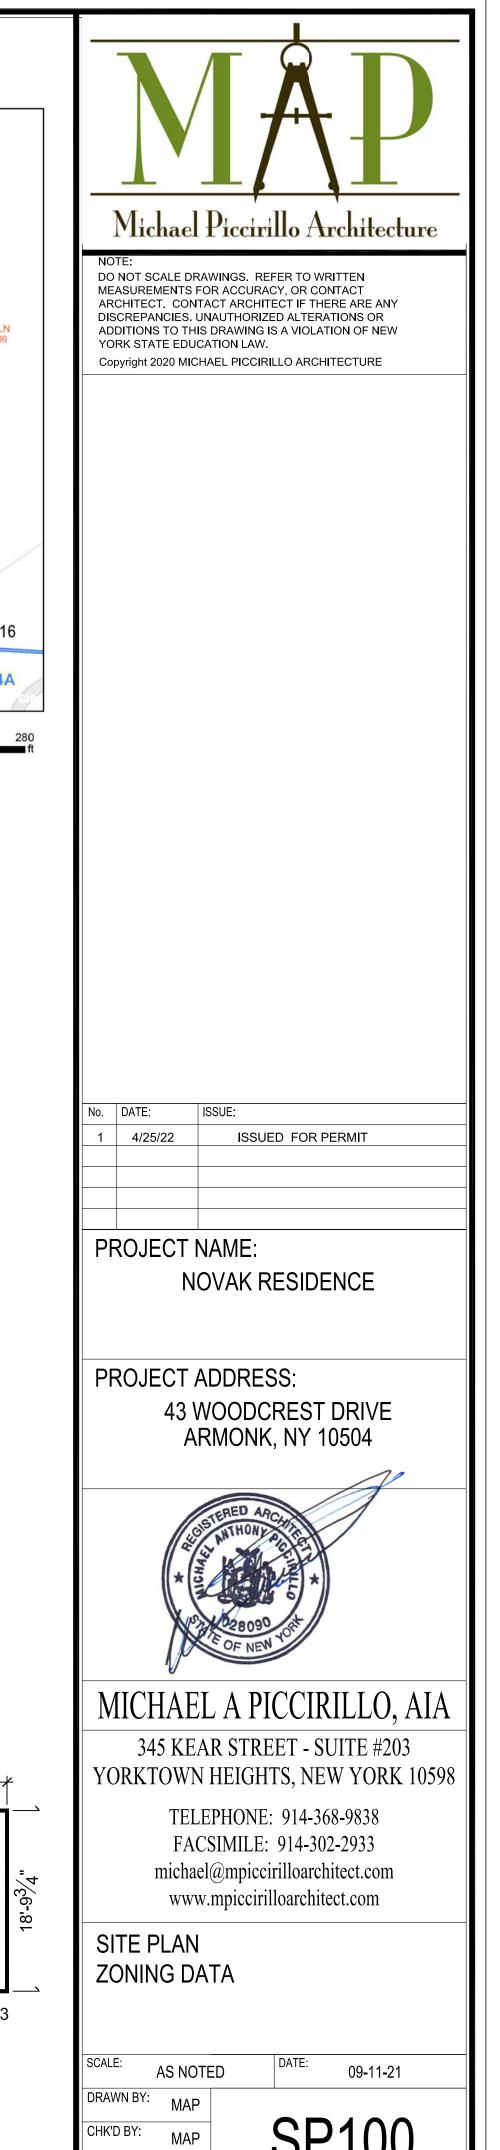

1 OF 1

SITE PLAN SCALE: 1" = 20'

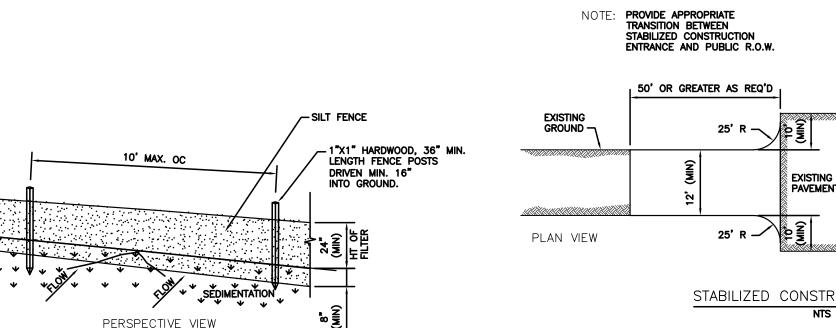

EXISTING PAVEMENT

FILTER CLOTH

PROFILE

, 50' OR GREATER AS REQ'D | PUBLIC ROW |

5.FILTER CLOTH — WILL BE PLACED OVER THE ENTIRE AREA PRIOR TO PLACING OF STONE. 6.SURFACE WATER — ALL SURFACE WATER FLOWING OR DIVERTED TOWARD CONSTRUCTION ENTRANCES SHALL BE PIPED ACROSS THE ENTRANCE. IF PIPING IS IMPRACTICAL. A MOUNTABLE BERM WITH 5:1 SLOPES WILL BE PERMITTED 7.MAINTENANCE — THE ENTRANCE SHALL BE MAINTAINED IN A CONDITION WHICH WILL PREVENT TRACKING OR FLOWING OF SEDIMENT ONTO PUBLIC RIGHTS—OF—WAY, ALL SEDIMENT SPILLED, DROPPED, WASHED OR TRACTED ONTO PUBLIC RIGHTS—OF—WAY MUST BE REMOVED IMMEDIATELY. 8. WHEN WASHING IS REQUITED, IT SHALL BE DONE ON A AREA STABILISED WITH STONE AND WHICH DRAINS INTO AN APPROVED SEDIMENT TRAPPING DEVICE. 9.PERIODIC INSPECTION AND NEEDED MAINTENANCE SHALL BE PROVIDED AFTER EACH RAIN.

3.THICKNESS - NOT LESS THAN SIX (6) INCHES.

CONSTRUCTION SPECIFICATIONS

1.STONE SIZE - USE 2" STONE, OR RECLAIMED OR RECYCLED CONCRETE EQUIVALENT.

2.LENGTH - NOT LESS THAN 50 FEET (EXCEPT ON A SINGLE RESIDENCE LOT WHERE A 30 FOOT MINIMUM LENGTH WOULD

4. WIDTH — TWELVE (12) FOOT MINIMUM. BUT NOT LESS THAN THE FULL WIDTH AT POINTS WHERE INGRESS OR EGRESS OCCURS. TWENTY—FOUR (24) FOOT IF SINGLE ENTRANCE TO SIGHT.

ZONE: R - 2A


COVERAGE


STABILIZED CONSTRUCTION ENTRANCE

1"X1" HARDWOOD, 36" MIN. LENGTH FENCE POSTS-SILT FENCE -__FLOW COMPACTED SOIL -EMBED FILTER CLOTH A MIN. OF 6" IN GROUND. CONSTRUCTION SPECIFICATIONS 1. SILT FENCE TO BE FASTENED SECURELY TO FENCE POSTS WITH STAPLES. POSTS SHALL BE 1"X1" HARDWOOD, OR APPROVED EQUAL. WHEN TWO SECTIONS OF FILTER CLOTH ADJOIN EACH OTHER THEY SHALL BE WRAPPED AROUND 2 STAKES, MIN 2X. FILTER CLOTH SHALL BE EITHER FILTER USCF MISF180, MIRAFI 100X OR APPROVED EQUIVALENT.

STOCKPILE MATERIAL -STOCKPILE SHALL BE COVERED ENTIRELY BY AN ANCHORED PLASTIC COVER OR SEEDED STOCKPILE DETAIL

3. MAINTENANCE SHALL BE PERFORMED AS NEEDED, REINFORCE AREA LOW POINTS WITH ADDITIONAL STAKES OR OTHER MATERIALS (AS RECOMMENDED BY ENGINEER). MATERIAL SHALL BE REMOVED WHEN SEDIMENT LOAD REACHES 50% HEIGHT OF FENCE. SILT FENCE INSTALLATION DETAIL

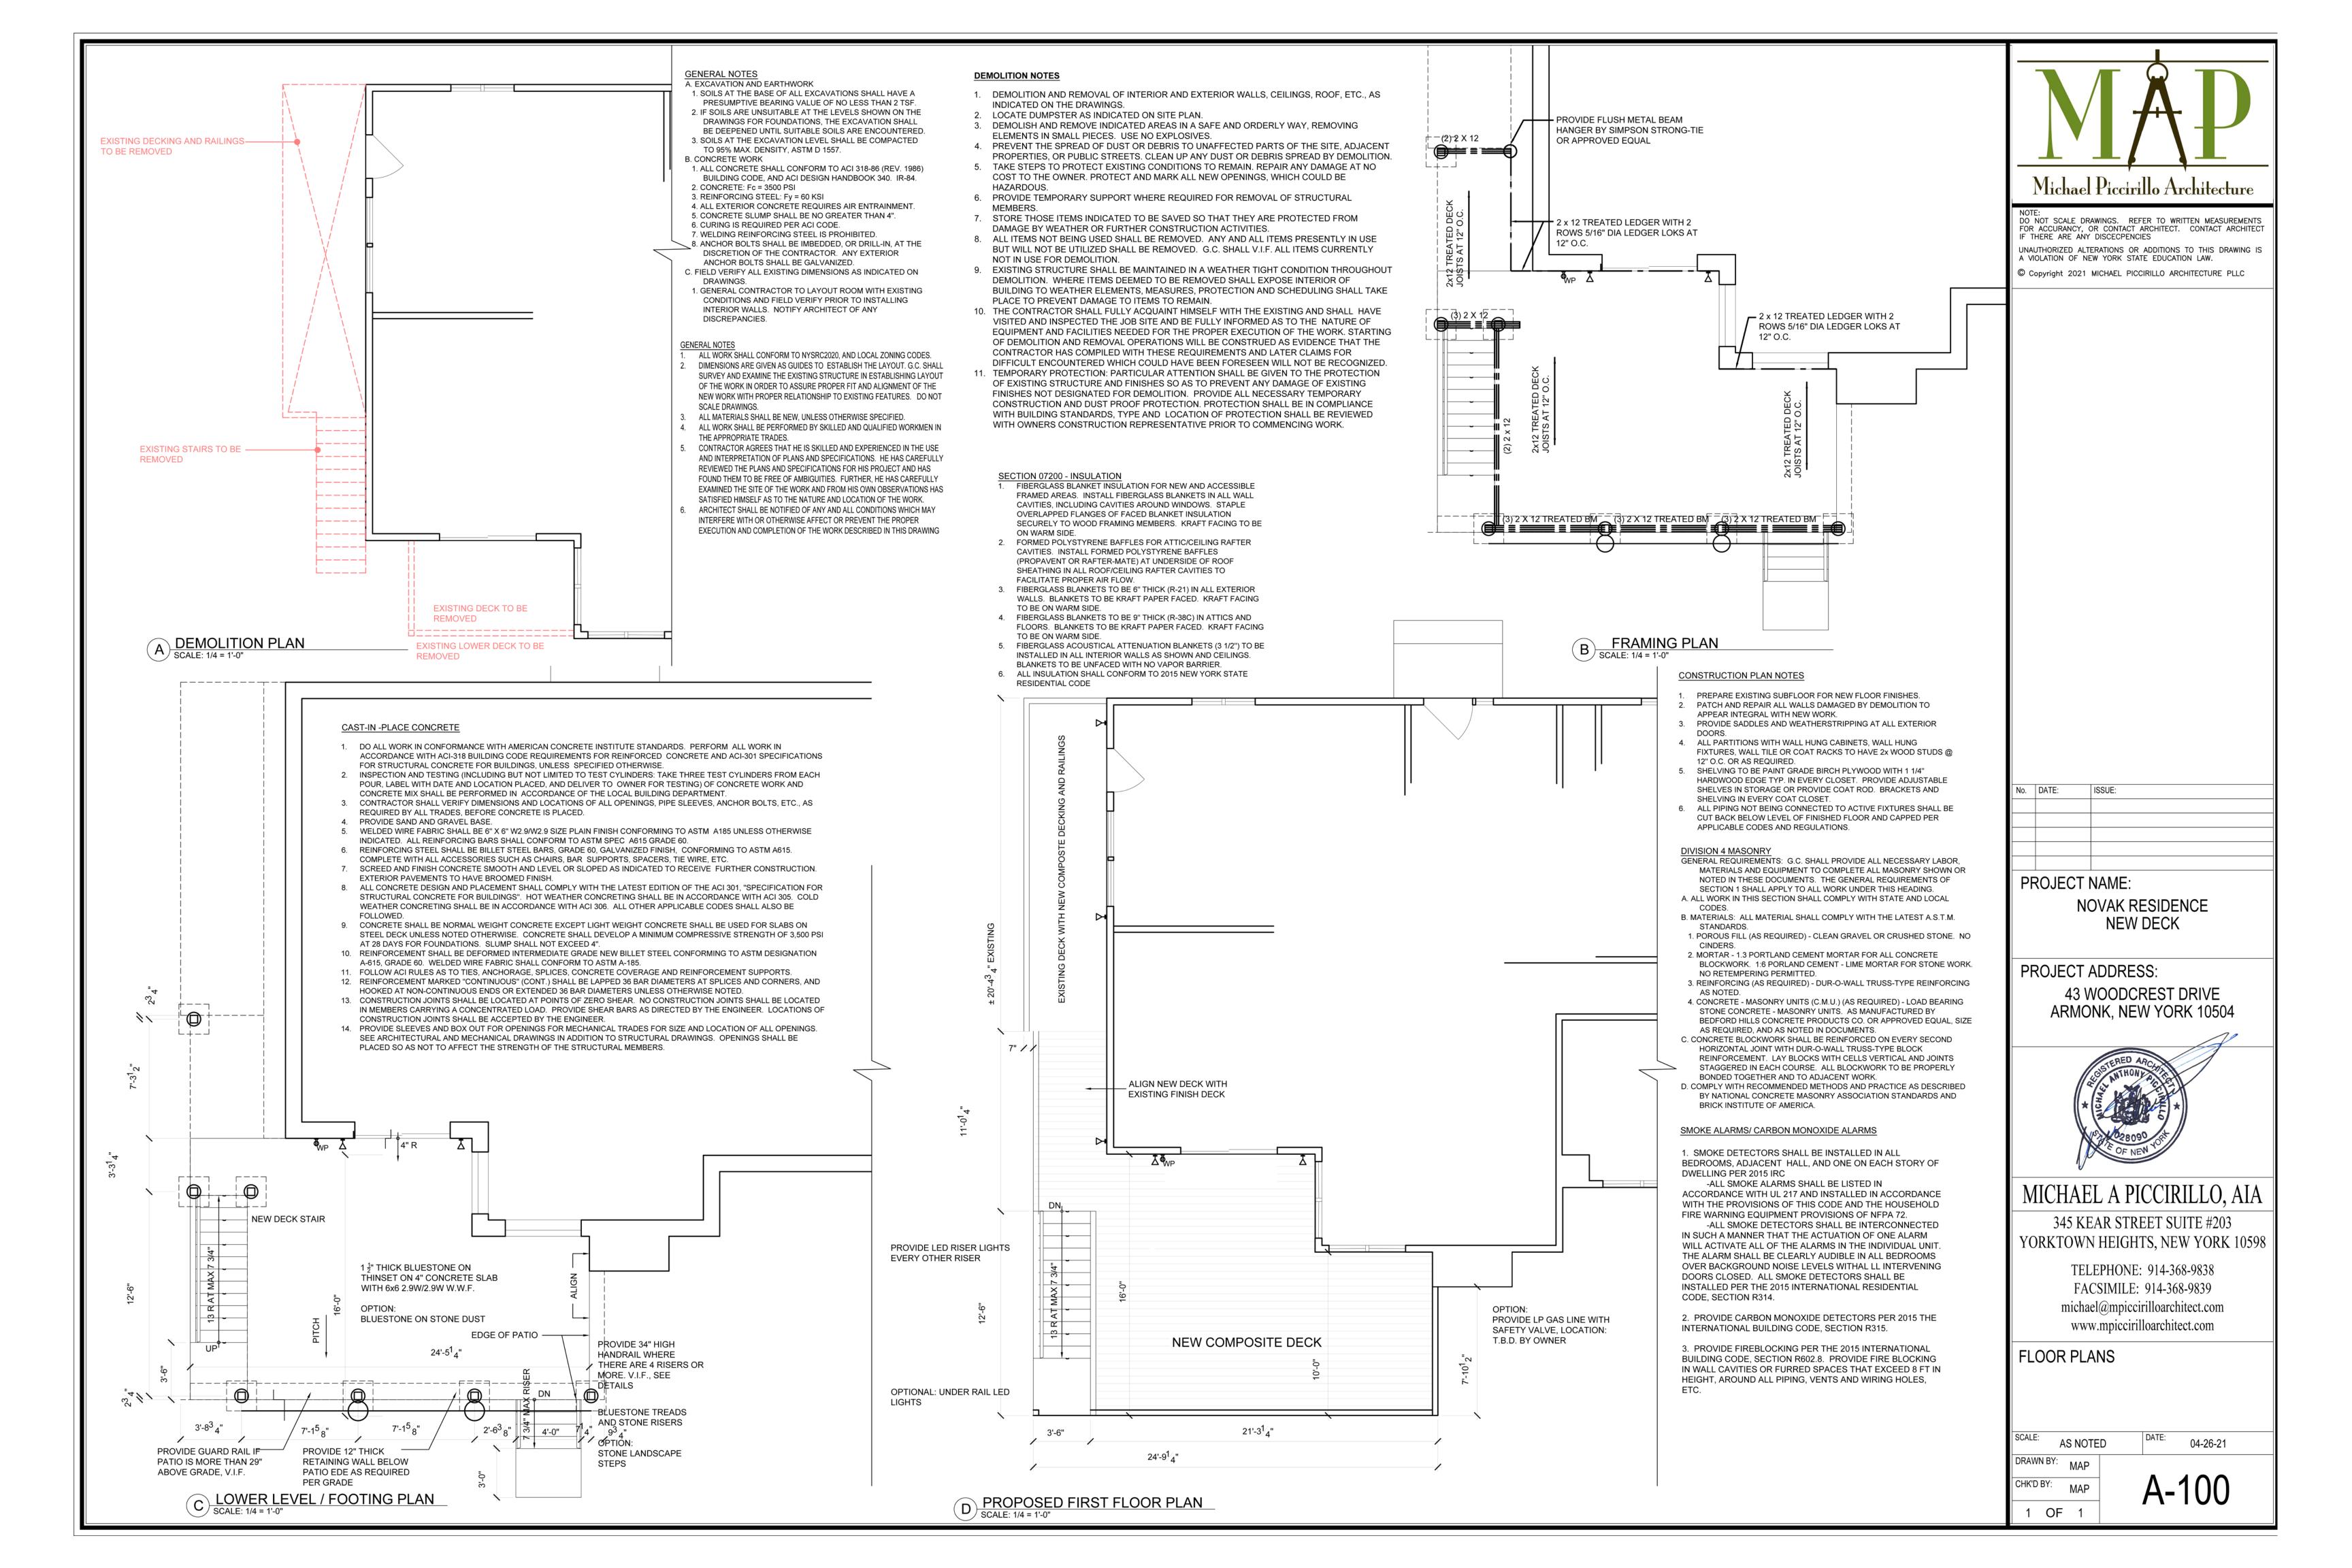

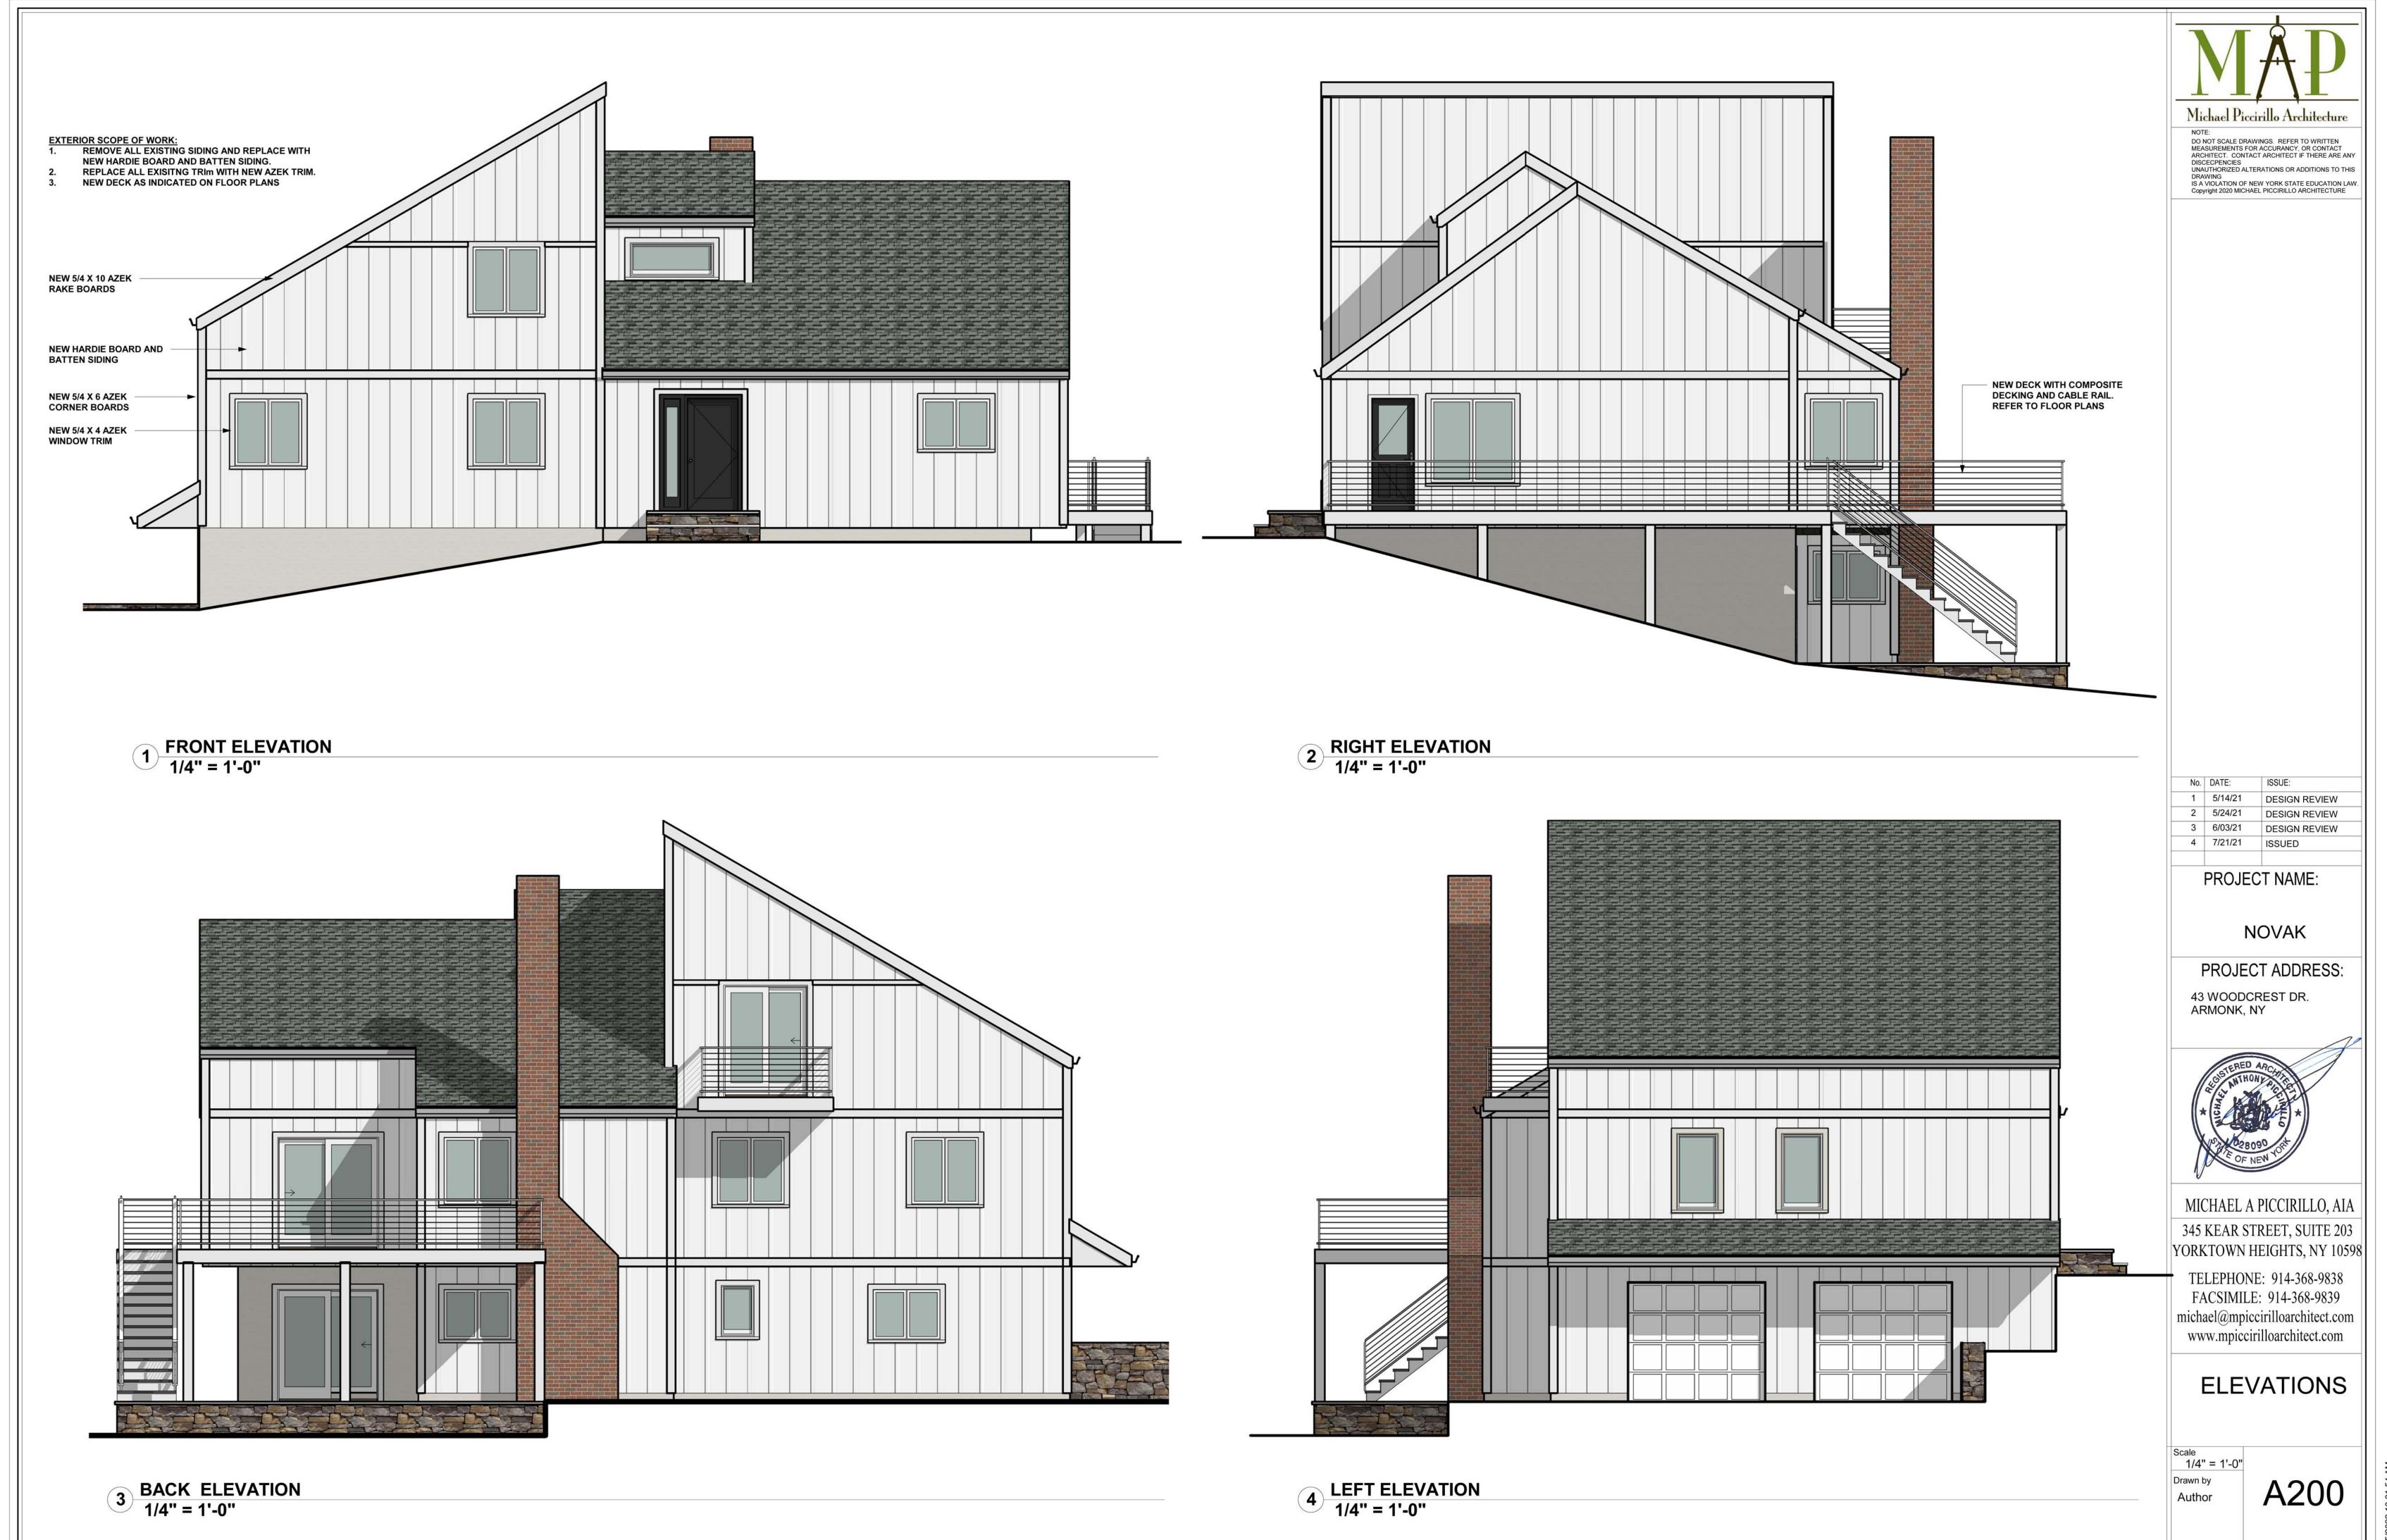

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3 BACK LEFT PERSPECTIVE





4 BACK RIGHT PERSPECTIVE



Michael Piccirillo Architecture

NOTE:
DO NOT SCALE DRAWINGS. REFER TO WRITTEN
MEASUREMENTS FOR ACCURANCY, OR CONTACT
ARCHITECT. CONTACT ARCHITECT IF THERE ARE ANY
DISCECPENCIES
UNAUTHORIZED ALTERATIONS OR ADDITIONS TO THIS
DRAWING
IS A VIOLATION OF NEW YORK STATE EDUCATION LAW.
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No. DATE: 1 5/14/21 DESIGN REVIEW 2 5/24/21 DESIGN REVIEW
3 6/03/21 DESIGN REVIEW
4 7/21/21 ISSUED

PROJECT NAME:

NOVAK

PROJECT ADDRESS: 43 WOODCREST DR. ARMONK, NY



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PERSPECTIVES

Drawn by
Author

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