### **Tax Parcel Maps**

Address: 10 WINDMILL PL


**Print Key:** 102.01-1-24 **SBL:** 10200100010240000000



Disclaimer:

This tax parcel map is provided as a public service to Westchester County residents for general information and planning purposes only, and should not be relied upon as a sole informational source. The County of Westchester hereby disclaims any liability from the use of this GIS mapping system by any person or entity. Tax parcel boundaries represent approximate property line location and should NOT be interpreted as or used in lieu of a survey or property boundary description. Property descriptions must be obtained from surveys or deeds. For more information please contact the assessor's office of the municipality.



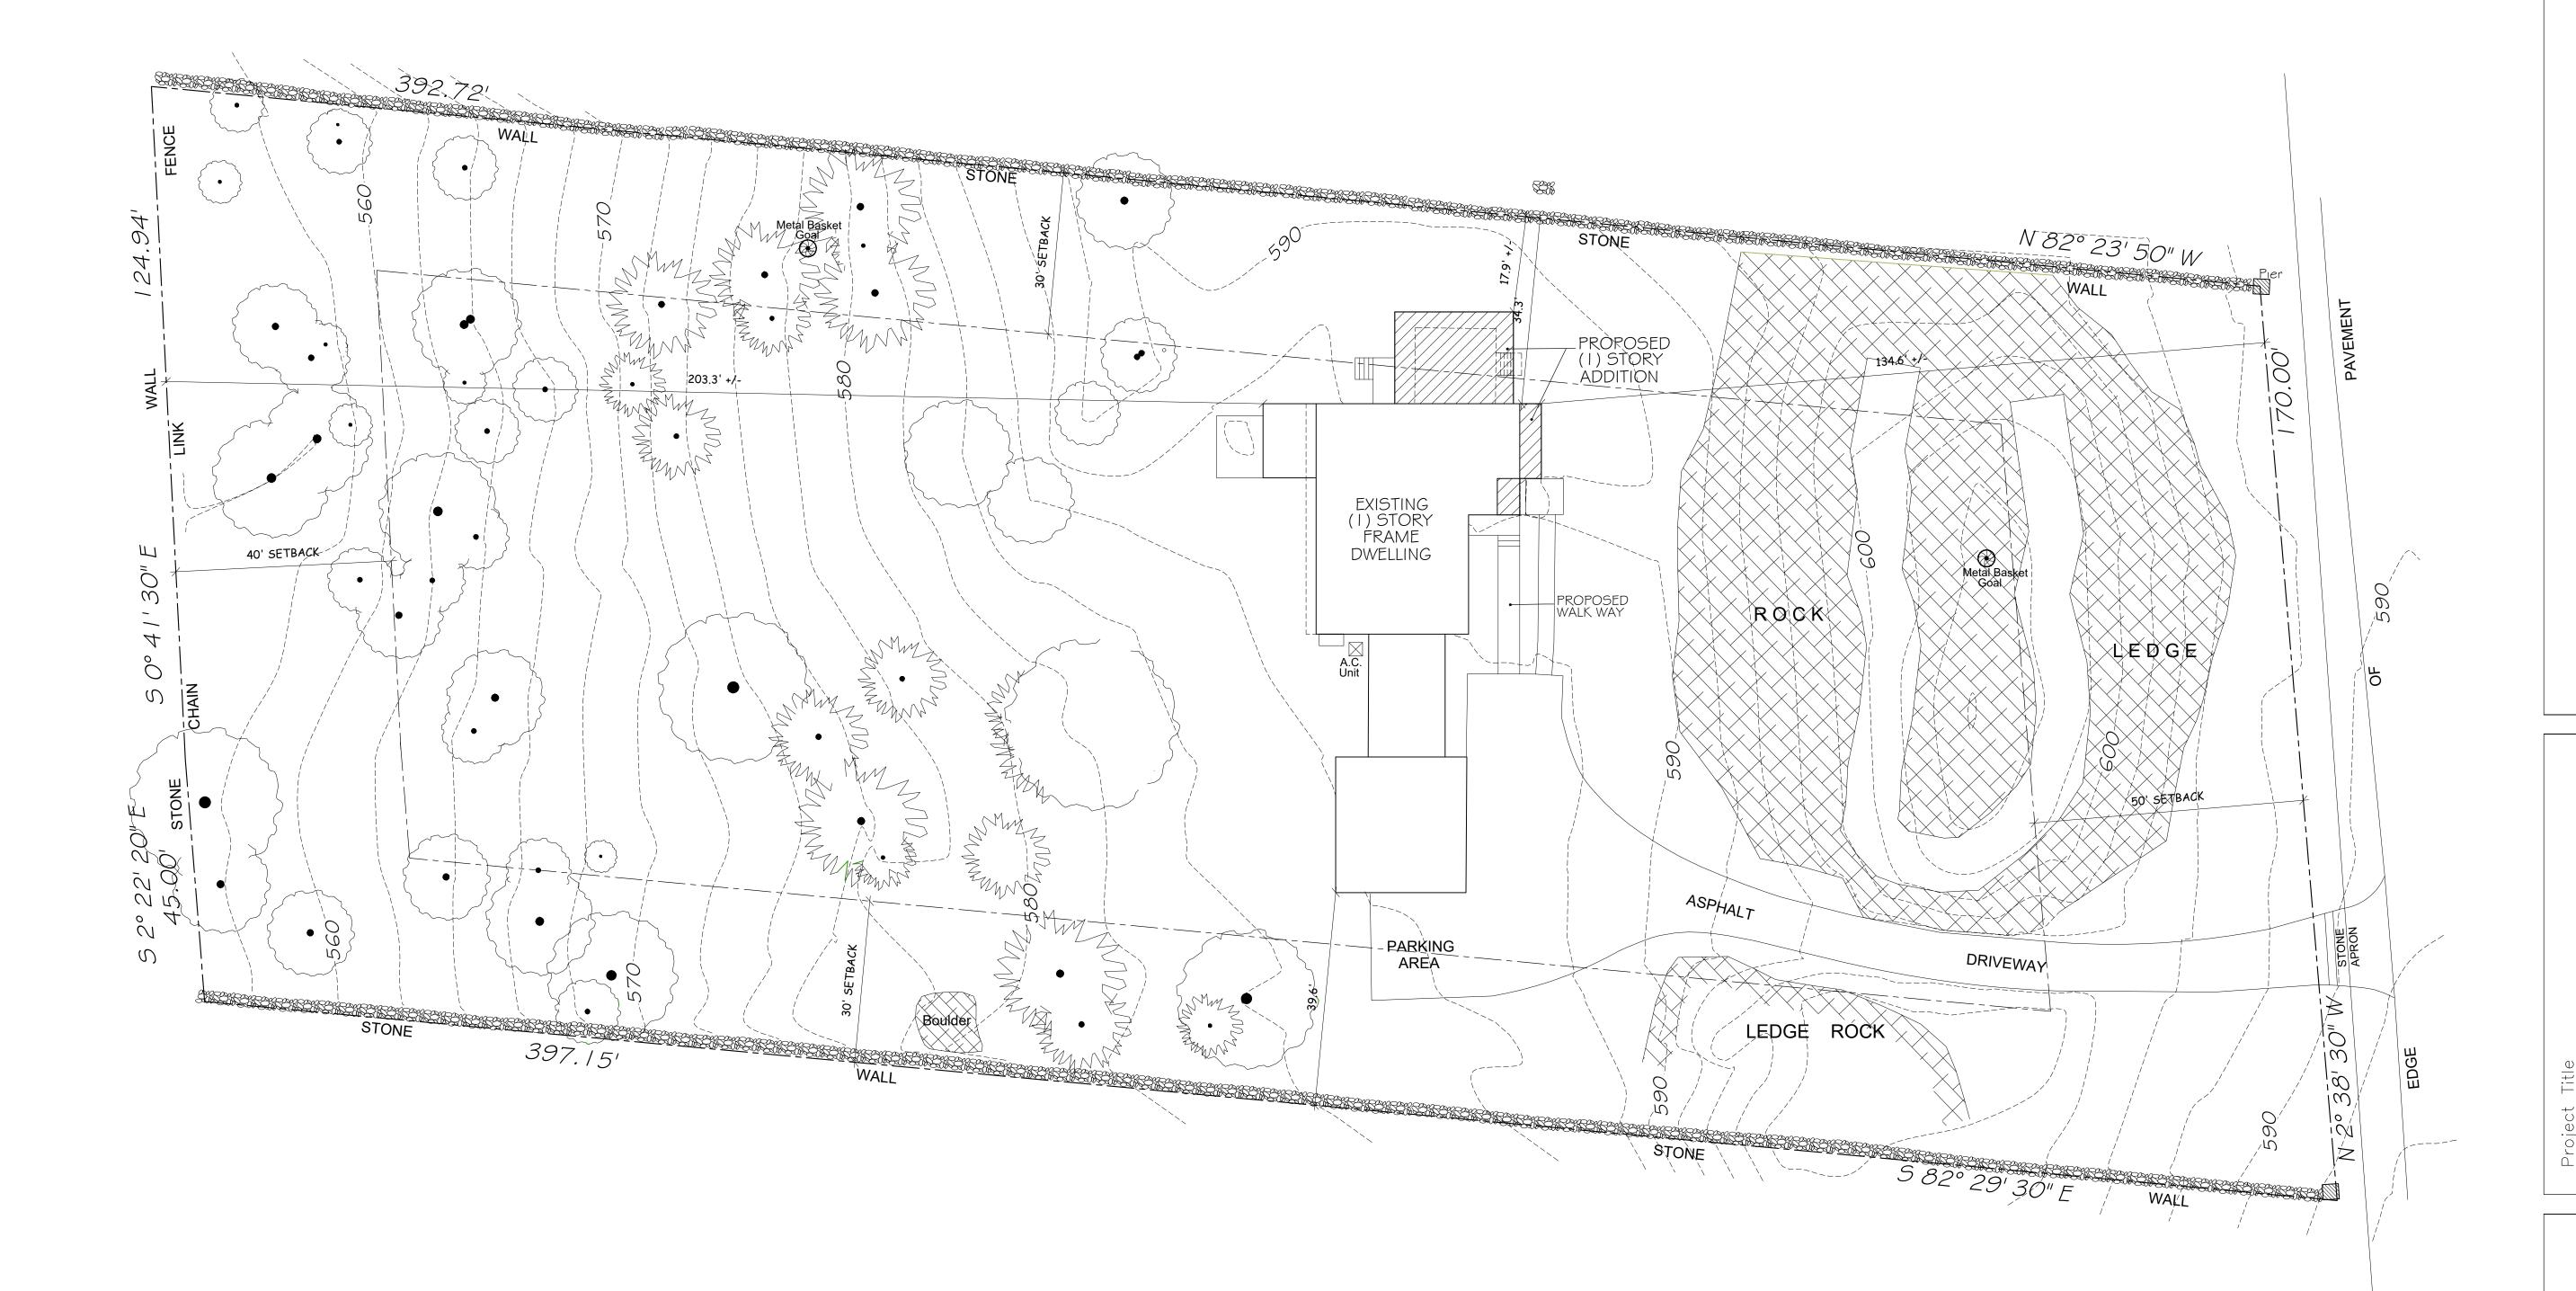

	LE OF LAND US RESIDENCE DI	_	
DESCRIPTION	REQUIRED/ PERMITTED	EXISTING	PROPOSED/ PROVIDED
MINIMUM LOT AREA (S.F./ NET ACRES)	65,340/ 1.5	66,289/ 1.52	66,289/ 1.52
MINIMUM LOT STREET FRONTAGE (FEET)	150	170	170
MINIMUM LOT WIDTH (FEET)	150	170	170
MINIMUM LOT DEPTH (FEET)	150	397	397
PRINCIPAL BUILDING MINIMUM YARD (FEET	<u></u>		
FRONT	50'	138.6' +/-	134.6' +/-
• • • • •			
SIDE	30'/30'	34.3'/ 39.6' +/-	17.9'/ 39.6' +/-
·	30'/30' 40'	34.3'/ 39.6' +/- 203.3' +/-	17.9'/ 39.6' +/- 203.3' +/-
SIDE	·		

LOT COVERAG	E CALCULATIONS	5	
AREA	EXISTING	PROPOSED	INCREASE
LOT AREA	66,289 sq.ft.	66,289 sq.ft.	0 sq.ft.
MAIN HOUSE	2,424 sq.ft.	2,887 sq.ft.	463 sq.ft.
DRIVEWAYS	*3,107 sq.ft.	*3,107 sq.ft.	0 sq.ft.
FRONT PORCH	35 sq.ft.	45 sq.ft.	10 sq.ft.
REAR DECKS	0 sq.ft.	47 sq.ft.	47 sq.ft.
WALKWAY	89 sq.ft.	95 sq.ft.	6 sq.ft.
SCREEN PORCH	274 sq.ft.	0 sq.ft.	-274 sq.ft.
TOTAL	*2,822 sq.ft.	*3,074 sq.ft.	*252 sq.ft.

\* DRIVEWAY AREA NOT INCLUDED IN TOTAL FOR LOT COVERAGE PURPOSES

# SITEPLAN

1" = 16'-0"

SITE PLAN BASED ON SURVEY, AS PREPARED BY JRL SURVEYING P.C. DATED 06/01/2022


MAP- BLOCK- LOT = 79.05 - 1 - 48 LOT AREA = 66,289 sq.ft. / 1.5218 AC. ZONE = R-1.5A

SETBACK: FRONT = 50' REAR = 40' SIDE = 30'

# RCHITECTS ENNON


ADDITION TO LEVY RESIDENCE

PROPOSED SITE PLAN

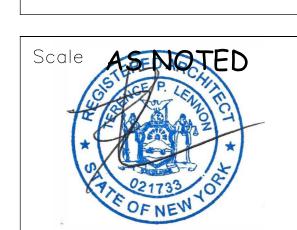

07/20/22 Drawing By **A.O.** 

Drawing No.

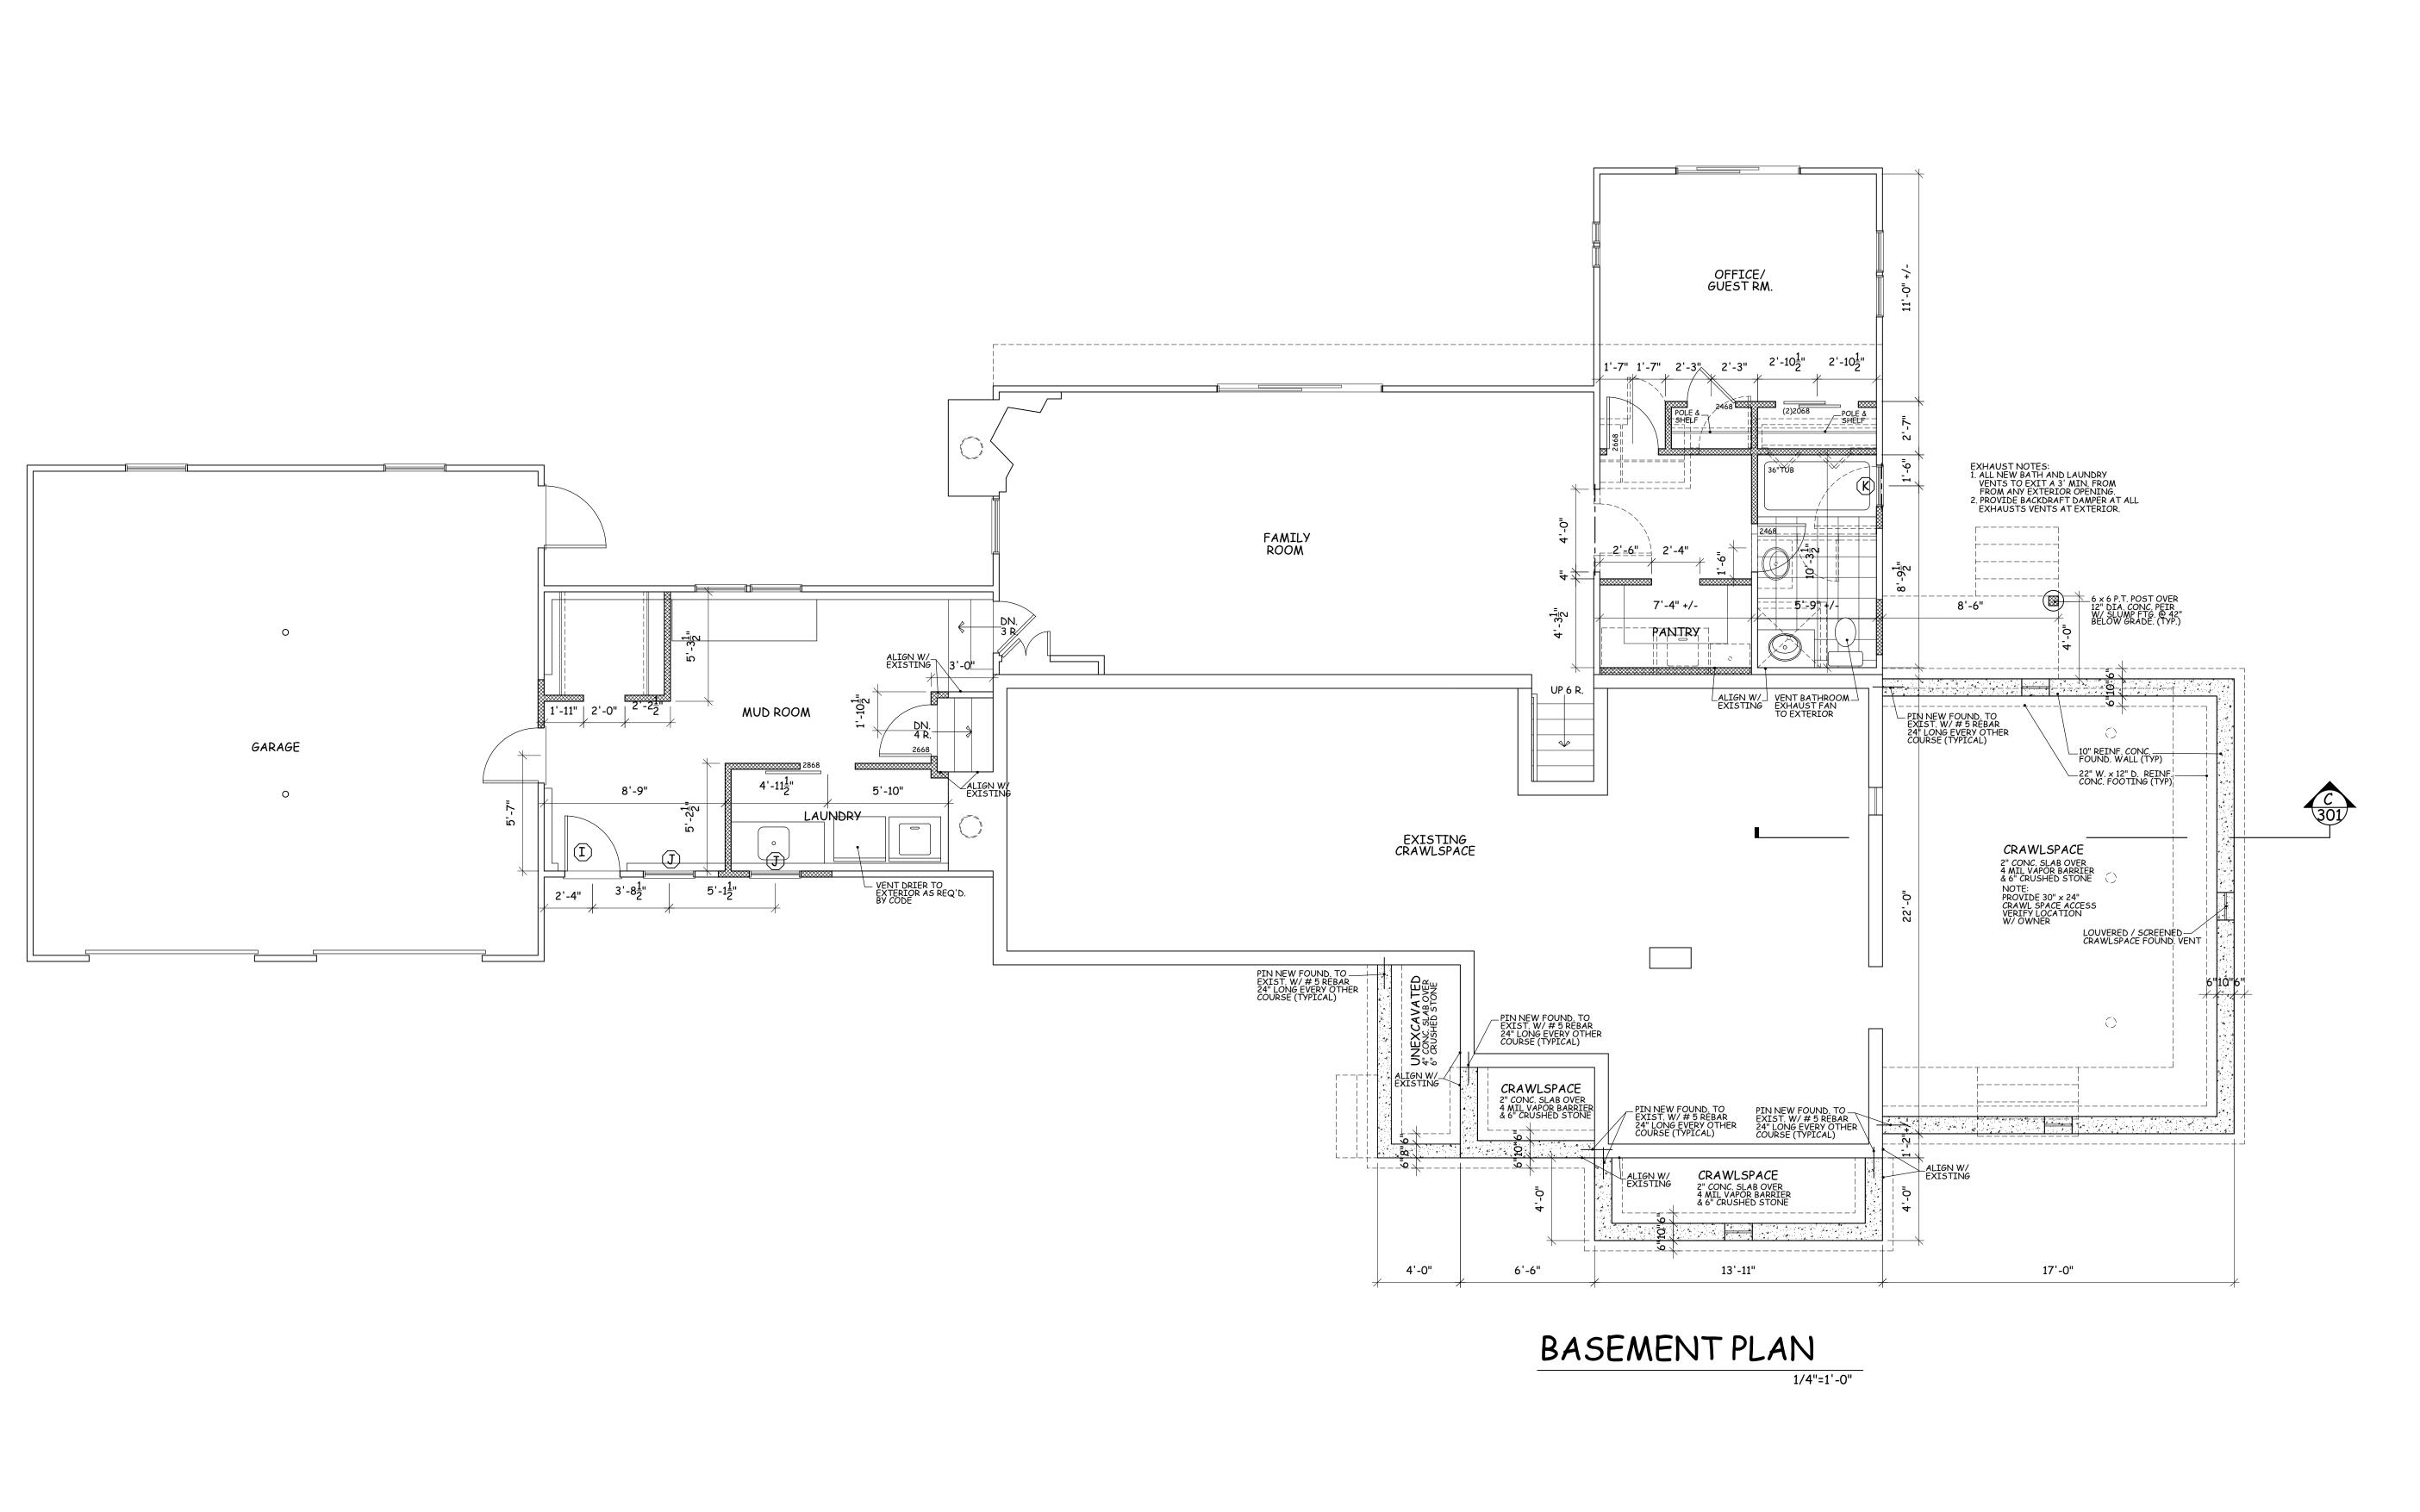

ARCHITECT

OFFICES AT

2A Hardscrabble Rd.

North Salem, New York 10560

ADDITION TO
LEVY RESIDENCE
10 WINDMILL PLACE
ARMONK, NY 10504

PROPOSED BASEMENT

Scale 1/4" = 1'-0'

Date 04/29/22 Drawing By A.O.

Drawing No.

EXIST. CONC. FOUNDATION WALL TO REMAIN

NEW CONC. FOUNDATION WALL


NEW FRAME WALL

EXIST. FRAME WALL TO BE REMOVED

EXIST. FRAME WALL TO REMAIN


LEGEND


A-101

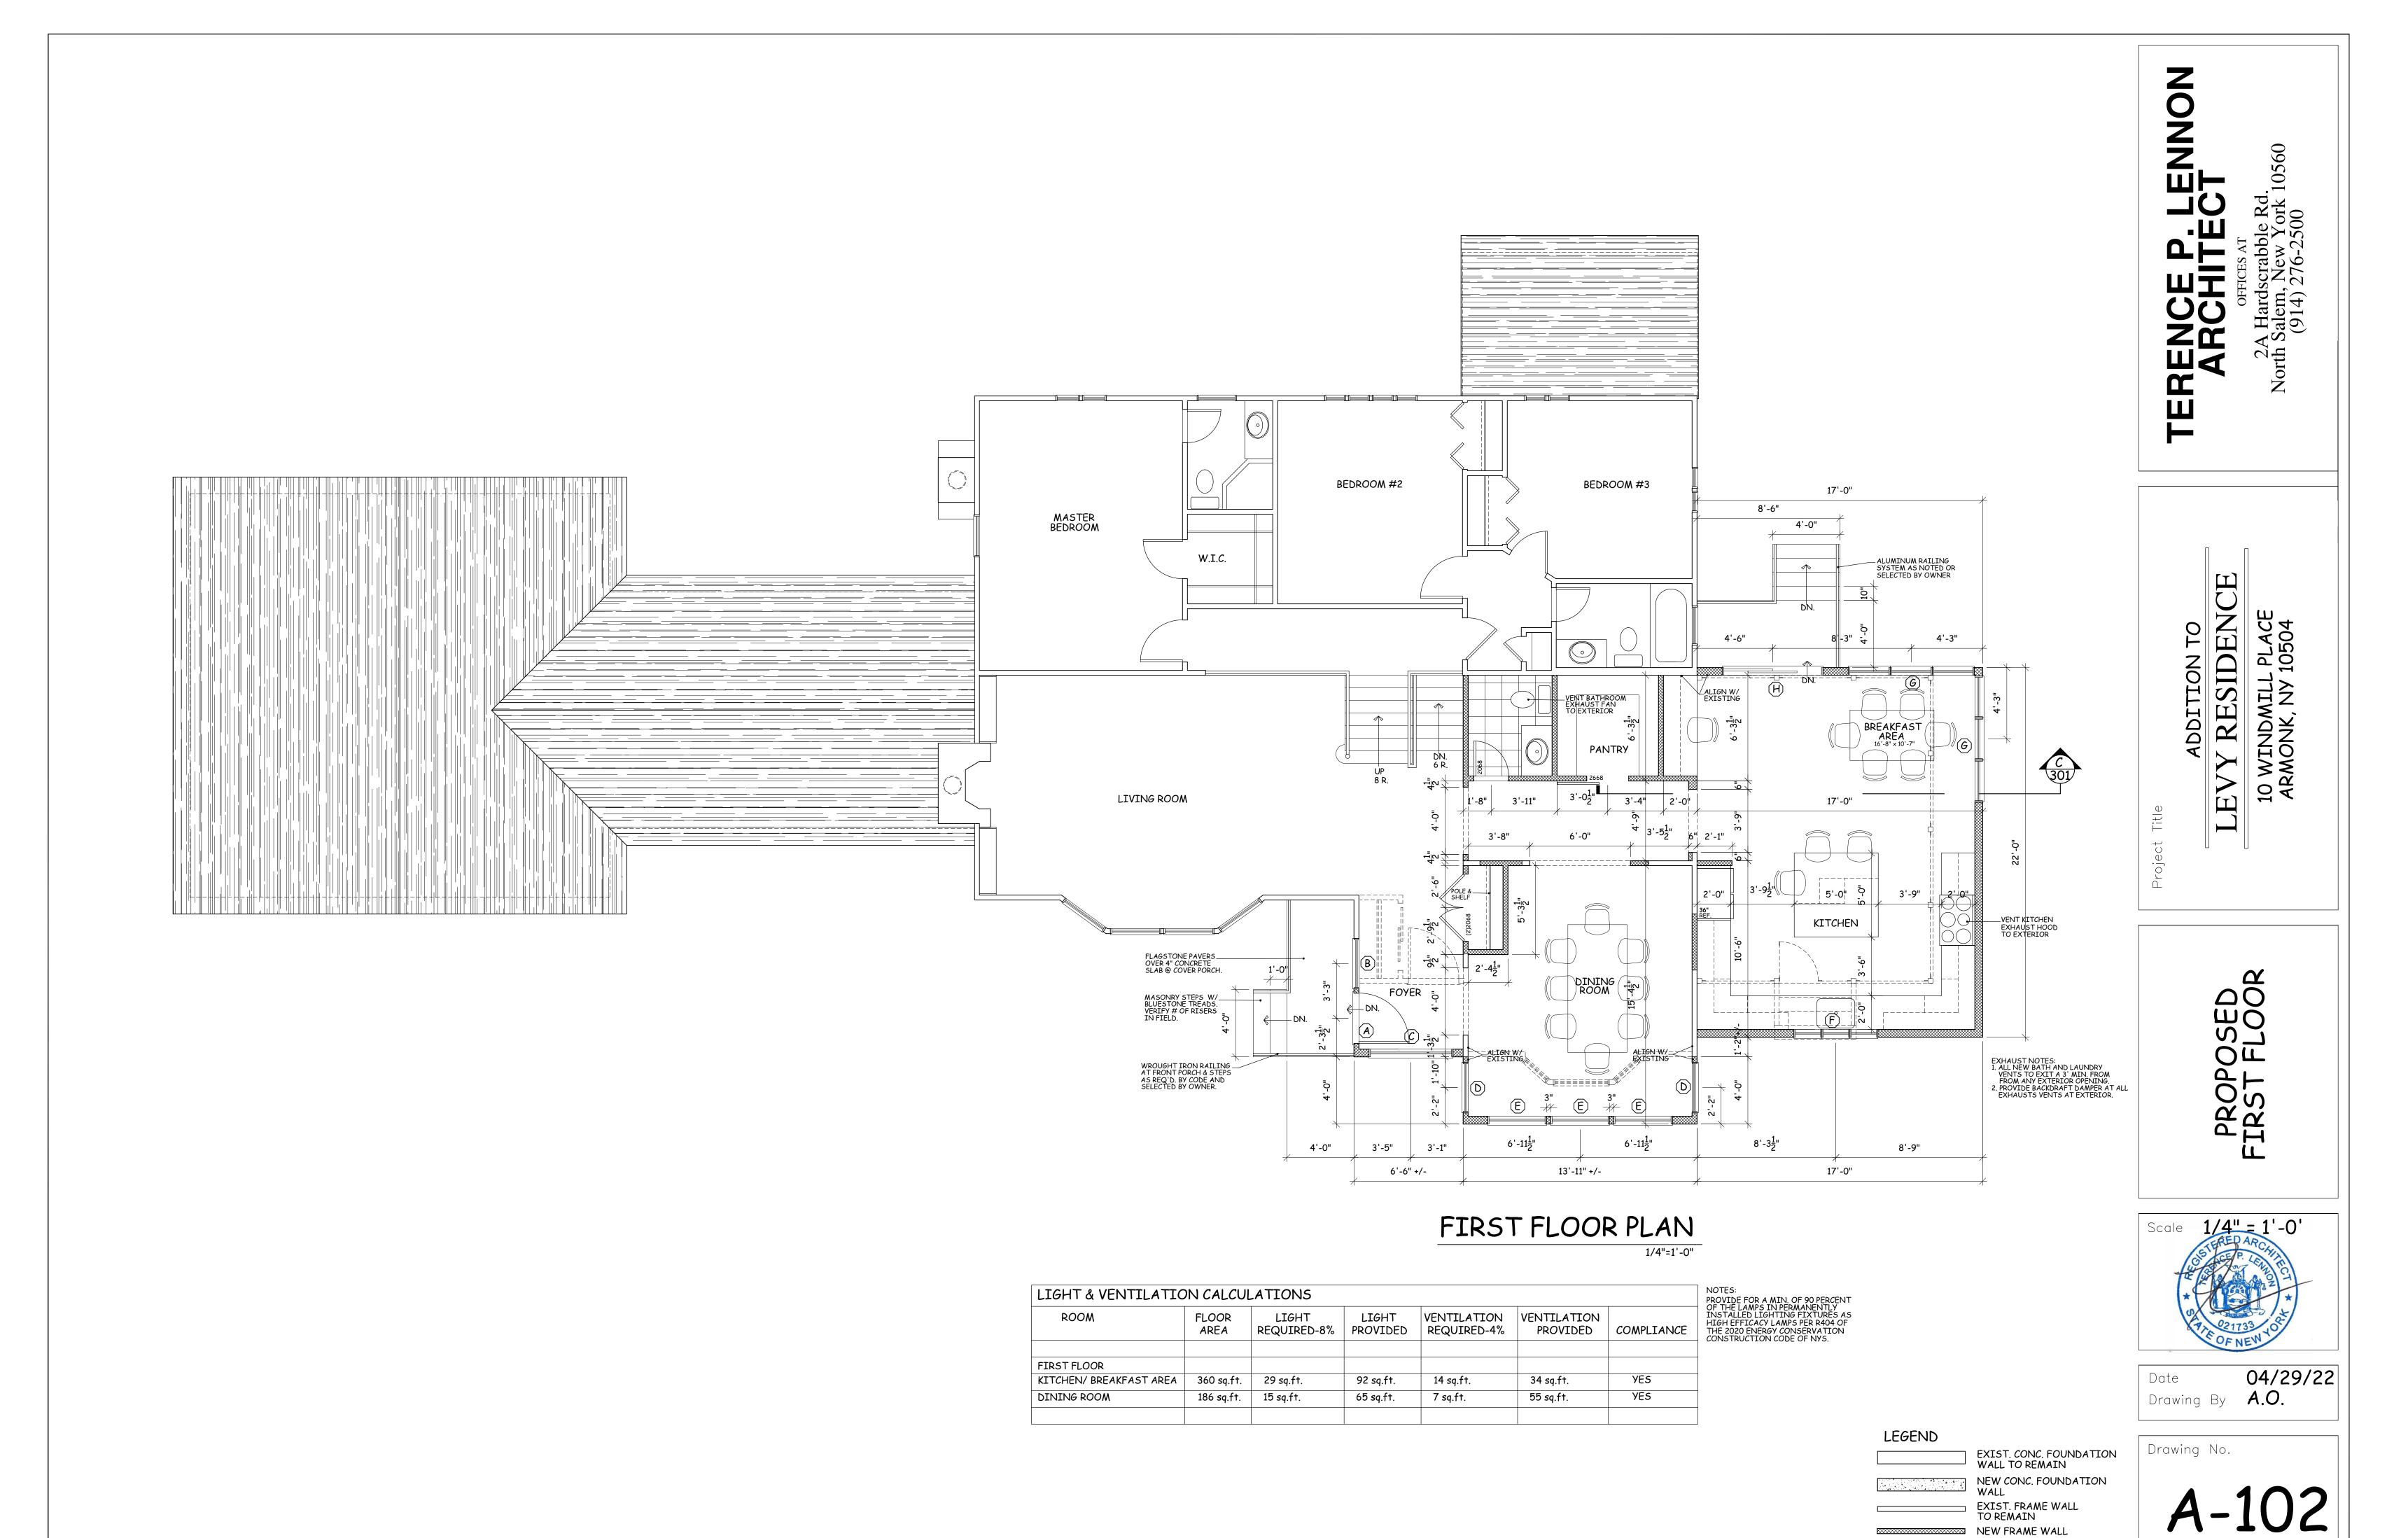


NEW FRAME WALL

EXIST. FRAME WALL TO BE REMOVED

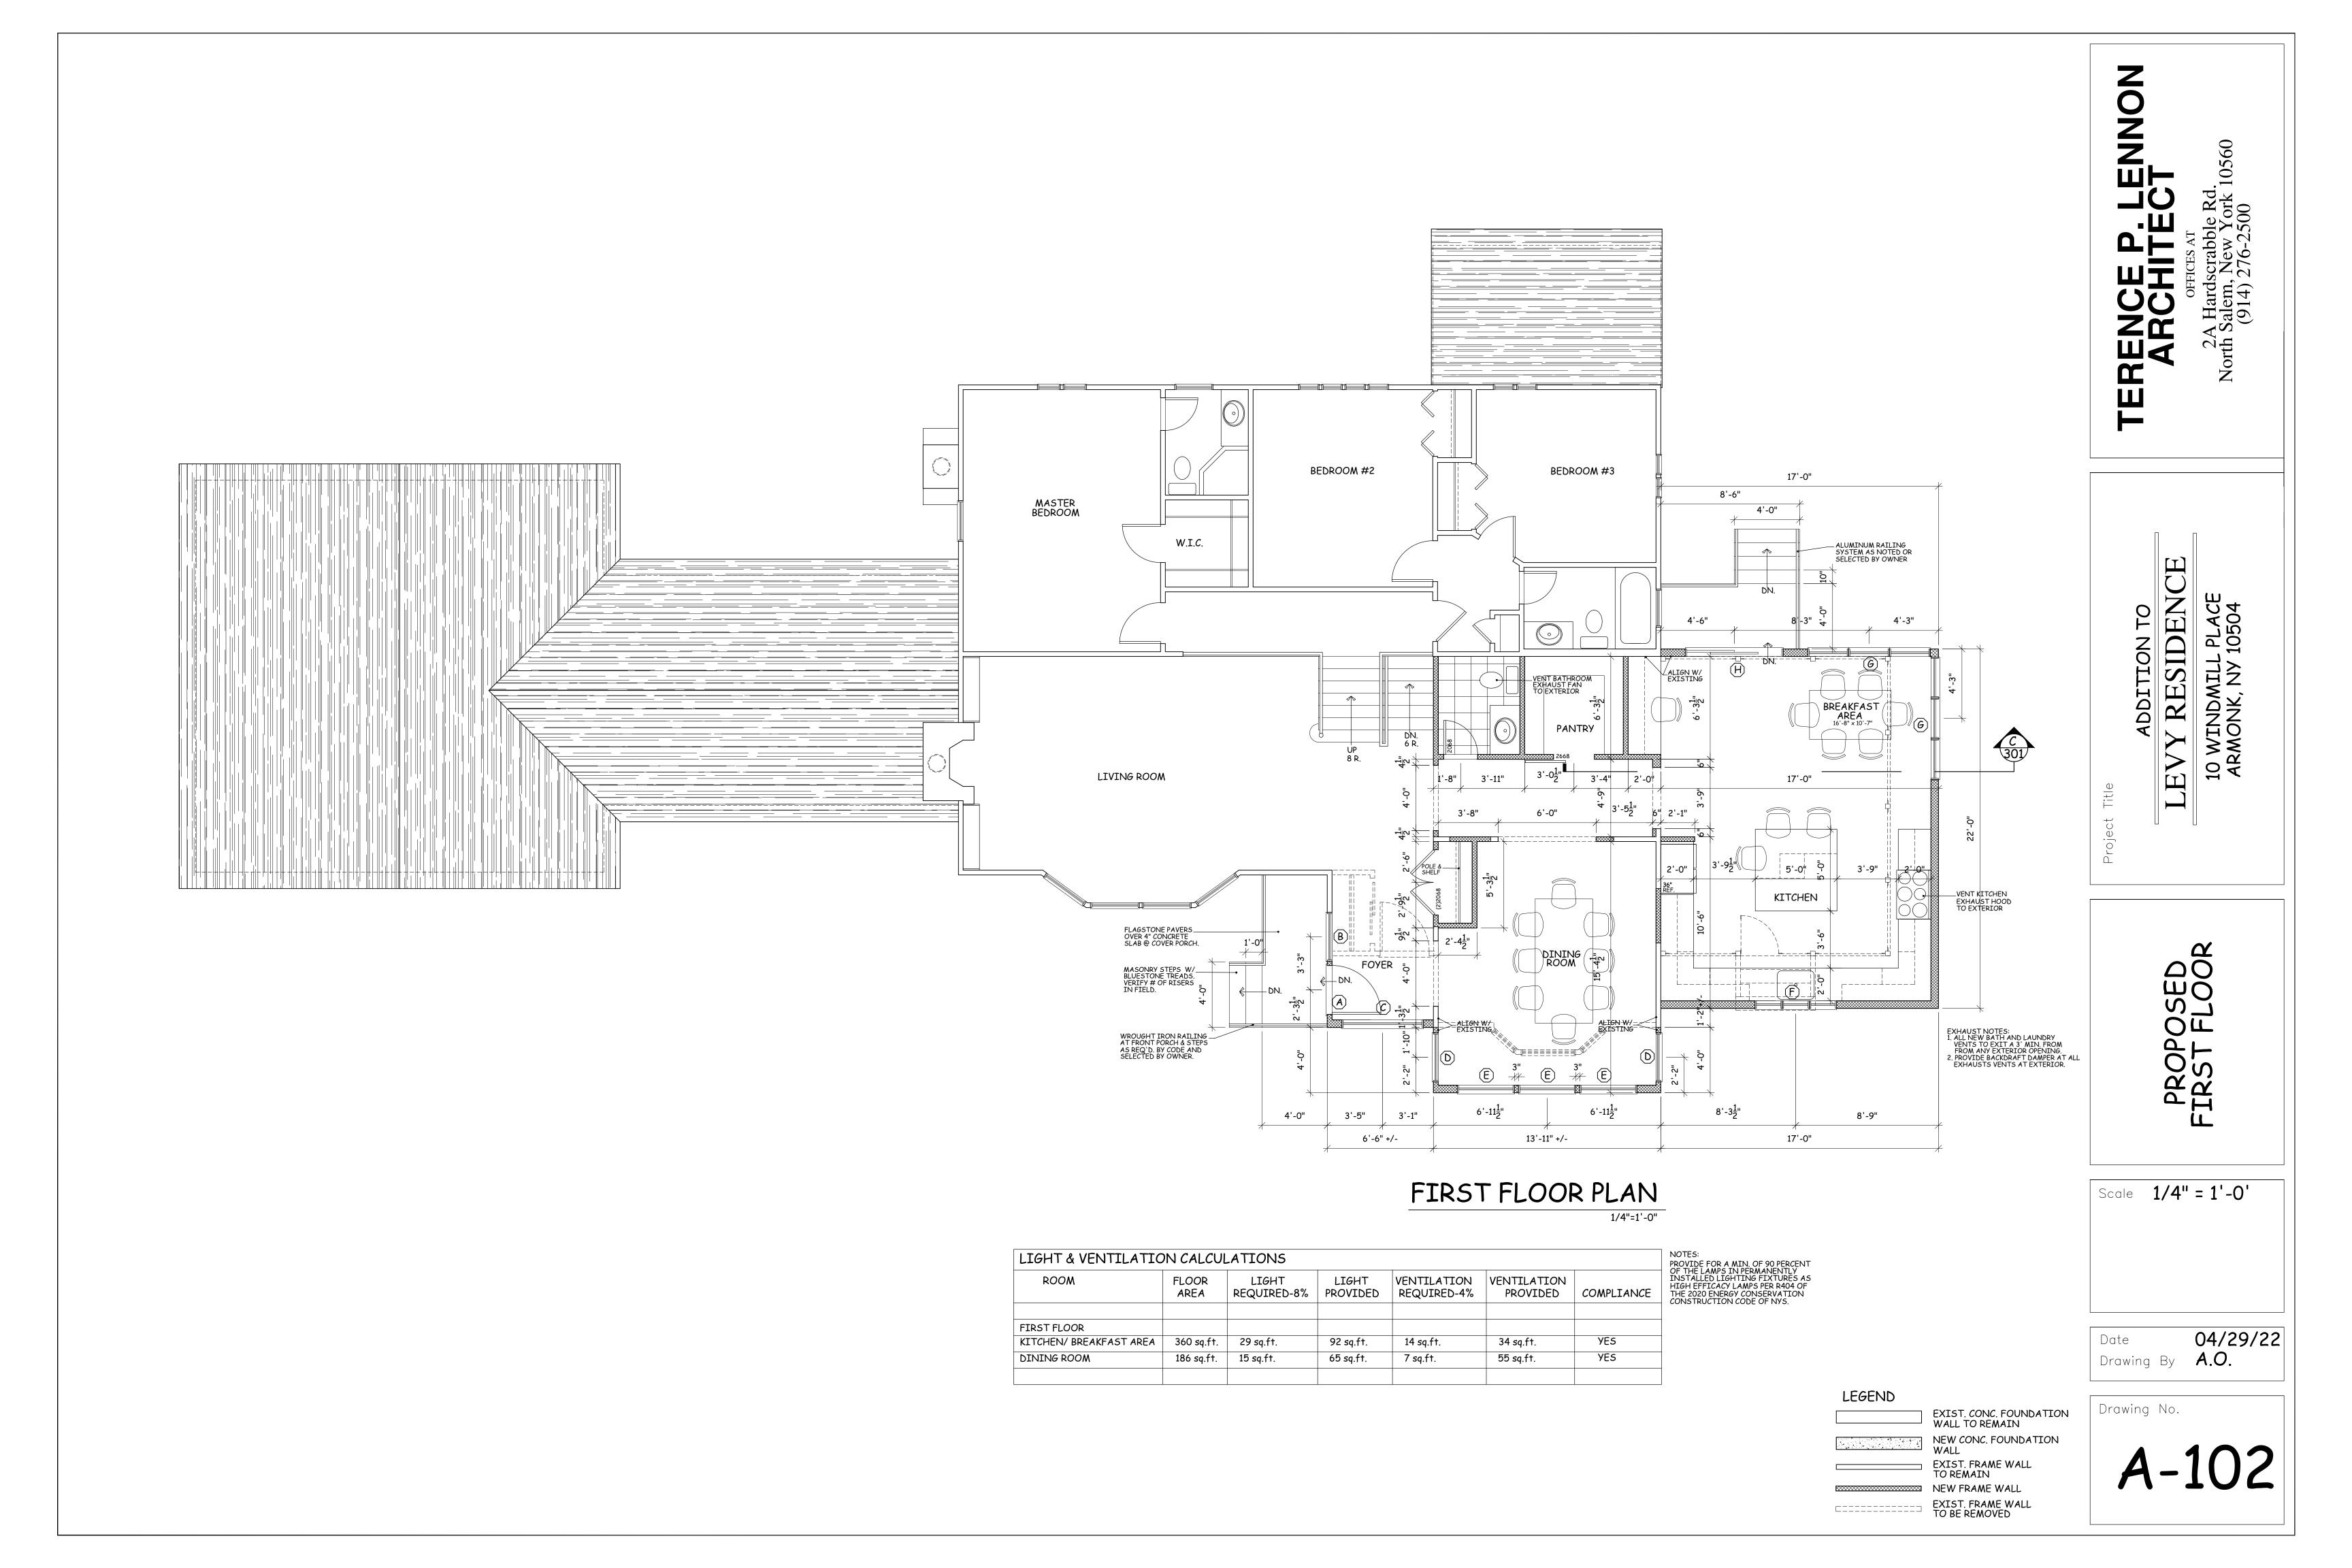

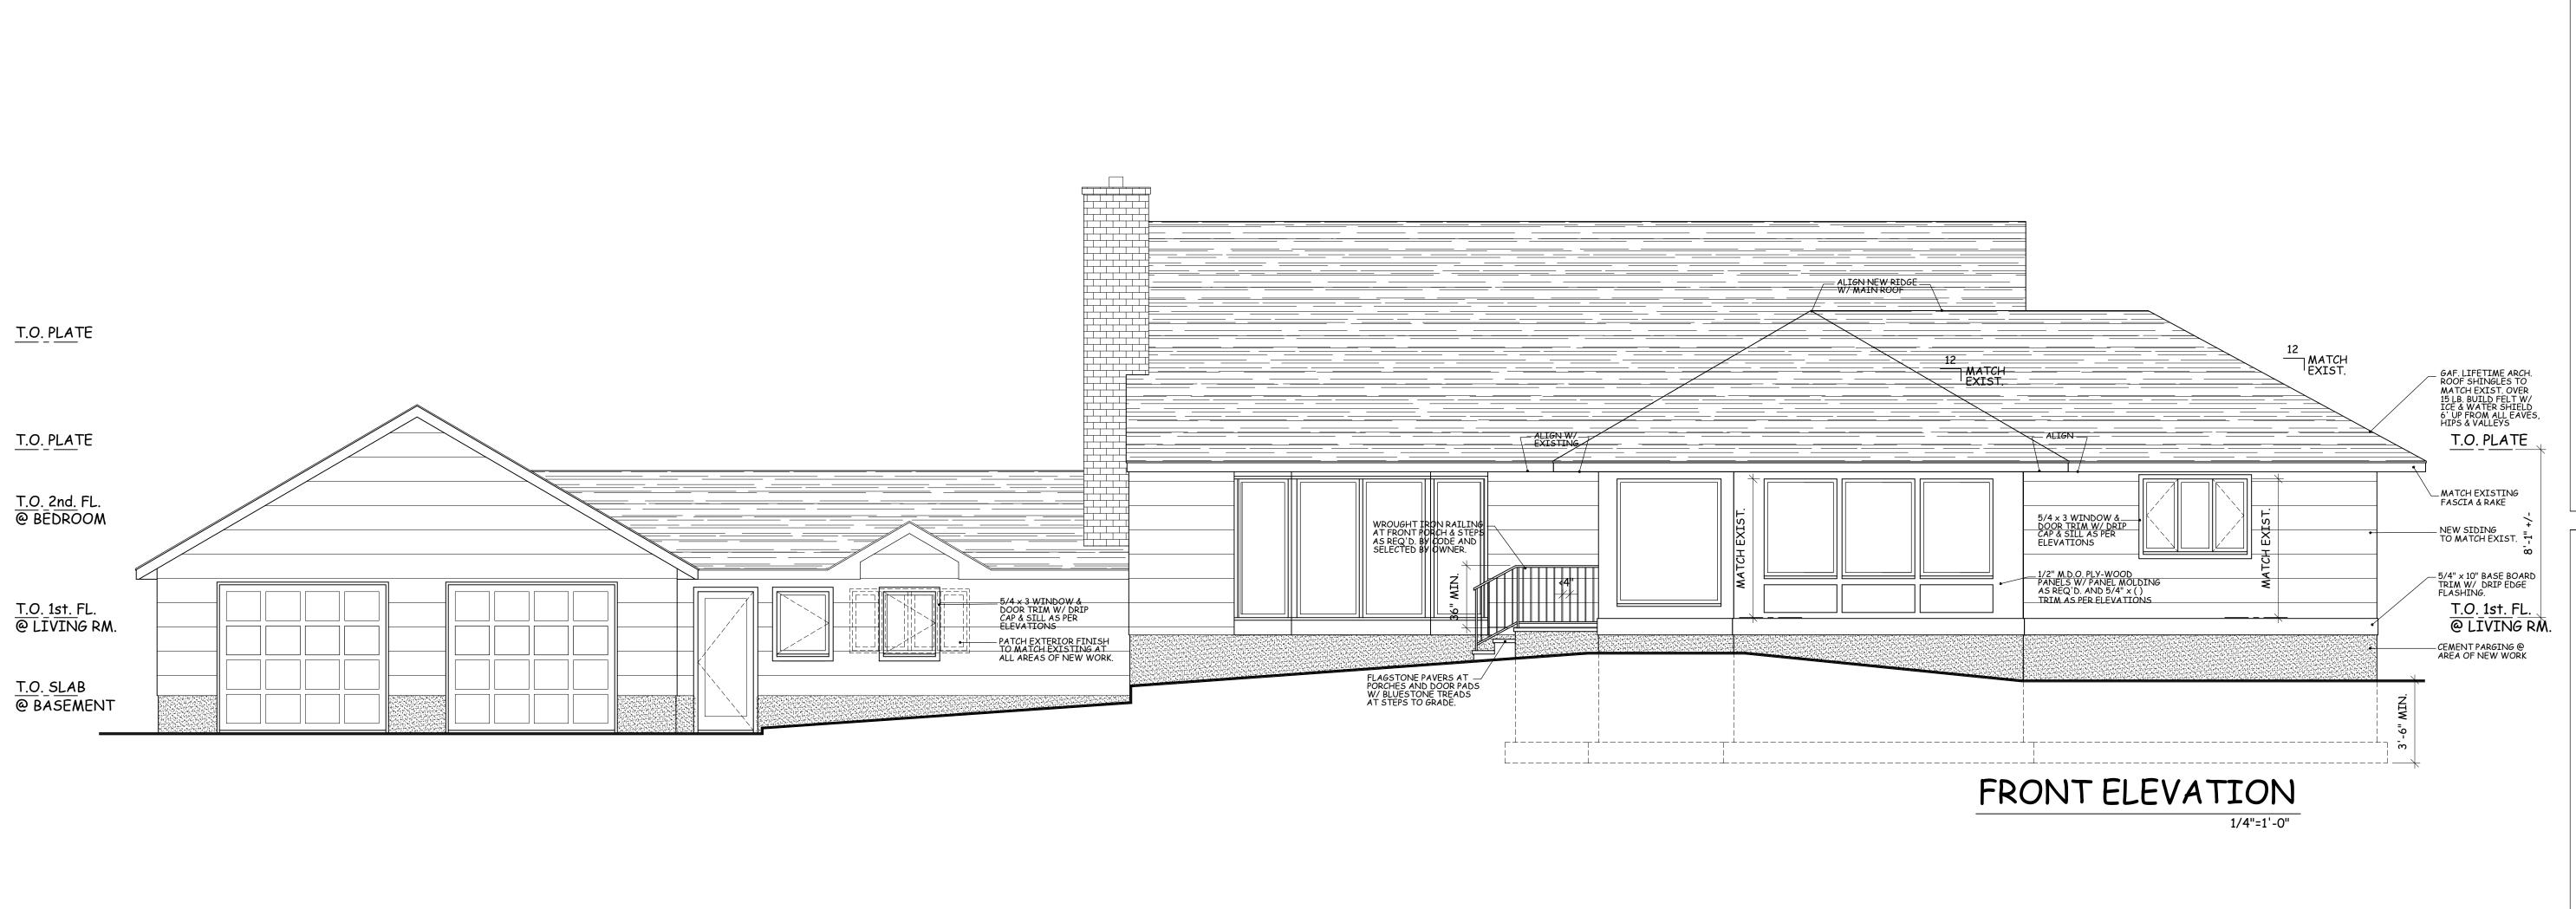

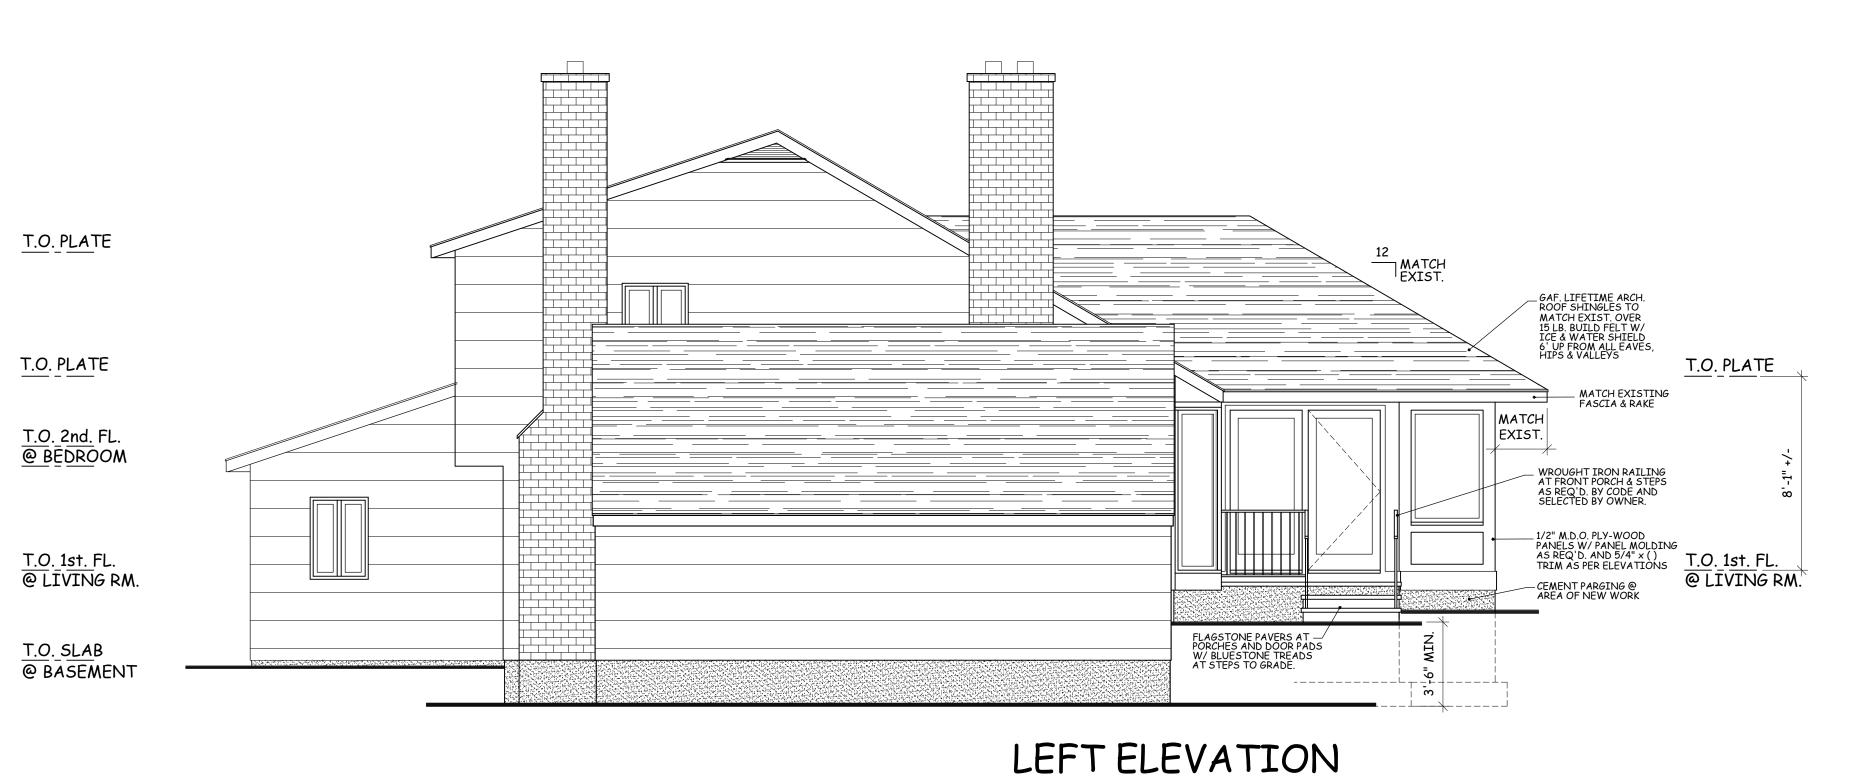

TERENCE P. LENNON
ARCHITECT
OFFICES AT
2A Hardscrabble Rd.
North Salem, New York 10560
(914) 276-2500


ADDITION TO

SVY RESIDENCE

10 WINDMILL PLACE

ARMONK, NY 10504


PROPOSED ELEVATIONS

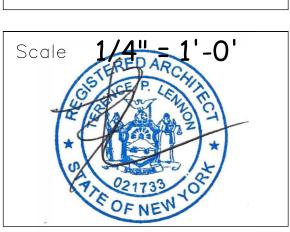



Date 04/29/22 **A.O.** 

Drawing No.

A-201

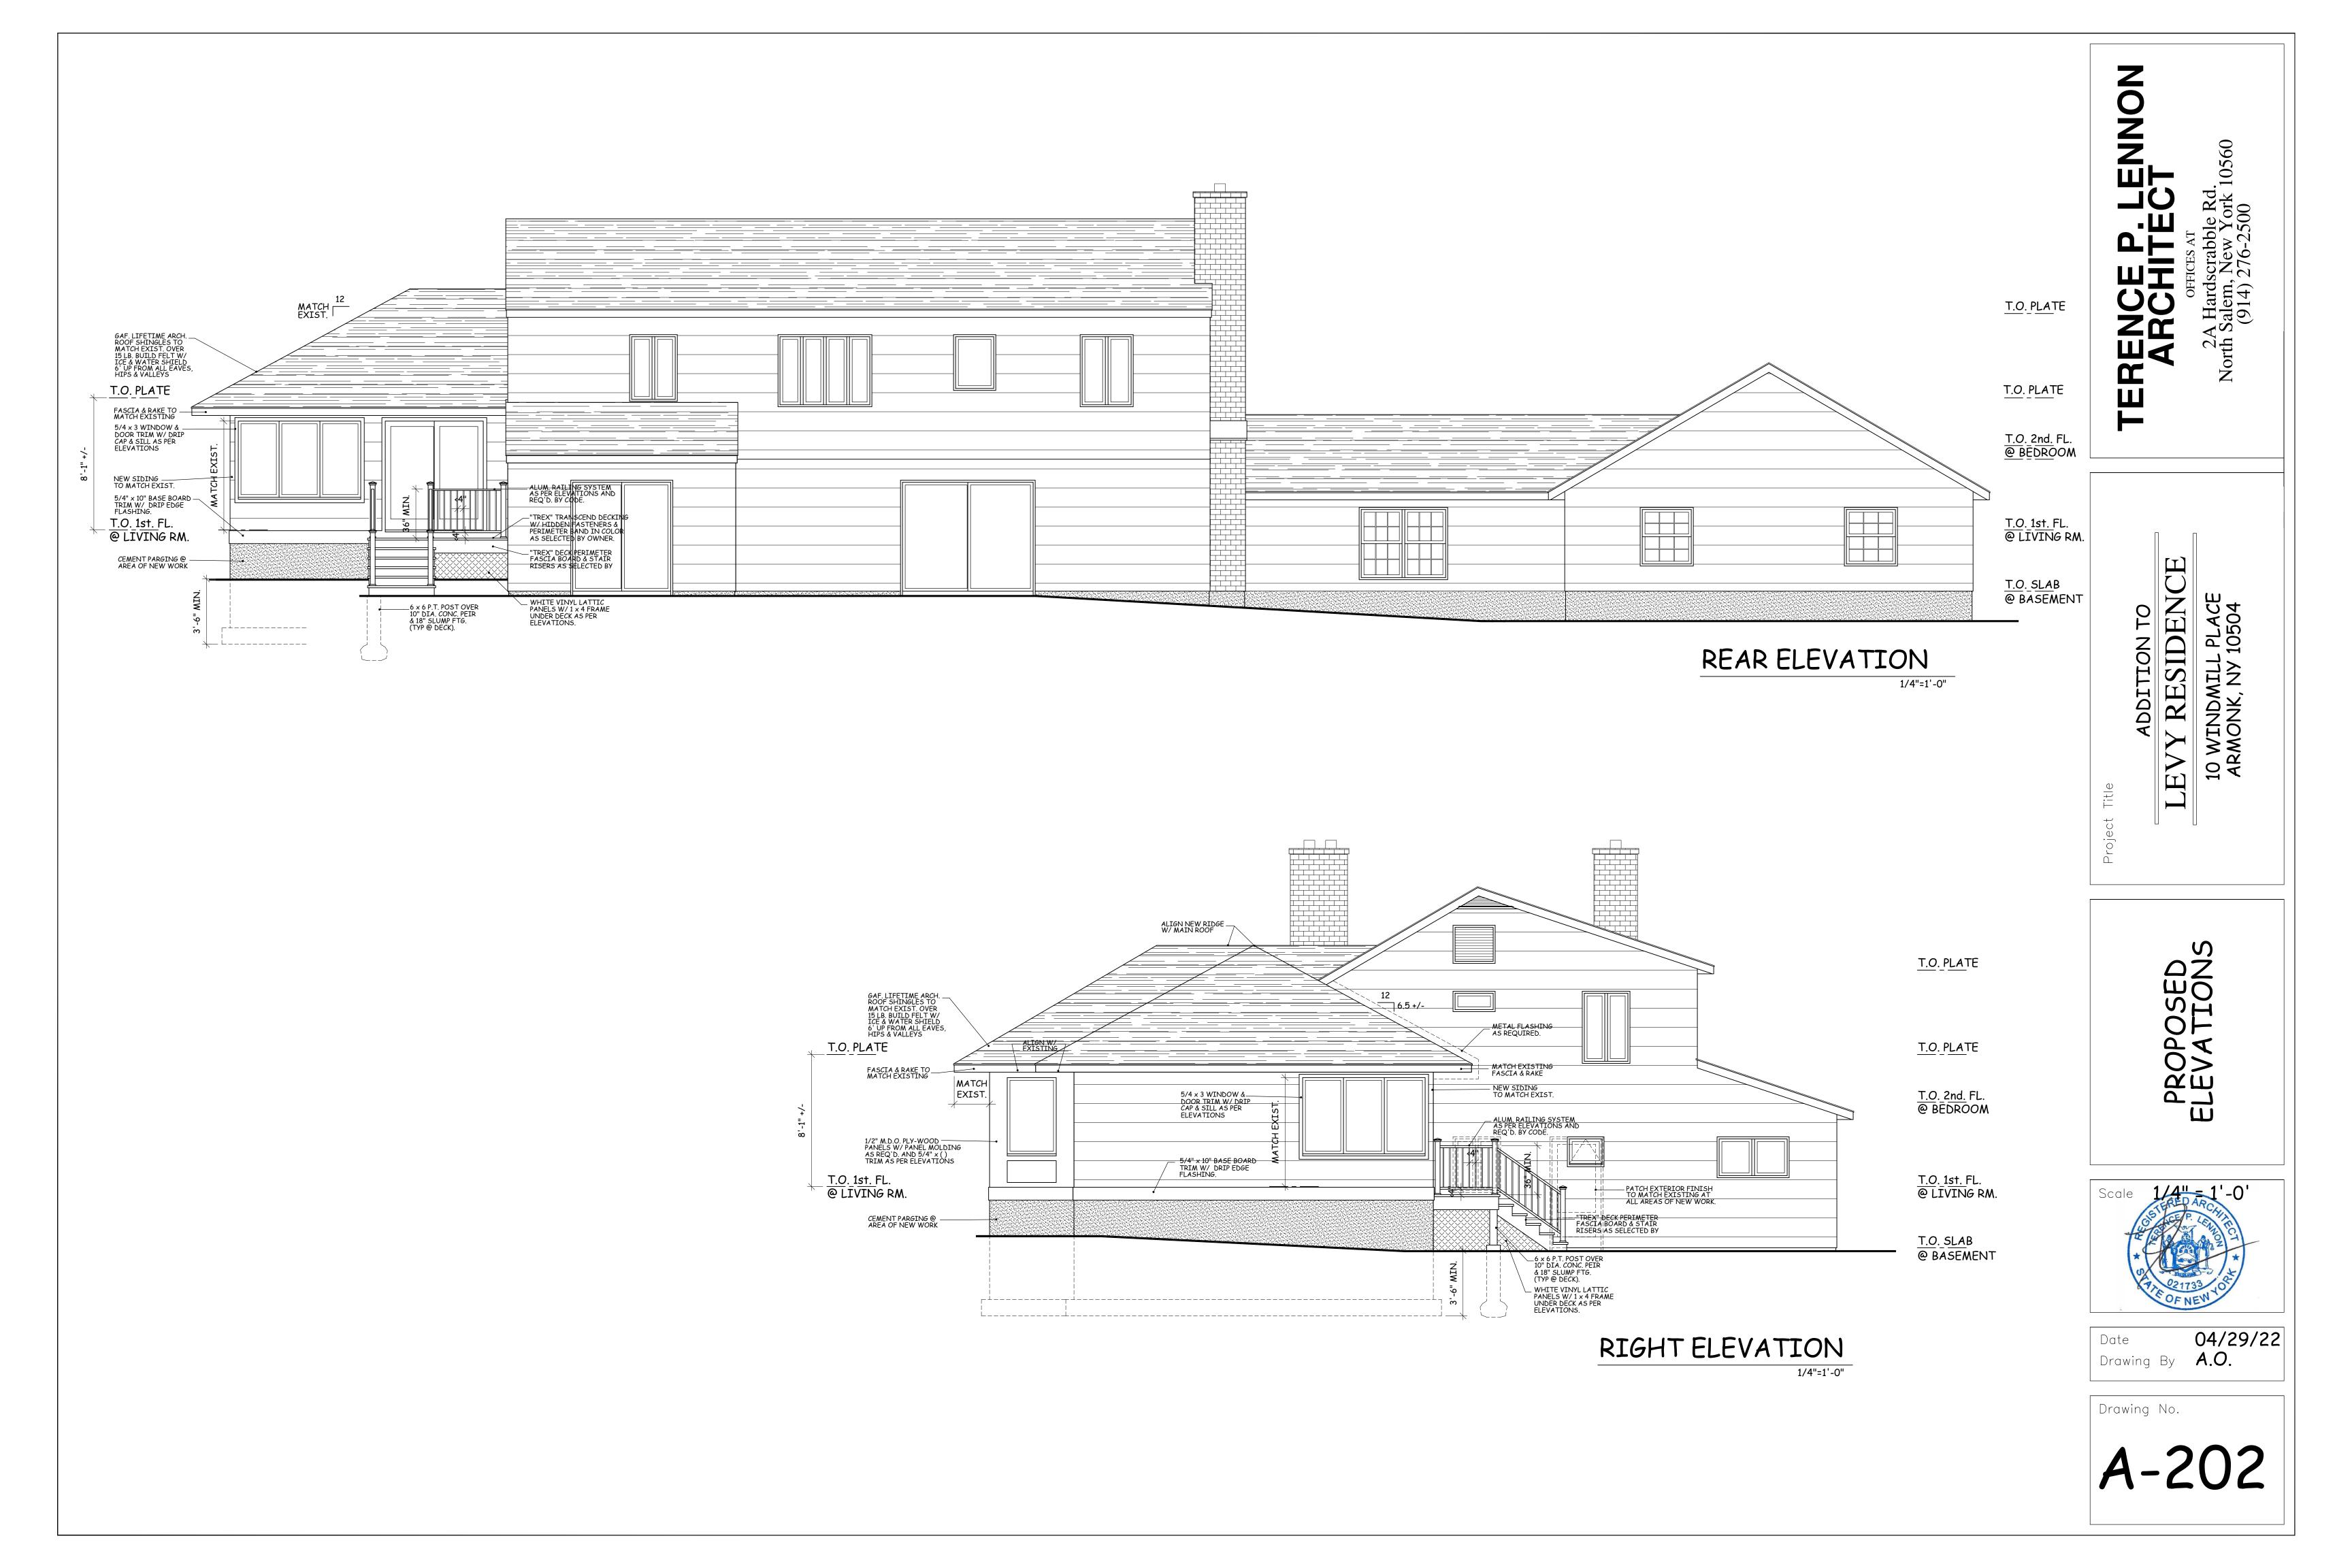

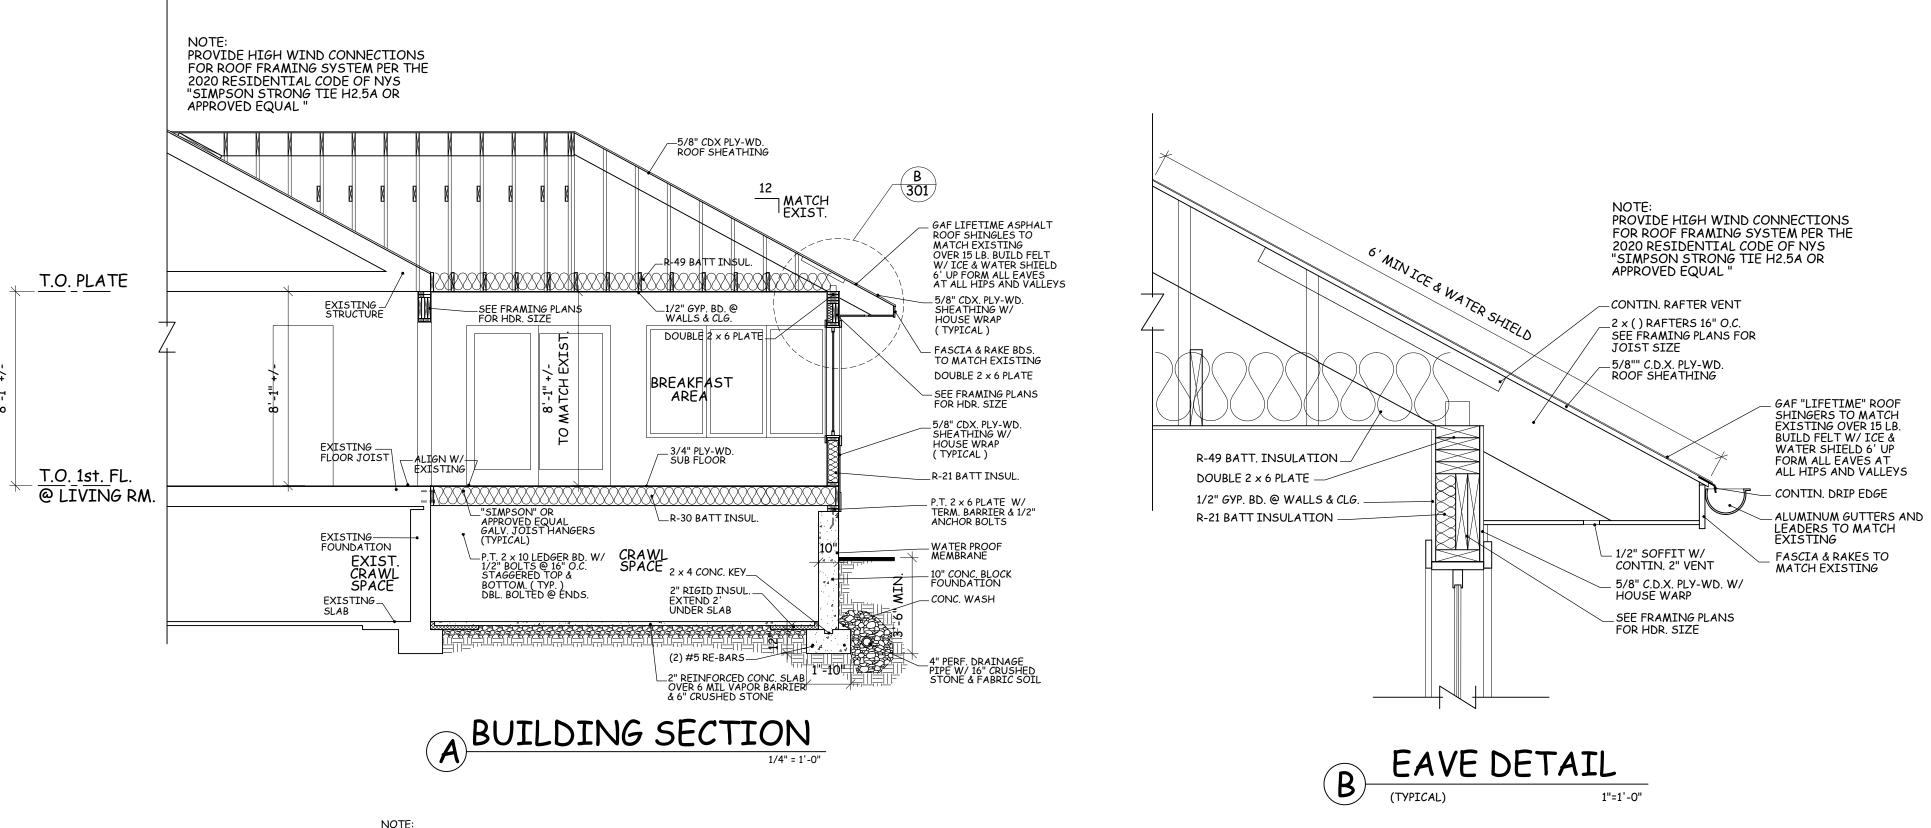

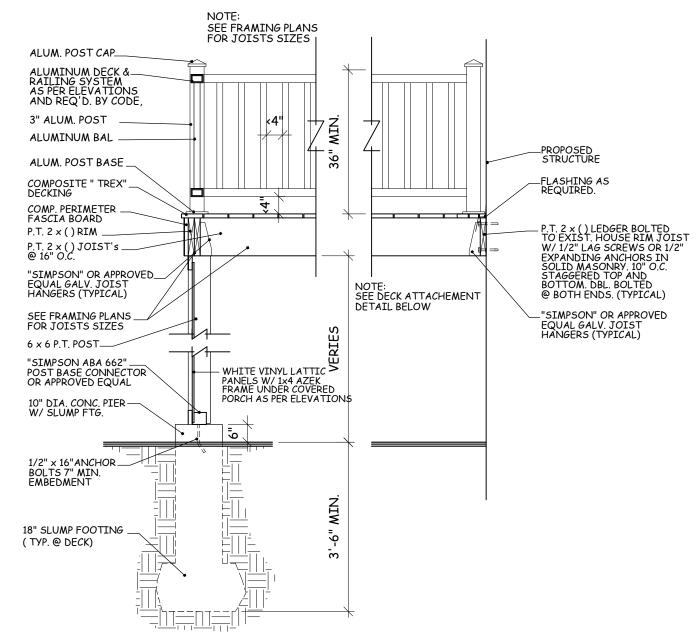

DECK	DETAI	iL
		1/2"=1'-0"

WIN.	QNTY.	MFR.	TYPE	MODEL	ROUGH OPENING	DIVIDED	LIGHTS	LOC	ATION	REMARKS
Α	1	T.B.D.	ENTRY DOOR	T.B.D.	3'-0" x 6'-10" UNIT SIZE	SEE ELEV	SEE ELEVATIONS SEE PLANS		PLANS	
В	1	ANDERSEN	STATIONARY	FWH316115	3'-1" × 6'-11"				1	
С	1	1	CASE.	T.B.D.	5'-0" x 6'-0" UNIT SIZE					
D	2		CASE.	CXW15	3'-0 1/2" × 5'-0 7/8"					
Е	3		CASE.	T.B.D.	3'-6" x 5'-0" UNIT SIZE					
F	1		CASE.	CN335	5'-1 1/2" × 3'-5 3/8"					
G	2		CASE.	CW35	7'-1 1/8" × 5'-0 3/8"					
Н	1	<b>\</b>	PATIO DOOR	FWG60611L	6'-0" × 6'-11"					
I	1	T.B.D.	DOOR	T.B.D.	2'-8" x 6'-10" UNIT SIZE					
J	2	ANDERSEN	CASE.	CX13	2'-8" × 3'-0 1/2"					
K	1	ANDERSEN	AWNG.	AN21	2'-0 5/8" x 1'-9"					
						_			$\downarrow$	

WINDOW & EXTERIOR DOOR NOTES:

- 1. ALL NEW WINDOWS & EXTERIOR FRENCH DOORS TO BE AS MFR'D. BY " ANDERSEN " (WOOD UNITS)
  SUPPLY AND INSTALL SCREENS (WHITE) ON ALL NEW
  OPERABLE UNITS. 7/8" SIM. DIVIDED LITES AS PER ELEVATIONS
- 2. ANY NEW WINDOW OR DOOR EXTENDING LESS THAN 18" ABOVE FINISHED FLOOR MUST BE TEMPERED.
- 3. ALL NEW WINDOWS TO BE SUPPLIED W/ HARDWARE AS REQUIRED. VERIFY TYPE & FINISH W/ OWNER PRIOR TO ORDERING.
- 4. ALL NEW EXTERIOR FRENCH DOORS TO BE SUPPLIED
- W/ OIL RUBBED BRONZE HARDWARE OR AS SELECTED BY OWNER.
- SOME UNITS ON WINDOW SCHEDULE MAY NOT APPEAR ON FLOOR PLANS, SEE ELEVATIONS FOR
- 6. ALL EXTERIOR GLASS DOORS SHALL BE TEMPERED GLASS.
- VERIFY WEATHER ADDITIONAL UNITS SHOULD BE TEMPERED.
- SEE ELEVATIONS FOR SWING ACTION OF ALL OPERABLE UNITS.
- 8. VERIFY ALL WINDOW AND EXTERIOR DOOR OPTIONS W/ OWNER PRIOR TO ORDERING. (COLOR, GRILLS, SCREENS,
- AND HARDWARE TYPE & COLOR) 9. CONTRACTOR RESPONSIBLE FOR VERIFYING ROUGH OPENINGS OF ALL EXISTING WINDOWS TO BE REPLACED PRIOR TO ORDERING. NOTIFY ARCHITECT IF ASSUMED HEADERS ARE NOT PRESENT, UNDERSIZED OR DAMAGED.


TERENCE P. LENNON ARCHITECT

RESIDENCE PLACE 10504 ADDITION



04/29/22 Date Drawing By **A.O.** 

Drawing No.

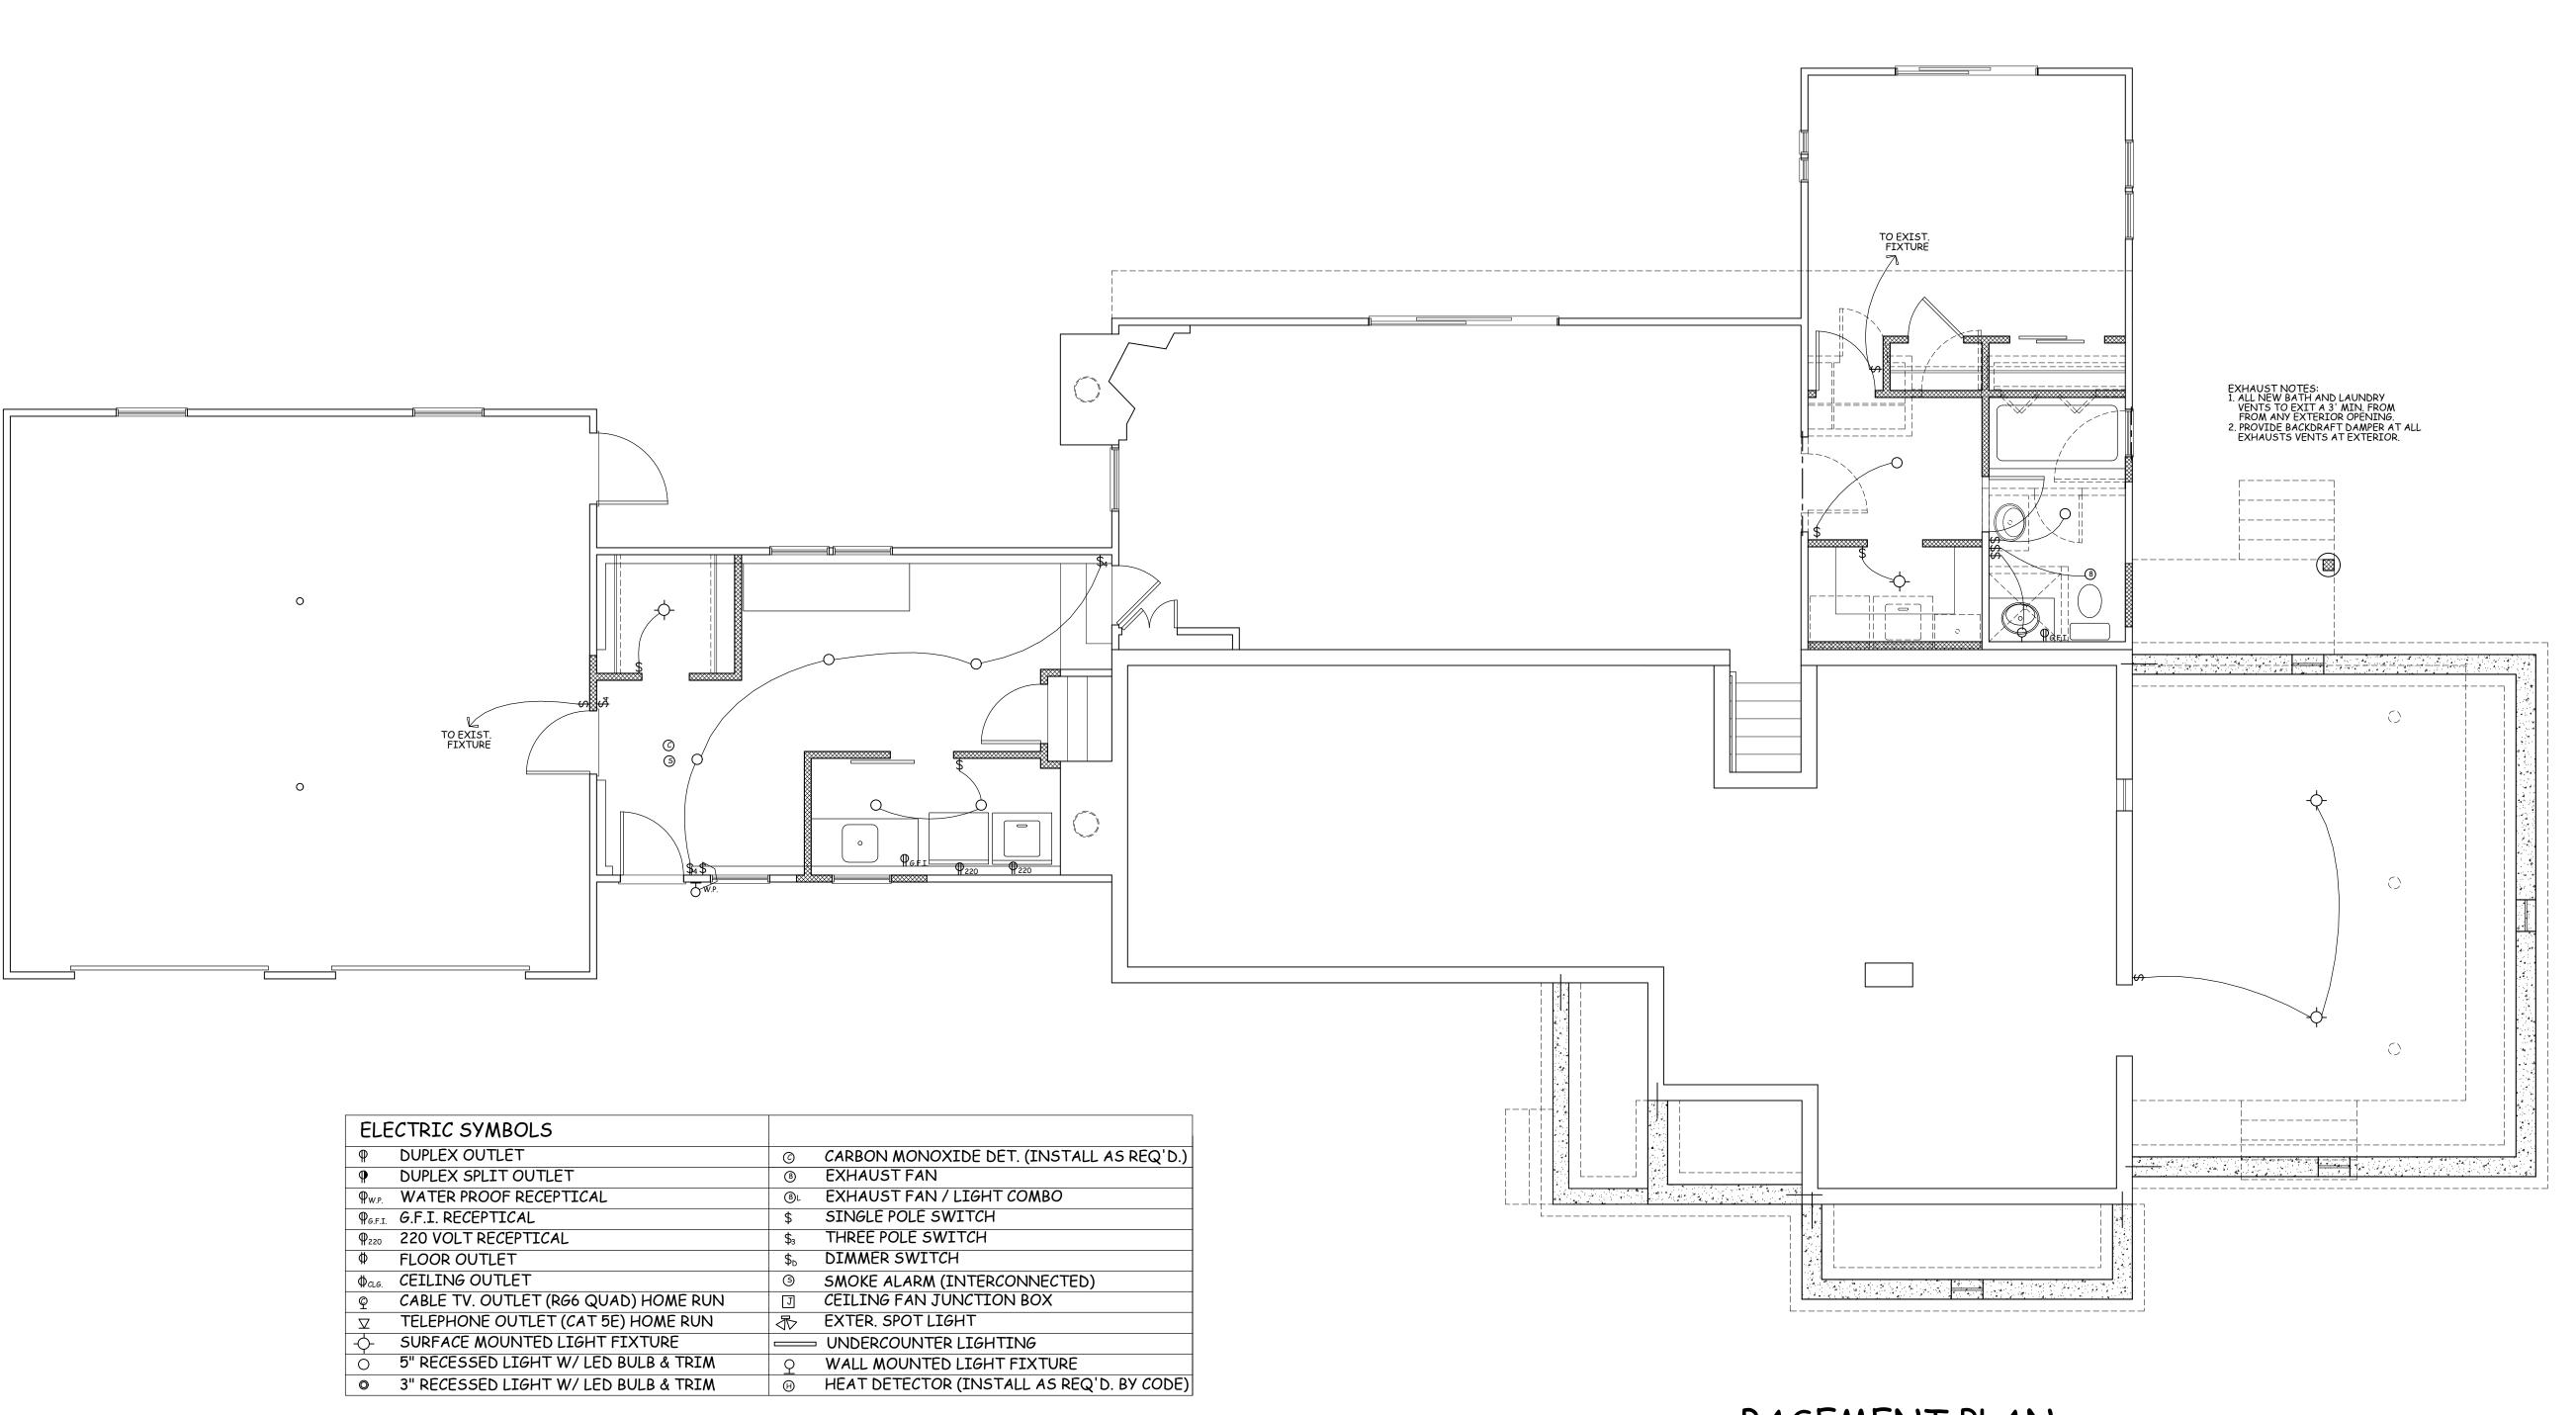

ELECTRICAL NOTES:

1. WALL OUTLETS AT AREA'S OF NEW WORK BY ELECTRICIAN AS REQ'D. BY CODE. UNLESS OTHERWISE NOTED ON DRAWING.

2. INSTALL HARDWIRED, INTERCONNECTED SMOKE DETECTORS W/BATTERY BACKUP TO ALL AREA'S OF RESIDENCE AS REQ'D. BY CURRENT VERSION OF APPLICABLE CODE.

3. PROVIDE HARDWIRED, CARBON MONOXIDE DETECTORS W/ BATTERY BACKUP LOCATE AS RREQ'D. BY CURRENT CODE.

4. VERIFY APPLIANCE & NEW MECHANICAL EQUIPMENT ELECTRICAL REQUIREMENTS W/OWNER PRIOR TO ROUGH IN

 PROVIDE OWNER W/ \$500 ALLOWANCE FOR THE SELECTION & INSTALLATION OF DIMMER SWITCHES. VERIFY LOCATIONS.

7. ALL BATH, LAUNDRY & KITCHEN EXHUAST VENTS TO EXIT A MIN. OF 3' FROM ANY EXTERIOR OPENING. PROVIDE BACKDRAFT

DAMPER AT ALL EXHAUST VENTS.

8. ALL RECESSED LIGHTS IN CONTACT W/
ROOF OR FLOOR INSULATION TO BE BOTH
IC & UL RATED.

6. PROVIDE FOR A MIN. OF 90 PERCENT OF THE LAMPS IN PERMANENTLY INSTALLED LIGHTING FIXTURES AS HIGH EFFICIENCY LAMPS PER THE 2020 ENERGY CONSERVATION CONSTRUCTION CODE OF NYS.

BASEMENT PLAN

/4"=1`-0"

ARCHITECT

OFFICES AT

2A Hardscrabble Rd.


North Salem New York 10560

ADDITION TO

Y RESIDENCE

WINDMILL PLACE


ASDEMENT LECTRICAL PLAN

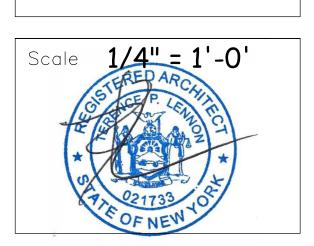

Date **04/29/22**Drawing By **A.O.** 

Drawing No.

E-101

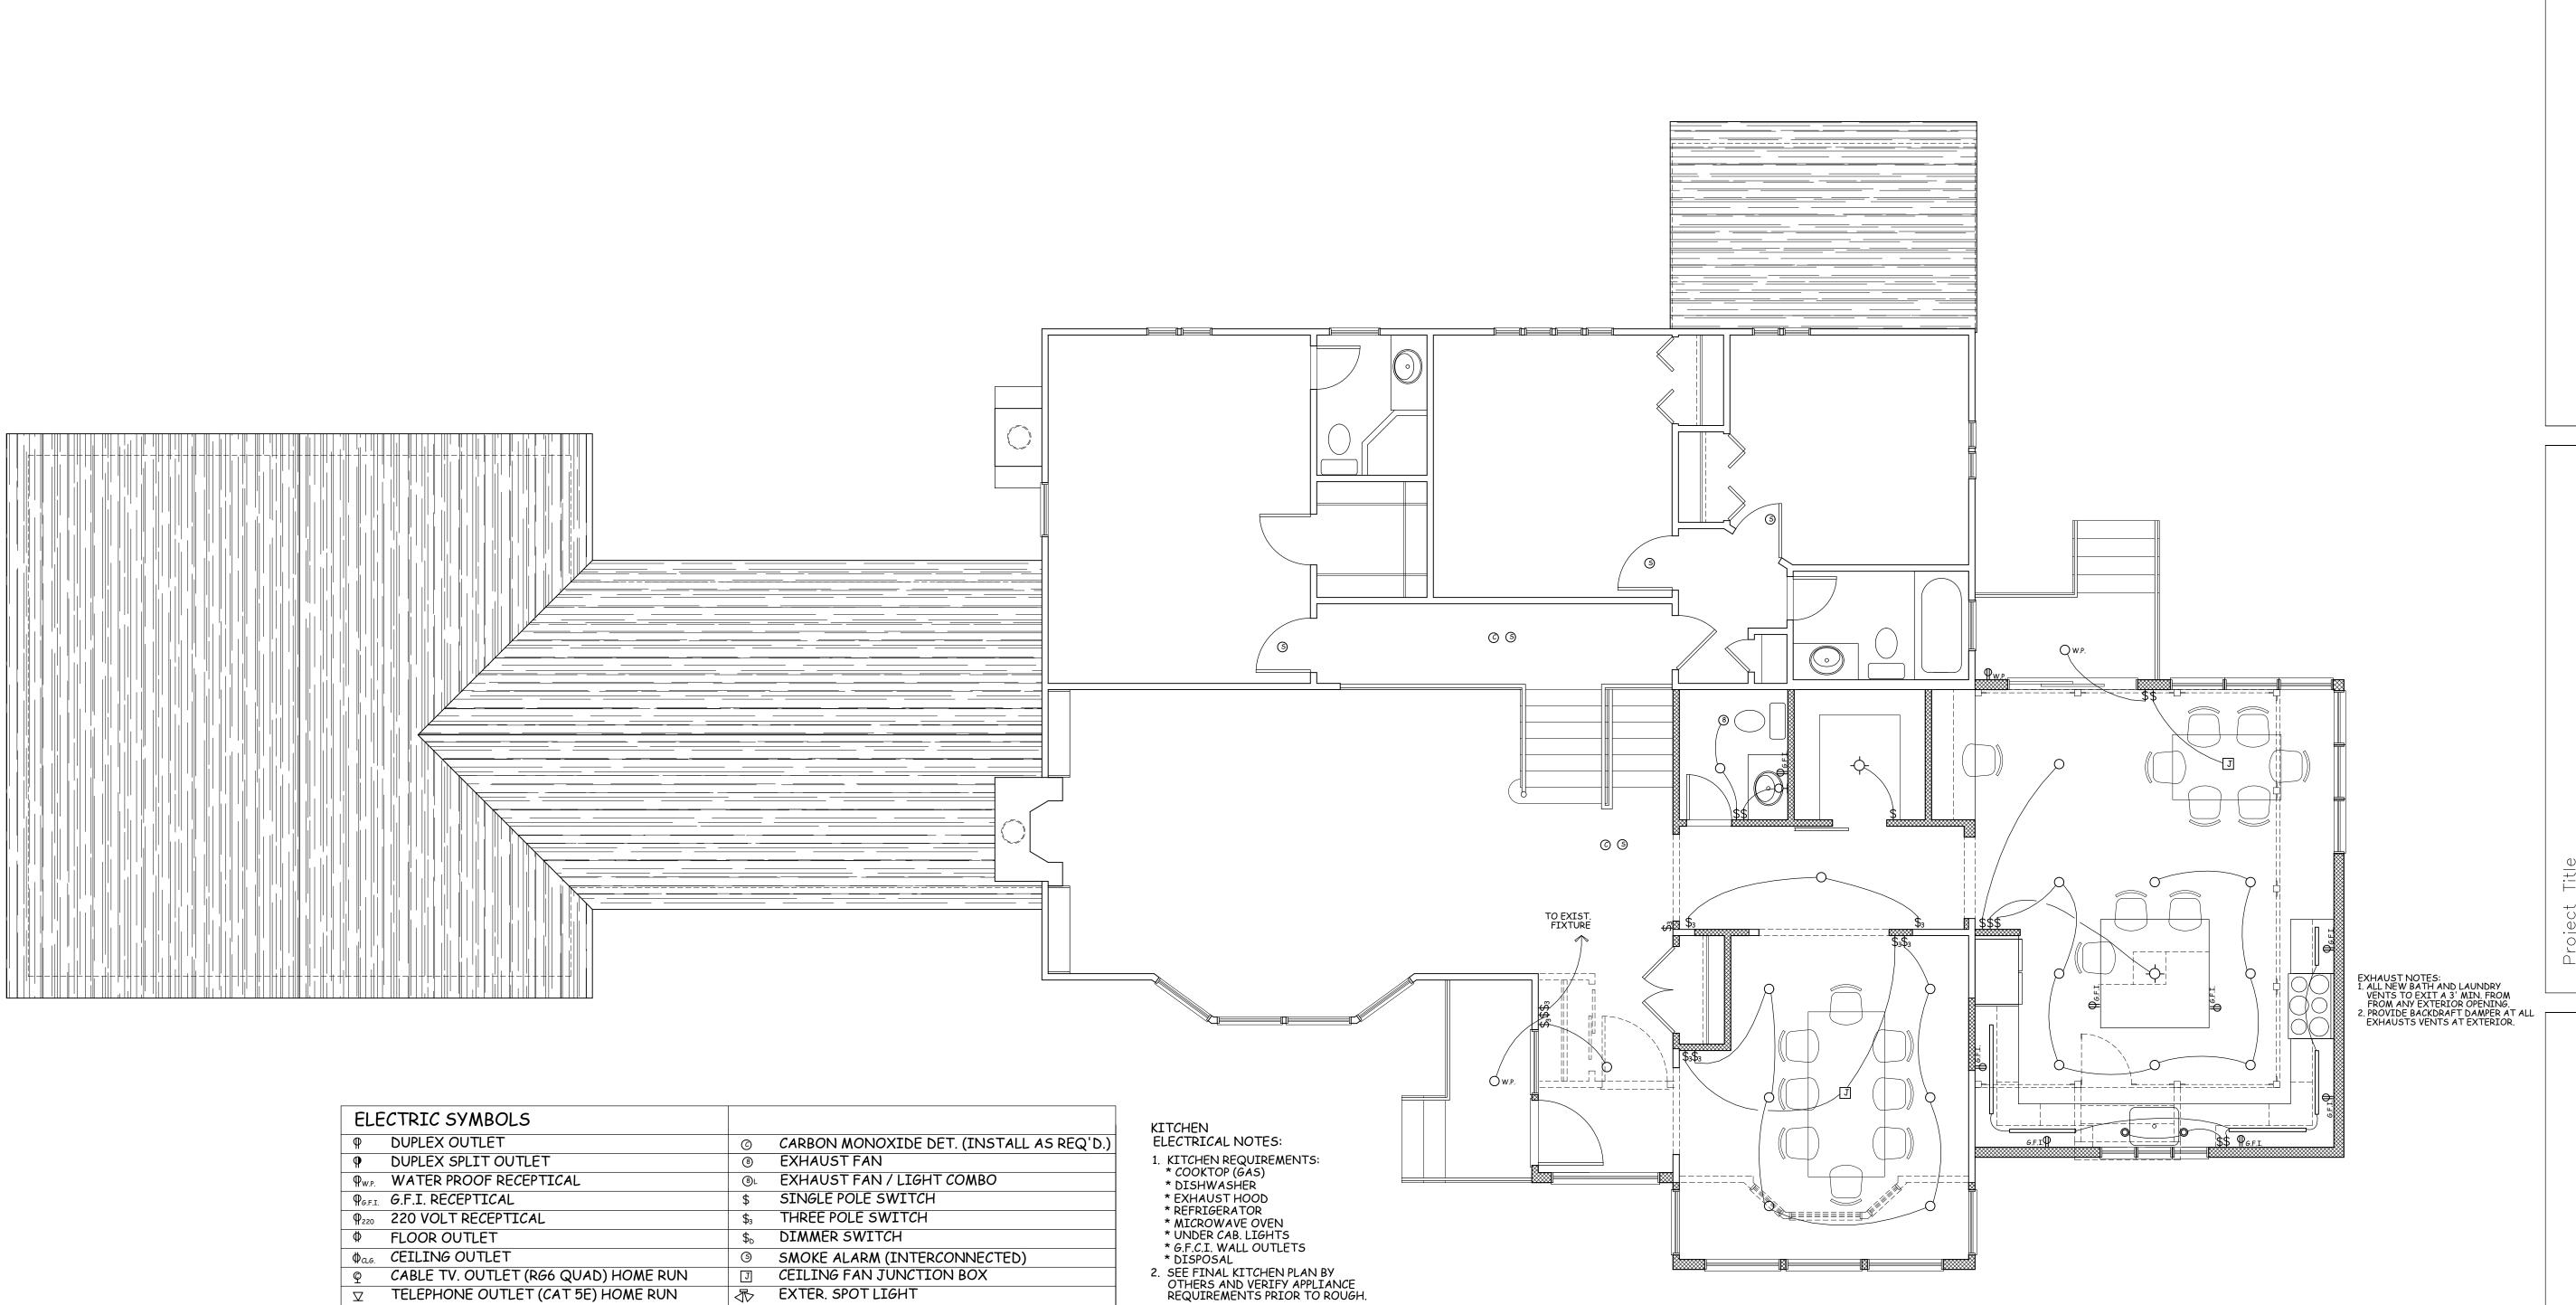

3. VERIFY KITCHEN COUNTER ELECTRICAL OUTLET LOCATIONS W/ KITCHEN SUPPLIER

### ELECTRICAL NOTES:

- 1. WALL OUTLETS AT AREA'S OF NEW WORK BY ELECTRICIAN AS REQ'D. BY CODE. UNLESS OTHERWISE NOTED ON DRAWING.
- 2. INSTALL HARDWIRED, INTERCONNECTED SMOKE DETECTORS W/ BATTERY BACKUP TO ALL AREA'S OF RESIDENCE AS REQ'D. BY CURRENT VERSION OF APPLICABLE CODE.

CABLE TV. OUTLET (RG6 QUAD) HOME RUN TELEPHONE OUTLET (CAT 5E) HOME RUN

- SURFACE MOUNTED LIGHT FIXTURE

O 5" RECESSED LIGHT W/ LED BULB & TRIM

○ 3" RECESSED LIGHT W/ LED BULB & TRIM

- 3. PROVIDE HARDWIRED, CARBON MONOXIDE DETECTORS W/ BATTERY BACKUP LOCATE AS RREQ'D. BY CURRENT CODE.
- 4. VERIFY APPLIANCE & NEW MECHANICAL EQUIPMENT ELECTRICAL REQUIREMENTS W/OWNER PRIOR TO ROUGH IN
- PROVIDE OWNER W/ \$500 ALLOWANCE FOR THE SELECTION & INSTALLATION OF DIMMER SWITCHES. VERIFY LOCATIONS.

EXTER. SPOT LIGHT

CEILING FAN JUNCTION BOX

— UNDERCOUNTER LIGHTING


WALL MOUNTED LIGHT FIXTURE

HEAT DETECTOR (INSTALL AS REQ'D. BY CODE)

- 6. PROVIDE FOR A MIN. OF 90 PERCENT OF THE LAMPS IN PERMANENTLY INSTALLED LIGHTING FIXTURES AS HIGH EFFICIENCY LAMPS PER THE 2020 ENERGY CONSERVATION CONSTRUCTION CODE OF NYS.
- 7. ALL BATH, LAUNDRY & KITCHEN EXHUAST VENTS TO EXIT A MIN. OF 3' FROM ANY EXTERIOR OPENING. PROVIDE BACKDRAFT
- DAMPER AT ALL EXHAUST VENTS.

  8. ALL RECESSED LIGHTS IN CONTACT W/
  ROOF OR FLOOR INSULATION TO BE BOTH
  IC & UL RATED.


# FIRST FLOOR PLAN

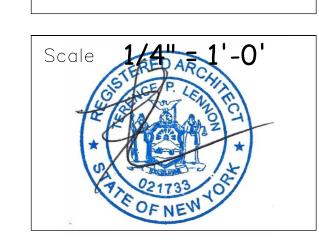

04/29/22 Drawing By **A.O.** 

Drawing No.

E-102

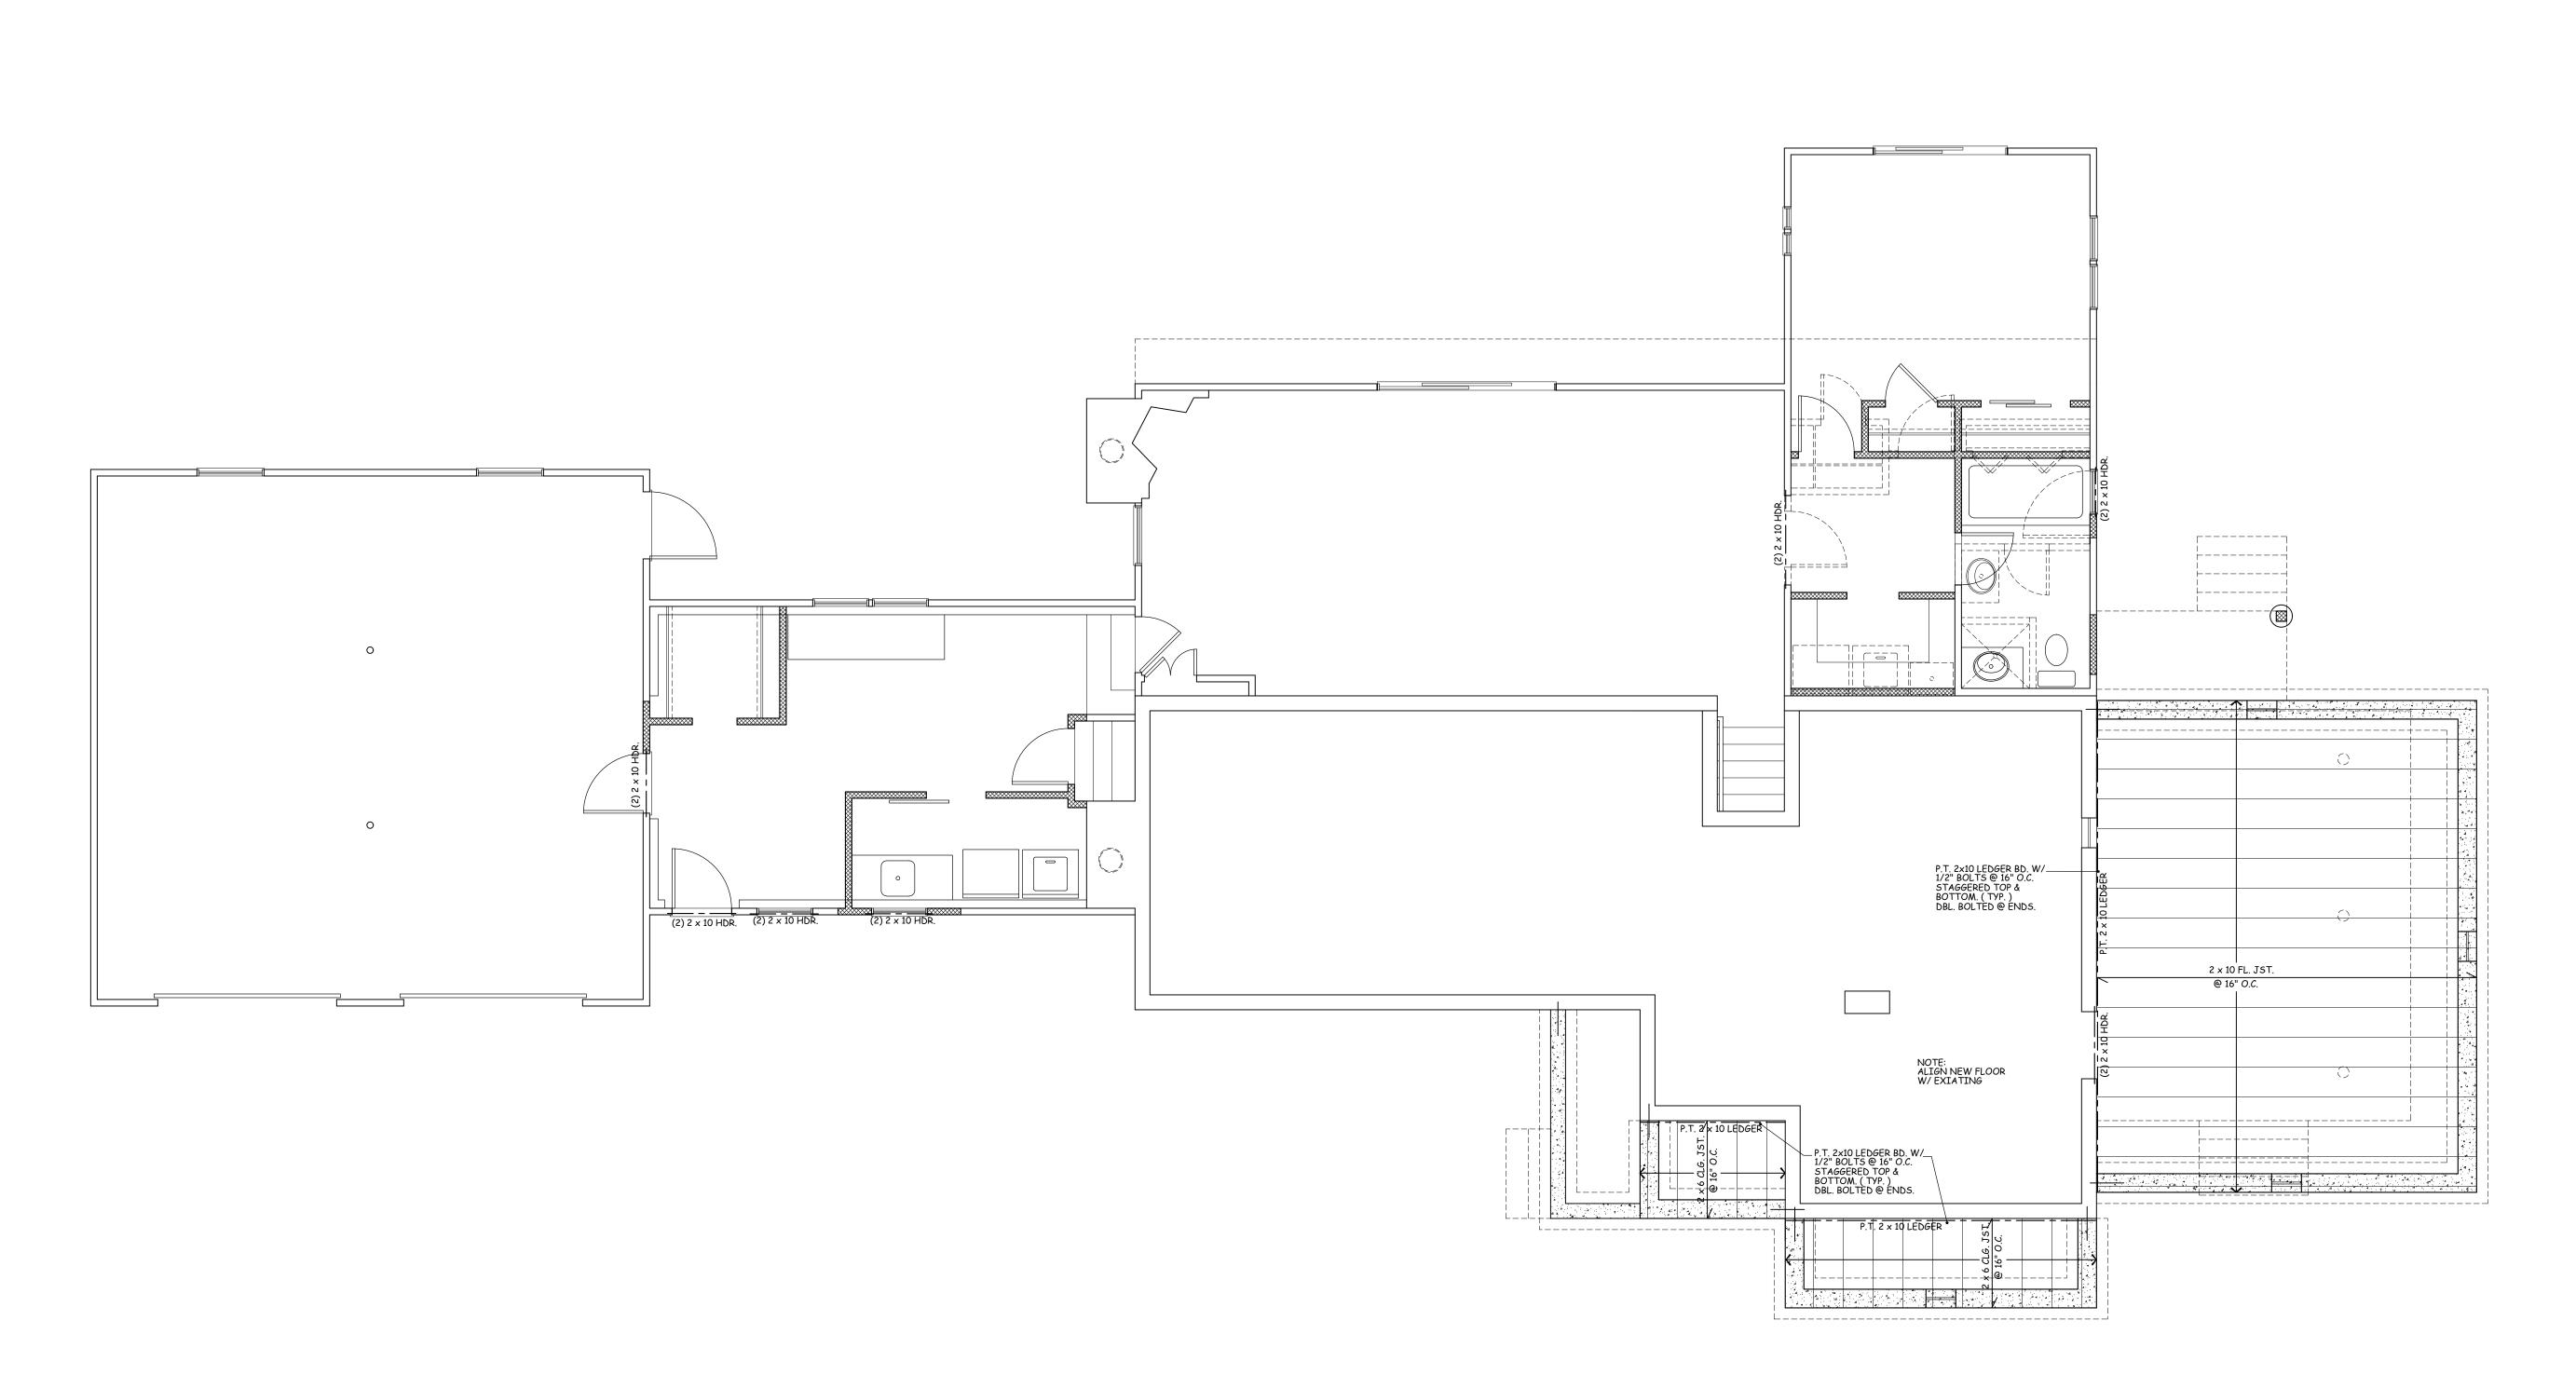

## BASEMENT PLAN

1/4"=1'-0"


### FRAMING NOTES:

- 1. ALL FRAMING SHOWN
  TO PLATE LINE BELOW
  2. ALL HEADERS TO BE (2)
  2 x 10's UNLESS NOTED
  OTHERWISE
  3. VERIFY FASC IA AND RAKE
  OVERHANGS. (SEE A-200)
- 4. PROVIDE SOLÌD STUDDING @ ALL BEAMS, HEADERS, AND POINT LOADS TO FOUND. 5. ALL ENGINEERED WOOD
- FRAMING PRODUCTS TO BE AS MFR'D. BY WEYERHAEUSER OR APPROVED EQUAL. INSTALL AS PER Mfr.'s SPECS.
- 6. SEE BUILDING SECTIONS AND DETAILS (A-300 SERIES DRAWINGS) FOR SUPPLEMENTAL FRAMING REQ.
- 7. CONTRACTOR RESPONSIBLE FOR VERIFYING FIELD CONDITIONS BEFORE START OF WORK AND NOTIFY ARCHITECT
- 8. PROVIDE 2 × 8 COLLAR TIES 32" O.C. AT ALL ROOFS. SET AT UPPER THIRD OF ATTIC SPACE. (TYP.)
  9. PROVIDE AND INSTALL REQUIRED PLACARDS INDICATING LOCATION AND USE OF ALL ENGINEERED FRAMING COMPONENTS.
- 10. PROVIDE 2 × 12 FLAT NAILER AT ALL VALLEYS OVER ROOFS. FLAT NAILER WIDTH SHALL MATCH THE JACK RAFTER LEVEL CUT MIN.
- 11. LVL's SHALL BE AS MFR'D. BY "WEYERHAEUSER"
  2.0E MICROLLAM OR APPROVED EQUAL. 1 3/4" WIDE
  IN DEPTH AS INDICATED ON PLANS.
  G= 125,000psi, E= 2.0 × 40 psi, Fc=750 psi, Ft= 1,555psi
  Fb=2,600 psi at 12" depth for other than 12" depth multiply
  Fb by (12/d) .136

  12. PROVIDE ROOF UPLIFT & TIE DOWN CONNECTIONS
  AS PER SECTION 802.11 OF THE 2020 RESIDENTAIL
  CODE OF NEW YORK STATE

LEVY RESIDENCE


99

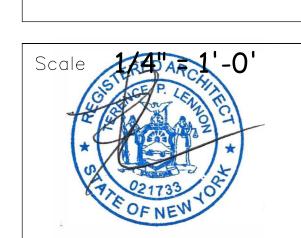

04/29/22 Date Drawing By **A.O.** 

Drawing No.

F-101

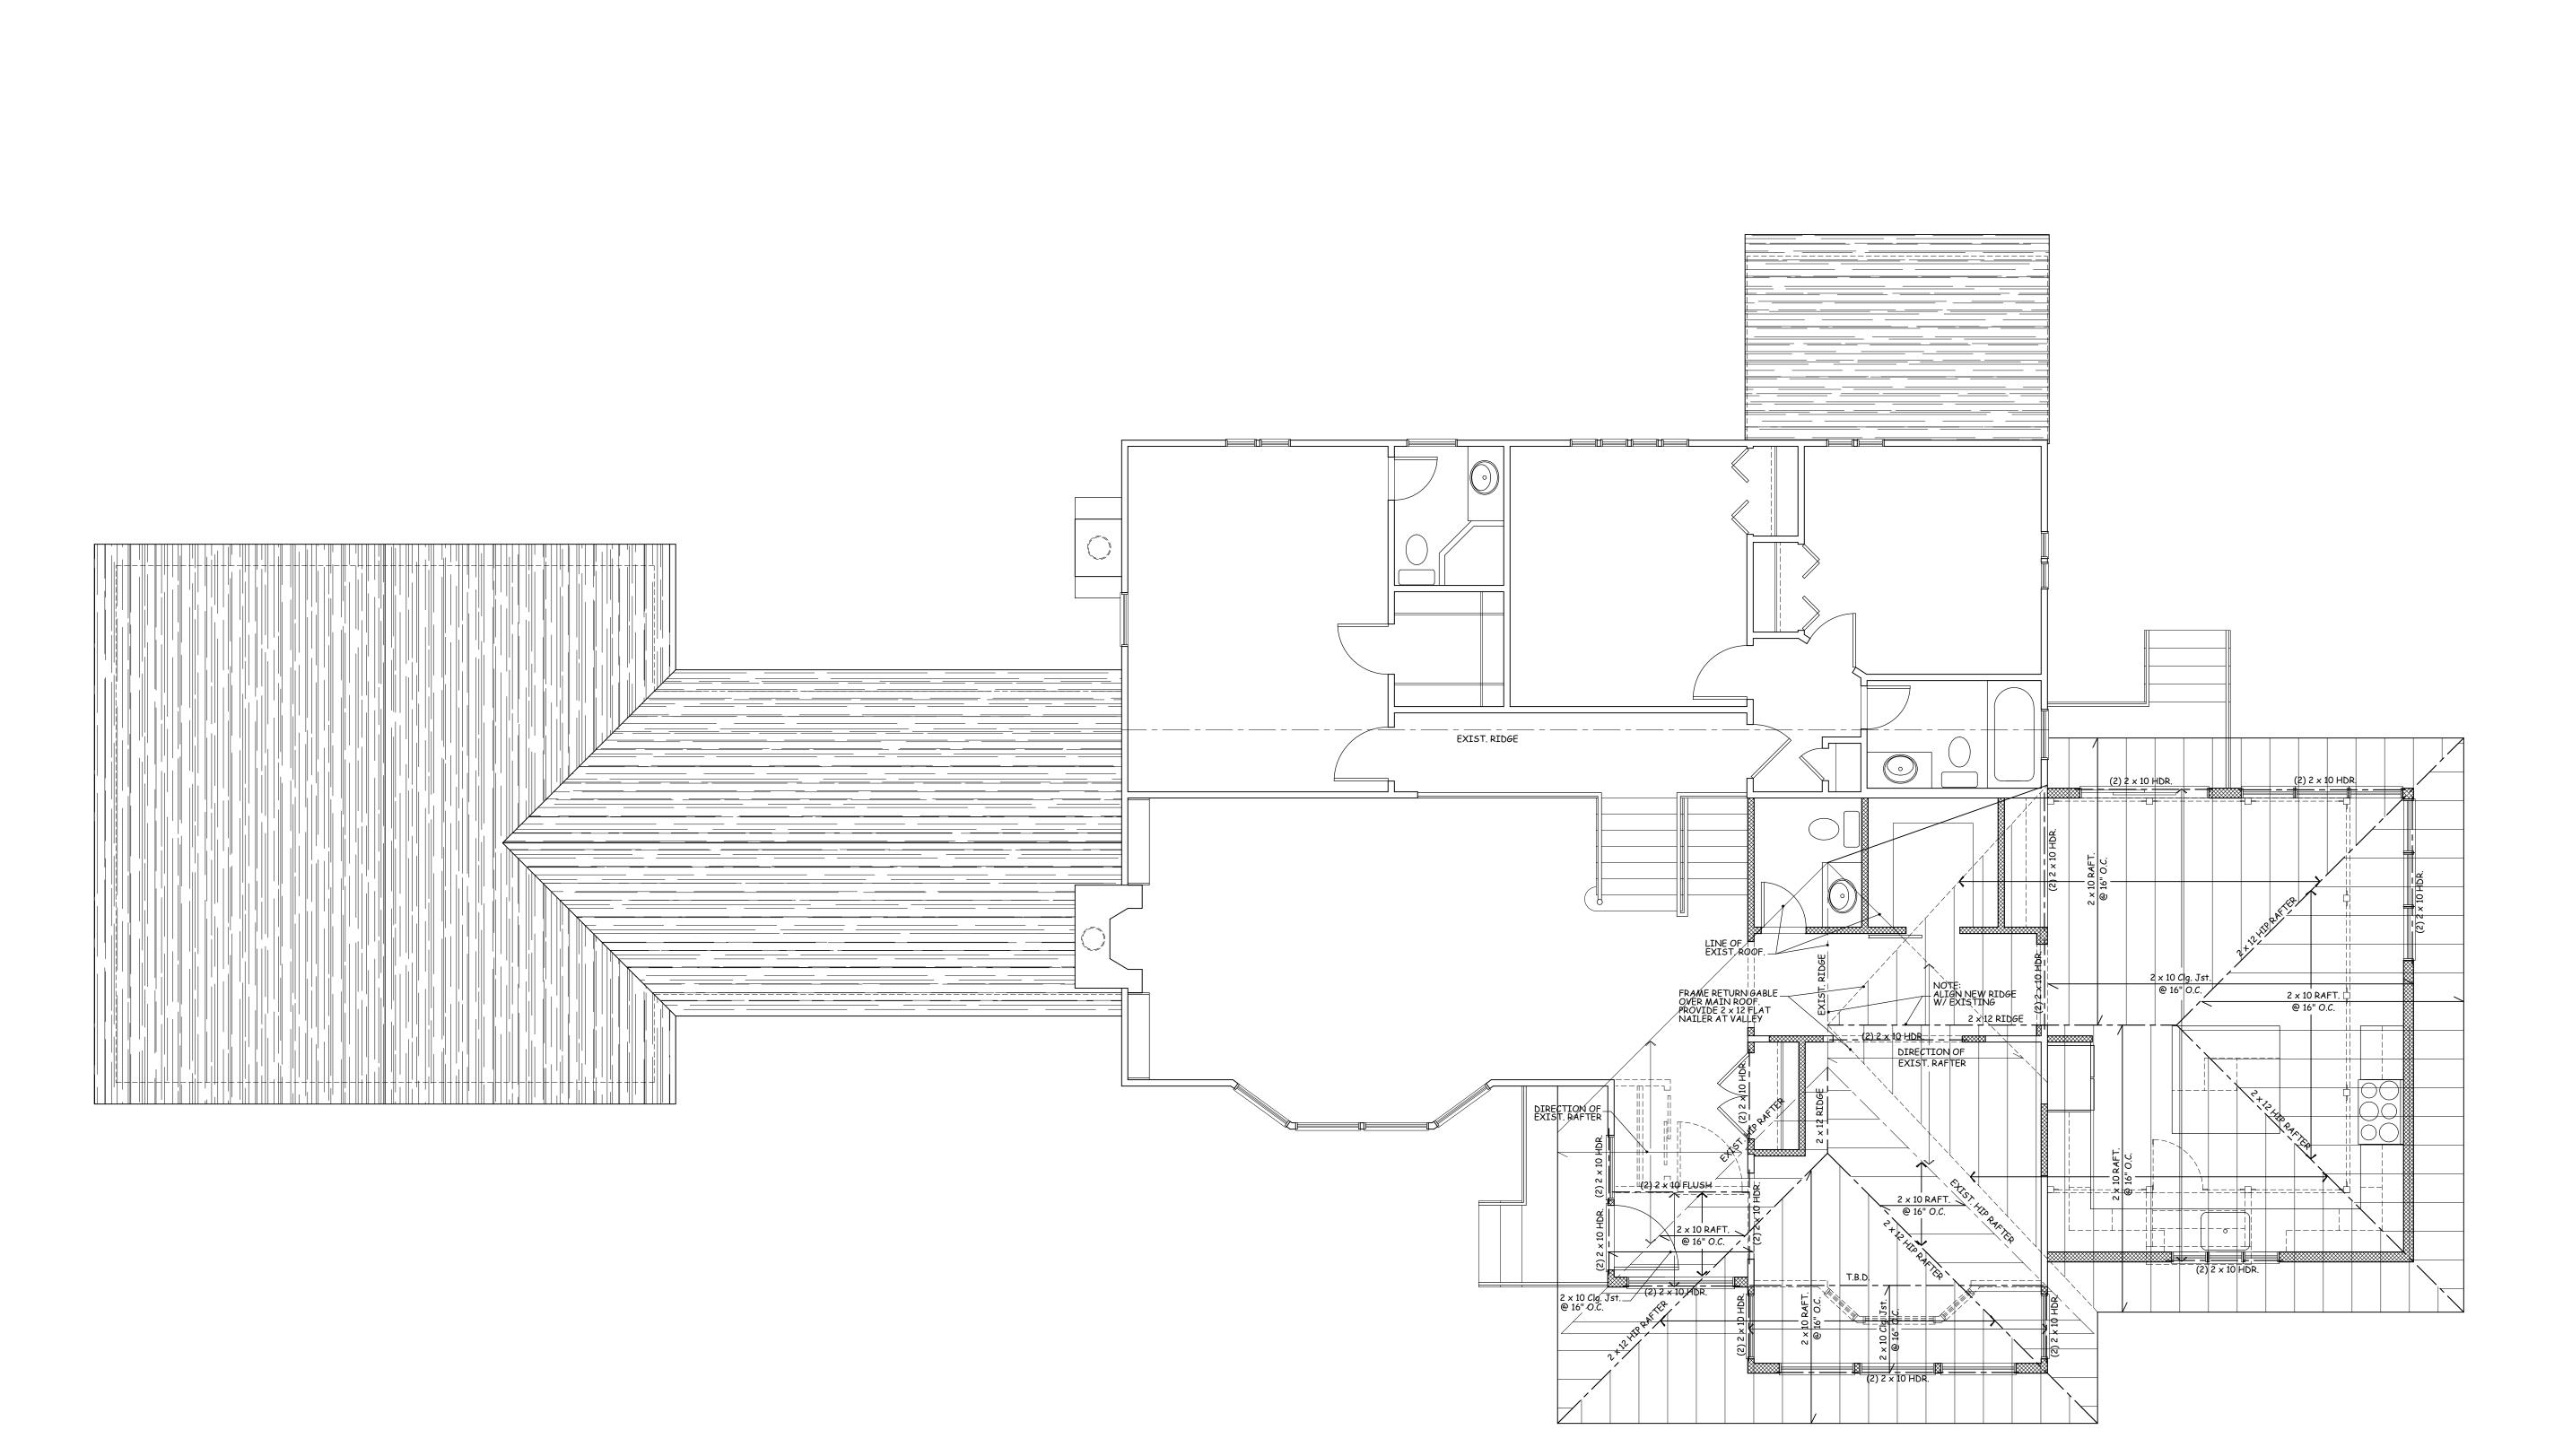


# FIRST FLOOR PLAN

### FRAMING NOTES:

- 1. ALL FRAMING SHOWN
  TO PLATE LINE BELOW
  2. ALL HEADERS TO BE (2)
  2 x 10's UNLESS NOTED
  OTHERWISE
  3. VERIFY FASC IA AND RAKE
  OVERHANGS. (SEE A-200) 4. PROVIDE SOLÌD STUDDING
- @ ALL BEAMS, HEADERS, AND POINT LOADS TO FOUND.
- 5. ALL ENGINEERED WOOD FRAMING PRODUCTS TO BE AS MFR'D. BY WEYERHAEUSER OR APPROVED EQUAL. INSTALL AS PER Mfr.'s SPECS.
- 6. SEE BUILDING SECTIONS AND DETAILS (A-300 SERIES DRAWINGS) FOR SUPPLEMENTAL FRAMING REQ.
- 7. CONTRACTOR RESPONSIBLE FOR VERIFYING FIELD CONDITIONS BEFORE START OF WORK AND NOTIFY ARCHITECT
- 8. PROVIDE 2 × 8 COLLAR TIES 32" O.C. AT ALL ROOFS. SET AT UPPER THIRD OF ATTIC SPACE. (TYP.)
  9. PROVIDE AND INSTALL REQUIRED PLACARDS INDICATING LOCATION AND USE OF ALL ENGINEERED FRAMING COMPONENTS.
- 10. PROVIDE 2 × 12 FLAT NAILER AT ALL VALLEYS OVER ROOFS. FLAT NAILER WIDTH SHALL MATCH THE JACK RAFTER LEVEL CUT MIN.
- 11. LVL's SHALL BE AS MFR'D. BY "WEYERHAEUSER"
  2.0E MICROLLAM OR APPROVED EQUAL. 1 3/4" WIDE
  IN DEPTH AS INDICATED ON PLANS.
  G= 125,000psi, E= 2.0 × 40 psi, Fc=750 psi, Ft= 1,555psi
  Fb=2,600 psi at 12" depth for other than 12" depth multiply
  Fb by (12/d) .136

  12. PROVIDE ROOF UPLIFT & TIE DOWN CONNECTIONS
  AS PER SECTION 802.11 OF THE 2020 RESIDENTAIL
  CODE OF NEW YORK STATE


FIG

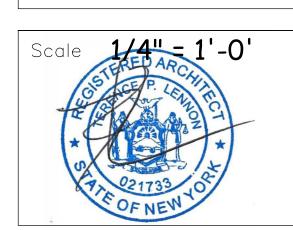

04/29/22 Drawing By **A.O.** 

Drawing No.

F-102

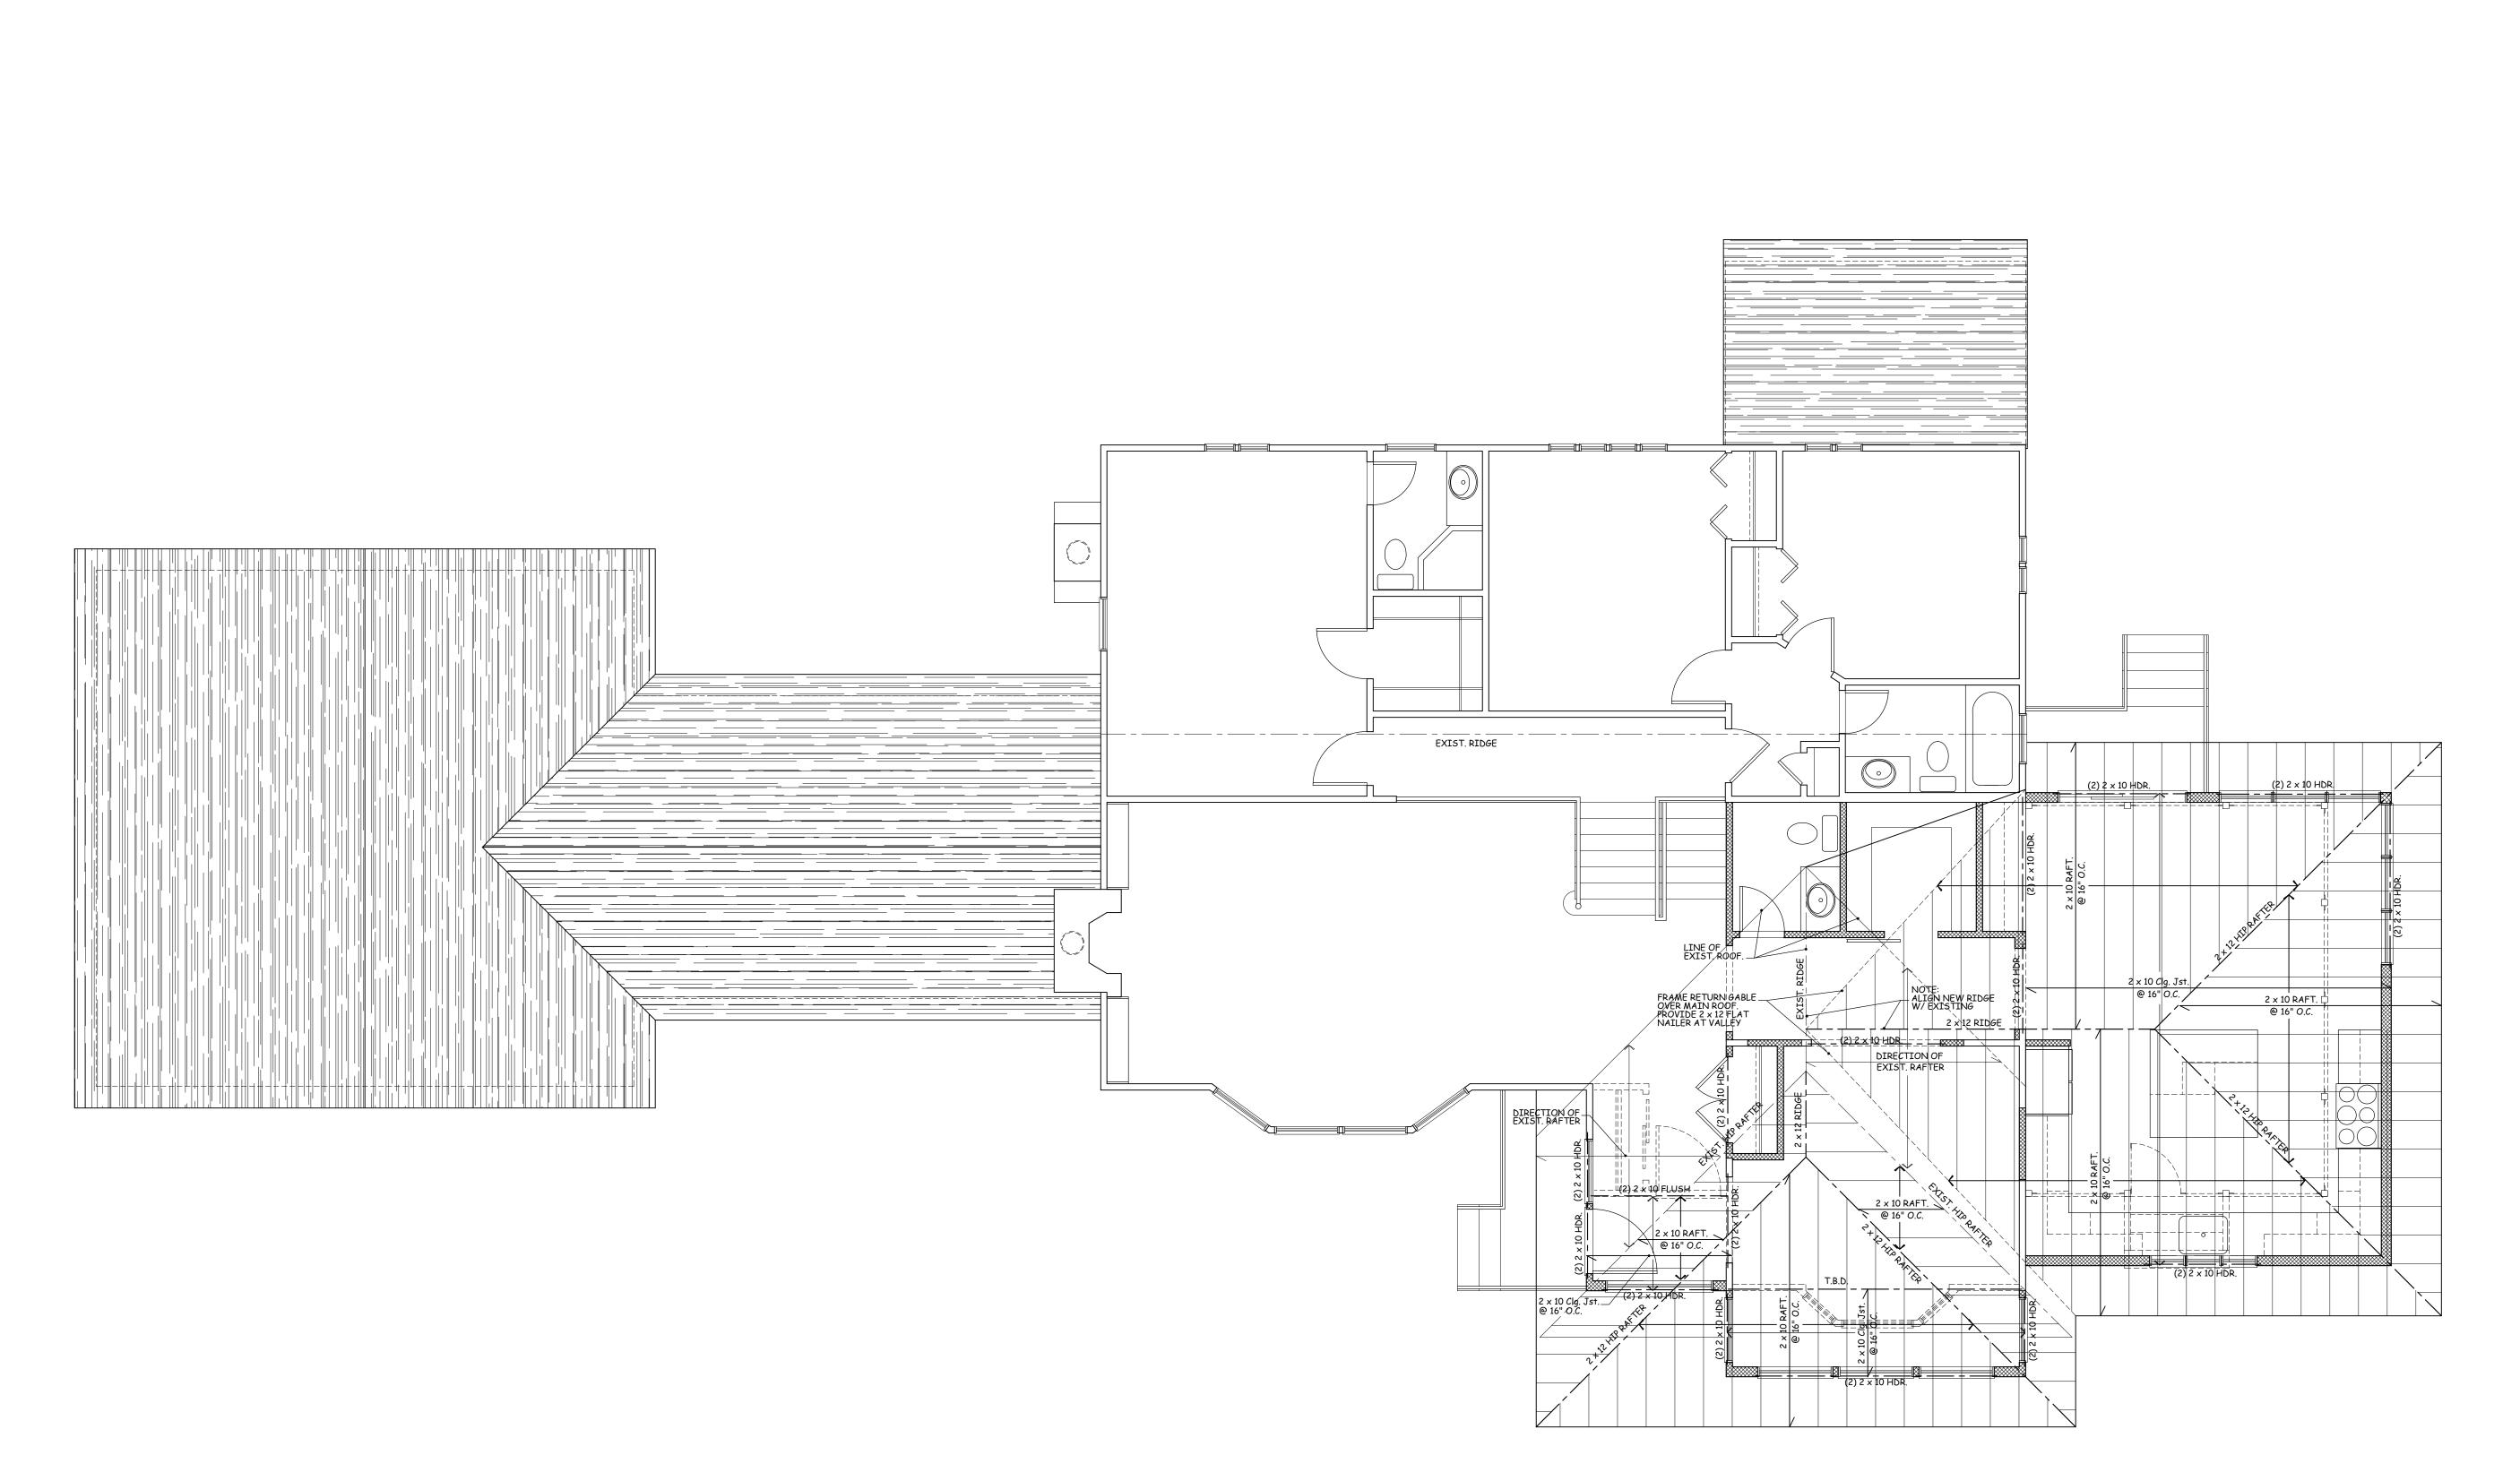

# FIRST FLOOR PLAN

FRAMING NOTES:

- 1. ALL FRAMING SHOWN
  TO PLATE LINE BELOW
  2. ALL HEADERS TO BE (2)
  2 x 10's UNLESS NOTED
  OTHERWISE
  3. VERIFY FASC IA AND RAKE
  OVERHANGS. (SEE A-200)
  4. PROVINE SOUTH STUDDING 4. PROVIDE SOLID STUDDING
- @ ALL BEAMS, HEADERS, AND POINT LOADS TO FOUND. 5. ALL ENGINEERED WOOD
- FRAMING PRODUCTS TO BE AS MFR'D. BY WEYERHAEUSER OR APPROVED EQUAL. INSTALL AS PER Mfr.'s SPECS.
- 6. SEE BUILDING SECTIONS AND DETAILS (A-300 SERIES DRAWINGS) FOR SUPPLEMENTAL FRAMING REQ.
- 7. CONTRACTOR RESPONSIBLE FOR VERIFYING FIELD CONDITIONS BEFORE START OF WORK AND NOTIFY ARCHITECT
- 8. PROVIDE 2 × 8 COLLAR TIES 32" O.C. AT ALL ROOFS. SET AT UPPER THIRD OF ATTIC SPACE. (TYP.) 9. PROVIDE AND INSTALL REQUIRED PLACARDS INDICATING LOCATION AND USE OF ALL ENGINEERED FRAMING COMPONENTS.
- 10. PROVIDE 2 × 12 FLAT NAILER AT ALL VALLEYS OVER ROOFS. FLAT NAILER WIDTH SHALL MATCH THE JACK RAFTER LEVEL CUT MIN.
- 11. LVL's SHALL BE AS MFR'D. BY "WEYERHAEUSER"
  2.0E MICROLLAM OR APPROVED EQUAL. 1 3/4" WIDE
  IN DEPTH AS INDICATED ON PLANS.
  G= 125,000psi, E= 2.0 × 40 psi, Fc=750 psi, Ft= 1,555psi
  Fb=2,600 psi at 12" depth for other than 12" depth multiply
  Fb by (12/d) .136

  12. PROVIDE ROOF UPLIFT & TIE DOWN CONNECTIONS
  AS PER SECTION 802.11 OF THE 2020 RESIDENTAIL
  CODE OF NEW YORK STATE

ROOF RAMING PL

Scale 1/4" = 1'-0'

04/29/22 Drawing By **A.O.** 

Drawing No.

F-102

Google Earth \_\_\_\_\_\_\_\_ 60 m\_ Camera: 751 m 41°09'03'N 73°40'01"W 183 m



Google Earth \_\_\_\_\_\_\_\_ 30 m\_ Camera: 474 m 41°09'03"N 73°40'01"W 178 n



# Town of North Castle Residential Project Review Committee

17 Bedford Road Armonk, New York 10504 (914) 273-3542 (914) 273-3554 (fax)

### RPRC COMPLETENESS REVIEW FORM

This form represents the standard requirements for a completeness review for all Residential Project Review Committee submissions. Failure to provide all of the information requested will result in a determination that the application is incomplete.

Project Name on Plan:	
Initial Submittal Revised Preliminary	
Street Location: 10 Windmill Place Arminle, My 10504	•
Zoning District: R.15 Property Acreage: 1-573 Tax Map Parcel ID: 102.01-1	-24
Date: 7/19/222	
DEPARTMENTAL USE ONLY	
Date Filed: Staff Name:	
Preliminary Plan Completeness Review Checklist Items marked with a are complete, items left blank are incomplete and must be completed, "NA" means not applicable.	
1. Plan prepared by a registered architect or professional engineer	
2. Aerial photo (Google Earth) showing the applicant's entire property and adjacent properties and streets	
3. Map showing the applicant's entire property and adjacent properties and streets	
. A locator map at a convenient scale	
The proposed location, use and design of all buildings and structures	
Existing topography and proposed grade elevations	
7. Location of drives	
3. Location of all existing and proposed site improvements, including drains, culverts, retaining walls and fences	

### RPRC COMPLETENESS REVIEW FORM

Page 2

<b>)</b> . [	Description of method of water supply and sewage disposal and location of such facilities
	The name and address of the applicant, property owner(s) if other than the applicant and of the planner, engineer, architect, surveyor and/or other professionals engaged to work
	Submission of a Zoning Conformance Table depicting the plan's compliance with the ninimum requirements of the Zoning District
g	f a tree removal permit is being sought, submission of a plan depicting the location and graphical removal status of all Town-regulated trees within the proposed area of disturbance. In addition, the tree plan shall be accompanied by a tree inventory includes a unique ID number, the species, size, health condition and removal status of each tree.
	f a wetlands permit is being sought, identification of the wetland and the 100-foot wetland buffer.
Plannin	information about the items required herein can be obtained from the North Castle ig Department. A copy of the Town Code can be obtained from Town Clerk or on the castle homepage: <a href="http://www.northcastleny.com/townhall.html">http://www.northcastleny.com/townhall.html</a>
	On this date, all items necessary for a technical review of the proposed site plan have been submitted and constitute a COMPLETE APPLICATION.



### TOWN OF NORTH CASTLE

### WESTCHESTER COUNTY 17 Bedford Road Armonk, New York 10504-1898

### PLANNING DEPARTMENT Adam R. Kaufman, AICP Director of Planning

Telephone: (914) 273-3542 Fax: (914) 273-3554 www.northcastleny.com

GROSS LAND COVERAGE CALCULATIONS WORKSHEET

	CHOSS Entre So Financia	7/-0/
		Date: 4/28/2022
Tax Map	Designation or Proposed Lot No.: 102.01-1-27	
Gross Lo	ot Coverage	
1.	Total lot Area (Net Lot Area for Lots Created After 12/13/06):	1.5 +5
2.	Maximum permitted gross land coverage (per Section 355-26.C(1)(b)):	6534
3.	BONUS maximum gross land cover (per Section 355-26.C(1)(b)):	
	Distance principal home is beyond minimum front yard setback x 10 =	
4.	TOTAL Maximum Permitted gross land coverage = Sum of lines 2 and 3	6534
5.	Amount of lot area covered by <b>principal building:</b> 2424 existing + 463 proposed =	2387
6.	Amount of lot area covered by accessory buildings:  existing + proposed =	
7.	Amount of lot area covered by decks:  existing + proposed =	47
8.	Amount of lot area covered by <b>porches:</b> 309 existing + 269 proposed =	45
9.	Amount of lot area covered by <b>driveway</b> , <b>parking areas and walkways:</b> existing + proposed =	3202
10.	Amount of lot area covered by terraces: existing + proposed =	
11.	Amount of lot area covered by tennis court, pool and mechanical equip:  existing + proposed =	
12.	Amount of lot area covered by all other structures:	
13. Prop	osed gross land coverage: Total of Lines 5 – 12 =	6181
the proje does not	3 is less than or equal to Line 4, your proposal complies with the Town's maximum greet may proceed to the Residential Project Review Committee for review. If Line 13 is comply with the Town's regulations.  Date	ross land coverage regulations and greater than Line 4 your proposal
	021733 OF	



### TOWN OF NORTH CASTLE

### WESTCHESTER COUNTY 17 Bedford Road

Armonk, New York 10504-1898

### PLANNING DEPARTMENT Adam R. Kaufman, AICP **Director of Planning**

January 29, 2019 Telephone: (914) 273-3542 Fax: (914) 273-3554 www.northcastleny.com

FLOOR AREA CALCULATIONS WORKSHEET Application Name or Identifying Title: Tax Map Designation or Proposed Lot No.: Floor Area Total Lot Area (Net Lot Area for Lots Created After 12/13/06): 1. 2. **Maximum** permitted floor area (per Section 355-26.B(4)): 3. Amount of floor area contained within second floor: 4. 546 existing + \_\_\_\_\_ proposed = 5. Amount of floor area contained within garage: existing + proposed = Amount of floor area contained within porches capable of being enclosed:

274 existing + 274 proposed = 6. Amount of floor area contained within basement (if applicable – see definition): 7. existing + proposed = Amount of floor area contained within attic (if applicable - see definition): 8. \_\_\_\_\_existing + \_\_\_\_\_proposed = 9. posed floor area: Total of Lines 3 - 9 =10. Pro If Line 10 is less than or equal to Line 2, your proposal complies with the Town's maximum floor area regulations and the project may proceed to the Residential Project Review Committee for review. If Line 10 is greater than Line 2 your proposal does not comply with the Town's regulations. Signature and Seal of Professional Preparing Worksheet



Section I- PROJECT

### TOWN OF NORTH CASTLE

### WESTCHESTER COUNTY 17 Bedford Road Armonk, New York 10504-1898

RESIDENTIAL PROJECT REVIEW COMMITTEE Adam R. Kaufman AICP, Chair


Telephone: (914) 273-3000 x 43

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### RESIDENTIAL PROJECT REVIEW COMMITTEE (RPRC) APPLICATION

ADDRESS: 10 Windmill Place Armondo Ny 10504

Section III- DESCRIPTION OF WORK:
· Kyrta / Entry Expansion · Small Rear Landona : STOPS
. SMOIL REDUCE . STOPS
Section III- CONTACT INFORMATION:
APPLICANT: Bulders Afelier
ADDRESS: 2A Hardscrabble Road North Selem, NY 100701)
PHONE: 9142762500 MOBILE: EMAIL: abbookie Poutlook. com.
PROPERTY OWNER: LLVY
ADDRESS: 10 Windmill Place Armonte, NY 10504
ADDRESS: 10 Windmill Place Armonic, NY 10504 PHONE: 914 273 9638 MOBILE: 914 3931577 EMAIL: Maichael. Levy @grand/uxrealty
PROFESSIONAL: Terence Lennon
ADDRESS: 11 Aunt Park Lane Newform CT 06470
PHONE: 177 15 4 / 9 6 7 MOBILE:
EMAIL: terry lennonaia @ gnail.com
Section IV-PROPERTY INFORMATION:
Zone: 2.15 Tax ID (lot designation) /02.01-124

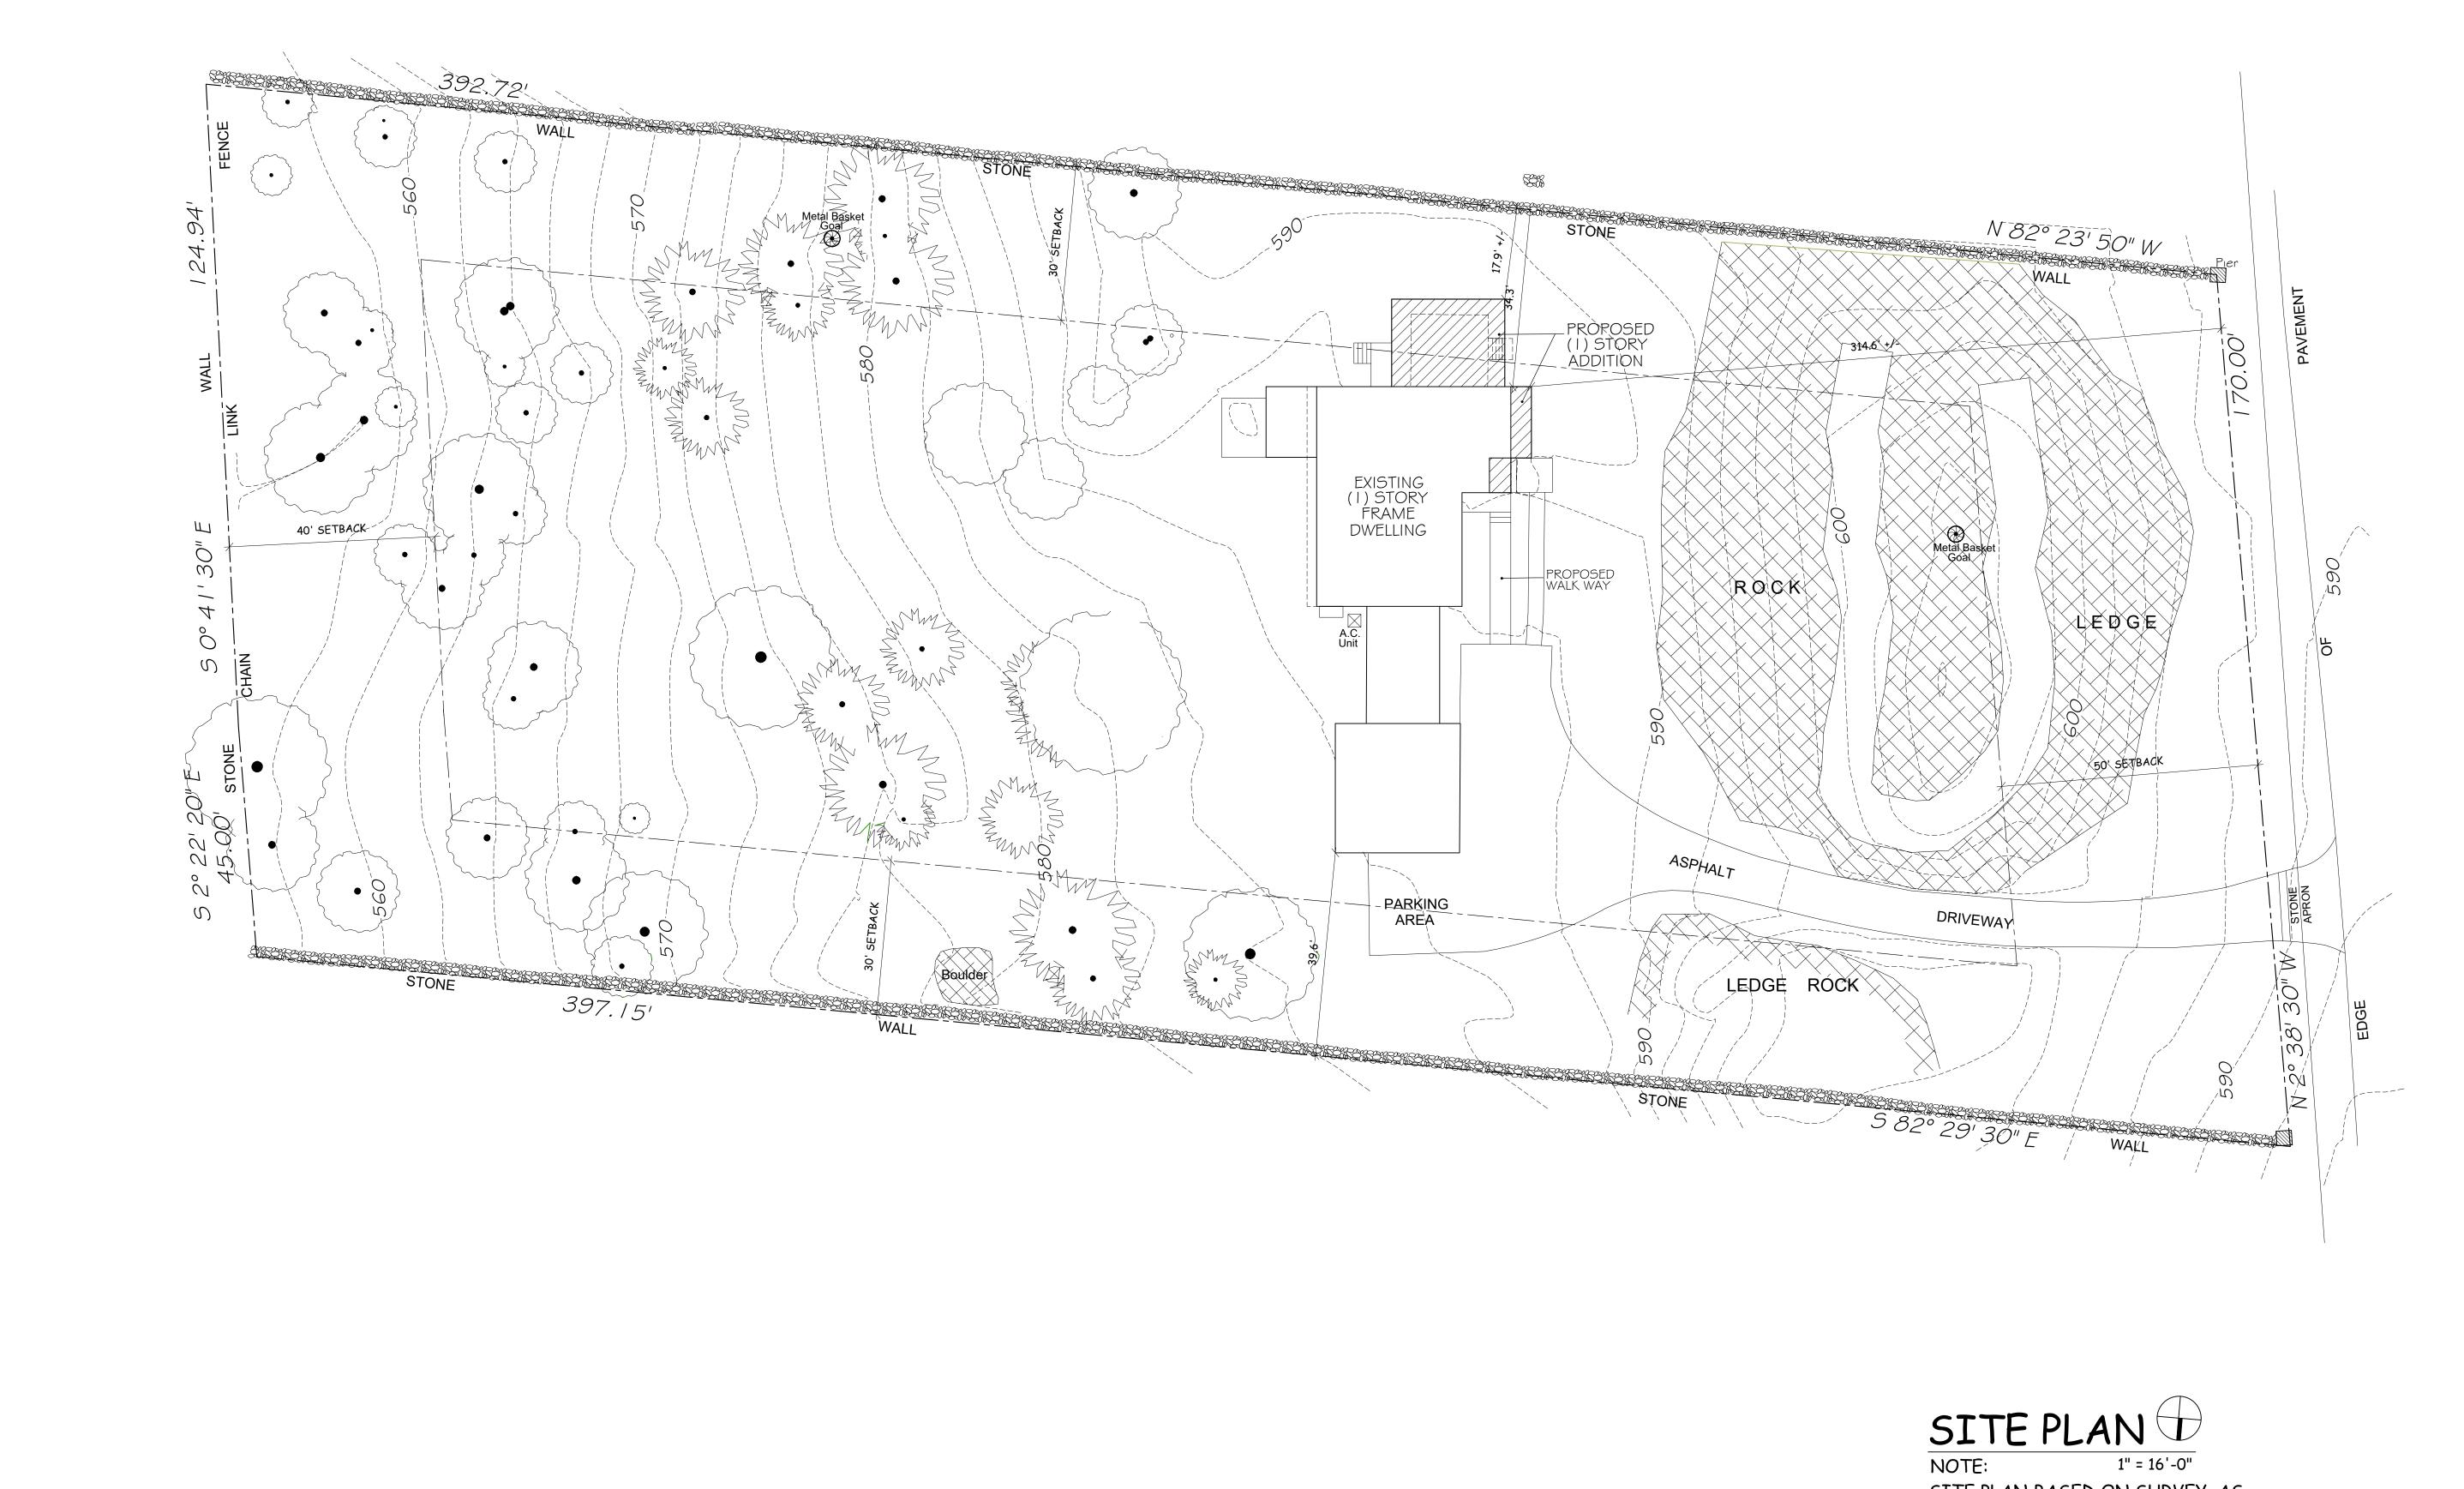

SITE PLAN BASED ON SURVEY, AS PREPARED BY JRL SURVEYING P.C. DATED 06/01/2022


MAP- BLOCK- LOT = 79.05 - 1 - 48 LOT AREA = 66,289 sq.ft. / 1.5218 AC. ZONE = R-1.5A

SETBACK: FRONT = 50' REAR = 40' SIDE = 30'

RCHITECTS

ADDITION TO LEVY RESIDENCE

PROPOSED SITE PLAN

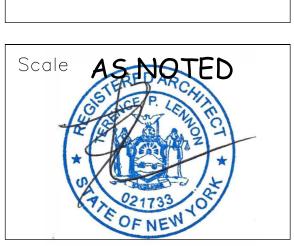

11/08/07 Drawing By **A.O.** 

Drawing No.

