

Site Planning
Civil Engineering
Landscape Architecture
Land Surveying
Transportation Engineering

Environmental Studies Entitlements Construction Services 3D Visualization Laser Scanning

March 25, 2024

Honorable Chairman Carthy and Members of the Planning Board Town of North Castle 15 Bedford Road Armonk, New York 10504

RE: JMC Project 20044

4 Tripp Lane Zoning Compliance

4 Tripp Lane

Town of North Castle, New York

Response to KSCJ Comments Outlined in a Memorandum Issued to the Conservation Board & Planning Board, dated February 15, 2024.

Chairman Carthy and Members of the Planning Board:

This letter has been prepared to address comments from KSCJ, dated February 15, 2024, the Town's Planning Department staff.

To assist in your review of the revised documents, we are pleased to provide the following, which restates the comments from the above referenced memorandums, followed by our responses:

Comment No. 1

On February 8, 2024, this office met with the homeowner and the Design Engineer for a site visit. The intermittent watercourse previously shown bisecting the property has been determined not to exist; therefore, the only regulated on-site area is the 100' buffer associated with an off-site wetland located on 2 Tripp Lane. A markup of the submitted plan has been provided showing the on-site 100' wetland buffer. Please note that associated disturbance numbers should be outlined.

Response No. 1

JMC has updated the Site Plans and mitigation requirements based on KSCJ's findings and the Conservation Board's subsequent approval. The applicant looks forward to coordinating the approval of these updated plans with the Planning Board.

Comment No. 2

A Wetland Mitigation Cost Estimate shall be submitted. The Conservation Board may wish to consider requesting a long-term wetland mitigation maintenance and monitoring plan (typically 5

JMC Planning Engineering Landscape Architecture & Land Surveying, PLLC | JMC Site Development Consultants, LLC

years) to ensure that plantings associated with any required wetland mitigation plan will continue to thrive.

Response No. 2

A wetland mitigation estimate will be submitted as soon as this plan has been finalized with the Planning Board. The applicant requests that this be an item included in the Site Plan Resolution letter.

Comment No. 3

As previously noted, the plan has been revised as requested to illustrate and dimension all minimum required yard setbacks and includes a Bulk Zoning Table. It appears that area variances and/or waivers will be required for the location of the driveway gate, curb cut width and gate pier height. The plan should be referred to the Building Inspector for confirmation.

Response No. 3

The applicant awaits referral to the Building Inspector to finalize the requested waiver and variance.

Comment No. 4

As previously noted, the applicant has cleared a significant number of trees on the property. The quantity, size and species are not known. As required by Chapter 308, Trees of the Town Code, Section 308-25, the applicant will be required to provide a tree restoration plan to mitigate the unapproved removal of existing vegetation. The Planning Board will need to determine whether the restoration plan is ultimately appropriate for the level of disturbance and removals.

Because the actual level of Town-regulated tree removal is unknown, the applicant has used the adjacent property to establish a tree sample area to establish a baseline for the tree mitigation calculations. This office is amenable to this approach. The applicant has identified all trees greater than eight (8) inches in diameter and all trees greater than 24 inches in diameter from the 5,000 sf tree sample area. A total of 17 trees were sampled; 13 @ 8 inch dbh or greater and 4 @ 24 inch dbh or greater, which equates to 76% and 24% of the sample area, respectively. Applying this sample area over the ± 1.15 acres of tree removal results in a total of 171 trees removed; 130 @ 8 inch dbh or greater and 41 @ 24 inch dbh or greater (not 139 and 32 as presented in the calculations). This results in a minimum total tree caliper of 2,024 inches to mitigate. The applicant is proposing a total of ± 146 caliper inches of plantings. The applicant shall update the mitigation requirements, proposed tree planting notes and planting plan accordingly. It appears additional mitigation will be required. The planting notes were also cut off on the plan and should be corrected.

Response No. 4

JMC submitted and presented Drawing C-130, titled "Tree & Wetland Mitigation Plan" to the Conservation Board following two separate site walks, one including a representative from the Conservation Board the other including a representative from KSCJ, that now shows the updated wetland location and subsequent tree and wetland mitigation plan as determined following these site

walks and additional soil testing. JMC received a positive recommendation from the Conservation Board on this plan to the Planning Board on February 20, 2024, as detailed in a letter from the Conservation Board to the Planning Board, dated March 7, 2024.

It seems the applicant, the Planning Board, and the Conservation Board are in agreement that a total of 2,024 DBH inches were removed during the construction detailed on these Site Plans and would require the planting of 2,024 DBH inches to mitigate the removal. The mitigation, as shown on JMC Drawing C-130, is detailed below:

8-18" DBH trees were saved. (144 inches)
238-2" DBH trees were planted. (476 inches)
9-8" DBH trees were also planted. (72 inches)
29-3.5" trees are proposed to be planted. (101 inches)
23-1" trees are proposed to be planted. (23 inches)

For a total of 816 inches of tree mitigation. This was the amount that was described to the Conservation Board, and it was the applicant's understanding that their approval, detailed in the March, 7th letter, included this mitigation amount. It should be noted that the applicant proposes to dedicate 31,200 sf as a "no mow" meadow area.

Comment No. 5

As previously requested, the cut and fill plan should overlay the surveyed topography onto the predeveloped GIS topography to illustrate the cut and fill volumes established between pre-existing conditions and existing conditions. The fill sampling and testing was reviewed by the Town's Environmental Consultant. It was agreed that the fill remain in place with a 24 inch soil cap and a demarcation layer (orange fence or geotextile membrane) placed above the existing fill section. The soil cap shall include a minimum six (6) inch layer of top soil. This has been noted and detailed on the plan. However, the applicant shall prepare a proposed grading plan to illustrate how the add fill will be accommodated on the site and what, if any, added modifications to walls, walks, drives, etc., may be needed as a result. The applicant must also prepare an erosion and sediment control plan to illustrate and detail temporary access to the site and protection of the septic field for the import of clean fill, as well as all temporary sediment and erosion control measures that will be required.

The applicant has revised the scope of the project to propose the removal of approximately 704 c.y. of imported fill, which appears after extensive testing on the site, concentrated in an area located along the western property boundary. The applicant has stated, during a meeting on August 6, 2023 held at Town Hall, between the Applicant, The Planning Department, and our office, that test pits have revealed that the imported fill did not extend to the rest of the site as originally assumed. We defer to the Board on the acceptance and limits of the new imported fill removals.

Response No. 5

As was requested at the last Planning Board meeting on March 11th, the applicant has prepared a fill removal plan, titled "Fill Removal Plan" that would detail how the Site would look in the interim while the fill was removed before the excavated area could be backfilled.

Comment No. 6

The stormwater treatment system's overflow pipe should not be installed discharging towards the neighboring property. We recommend proposing pop-up emitters on the system or relocating the overflow to an area that will not affect the neighbors.

Response No. 6

The outlet structure has been removed and a grate is now being proposed on the 18" Nyloplast cleanout. The system will now act as bubbler system, meaning water will slowly bubble out of the inlet when the underground system becomes inundated with water during heavy rainfall events. Detail #7 has been added to JMC Drawing C-901.

We trust that the above, along with the enclosed documents and drawings, address comments from KSCJ, dated February 15, 2024, the Town's Planning Department staff. We look forward to your continued review throughout the Site Plan approval process and discussing this matter with you further. Should you have any questions or require additional information regarding the information provided above, please do not hesitate to contact our office at 914-273-5225.

Sincerely,

JMC Planning Engineering Landscape Architecture & Land Surveying, PLLC

Rick Bohlander

Rick Bohlander, PE Project Manager

p:\2020\20044\admin\tcomment response 03-25-2024.docx

SITE DEVELOPMENT PLAN APPROVAL DRAWINGS

PEREIRA RESIDENCE

4 TRIPP LANE TAX MAP SECTION 108.02 | BLOCK 1 | LOT 10 WESTCHESTER COUNTY NORTH CASTLE, NY

Applicant / Owner:
MR. & MRS. PEREIRA
4 TRIPP LANE
TOWN OF NORTH CASTLE, NY
APPLICANT PHONE: (914) 391-6979

Architect:


GET MY C.O. 57 WHEELER AVENUE, SUITE 203 PLEASANTVILLE, NY 10570 (914) 727-0980

Surveyor:

SUMMIT LAND SURVEYING P.C. 21 DRAKE LANE WHITE PLAINS, NY 10607 (914) 629-7758



Site Planner, Civil Engineer
and Landscape Architect:
120 BEDFORD ROAD
ARMONK, NY 10504
(914) 273-5225

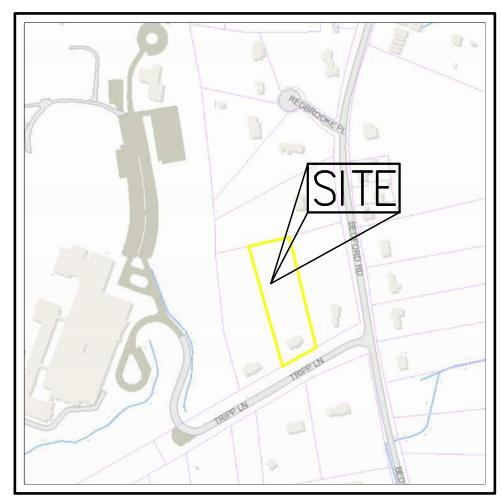





JMC Drawing List:

C-000 COVER SHEET

C-100 PRE-EXISTING CONDITIONS MAP

C-110 EXISTING CONDITIONS MAP AND DEMOLITION PLAN

C-130 TREE & WETLAND MITIGATION PLAN

C-140 FILL REMOVAL PLAN

C-200 SITE PLAN

C-310 GROSS LAND COVERAGE PLAN

C-410 CUT AND FILL PLAN

C-900 CONSTRUCTION DETAILS

C-901 CONSTRUCTION DETAILS

TABLE OF LAND USE

TOWN OF NORTH CASTLE, N.Y. SECTION 108.02, BLOCK 1, LOT 10

DESCRIPTION		REQUIRED	PROVIDED
MINIMUM LOT AREA	(ACRES / S.F.)	2	±2.06/±89,820
MINIMUM LOT FRONTAGE	(FEET)	150	±183.6
MINIMUM LOT WIDTH	(FEET)	150	±175
MINIMUM LOT DEPTH	(FEET)	150	±513.3
MINIMUM YARDS			
FRONT	(FEET)	50	±55.13
SIDE	(FEET)	30	±35.17
REAR	(FEET)	50	±402.19
ACCESSORY BUILDING SIDE YARD SETBACK	(FEET)	10	15
MAXIMUM BUILDING HEIGHT	(FEET)	30	<30
MAXIMUM BUILDING COVERAGE	(PERCENT)	8	3.92
MINIMUM DWELLING UNIT SIZE (§355-70)	(S.F.)	1,400	2,786
MINIMUM DRIVEWAY PIER/GATE SETBACK FROM RIGH	T-OF-WAY (FEET)	20	±0.65 (1)
MAXIMUM DRIVEWAY CURB CUT	(FEET)	18	±24.6 (1)
MAXIMUM DRIVEWAY PIER HEIGHT	(FEET)	8	9 (1)

(1) WILL REQUIRE A VARIANCE.

GENERAL CONSTRUCTION NOTES APPLY TO ALL WORK HEREIN

1. PRIOR TO CONSTRUCTION, THE CONTRACTOR SHALL CALL 811 "DIG SAFELY" (1-800-962-7962) TO HAVE UNDERGROUND UTILITIES LOCATED. EXPLORATORY EXCAVATIONS SHALL COMPLY WITH CODE 753 REQUIREMENTS. NO WORK SHALL COMMENCE UNTIL ALL THE OPERATORS HAVE NOTIFIED THE CONTRACTOR THAT THEIR UTILITIES HAVE BEEN LOCATED. THE CONTRACTOR SHALL BE RESPONSIBLE FOR THE PRESERVATION OF ALL PUBLIC AND PRIVATE UNDERGROUND AND SURFACE UTILITIES AND STRUCTURES AT OR ADJACENT TO THE SITE OF CONSTRUCTION, INSOFAR AS THEY MAY BE ENDANGERED BY THE CONTRACTOR'S OPERATIONS. THIS SHALL HOLD TRUE WHETHER OR NOT THEY ARE SHOWN ON THE CONTRACT DRAWINGS. IF THEY ARE SHOWN ON THE DRAWINGS, THEIR LOCATIONS ARE NOT GUARANTEED EVEN THOUGH THE INFORMATION WAS OBTAINED FROM THE BEST AVAILABLE SOURCES, AND IN ANY EVENT, OTHER UTILITIES ON THESE PLANS MAY BE ENCOUNTERED IN THE FIELD. THE CONTRACTOR SHALL, AT HIS OWN EXPENSE, IMMEDIATELY REPAIR OR REPLACE ANY STRUCTURES OR UTILITIES THAT HE DAMAGES, AND SHALL CONSTANTLY PROCEED WITH CAUTION TO PREVENT UNDUE INTERRUPTION OF UTILITY SERVICE.

2. CONTRACTOR SHALL HAND DIG TEST PITS TO VERIFY THE LOCATION OF ALL EXISTING UNDERGROUND UTILITIES PRIOR TO THE START OF CONSTRUCTION. CONTRACTOR SHALL VERIFY EXISTING UTILITIES DEPTHS AND ADVISE OF ANY CONFLICTS WITH PROPOSED UTILITIES. IF CONFLICTS ARE PRESENT. THE OWNER'S FIELD REPRESENTATIVE, JMC, PLLC AND THE APPLICABLE MUNICIPALITY OR AGENCY SHALL BE NOTIFIED IN WRITING. THE EXISTING/PROPOSED UTILITIES RELOCATION SHALL BE DESIGNED BY JMC, PLLC.

3. CONTRACTOR IS RESPONSIBLE FOR OBTAINING ANY AND ALL LOCAL PERMITS REQUIRED.

4. ALL WORK SHALL BE DONE IN STRICT COMPLIANCE WITH ALL APPLICABLE NATIONAL, STATE, AND LOCAL CODES, STANDARDS, ORDINANCES, RULES, AND REGULATIONS. ALL CONSTRUCTION WORK SHALL BE PERFORMED IN ACCORDANCE WITH ALL SAFETY CODES. APPLICABLE SAFETY CODES MEAN THE LATEST EDITION INCLUDING ANY AND ALL AMENDMENTS, REVISIONS, AND ADDITIONS THERETO, TO THE FEDERAL DEPARTMENT OF LABOR, OCCUPATIONAL SAFETY AND HEALTH ADMINISTRATION'S OCCUPATIONAL SAFETY AND HEALTH STANDARDS (OSHA); AND APPLICABLE SAFETY, HEALTH REGULATIONS AND BUILDING CODES FOR CONSTRUCTION IN THE STATE OF NEW YORK. THE CONTRACTOR SHALL BE RESPONSIBLE FOR GUARDING AND PROTECTING ALL OPEN EXCAVATIONS IN ACCORDANCE WITH THE PROVISION OF SECTION 107-05 (SAFETY AND HEALTH REQUIREMENTS) OF THE NYSDOT STANDARD SPECIFICATIONS. IF THE CONTRACTOR PERFORMS ANY HAZARDOUS CONSTRUCTION PRACTICES, ALL OPERATIONS IN THE AFFECTED AREA SHALL BE DISCONTINUED AND IMMEDIATE ACTION SHALL BE TAKEN TO CORRECT THE SITUATION TO THE SATISFACTION OF THE APPROVAL AUTHORITY HAVING JURISDICTION.

5. CONTRACTOR SHALL MAINTAIN ACCESS TO ALL PROPERTIES AFFECTED BY THE SCOPE OF WORK SHOWN HEREON AT ALL TIMES TO THE SATISFACTION OF THE OWNERS REPRESENTATIVE. RAMPING CONSTRUCTION TO PROVIDE ACCESS MAY BE CONSTRUCTED WITH SUBBASE MATERIAL EXCEPT THAT TEMPORARY ASPHALT CONCRETE SHALL BE PLACED AS DIRECTED BY THE ENGINEER. THE CONTRACTOR SHALL BE RESPONSIBLE FOR PROVIDING SAFE PEDESTRIAN ACCESS AT ALL TIMES.

6. CONTRACTOR SHALL MAINTAIN THE INTEGRITY OF EXISTING PAVEMENT TO REMAIN.



SUBSURFACE UTILITY LOCATIONS ARE BASED ON A COMPILATION OF FIELD EVIDENCE, AVAILABLE RECORD PLANS AND/OR UTILITY MARK-OUTS. THE LOCATION OR COMPLETENESS OF UNDERGROUND INFORMATION CANNOT BE GUARANTEED. VERIFY THE ACTUAL LOCATION OF ALL UTILITIES PRIOR TO EXCAVATION OR CONSTRUCTION.




APPROVED BY TOWN OF NORTH CASTLE PLANNING BOARD:


RESOLUTION, DATED:

CHRISTOPHER CARTHY, CHAIRMAN TOWN OF NORTH CASTLE PLANNING BOARD

ENGINEERING PLANS REVIEWED FOR CONFORMANCE TO RESOLUTION:

JOSEPH M. CERMELE, P.E.
KELLARD SESSIONS CONSULTING
CONSULTING TOWN ENGINEERS

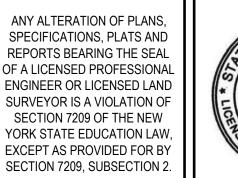

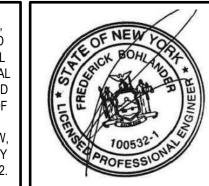

Revision	Date	Ву	
REVISED PER TOWN ENGINEER'S COMMENTS	07/12/2022	RB	
PLANNING BOARD SUBMISSION	01/09/2023	RB	
PLANNING BOARD SUBMISSION	09/11/2023	RB	
PLANNING BOARD SUBMISSION	10/23/2023	RB	
PLANNING BOARD SUBMISSION	02/22/2024	RB	
PLANNING BOARD SUBMISSION	03/25/2024	RB	

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John Meyer Consulting, Inc.


John Meyer Consulting, Inc.


120 BEDFORD ROAD • ARMONK, NY 10504

voice 914.273.5225 • fax 914.273.2102

www.jmcpllc.com



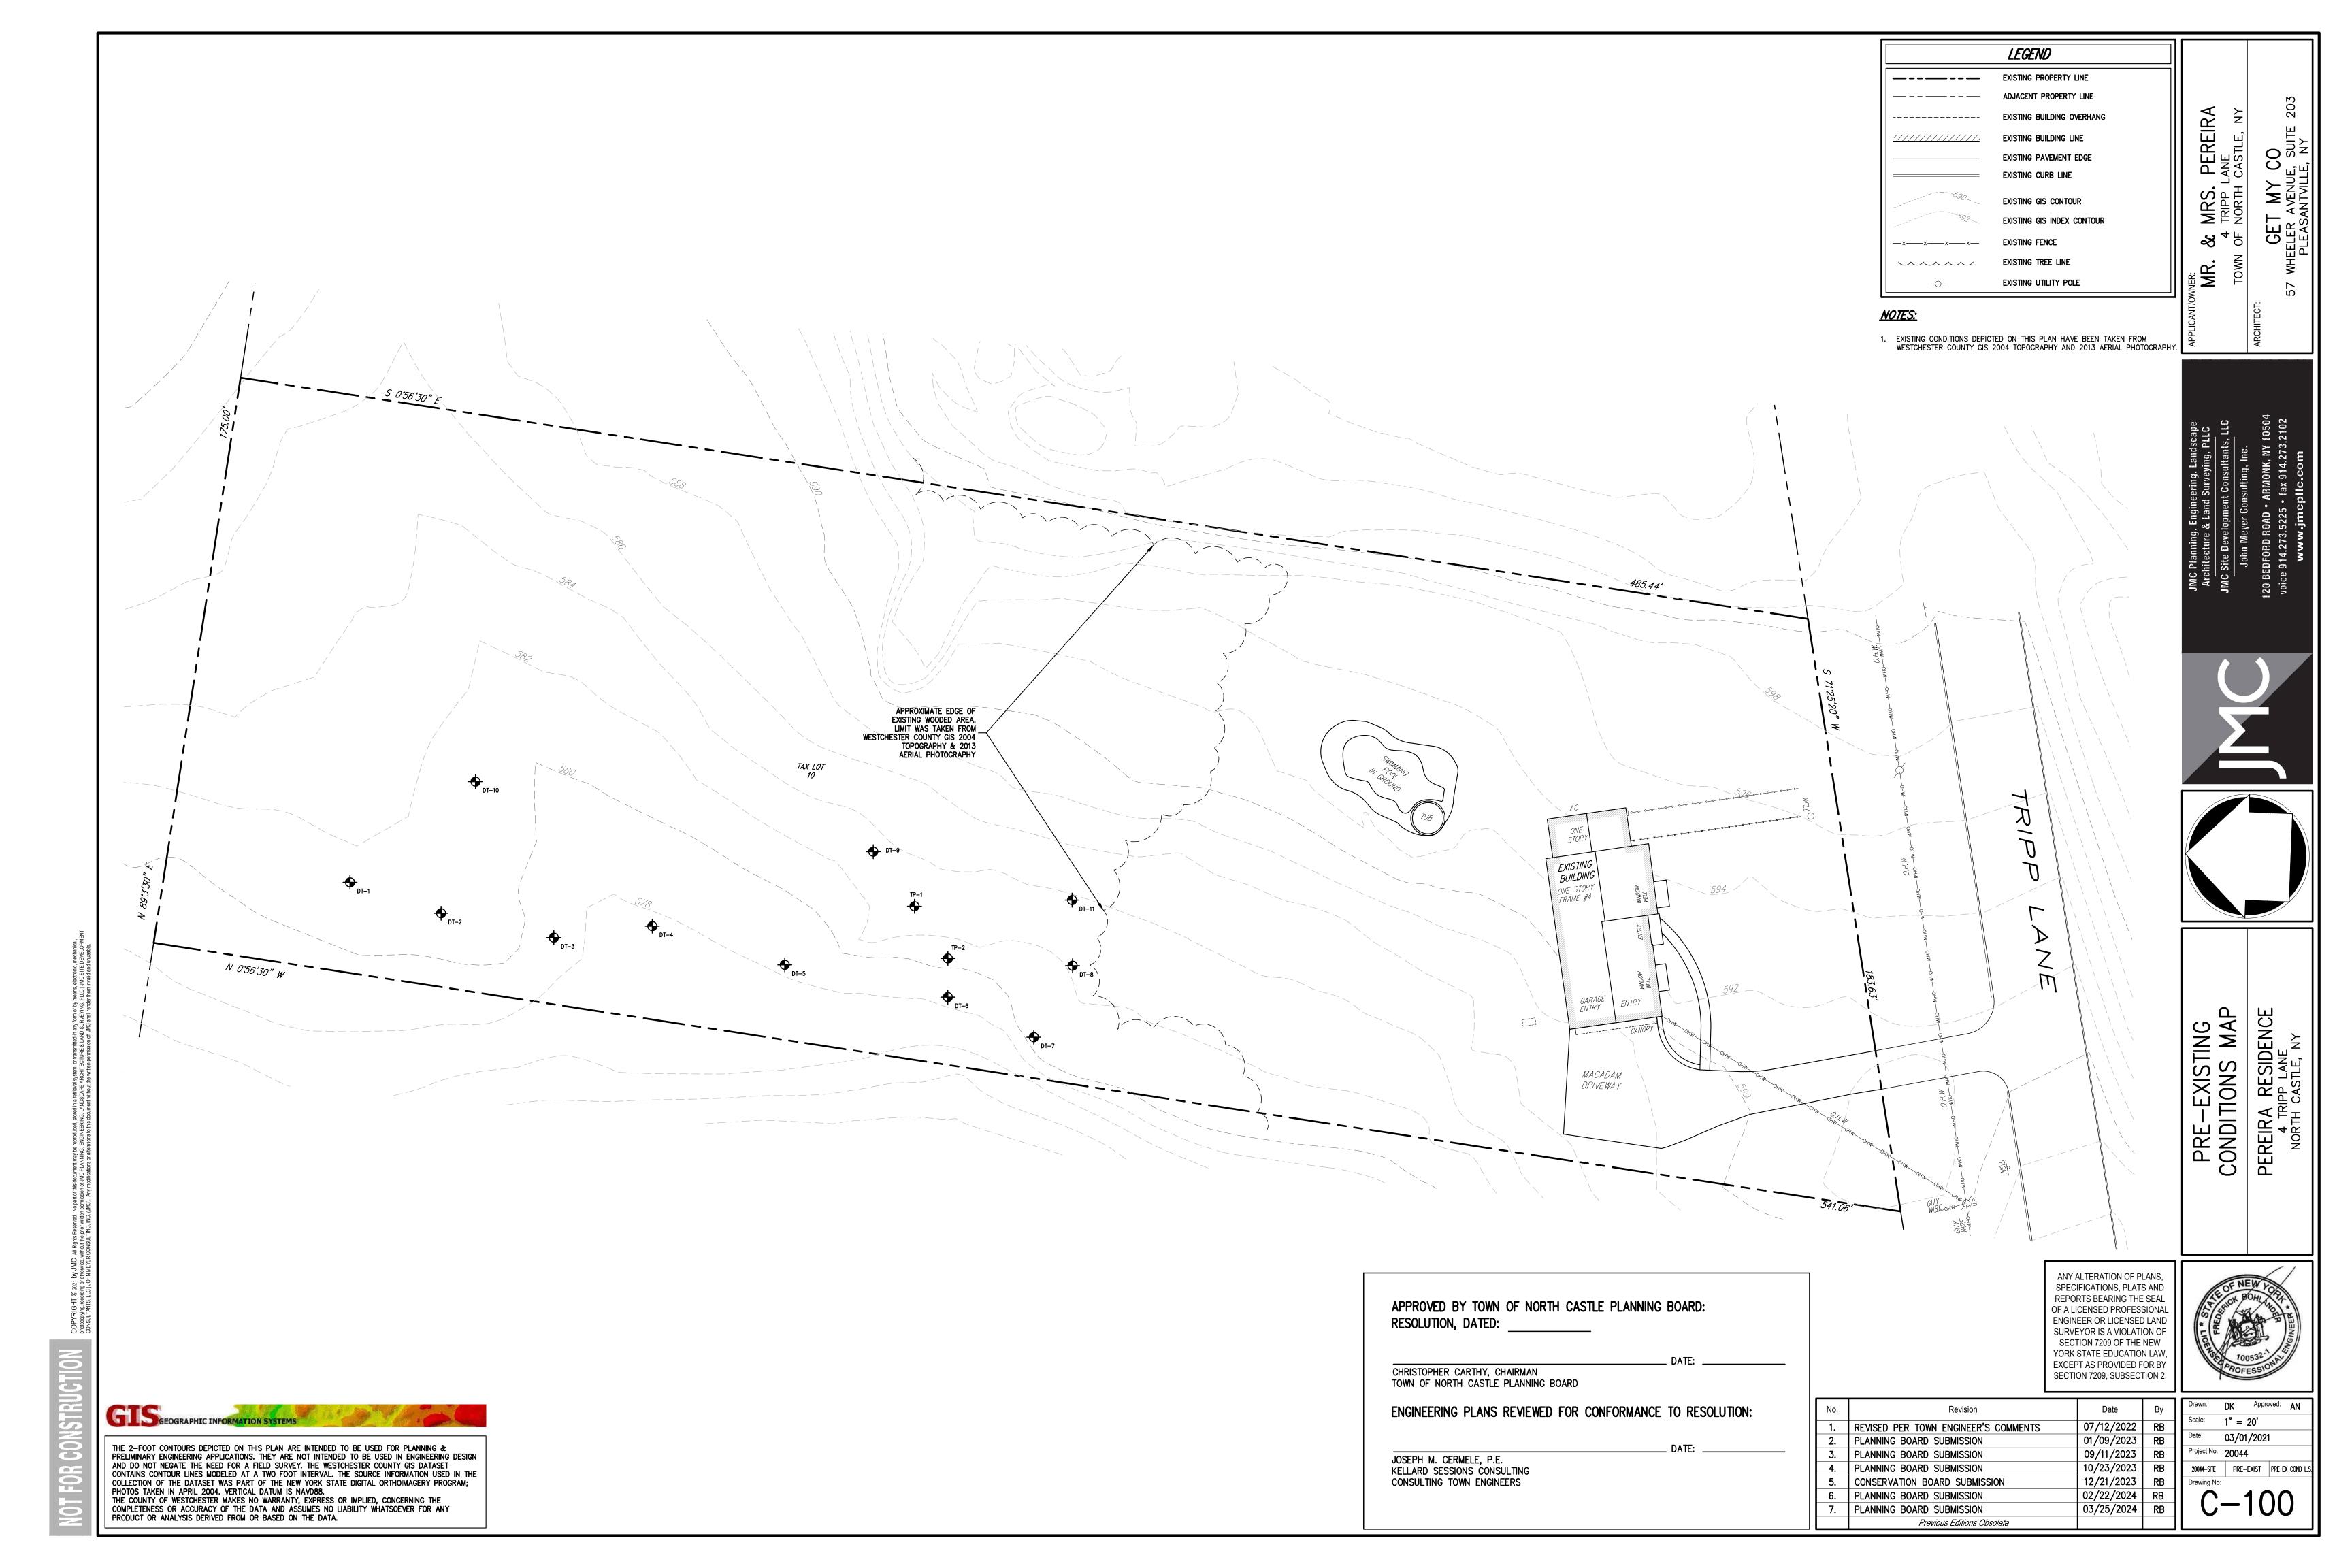

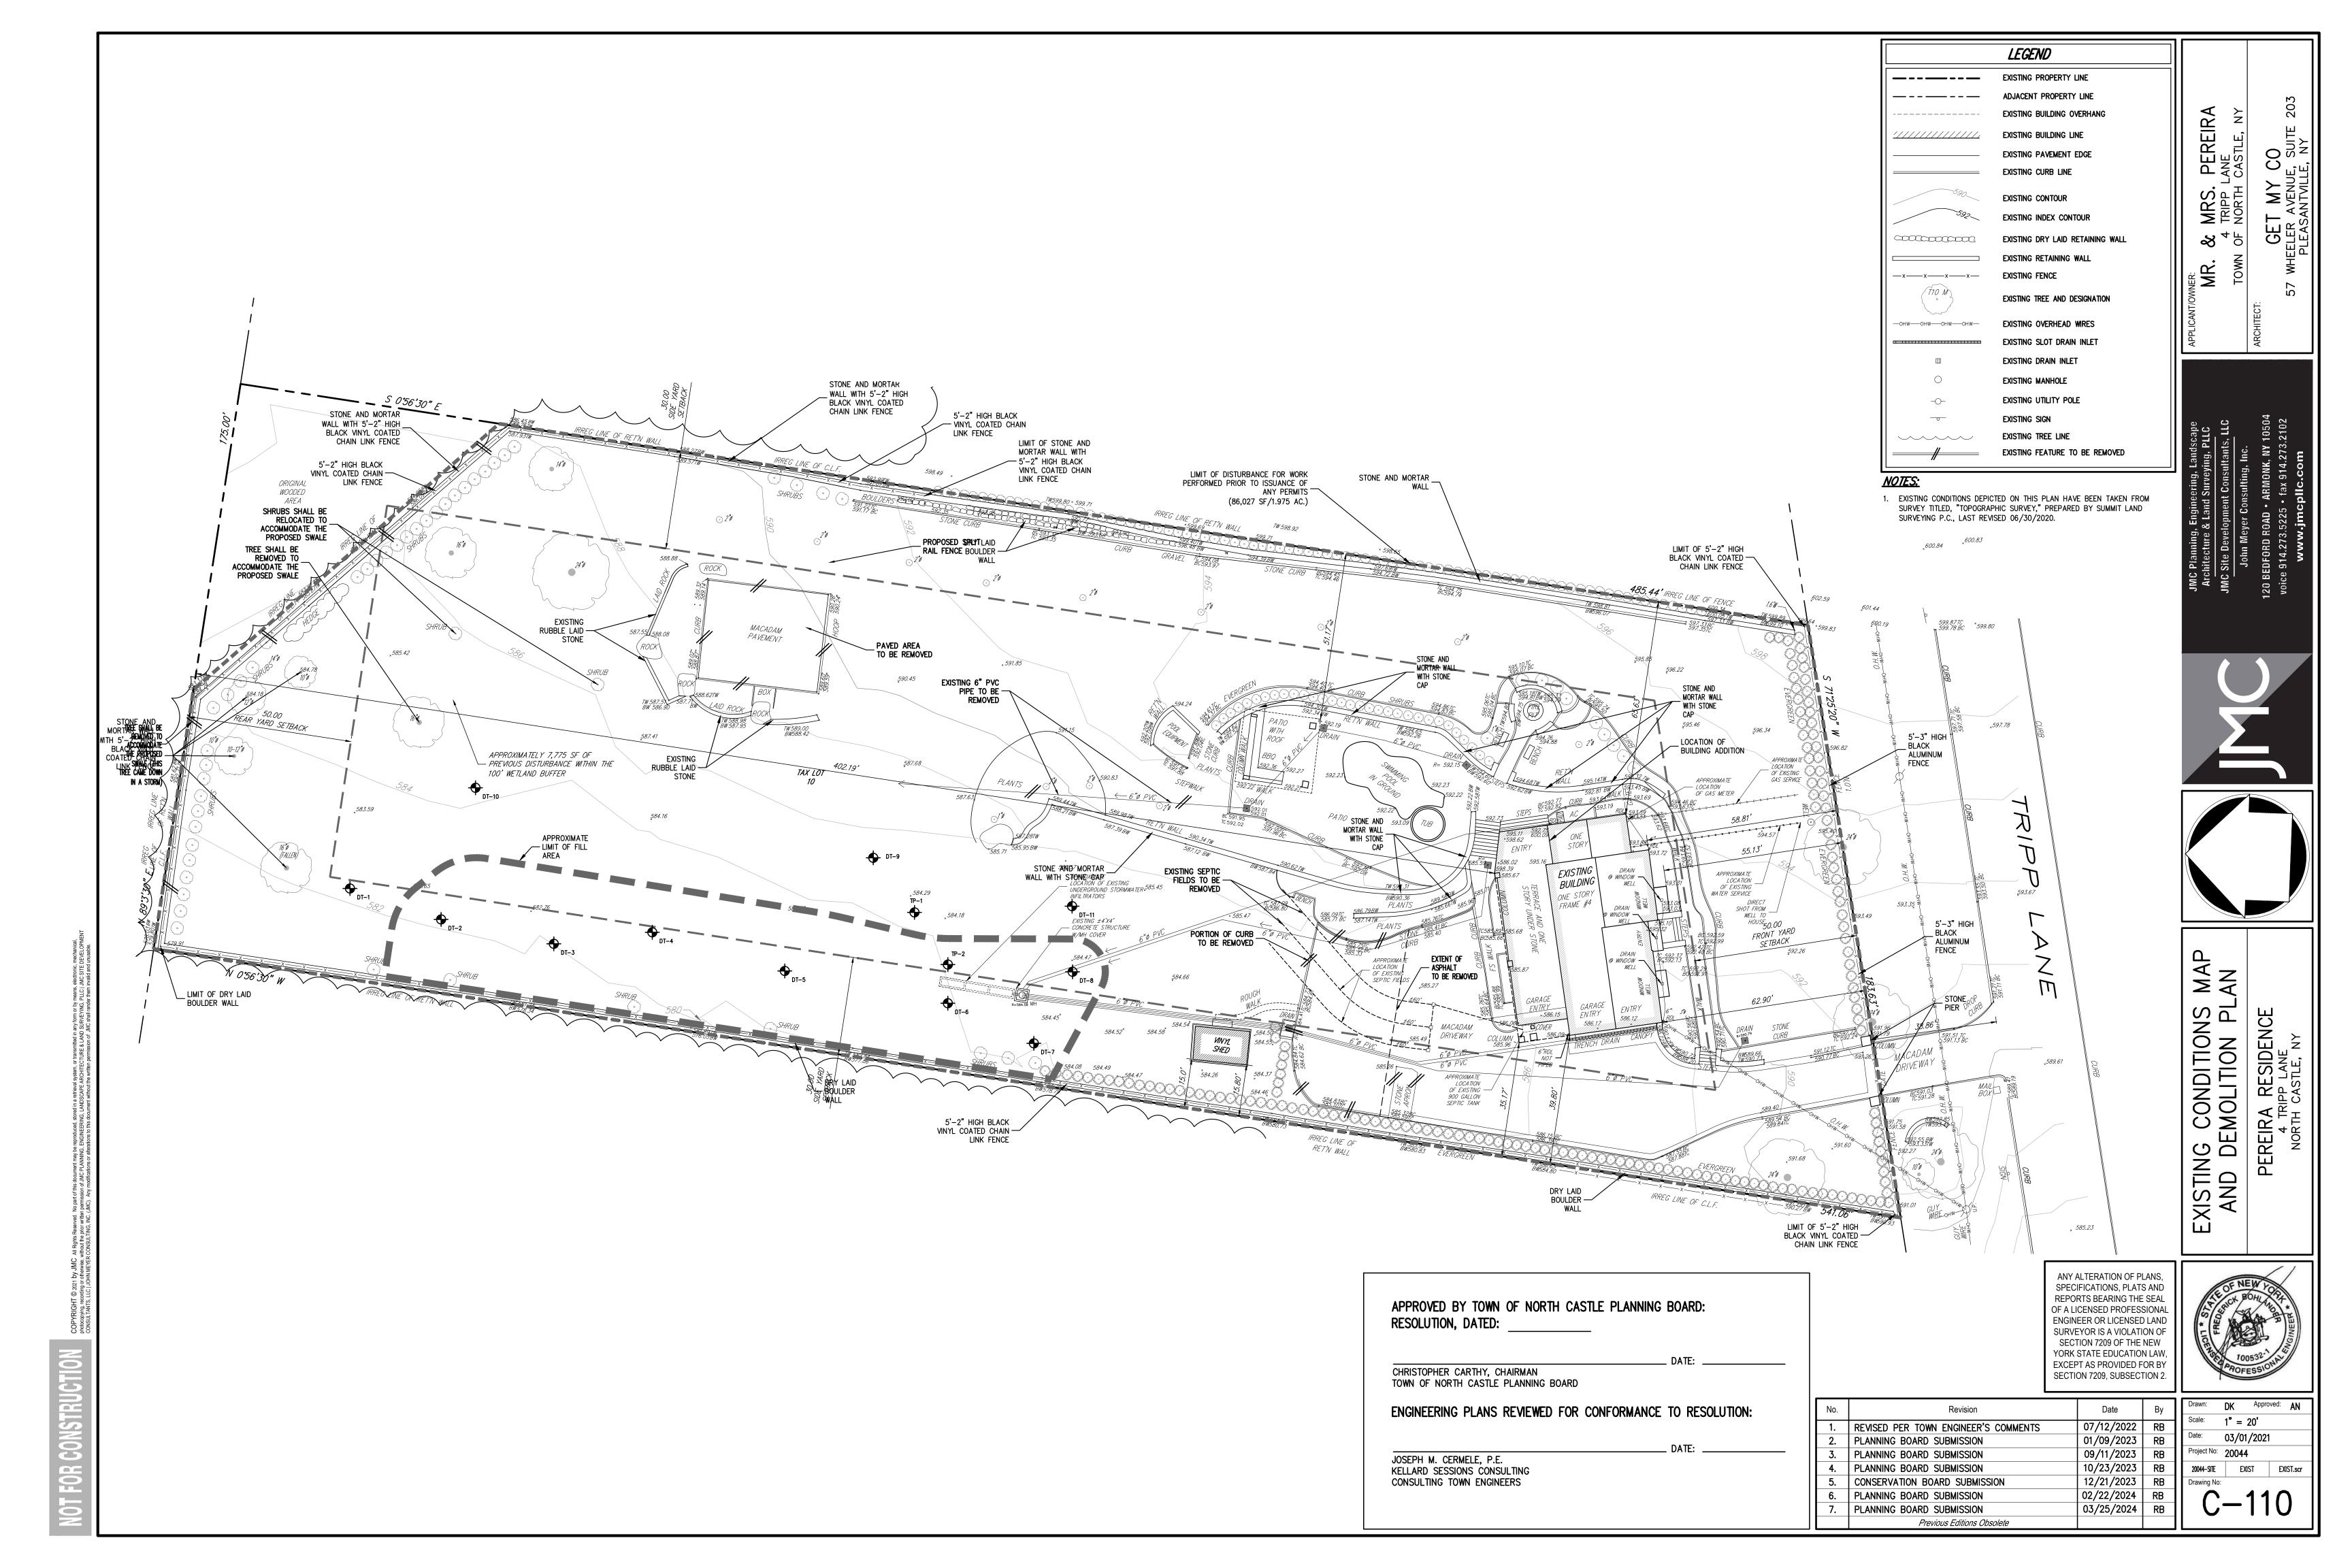

ERNST
SEEDS

Ernst Conservation Seeds 8884 Mercer Pike Meadville, PA 16335 (800) 873-3321 Fax (814) 336-5191

www.ernstseed.com

Date: February 22, 2024

Native Upland Wildlife Forage & Cover Meadow Mix - ERNMX-123

	Botanical Name	Common Name	Price/Lb
34.50 %	Andropogon gerardii, 'Southlow'-MI Ecotype	Big Bluestem, 'Southlow'-MI Ecotype	10.81
27.00 %	Panicum virgatum, 'Shawnee'	Switchgrass, 'Shawnee'	12.10
21.00 %	Elymus virginicus, Madison-NY Ecotype	Virginia Wildrye, Madison-NY Ecotype	10.45
11.40 %	Sorghastrum nutans, PA Ecotype	Indiangrass, PA Ecotype	15.22
2.80 %	Rudbeckia hirta	Blackeyed Susan	31.20
1.30 %	Heliopsis helianthoides, PA Ecotype	Oxeye Sunflower, PA Ecotype	33.60
1.00 %	Chamaecrista fasciculata, PA Ecotype	Partridge Pea, PA Ecotype	12.00
0.50 %	Coreopsis tinctoria	Plains Coreopsis	26.40
0.30 %	Desmodium canadense, PA Ecotype	Showy Ticktrefoil, PA Ecotype	48.00
0.10 %	Asclepias syriaca, PA Ecotype	Common Milkweed, PA Ecotype	96.00
0.10 %	Monarda fistulosa, Fort Indiantown Gap-PA Ecotype	Wild Bergamot, Fort Indiantown Gap-PA Ecotype	96.00

Mix Price/Lb Bulk: Seeding Rate: 20 lbs/acre with 30 lbs/acre of a cover crop. For

a cover crop use either grain oats (1 Jan to 31

Jul) or grain rye (1 Aug to 31 Dec). Uplands & Meadows; Wildlife Habitat & Food Plots; Wildlife Habitat & Food Plots - Herbaceous Perennial

This perennial grass mix with re-seeding annual forbs creates attractive first-year color and perennial cover when planted in full sun

APPROVED BY TOWN OF NORTH CASTLE PLANNING BOARD: RESOLUTION, DATED: CHRISTOPHER CARTHY, CHAIRMAN TOWN OF NORTH CASTLE PLANNING BOARD ENGINEERING PLANS REVIEWED FOR CONFORMANCE TO RESOLUTION: JOSEPH M. CERMELE, P.E.

KELLARD SESSIONS CONSULTING

CONSULTING TOWN ENGINEERS

//_^_/

PROPOSED FLOWERING TREE 100' WETLAND BUFFER AREA LIMIT OF GRADING AREA TO RECREATE PRE-EXISTING SWALE

NOTES:

1. EXISTING CONDITIONS DEPICTED ON THIS PLAN HAVE BEEN TAKEN FROM WESTCHESTER COUNTY GIS 2004 TOPOGRAPHY AND WESTCHESTER COUNTY GIS TIME LAPSED AERIAL PHOTOGRAPHY FROM 2013.

LEGEND

EXISTING PROPERTY LINE

EXISTING BUILDING LINE

EXISTING CURB LINE

ADJACENT PROPERTY LINE

EXISTING PAVEMENT EDGE

EXISTING RETAINING WALL

EXISTING TREE AND DESIGNATION

UNDISTURBED WOODED AREA

SAMPLE AREA OF TREES

PRE-EXISTING TREE LINE

CURRENT TREE LINE

EXISTING CONTOUR

EXISTING INDEX CONTOUR

PROPOSED SEEDED AREA

PROPOSED FINISHED GRADE

PROPOSED DECIDUOUS TREE

PREVIOUSLY DISTURBED WOODED AREA

EXISTING FENCE

EXISTING WETLAND

EXISTING DRY LAID RETAINING WALL

PEREIR/ ANE

MRS. TRIPP NORTH

AR.

TREE MITIGATION NOTES:

EXISTING TREES REMOVED:

- 1. REGULATED TREES ARE TREES THAT HAVE A DBH (DIAMETER AT BREAST HEIGHT) OF 8" OR GREATER.
- OBSERVATIONS, THE AREA THAT WAS CLEARED OF EXISTING TREES TOTAL
- ±1.15 ACRES (±50,094 SQ.FT.)
- AC. AREA, A SAMPLE AREA WITHIN THE ADJOINING EXISTING WOODED AREA TO THE WEST WAS UTILIZED (SEE LOCATION IDENTIFIED ON PLAN). THE AREA ANALYIZED IS 50 FEET WIDE BY 100 FEET LONG (5,000 SQ.FT.) BASED UPON FIELD MEASUREMENTS PERFORMED BY REPRESENTATIVES OF JMC PLLC. ON 04/02/2021. 17 TREES 8" DBH OR GREATER WERE NOTED WITHIN THE SAMPLE AREA. OUT OF THE 17 TREES, 4 TREES WERE 24" DBH OR GREATER.
- 4. ±1.15 ACRES X 43,560 SQ.FT.= ±50,094 SQ.FT. 17 REGULATED TREES WITHIN A 5,000 SQ.FT. AREA =1 REGULATED TREE PER 294 SQ.FT. OF AREA. THEREFORE, ±50,094 SQ.FT. / 294 SQ.FT. = 170.39,

PROPOSED TREES PLANTED:

- 3. BASED UPON THE TREES REMOVED CALCULATIONS ABOVE OF 171 TREES, A TOTAL OF 255 TREES WERE PLANTED IN THEIR PLACE. (FOR A TOTAL OF 692 INCHES)
- 4. A TOTAL OF 52 TREES ARE BEING PROPOSED AS SHOWN ON THIS PLAN. (29-3.5" DBH TREES = 101 INCHES)(23-1" DBH TREES = 23 INCHES) (FOR A TOTAL OF 124 INCHES)

ANY ALTERATION OF PLANS,
SPECIFICATIONS, PLATS AND
REPORTS BEARING THE SEAL
OF A LICENSED PROFESSIONAL
ENGINEER OR LICENSED LAND
SURVEYOR IS A VIOLATION OF
SECTION 7209 OF THE NEW
YORK STATE EDUCATION LAW,
EXCEPT AS PROVIDED FOR BY
SECTION 7209, SUBSECTION 2.

Devision	Data	D
Revision	Date	Ву
EVISED PER TOWN ENGINEER'S COMMENTS	07/12/2022	RB
LANNING BOARD SUBMISSION	01/09/2023	RB
LANNING BOARD SUBMISSION	09/11/2023	RB
LANNING BOARD SUBMISSION	10/23/2023	RB
ONSERVATION BOARD SUBMISSION	12/21/2023	RB
PDATED WETLANDS	02/12/2024	RB
	02/22/2024	
PLANNING ROARD SURMISSION	03/25/2024	RR


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A A D

RE L

03/01/2021			
ct No:	20044		
4-SITE	TREE	TREE.LS	
ring No:			
^ 17^			
U-13U			



2. BASED UPON RECORD GIS AERIAL PHOTOGRAPHY AND CURRENT FIELD

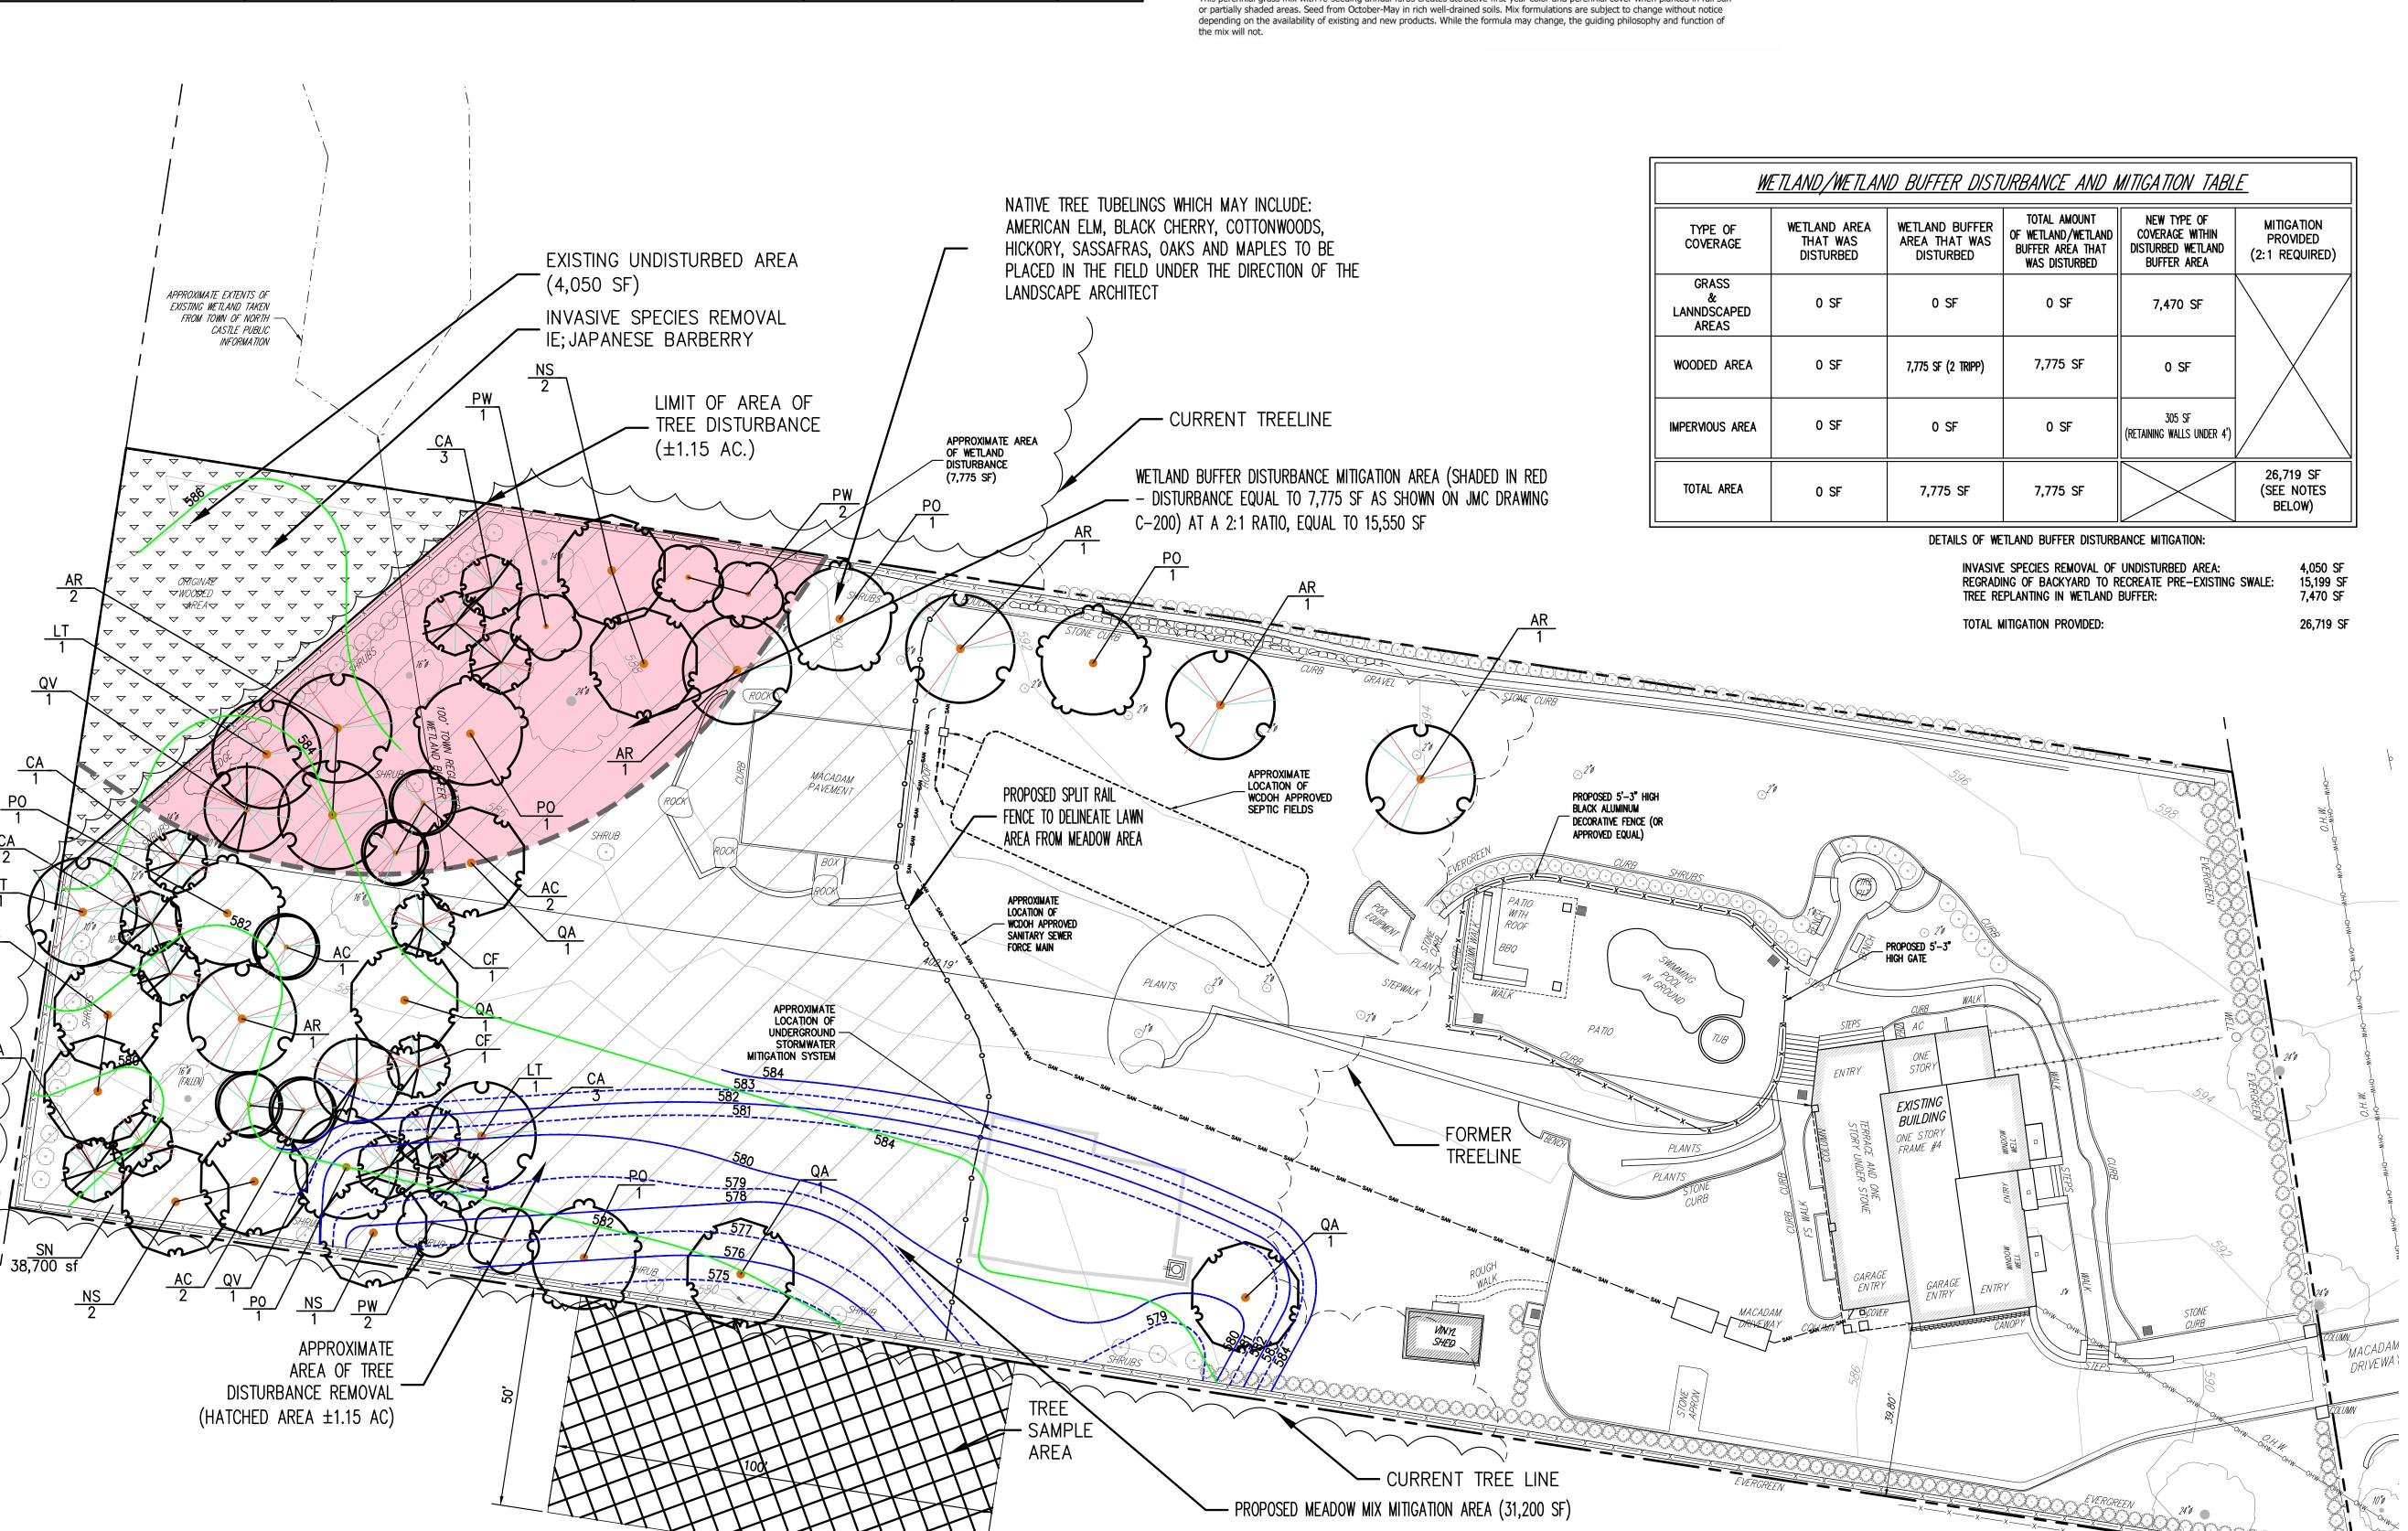
3. TO DETERMINE THE NUMBER OF TREES THAT WERE REMOVED WITHIN THE ± 1.15


SAY 171 REGULATED TREES WITHIN THE ±1.15 AC. DISTURBANCE AREA.


MITIGATION REQUIREMENTS


- 1. THE TOWN HAS REQUESTED THE APPLICANT MITIGATE THE REMOVAL OF TREES AT A 1:1 RATIO BASED ON THE CALIPER OF THE TRESS THAT WERE REMOVED AND THE CALIPER OF THE TREES TO BE PLANTED.
- 2. ESTIMATED CALIPER OF TREES THAT WERE REMOVED: 130 TREES @ 8" DBH & 41 TREES @ 24" DBH = 2,024 INCHES OF TREES THAT WERE REMOVED.


- 1. 8 EXISTING TREES WERE SAVED WITHIN THE ±1.15 AC. DISTURBANCE AREA. (8-18" DBH TREES = 144 INCHES)
- 2. 238 ARBORVITAES (GREEN GIANTS) WERE PLANTED ALONG THE EAST, WEST AND SOUTH PROPERTY LINES. AN ADDITIONAL 9 PLUM TREES WERE PLANTED ALONG THE WESTERN SIDE OF THE PROPERTY. (238-2" DBH TREES = 476 INCHES)(9-8" DBH TREES = 72 INCHES)

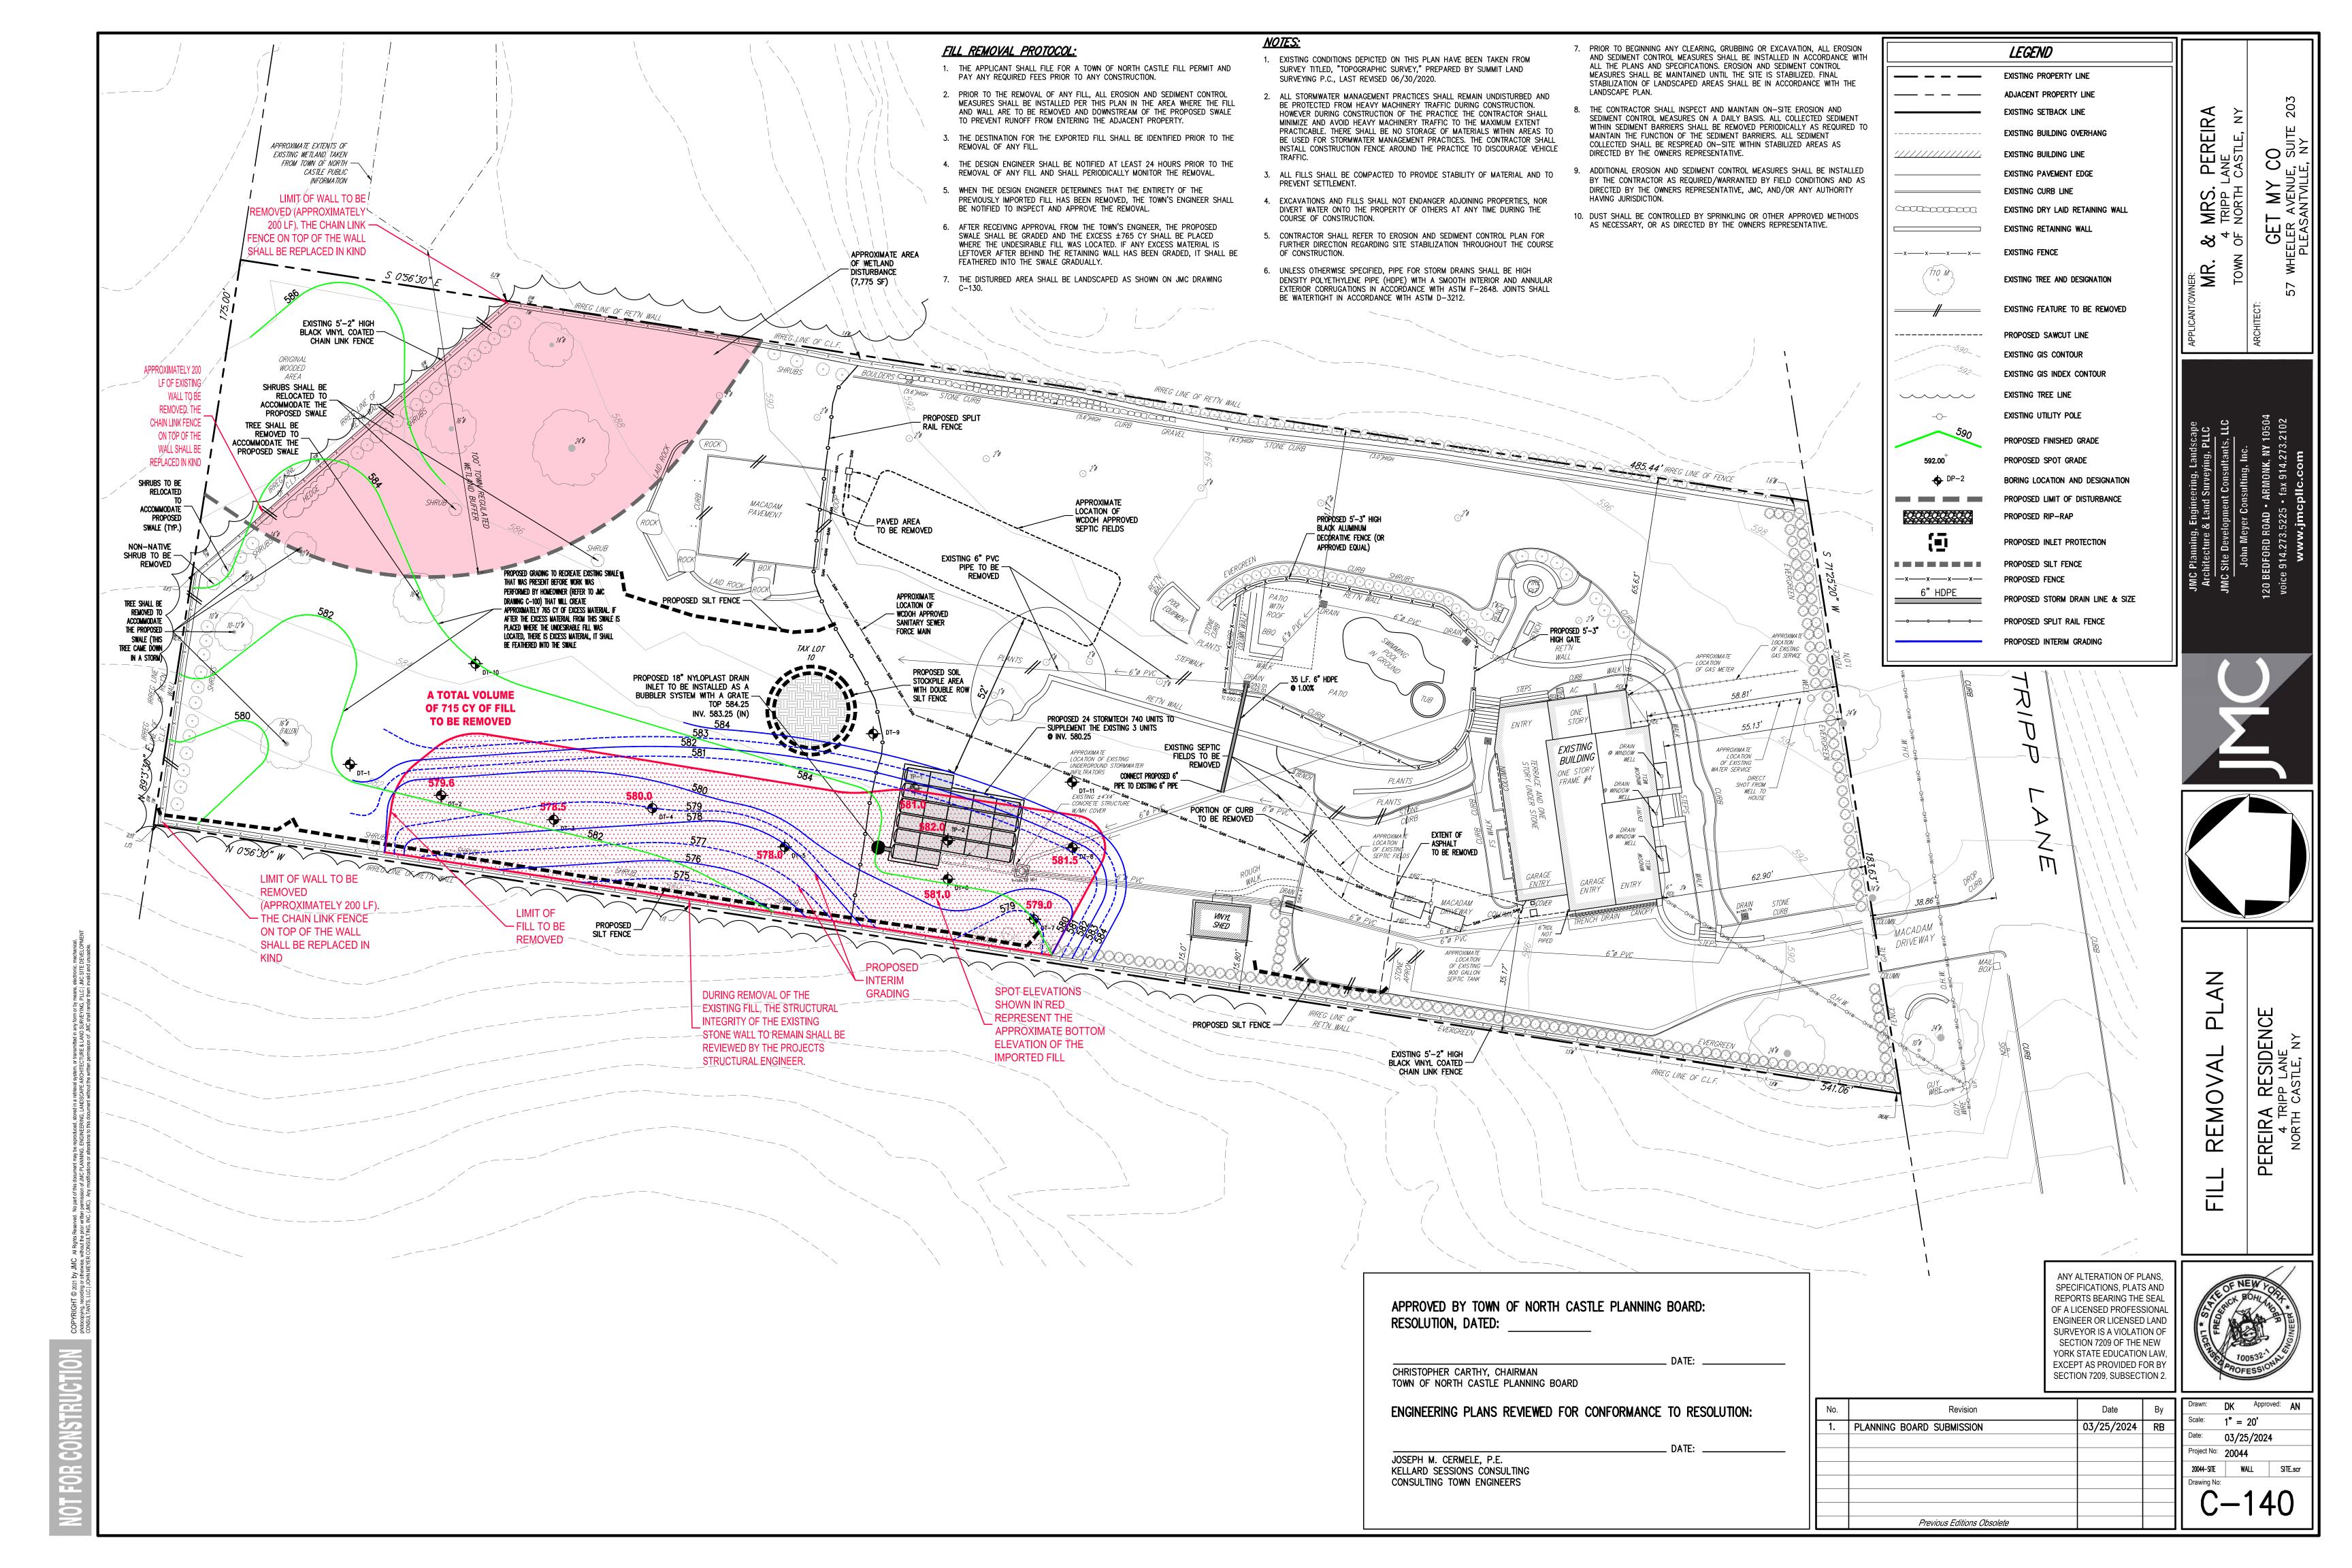

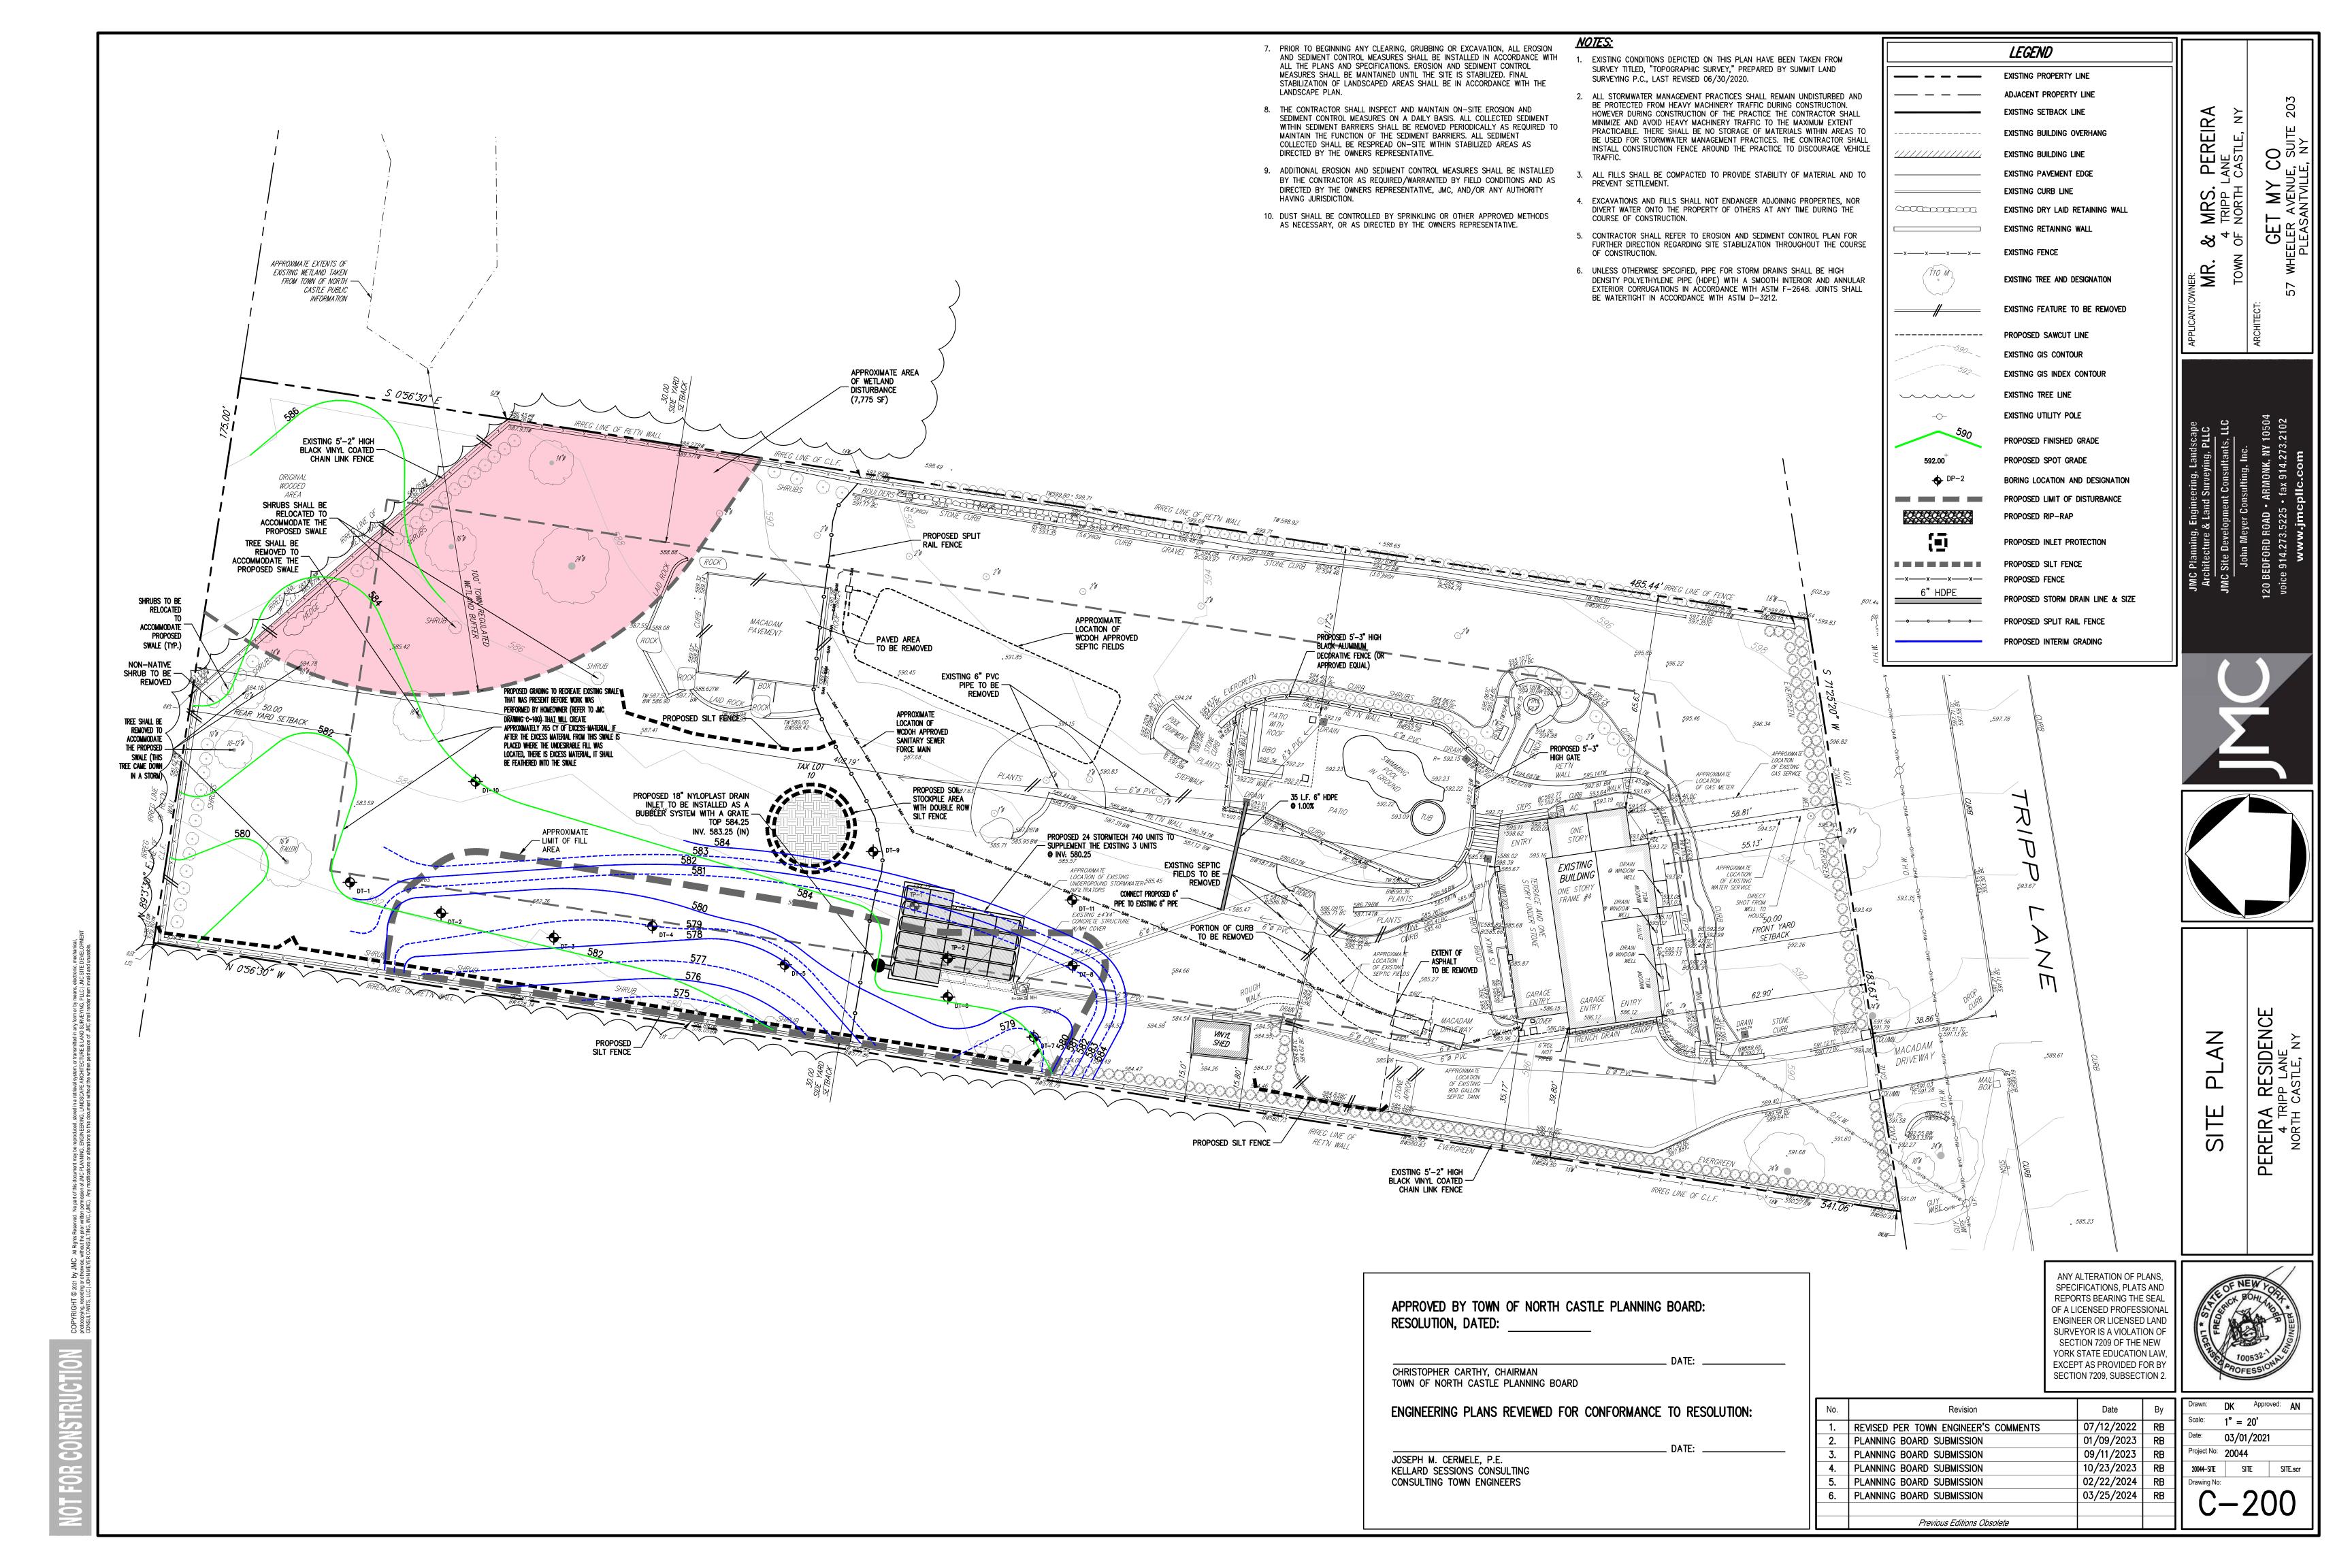

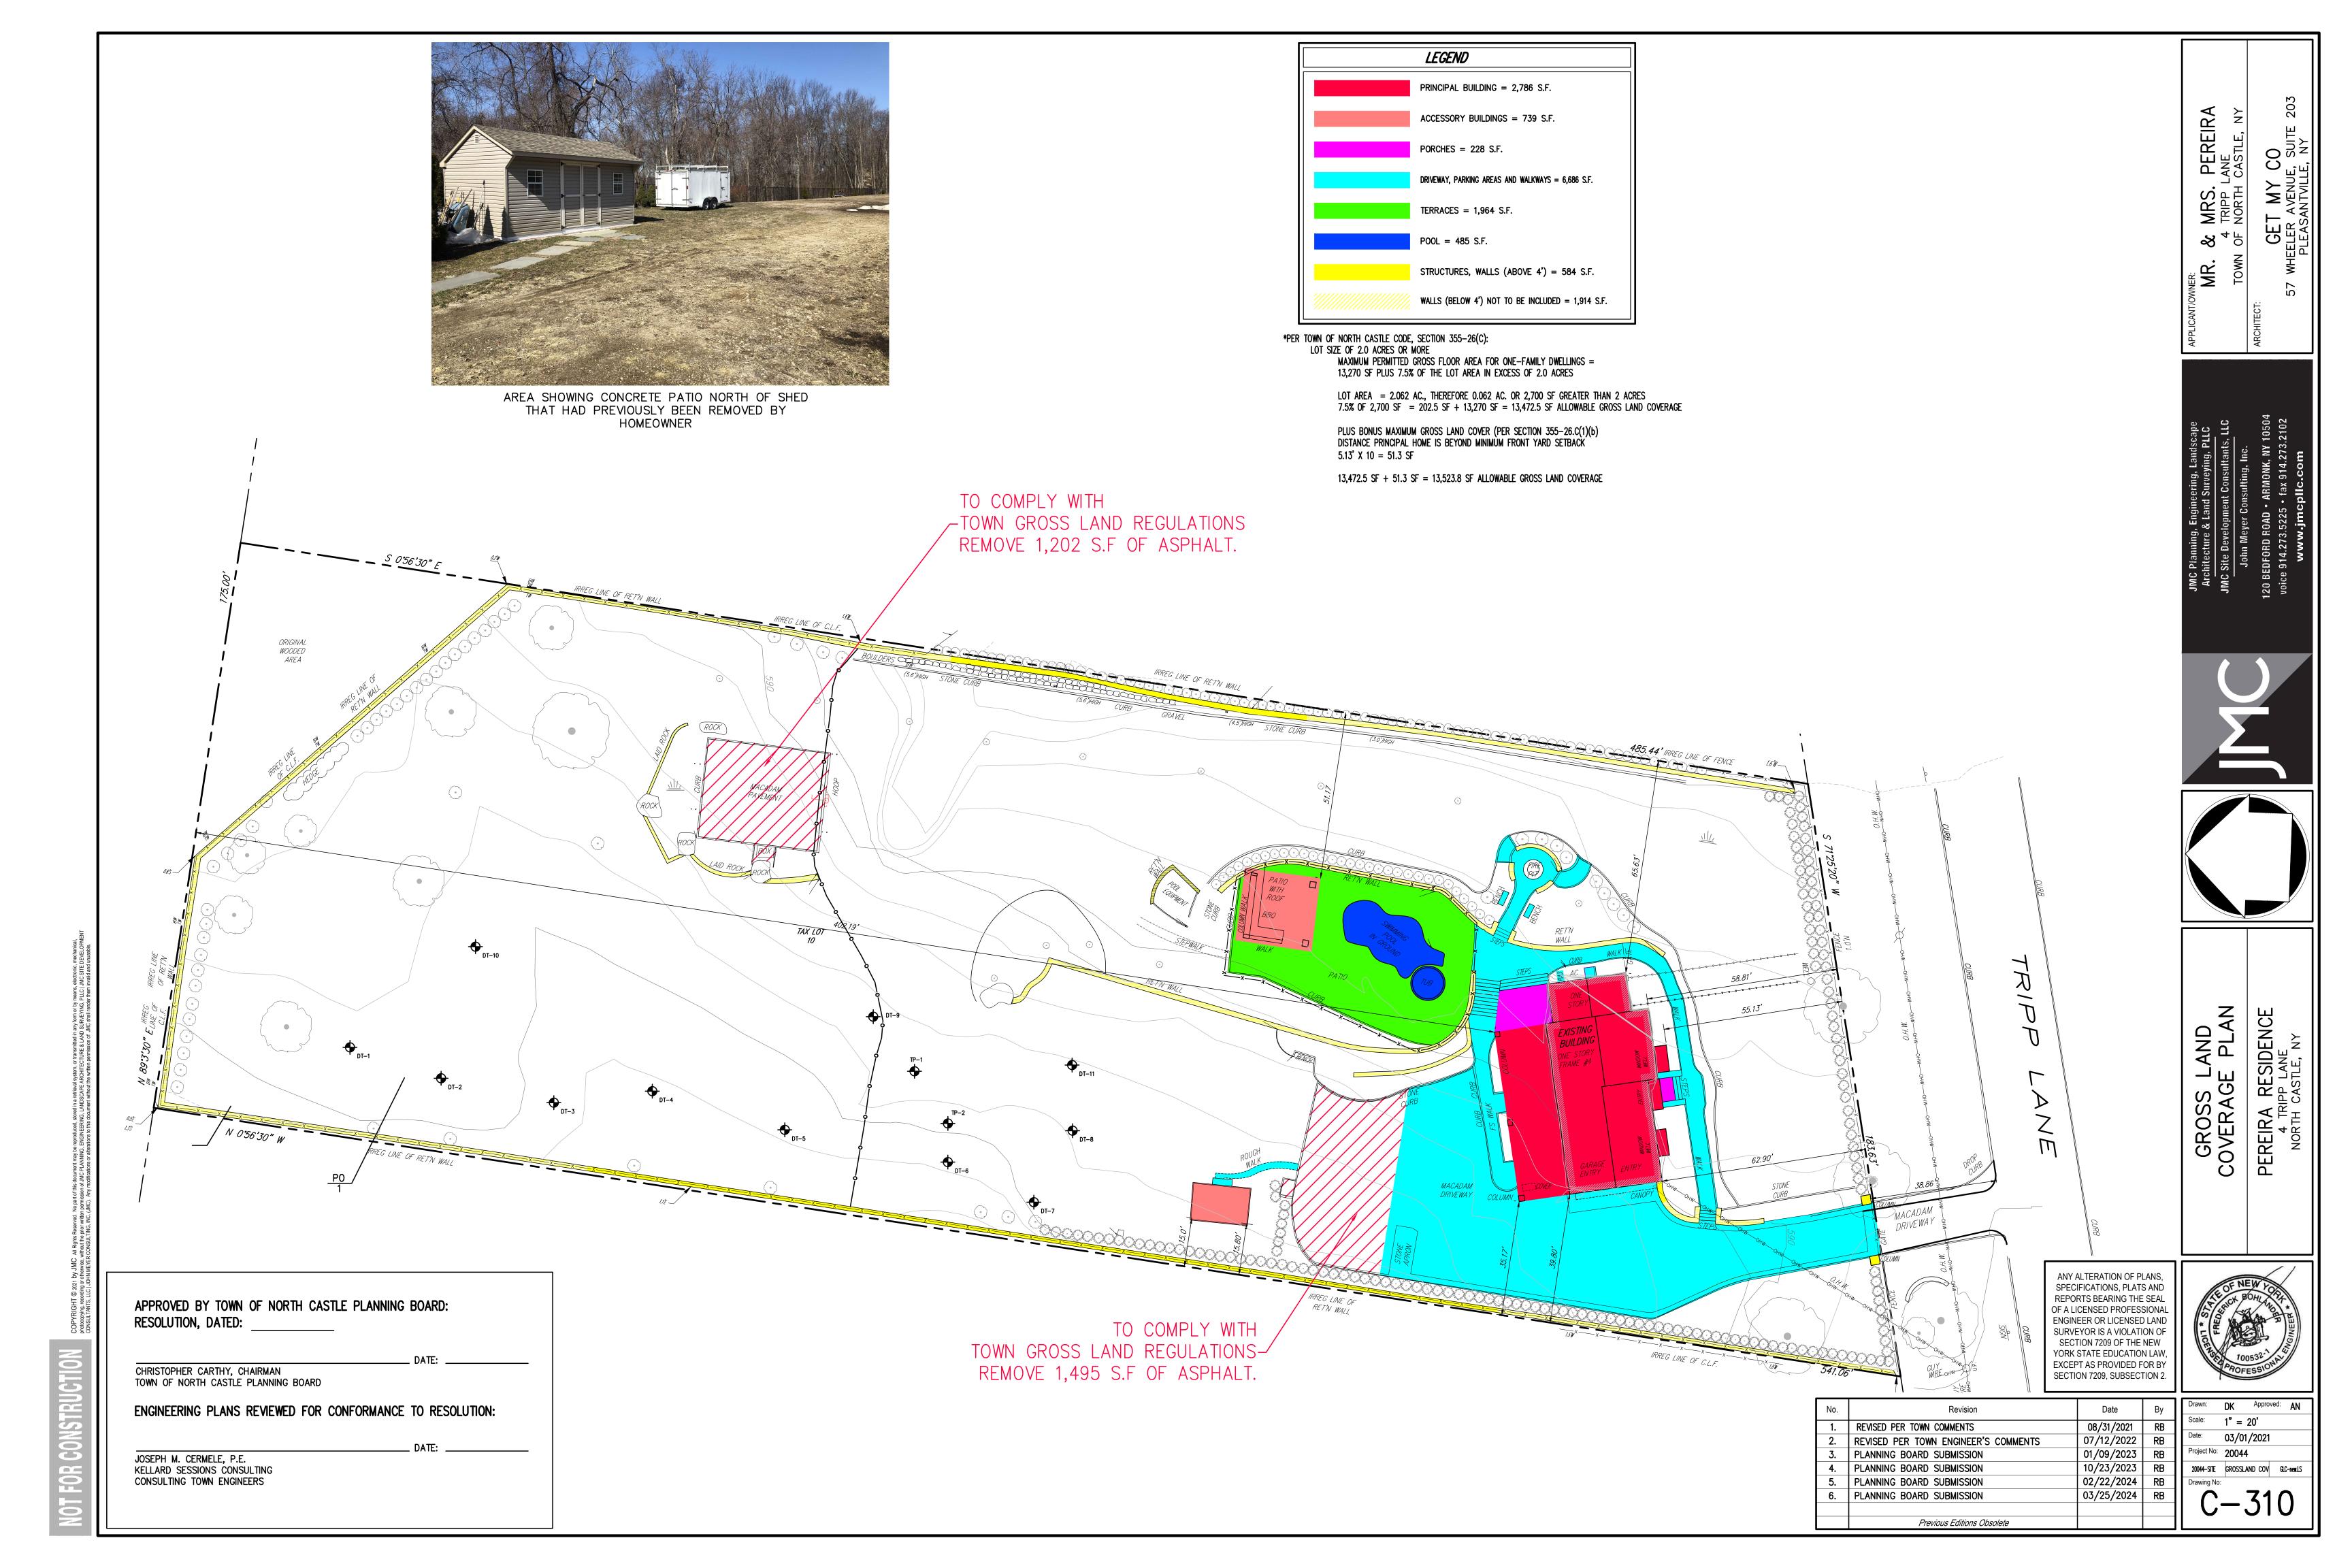

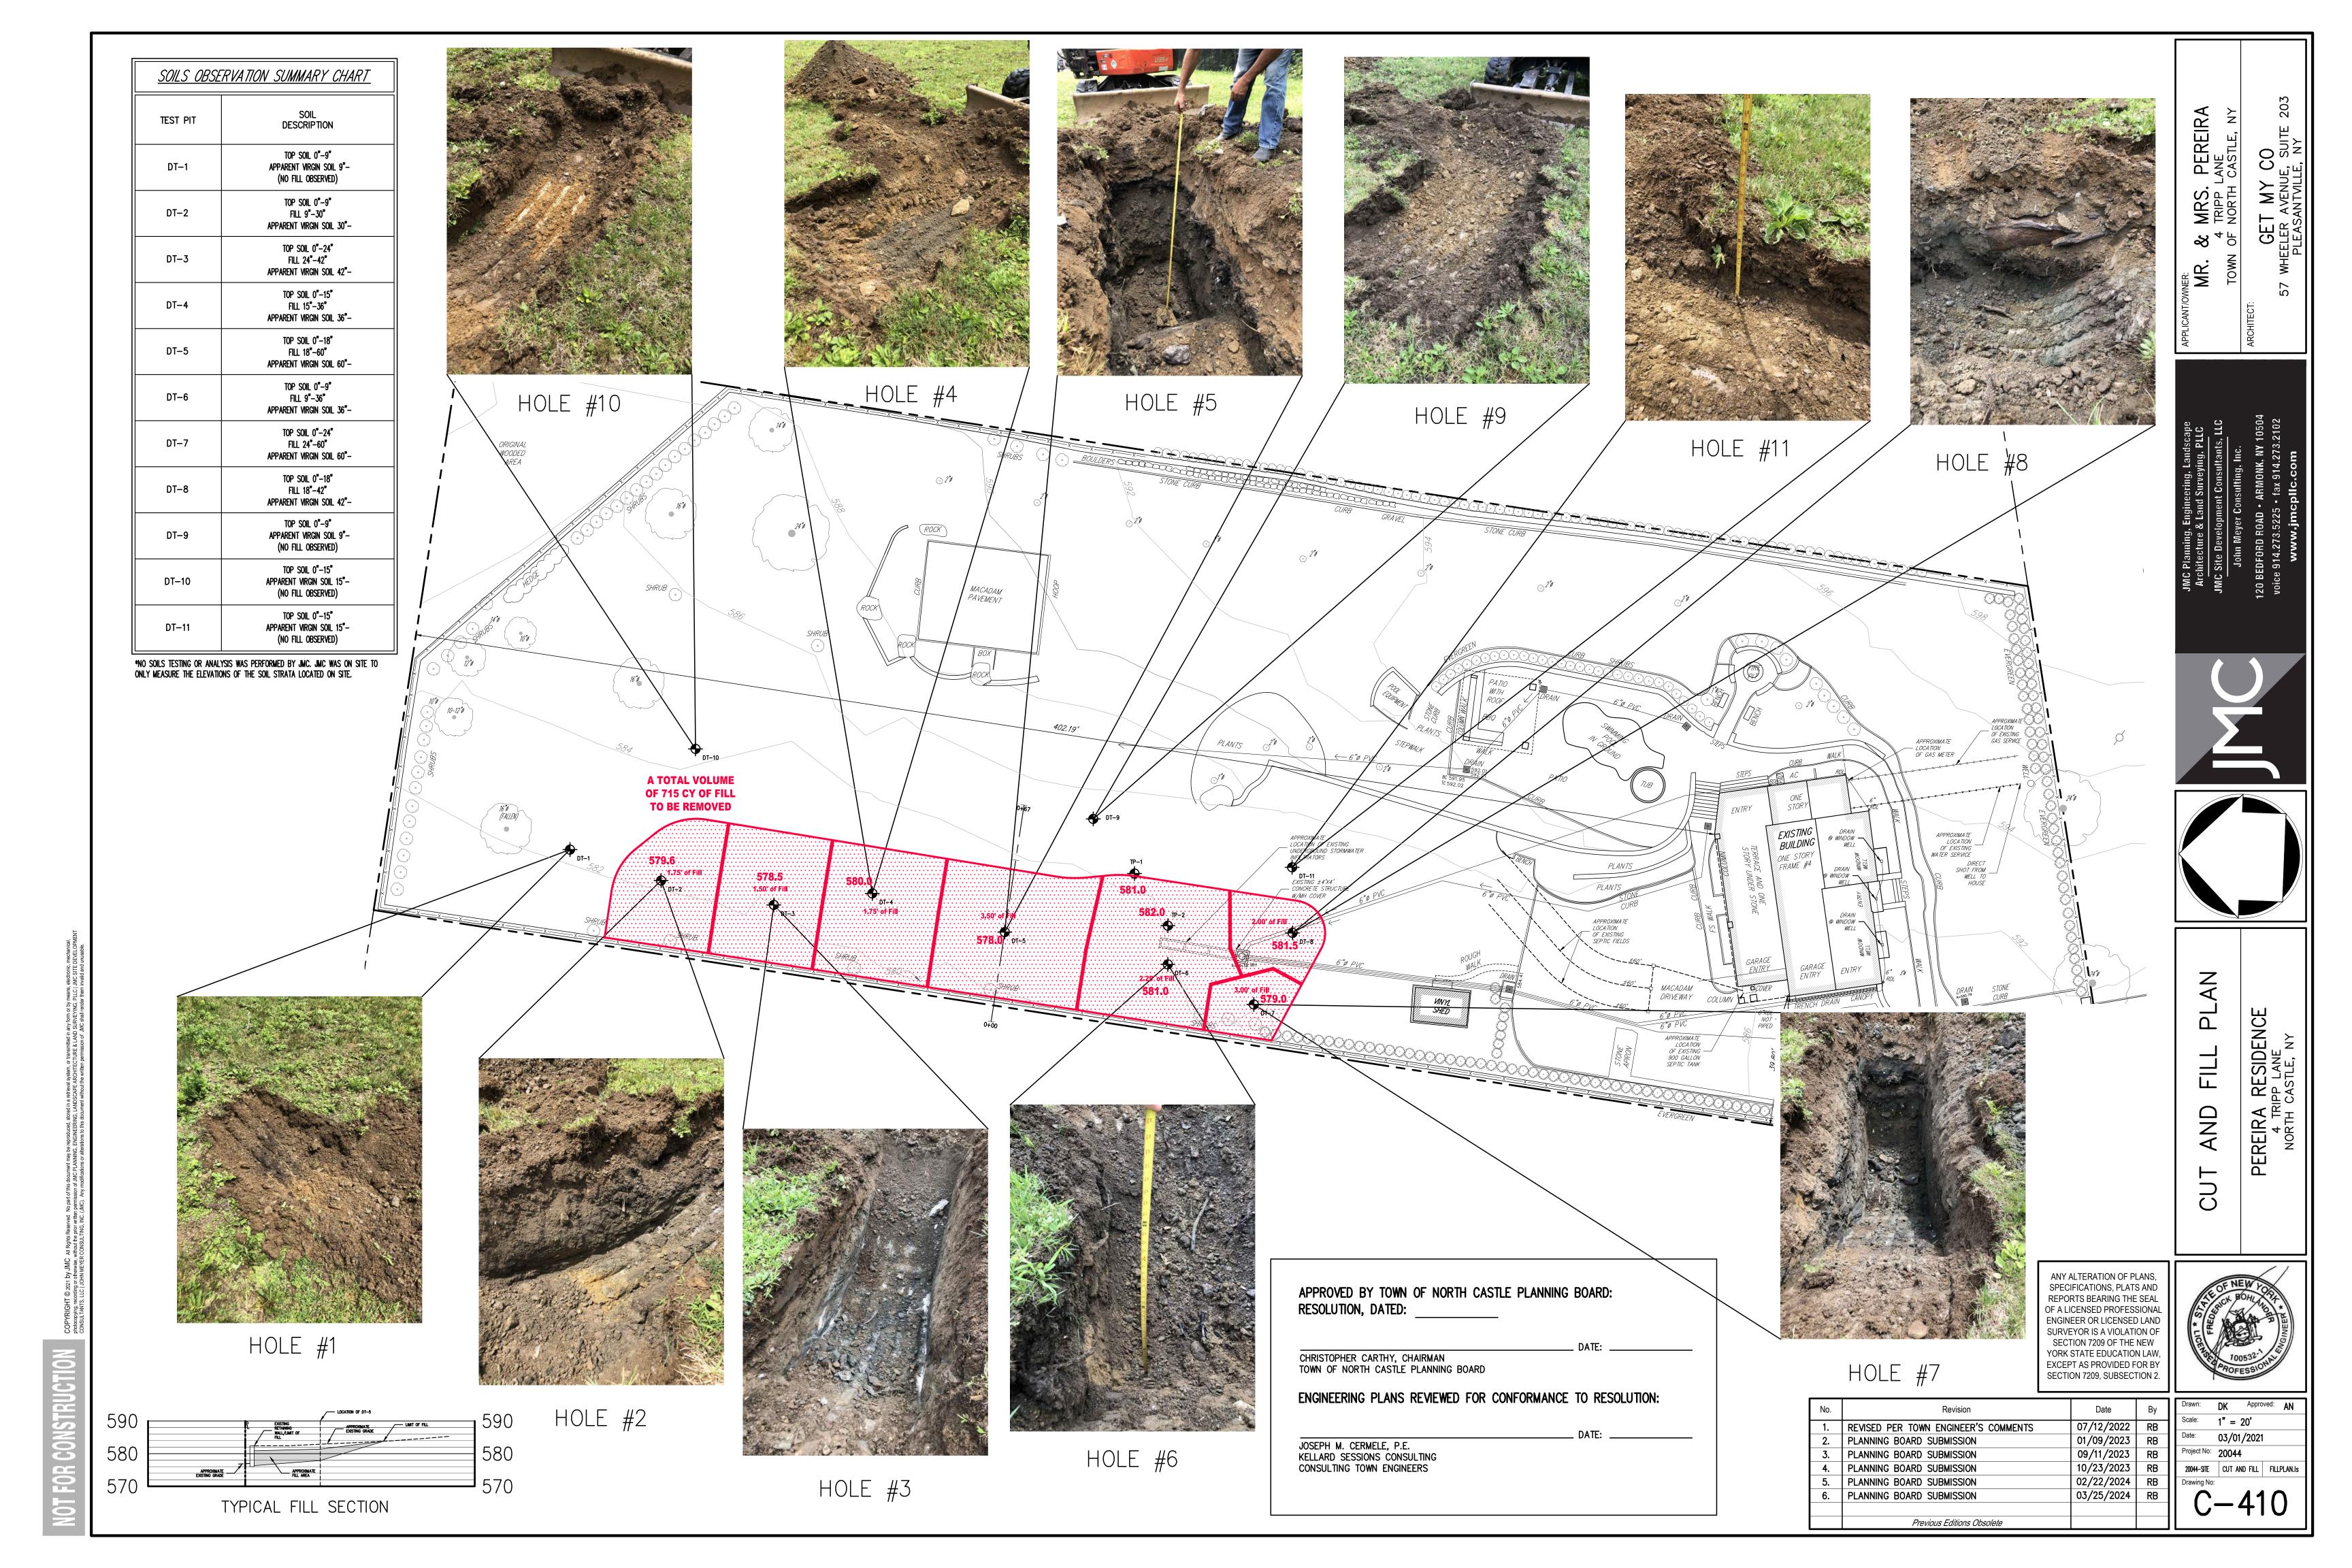

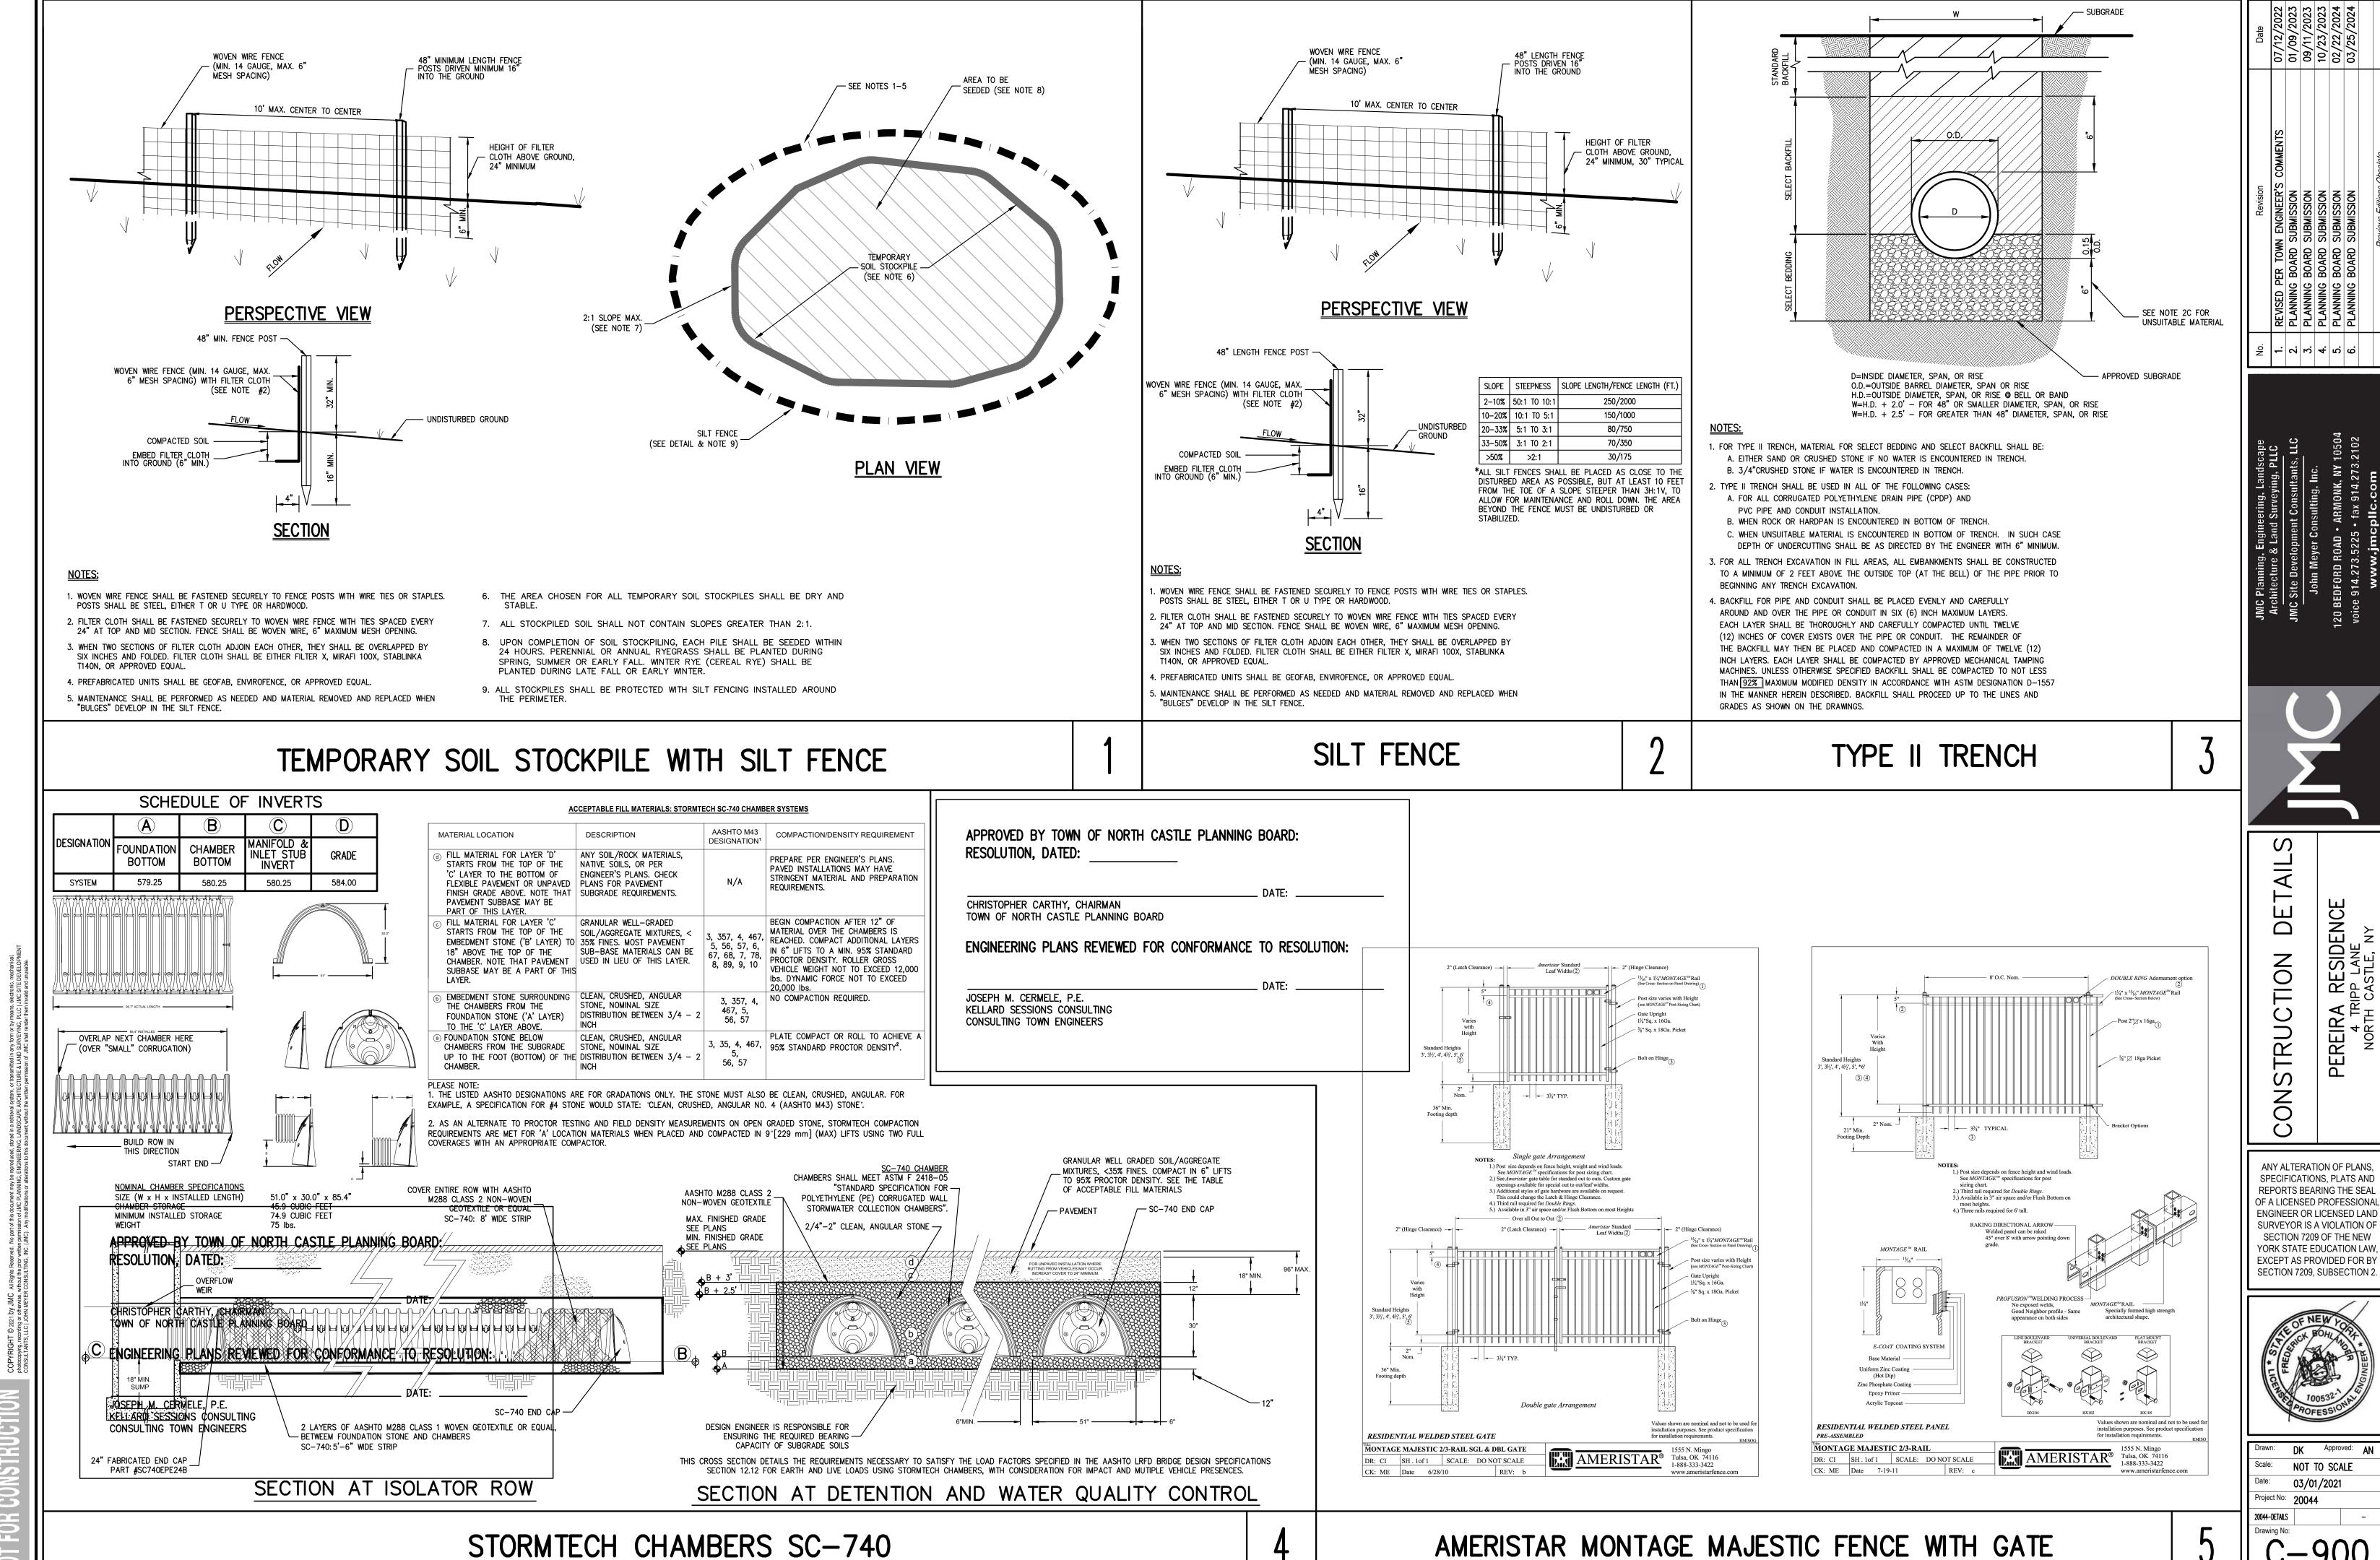

ANY ALTERATION OF PLANS SPECIFICATIONS, PLATS AND REPORTS BEARING THE SEAL OF A LICENSED PROFESSIONAL ENGINEER OR LICENSED LAND SURVEYOR IS A VIOLATION OF SECTION 7209 OF THE NEW YORK STATE EDUCATION LAW



DK Approved: AN NOT TO SCALE 03/01/2021 ²roject No: **20044**

20044-Details

A-3 FOR MASONRY STRUCTURES, THE FIRST COURSE OF MASONRY SHALL BE SET IN THE CONCRETE FOUNDATION BEFORE THE CONCRETE HAS SET. CONCRETE FOUNDATION SHALL BE CLASS "A"(4000 psi) CONCRETE, TWELVE (12) INCHES THICK AND SHALL EXTEND SIX (6) INCHES BEYOND THE OUTSIDE FACE THE STRUCTURE.

A-4 IT SHALL BE THE CONTRACTOR'S RESPONSIBILITY TO FURNISH AND CONSTRUCT THE PROPER SIZE STRUCTURE INCLUDING THE NECESSARY OPENINGS TO ACCOMMODATE THE WORK AS SHOWN ON THE PLANS OR ORDERED BY THE ENGINEER, AT NO ADDITIONAL COST TO THE OWNER.

A-5 ALL NECESSARY PATCHING FOR DRAIN STRUCTURES SHALL BE ACCOMPLISHED WITH NON-SHRINKING CEMENT MORTAR GROUT, APPROVED EQUAL TO SIKA-SET AS MANUFACTURED BY THE SIKA CHEMICAL

A-6 FOUNDATIONS FOR PRECAST CONCRETE STRUCTURES SHALL BE SET ON A COMPACTED LAYER OF APPROVED CRUSHED STONE HAVING A MINIMUM COMPACTED THICKNESS OF EIGHT (8) INCHES.

A-7 ALL PIPES SHALL BE CUT FLUSH WITH THE INSIDE WALL OF THE STRUCTURE.

A-8 PROVIDE REINFORCED CONCRETE TOP SLAB FOR OVERSIZED DRAIN INLETS WITH PROPER SIZE OPENING TO ACCOMMODATE INSTALLATION OF FRAME & GRATE.

A-9 FOR MASONRY STRUCTURES GREATER THAN TEN (10) FEET IN DEPTH, THICKNESS OF MASONRY WALLS SHALL BE INCREASED TO TWELVE (12) INCHES.

A-10 FOR ALL STRUCTURES GREATER THAN 10 FEET IN DEPTH, STRUCTURES SHALL PROVIDE MINIMUM INSIDE

NOTES PERTAINING TO MANHOLES

B-1 PRECAST CONCRETE MANHOLES SHALL COMPLY WITH ASTM STANDARD C-478. MANHOLE JOINTS SHALL COMPLY WITH ASTM STANDARD C-443.

B-2 FOR PRECAST CONCRETE MANHOLES FIVE (5) FEET OR LESS IN HEIGHT, TOP CONE SECTION SHALL BE REPLACED WITH PRECAST REINFORCED CONCRETE SLAB (6" MIN. THICKNESS) WITH OPENING OF SUFFICIENT SIZE TO ACCOMMODATE MANHOLE CASTING.

B-3 FOR MANHOLES 10 FEET OR MORE IN DEPTH, MANHOLE DIAMETER SHALL BE FIVE (5) FEET.

B-4 TERMINAL MANHOLE FLOORS SHALL BE SLOPED TOWARD OUTFALL PIPE.

B-5 INVERT CHANNELS FOR PRECAST CONCRETE MANHOLES SHALL BE CONSTRUCTED OF CONCRETE.

B-6 NOTES A-1, A-2, A-4, A-5, A-6 & A-7 UNDER "NOTES PERTAINING TO DRAIN INLETS" ABOVE SHALL

NOTES PERTAINING TO PRECAST CONCRETE STRUCTURES FOR STORM DRAINS, SANITARY SEWERS AND WATER LINES

C-1 ALL PRECAST CONCRETE STRUCTURES SHALL BE DESIGNED TO ACCOMMODATE AN H-20 DESIGN LOAD.

C-2 STEPS SHALL BE LOCATED WITHIN STRUCTURE TO AVOID PLACEMENT OVER PIPES WHEN PRACTICABLE

UTILITY NOTES

1) ALL WOOD FOR SPLIT RAIL FENCE TO BE PRESSURE TREATED.

FRONT VIEW

18" NYLOPLAST DRAINAGE STRUCTURE WITH GRATE

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THIS PRINT DISCLOSES SUBJECT MATTER IN WHICH | DRAWN BY EBC | MATERIAL

NYLOPLAST 18" DRAIN BASIN: 2818AG _ _ X

(5) ADAPTER

VARIABLE 0° - 380°

ACCORDING TO

18" MIN WIDTH GUIDELINE

- 8" MIN THICKNESS GUIDELINE

SOLID COVER

DWG SIZE A SCALE 1:30 SHEET 1 OF 1 DWG NO.

TRAFFIC LOADS: CONCRETE SLAB DIMENSIONS ARE FOR

GUIDELINE PURPOSES ONLY. ACTUAL CONCRETE SLAB MUST BE

DESIGNED TAKING INTO CONSIDERATION LOCAL SOIL CONDITIONS, TRAFFIC LOADING, & OTHER APPLICABLE DESIGN FACTORS.

SEE DRAWING NO. 7001-110-111 FOR NON TRAFFIC INSTALLATION.

(3) VARIABLE SUMP DEPTH ACCORDING TO PLANS

(6" MIN. BASED ON

MANUFACTURING REQ.)

THE BACKFILL MATERIAL SHALL BE CRUSHED STONE OR OTHER

GRANULAR MATERIAL MEETING THE REQUIREMENTS OF CLASS I,

BEDDING & BACKFILL FOR SURFACE DRAINAGE INLETS SHALL BE

GRATE OPTIONS | LOAD RATING | PART # | DRAWING # |

 DOME
 N/A
 1899CGD
 7001-110-215

 DROP IN GRATE
 LIGHT DUTY
 1801DI
 7001-110-074

PLACED & COMPACTED UNIFORMLY IN ACCORDANCE WITH ASTM D2321.

MEETS H-10 1899CGP 7001-110-212 MEETS H-20 1899CGS 7001-110-213

MEETS H-20 1899GGC 7001-110-214

18 IN DRAIN BASIN QUICK SPEC INSTALLATION DETAIL

BUFORD, GA 30518

PHN (770) 932-2443

FAX (770) 932-2490

CLASS II, OR CLASS III MATERIAL AS DEFINED IN ASTM D2321.

(1, 2) INTEGRATED DUCTILE IRON

(3) VARIABLE INVERT HEIGHTS

AVAILABLE (ACCORDING TO

PLANS/TAKE OFF)

(4) VARIOUS TYPES OF INLET & OUTLET ADAPTERS AVAILABLE:

ADS/HANCOR SINGLE WALL), N-12 HP, PVC SEWER (EX: SDR 35), PVC DWV (EX: SCH 40), PVC C900/C905, CORRUGATED & RIBBED PVC

WATERTIGHT JOINT

(CORRUGATED HDPE SHOWN)

4" - 18" FOR CORRUGATED HDPE (ADS N-12/HANCOR DUAL WALL,

GRATES/SOLID COVER SHALL BE DUCTILE IRON PER ASTM A536 GRADE 70-50-05

DRAIN BASIN TO BE CUSTOM MANUFACTURED ACCORDING TO PLAN DETAILS.

RISERS ARE NEEDED FOR BASINS OVER 84" DUE TO SHIPPING RESTRICTIONS.

- ADAPTERS CAN BE MOUNTED ON ANY ANGLE 0° TO 380°. TO DETERMINE MINIMUM

FRAMES SHALL BE DUCTILE IRON PER ASTM A536 GRADE 70-50-05.

DRAINAGE CONNECTION STUB JOINT TIGHTNESS SHALL CONFORM TO

ASTM 03212 FOR CORRUGATED HDPE (ADS N-12/HANCOR DUAL WALL),

ANGLE BETWEEN ADAPTERS SEE DRAWING NO. 7001-110-012.

SEE DRAWING NO. 7001-110-065

MINIMUM PIPE BURIAL DEPTH PER PIPE

MANUFACTURER

RECOMMENDATION


(MIN. MANUFACTURING

REQ. SAME AS MIN. SUMP)

FRAME & GRATE TO MATCH BASIN O.D.





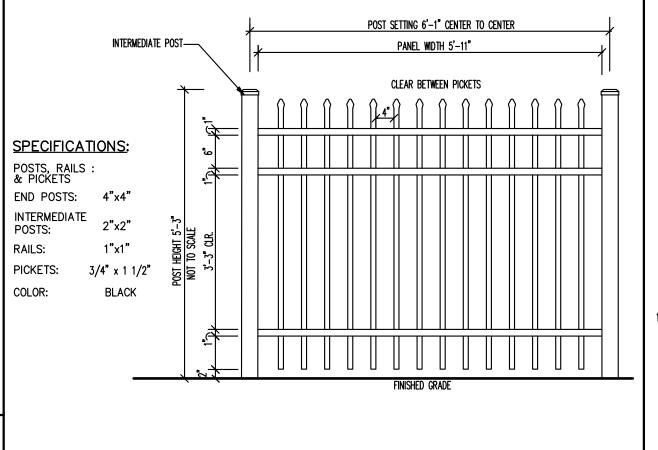



CHAIN LINK FENCE (GALVANIZED) - ALREADY INSTALLED AND WAS MEASURED IN THE FIELD

GALVANIZED HIGH CARBON STEEL

__FABRIC TO BE TWISTED AND BARBED

SPLIT RAIL FENCE

2'-10" X 3'-1" 6" HEIGHT (INCLUDES UPPER SECTION) 8'-0" W (ONE SIDE) 6'-9" HT. @ CENTER 5'-0" HT. @ CONNECTION TO PIER

> 2'-0" HT. TOTAL HEIGHT: 9'-0"

> > STONE AND MORTAR WALL

SHED

RESOLUTION, DATED: CHRISTOPHER CARTHY, CHAIRMAN TOWN OF NORTH CASTLE PLANNING BOARD ENGINEERING PLANS REVIEWED FOR CONFORMANCE TO RESOLUTION: JOSEPH M. CERMELE, P.E. KELLARD SESSIONS CONSULTING CONSULTING TOWN ENGINEERS

APPROVED BY TOWN OF NORTH CASTLE PLANNING BOARD:

DRIVEWAY WIDTH APPROVED COMPACTED — 2" TOP COURSE MATERIAL: ASPHALT CONCRETE, TYPE 6F MIX/ITEM: NYSDOT ITEM 403.1701 MATERIAL AND MIX/ITEM NUMBERS REFER TO: 6" BASE/SUBBASE COURSE MATERIAL: SUBBASE, TYPE 4 MIX/ITEM: NYSDOT ITEM 304.05

LARGE BELGIAN BLOCK CURBING

(12" DEEP X 8" LONG X 4" WIDE)

SEE PLANS

- PAVEMENT

APPROVED COMPACTED

FINISHED PAVEMENT GRADE

SITE DRIVEWAY

STONE CURB

(BELGIAN BLOCK)

LAWN OR LANDSCAPING-

THICKNESSES INDICATED REFER TO

DEPARTMENT OF TRANSPORTATION

STANDARD SPECIFICATIONS

COMPACTED MEASURES.


NEW YORK STATE

SUBGRADE

(SEE PLANS)

NOTES:

ANY ALTERATION OF PLANS. SPECIFICATIONS, PLATS AND REPORTS BEARING THE SEAL OF A LICENSED PROFESSIONAL ENGINEER OR LICENSED LAND SURVEYOR IS A VIOLATION OF SECTION 7209 OF THE NEW YORK STATE EDUCATION LAW, EXCEPT AS PROVIDED FOR BY SECTION 7209, SUBSECTION 2

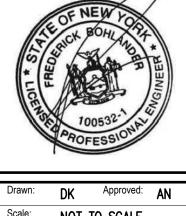

NOT TO SCALE

GATE AND STONE PIER

PERSPECTIVE VIEW

DRY LAID BOULDER WALL

(WITH PATIO REMOVED)

STONE AND MORTAR WALL

CLASS A CONCRETE

FOUNDATION (4,000 PSI)

1. JOINTS SHALL BE NO WIDER THAN 3/4" AND SHALL BE MORTARED. JOINTS SHALL BE FULLY FILLED WITH 1:2 CEMENT MORTAR, NEATLY

POINTED AND CLEANED OF EXCESS MORTAR.