
PROPOSED RENOVATION OF

The Kalian Residence

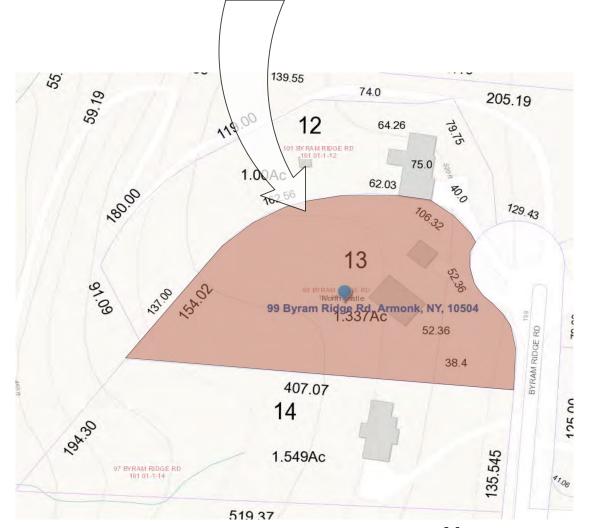

99 Byram Ridge Road, Armonk, NY

OWNER: Mr. & Mrs. Christopher Kalian

Contractor : Ridge Partners


Architect: Tom F. Abillama, AIA



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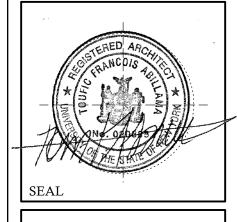


OWNER:

MR. & MRS. CHRISTOPHER KALIAN

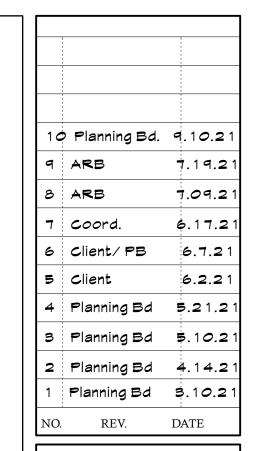

1955 CENTRAL PARK AVENUE YONKERS, NEW YORK PHONE: 914 6684673 FAX: 914 668 1831 EMAIL: FILES@TFARA.COM



KEY PLAN

PROPOSED
ONE FAMILY
DWELLING
EXPANSION


99 BYRAM RIDGE RD.,
ARMONK, N.Y

TITLE SHEET

Project ID / DATE : 2048/ 10.15.2020

Sheet Scale:

Drawn By: KM Checked By: TFA

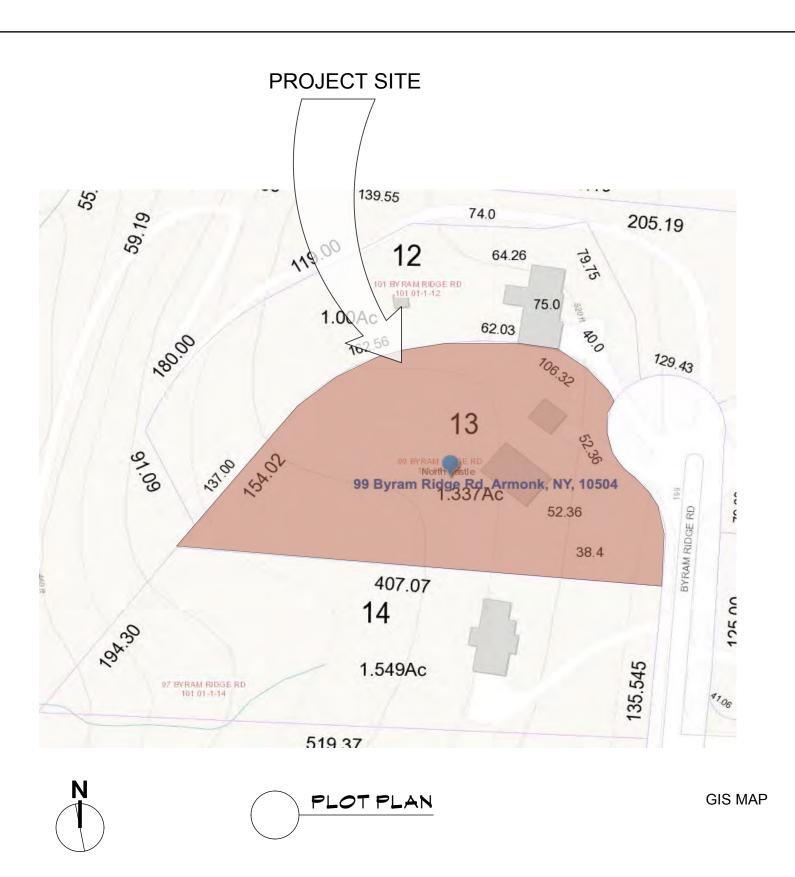

ELECTRICAL NOTES

Mork related to these documents shall include furnishing and installation of every kind of wire/conduit required to make the electric light and power distribution system complete, i.e. providing and connecting service entrance equipment, lighting panels, power panels, switches, outlets, receptacles, back boxes, related components required by the local utility company of all fixtures complete with lamps, clamps, hangers, supports, etc.

All electrical work shall comply with the requirements of the national electric code, latest edition. Should a conflict arise, the code or more stringent requirements shall prevail.

All wiring shall be copper, #12 awg minimum size - #8 and smaller to be solid, #6 and larger to be stranded. Insulation to be NEC 600 volt type, rated @ 75 degrees C and be properly phase color coded for 120/208 V. 3 phase 4-wire service.

Unless noted otherwise, minimum size conduit shall be 1/2" and number of cross marks indicate number of #12 conductors in conduit. Type of conduit used shall be in strict accordance with code provisions concerning same. All conduit runs are to be concealed in floors, walls, and ceilings, except where noted otherwise.

Electrical installation shall be tested for shorts, grounds, operation of low voltage circuitry, night light wiring, stand-by generator and connections to same, etc. Defects shall be remedied at once and the tests re-run as many times as may be required to prove correctness. Balance all phase loading of all panelboards.

The circuits shall be distinctly numbered and identified on the schedule of circuits typewritten to the panelboard. Affix permanent identifying nameplates to all electrical switches, pilot devices, selector switches, etc. Submit samples and list of titles for approval prior to purchase and installation.

PLUMBING NOTES

Installation of all work herein specified shall conform to the requirements of the NY State Plumbing Code, rules and regulations of the North Castle building department, and all other local authorities having jurisdiction, including federal O.S.H.A. specifications.

All materials used shall be new, best of their respective brands and conform to the requirements of all state and local authorities having jurisdiction. Pipework installed under this contract shall be in accordance with the following schedule:

Material

Soil and waste lines[within building]above grade-extra heavy cast iron pipe or dwv copper pipe with sweat solder connections;

Below grade- extra heavy cast iron pipe. soil and waste lines [outside building] extra heavy cast iron pipe. vent pipingstandard weight galvanized pipe or type dwv copper pipe with sweat solder joints. cold and hot water piping underground-typek with flare fittings.

Above grade [within building] type I copper tube with lead free sweat solder connections

Set clevis hangers for the support of copper piping not more than 10 ft on center. set hangers for cast iron pipe not more than 5 ft apart; use 3/8" rod for pipe up to 2" and 1/2" rod for pipes, 2 1/2" and larger. cover all cold water and hot water lines with 1" thick o-c fiberglass light density one piece pipe insulation having frk universal type vapor barrier outer jacket. install as per manufacturer's specifications. cover all valves and fittings with zeston premoulded insulating shapes.

02060 REMOVALS

I. MORK INCLUDED

- 1. SEE ARCHITECTURAL DEMOLITION DRAWING SEE ALSO MECHANICAL AND ELECTRICAL DRAWINGS.
- 2. GENERAL REMOVALS AND RELOCATIONS:
- 1. REMOVE AND RELOCATE ALL EXISTING MISCELLANEOUS MECHANICAL AND ELECTRICAL DEVICES AND FIXTURES INCLUDING BUT NOT LIMITED TO: FIRE ALARM, PULLS STATIONS, POWER OUTLETS, LIGHT SMITCHES, THERMOSTATS AND TELEPHONE OUTLETS AS REQUIRED FOR THE INSTALLATION OF NEW YORK.
- 2. REMOVE ALL ITEMS, MATERIALS AND FINISHES REQUIRED FOR THE INSTALLATION OF NEW WORK, OR THE RELOCATION OF EXISTING, AS DESCRIBED IN PERTINENT SECTIONS OF THESE SPECIFICATIONS AND / OR SHOWN ON THE DRAWINGS INCLUDING STRUCTURAL, MECHANICAL END ELECTRICAL DRAWINGS AND SPECIFICATIONS.
- 3. EXISTING WIRING, PIPING OR OTHER LINES WITHIN WALLS OR CEILINGS TO BE REMOVED - VERIFY THAT THESE ARE ABANDONED PRIOR TO REMOVAL. RE-ROUTE ANY LINES THAT ARE STILL IN USE TO MAINTAIN ALL EXISTING SERVICES.
- II. MATERIALS (NA) III. EXECUTION
- 1. ALL REMOVALS AND DEMOLITION SHALL BE IN COMPLIANCE WITH NYS BUILDING CODE, AND ALL APPLICABLE FEDERAL SAFETY REGULATIONS.
- 2. ALL MATERIALS AND ITEMS THAT ARE TO BE REUSED AND RELOCATED IN CONJUNCTION MITH THE NEW MORK SHALL BE CAREFULLY CUT AWAY FROM THE EXISTING ABUTTING WORK TRUE TO LINE AT THE NEAREST JOINT, SURFACE BREAK OR PATTERN LINE TO ENSURE NO NOTICEABLE DIFFERANCE BETWEEN NEW AND EXISTING TO REMAIN. REMOVALS SHALL BE KEPT TO A MINIMUM MATERIALS TO BE REUSED AND RELOCATED SHALL BE PROPERLY HANDLED. TAGGED AND PROPERLY STORED TO PREVENT DAMAGING AND BREAKING.
- 3. CAREFULLY COORDINATE ALL TRADES TO ENSURE PROPER AND ADEQUATE INTERFACE OF THE WORK.
- 4. WHEN WORK IS STOPPED, PROVIDE AND MAINTAIN IN PLACE SUITABLE COVERINGS AND BARRIERS FOR PROTECTION OF THE WORK AND SAFETY FOR ALL PERSONNEL AND BUILDING USERS, PROVIDE PROTECTED PATHS OF EGRESS, PER PHASING REQUIREMENTS, FOR CONTINUOUS PLUBLIC ACCESS TO STAIRS , ESCALATORS AND ENTRANCES / EXITS.
- 5. PROTECT ALL WORK, EXISTING AND NEW, FROM DAMAGE BY ANY CAUSE THROUGHOUT THE DEMOLITION OPERATIONS PROTECTIVE COVERINGS OR BARRIERS SHALL NOT MAR, STAIN OR PENETRATE THE FINISHED MORK.
- 6. COORDINATE ALL ELECTRICAL WORK FOR THE PROPER DISCONNECTIONS, PROTECTIONS AND CAPPINGS: SEE ELECTRICAL DRAWINGS AND SPECIFICATIONS.
- 7. UNDERTAKE WHATEVER PRECAUTIONS ARE NECESSARY TO PREVENT EXCESSIVE DUST DURING DEMOLITION.
- REMOVE ALL PORTIONS OF THE WORK IN A SAFE MANNER WITH CARE TO PREVENT DAMAGE TO ADJACENT AND REMAINING STRUCTURE, FINISHES OR ANY OTHER ITEMS OF PROPERTY.
- 9. ALL MATERIALS UNLESS NOTED TO BE REUSED OR TO BE SALVAGED SHALL BE REMOVED OFF THE PROPERTY TO AN AVAILABLE DUMP OR SITE OF THE CONTRACTOR'S OWN CHOOSING AND ARE TO BE PROPERLY AND RESPONSIBLY DISPOSED OF. NO BURNING OR ON-SITE DISPOSAL IS PERMITTED.
- 10. VERIFY SALVAGE REQUIREMENTS FOR ALL MATERIALS NOTED TO BE REMOVED WITH SAFE HORIZON. MATERIALS NOTED TO BE SALVAGED SHALL BE PROPERLY STORED IN LOCATION PER SAFE HORIZON, INC. DIRECTIONS.
- 11. ALL SPACES ARE TO BE BROOM CLEANED DAILY.
- 12. ALL REMOVALS SHALL LEAVE THE EXISTING SURFACES AND SUBSTRATES FREE AND CLEAN FOR THE PROPER PATCHING AND PREPARATION REQUIRED FOR THE SPECIFIED NEW MATERIALS AND FINISHES.

NOTES: STEEL COL'S SHALL REST ON 12" X 12"

3/4" T. ST. BASE PLATE OVER LEVELLING PLATE OVER NON-SHRINK GROUT W/(4)3/4" \$ 12" LONG ANCHOR BOLTS OVER

3'-0" X 3'-0" X 18 " CONC. FOOTINGS W/(3) # 4'S EA. WAY-BOTTOM.

ALL BEAMS OVER 2 MEMBERS SHALL BE BOLTED TOGETHER M/3/4" THRU-BOLTS @ 18" O.C. STAGGERED.

ALL FLUSH BEAMS SHALL RECEIVE JOIST HANGERS BY SIMPSON OR EQ.

ALL DOORS, WINDOWS SHALL RECEIVE (2) 2X10 HEADERS (TYP.) UNLESS OTHERWISE NOTED ON PLANS.

ALL FOUNDATION WALLS SHALL BE WATERPROOFED W/ 2-COATS OF BITUM. COATING AND BACKFILLED M/GRAVEL

CONSTRUCTION TO BE "V b" SINGLE FAMILY RESIDENTIAL LIVE LOADS = 40 PSF GROUND SNOW LOAD = 30 PSF SNOW LOAD = 30 PSF DEAD LOAD = 15 PSF WIND LOADS = 115 MPH SEISMIC DESIGN: B

1- ALL STRUCTURAL STEEL SHALL CONFORM WITH AISC SPECIFICATIONS FOR STRUCTURAL STEEL FOR BUILDINGS, AND SHALL BE BASED ON ASTM-A36 WITH MINIMUM YIELD POINT OF

- 36.000 PSI. 2- ALL CONNECTION MATERIAL SHALL CONFORM TO ASTM REQUIREMENTS:
- A) HIGH STRENGTH BOLTS : A325.
- B) WELDING ELECTRODES : AWS-A5.1, E70 SERIES. C) BOLTS SHALL BE 3/4" DIAMETER.
- D) OPEN HOLES SHALL BE 13/16" DIAMETER, UNLESS OTHERWISE INDICATED. 3 - ALL WELDING SHALL BE DONE BY LICENSED WELDERS AND SHALL BE INSPECTED BY APPROVED WELDING AGENCY.
- 4- PROVISIONS SHALL BE MADE FOR CONNECTIONS OF OTHER TRADES PRIOR TO
- FABRICATION. 5- ALL STEEL MEMBERS SHALL HAVE SHOP COAT OF PRIMER.

6-LOOSE LINTELS SHALL HAVE 6" BEARING EACH END.

1- ALL FOOTINGS ARE TO REST ON UNDISTURBED SOIL HAVING A MIN. BEARING CAPACITY OF 2 TONS PER SQ. FT. 2- EDGES OF FOOTINGS SHALL NOT BE PLACED AT A GREATER THAN 1 VERTICAL

1- ALL CONCRETE SHALL BE STONE AGGREGATE CONCRETE WITH AN ULTIMATE COMPRESSIVE STRENGTH OF 3000# PSI AFTER 28 DAYS. 2- WELDED WIRE FABRIC SHALL HAVE AN ULTIMATE STRENGTH OF 70,000 PSI. 3- ALL STEEL REINFORCEMENT SHALL BE DEFORMED ACCORDING TO ASTM-A615, GRADE 60 AND SHALL HAVE A YIELD POINT OF 40,000 PSI.

TO 2 HORIZONTAL SLOPE WITH RESPECT TO ANY OTHER ADJACENT FOOTINGS.

- 1- CONCRETE BLOCK SHALL CONFORM TO ASTM C-145, GRADE N-1. 2- MORTAR SHALL CONFORM TO ASTM C-270 TYPE "M".
- 3- NO VINYLIDENE CHLORIDE OR ANY UNAPPROVED CURING ADMIXTURE SHALL BE ALLOWED IN MORTAR MIXTURE.
- 4- PROVIDE GALV. HORIZONTAL REINFORCEMENTS AT EVERY COURSE JOINT.

ADMINISTRATIVE

THE ARCHITECT/ENGINEER HAS NOT BEEN RETAINED FOR THE SUPERVISION OF WORK & IT REMAINS INCUMBENT ON THE CONTRACTOR TO INFORM THE BUILDING DEPARTMENT OR THE ARCHITECT/ENGINEER OF ANY DISCREPANCIES OR CHANGES ON THE APPROVED PLANS.

NO WORK IS TO BE STARTED UNTIL A BUILDING PERMIT HAS BEEN SECURED AS REQUIRED BY THE GOVERNING AGENCIES.

THE CONTRACTOR IS TO VERIFY ALL DIMENSIONS AND CONDITIONS PRIOR TO THE COMMENCEMENT OF WORK & SHALL REPORT ANDY DISCREPANCIES TO THE ATTENTION OF THE

ARCHITECT/ENGINEER BEFORE PROCEEDING.

ALL WORK OF THE VARIOUS TRADES INVOLVED WITH THE CONSTRUCTION OF THIS PROJECT IS TO BE PERFORMED BY CAPABLE AND REPUTABLE CONTRACTORS, LICENSED IN THE STATE OF NEW YORK & AS REQUIRED BY LOCAL AGENCIES.

DO NOT SCALE DIMENSIONS FROM DRAWINGS. WRITTEN DIMENSIONS ARE TO BE FOLLOWED FOR CONSTRUCTION PURPOSES. LARGE SCALE DRAWINGS TAKE PREFERENCE OVER SMALLER SCALE

NO WORK IS TO BE STARTED UNTIL THE PLANS ARE APPROVED BY THE NEW YORK CITY DEPT. OF BUILDING AND A WORK PERMIT IS OBTAINED.

THESE NOTES ARE PART OF THE CONSTRUCTION DOCUMENTS AND SPECIFICATIONS AND ARE TO BE FULLY COMPLIED WITH IN ALL RESPECT. THE CONTRACTOR SHALL BE HELD TO HAVE VISITED THE SITE SO THAT HE MAY DETERMINE THE DIFFICULTIES HE MAY ENCOUNTER DURING CONSTRUCTION.

FOUNDATION AND SUBSOIL CONDITIONS HAVE BEEN DESIGNED BASED ON THE INFORMATION CONTAINED WITHIN THE BORINGS AND/OR TEST PITS AS FURNISHED BY THE OWNER, EXACT FOUNDATION REQUIREMENTS ARE SUBJECT TO CHANGE BASED ON CONTROLLED INSPECTIONS OF SUBSOIL CONDITIONS AND MAY VARY FROM THOSE INDICATED ON THESE

CONTRACTOR IS RESPONSIBLE FOR NOTIFYING UTILITY COMPANIES TO VERIFY EXACT LOCATIONS OF THEIR UTILITY LINES, SERVICE AND OTHER POSSIBLE EQUIPMENT.

THE OWNER SHALL BE RESPONSIBLE FOR THE SAFE MAINTENANCE OF THE BUILDING SITE.

PRIOR TO COMMENCMENT OF WORK THE ADJACENT PROPERTY OWNERS SHALL BE GIVEN 5 DAYS WRITTEN NOTICE BY CERTIFIED MAIL, WHERE ADJACENT PROPERTY IS AFFECTED BY FOUNDATIONS, GRADING EARTH WORK OR DEMO WORK.

AN ACCURATE AND COMPLETED SURVEY, MADE BY A LICENSED SURVEYOR, SHALL BE SUBMITTED TO THE APPLICANT OF RECORD AFTER COMPLETION OF WORK SHOWING THE LOCATION AND ELEVATIONS OF ANY NEW BUILDING OR EXTENSION, FINISHED FLOOR ELEVATION, GRADE ELEVATIONS AND SHALL COMPLY TO THE MINIMUM STANDARDS OF THE NYSSPLS.

GENERAL NOTES

CONTRACTOR SHALL VISIT SITE AND SHALL BE RESPONSIBLE FOR VERIFICATION OF ALL DIMENSIONS, CONDITIONS, WHICH PERTAIN TO THE FABRICATION PROCESSES, OR TO TECHNIQUES FOR CONSTRUCTION AND COORDINATION OF THE WORK OF ALL TRADES, PRIOR TO START OF CONSTRUCTION.

ALL DISCREPANCIES SHALL BE BROUGHT TO THE ATTENTION OF ARCHITECT BEFORE PROCEEDING. THE ELEVATIONS AND AVAILABILITY OF UTILITITIES, SEWER, WATER AND ELECTRIC LINES SHALL BE VERIFIED BY OR DETERMINED BY INTERESTED CONTRACTORS PRIOR TO SUBMISSION OF BID.

CONTRACTORS SHALL ADJUST PITCH OF NEW LINES TO INSURE PROPER AND LEGAL INTERSECTIONS. CONTRACTOR SHALL COORDINATE LOCATIONS FOR STRUCTURAL, MECHANICAL AND ELECTRICAL WORK FOR ALL PITS, SLAB DEPRESSIONS, SLEEVES IN FOUNDATION WALLS, SLABS, AND ROOF OPENINGS, ETC.

CONTRACTOR SHALL VERIFY CONDITIONS OF ADJOINING STRUCTURES WHICH MAY BE AFFECTED, PROVIDE ADEQUATE PROTECTION AND RESTORE TO ORIGINAL CONDITIONS, WHENCE DAMAGE SHOULD RESULT FROM SUCH WORK. THE CONTRACTOR SHALL PROVIDE ALL NECESSARY SHORING AND BRACING FOR ALL BUILDING COMPONENTS IN ORDER TO ADEQUATELY PROTECT AGAINST ANY FAILURES.

CONTRACTOR SHALL SECURE AND PAY FOR ANY AND ALL PERMITS, LICENSES, CERTIFICATES, FEES, ETC., REQUIRED BY THE TOWN OF NORTH CASTLE DEPARTMENT OF BUILDINGS OR ANY AND ALL JURISDICTION AUTHORITIES. CONTRACTOR SHALL OBTAIN A FINAL CERTIFICATE OF OCCUPANCY UPON COMPLETION.

TO ALL REGULATIONS OF ALL AUTHORITIES HAVING JURISDICTION WHETHER SPECIFICALLY SHOWN OR NOT. [O.S.H.A. REGULATIONS MUST ALSO BE ADHERED TO]. ALL ELECTRIC WORK MUST CONFORM TO NATIONAL ELECTRIC CODE ANY ITEM SHOWN ON ONE SHEET SHALL BE AS IF CALLED FOR BY ALL SHEETS. FINAL COORDIANTION IS THE RESPONSIBILITY OF

ALL MORK MUST CONFORM TO THE TOWN OF NORTH CASTLE DEPARTMENT OF BUILDINGS, FIRE DEPARTMENT LAWS, RULES AND

THE CONTRACTOR. CONTRACTOR SHALL NOT SCALE DRAWINGS AND SHALL USE FIGURED DIMENSIONS ONLY. THE GENERAL CONDITIONS OF THE CONTRACT FOR CONSTRUCTION OF BUILDINGS, [STANDARD FORM OF A.I.A. LATEST EDITION A 201], ARE PART OF THE CONTRACT DOCUMENTS.

MORK INCLUDED IN THESE CONTRACT DOCUMENTS TO BE ALL LABOR, MATERIALS, AND EQUIPMENT, REQUIRED TO COMPLETE THE PROPOSED CONSTRUCTION AS SHOWN. WORK INCLUDED IN THIS CONTRACT SHALL BE ACCORDING TO THE TRUE INTENT OF THE DRAWINGS AND SHALL BE FIRST CLASS IN ALL RESPECTS.

MORKMANSHIP FOR A MINIMUM OF ONE YEAR AFTER SUBSTANTIAL COMPLETION. THE ARCHITECT HAS NOT BEEN RETAINED FOR SUPERVISION OR PERIODIC FIELD OBSERVATIONS AND ASSUMES NO RESPONSIBILITY FOR SAFETY METHODS ON SITE. THE OWNER AND CONTRACTOR SHALL HOLD HARMLESS THE ARCHITECT FROM

AND AGAINST ALL CLAIMS, DAMAGES, LOSSES AND EXPENSES INCLUDING ATTORNEY'S FEES ARISING OUT OF OR RESULTING

SUBCONTRACTORS SHALL GUARRANTEE. IN WRITING TO THE OWNER AT CONCLUSION OF JOB. ALL MATERIALS AND

CONTRACTOR SHALL APPLY TAPING COMPOUND IN 3 COATS TO ALL JOINTS OF ALL SHEETROCK, SHALL PROVIDE TWO COAT HIGH GLOSS PAINT IN THE KITCHEN AREA AND A SATIN FINISH COAT AT ALL OTHER AREAS. INCLUDING CEILINGS. CONTRACTOR TO PROVIDE NEW CERAMIC TILE THROUGHOUT KITCHEN, BATHROOMS, LAUNDRY ROOMS AND ALL OTHER WET FLOOR AREAS. COLORS AS SELECTED BY OWNER. SUBCONTRACTOR IS TO PROVIDE ALL FINISH HARDWARE AS REQUIRED BY THE OWNER FOR

SCOPE OF WORK PERTAINS TO THE RENOVATION/ADDITION TO EXISTING ONE FAMILY DWELLING. THESE PLANS ARE BASED ON THE 2020 RCNYS, (APPENDIX J. ALTERATION LEVEL 2-CHAPTER 6), THE TOWN OF NORTH CASTLEMUNICIPAL CODE AND ALL APPLICABLE RULES AND REGULATIONS.

FROM THE PERFORMANCE OF THE WORK BY THE CONTRACTOR.

I, TOM F. ABILLAMA R.A. , HEREBY STATE THAT I HAVE PREPARED THESE PLANS AND SPECIFICATIONS, TO THE BEST OF MY KNOWLEDGE, BELIEF AND PROFESSIONAL JUDGEMENT, IN COMPLIANCE WITH THE 2020 ENERGY CODE OF NEW YORK STATE-R 105.2.2 -ZONE 4A

TOM F. ABILLAMA, R.A. ARCHITECT

ENERGY CODE REQUIREMENTS: PRESCRIPTIVE METHOD ZONE 4A CRITERIA (RCNY,2020- N1102.1.2):

- 2-UFACTOR @ SKYLIGHT: .55 3-UFACTOR @ SHGC:.40 4-R VALUE @ ROOF: R-49
- 5-R-VALUE @ WD FRAME WALL: R-21 6-R-VALUE @ MASS WALL: R-13

1-UFACTOR @ GLAZING:.32

- 7-R-VALUE @ FLOOR: R-25 8-R-VALUE @ BASEMENT WALL: R-13 9-R-VALUE @ SLAB: R-10, 2 FT PERIM.
- 10-R-VALUE @ CRAWL SPACE WALL: R-19 1 1 - MAX INFILTR.@ WDWS,SKLTS: 0.3 CFM/SF 12-MAX INFILTR.@ SWING. DRS: 0.5 CFM/SF
- 13- MIN.75% -HIGH EFFICACY LAMPS
- 14- TESTING PER N1102-.4.1.2

ROUGH CARPENTRY:

Ground

ALL NEW DOORS.

- Framing and structural lumber: Douglas Fir #1. Fb=1050 psi, E=1,600,000 Fv=95 psi. All joists and rafters to have diagonal bridging, 8'-0" o.c. maximum. Solid blocking under ceramic tile. Members of built—up girders, headers or lintels
- shall be spiked or bolted together to act as one unit. 2. Cross bridging of joists 1- 1/4" x 3" max, 3'-0" o.c. Collar ties at cathedral ceilings,
- 2-2 x 6 @ 4'-0" o.c. max. Exterior carpentry at porches shall be c.c.a. treated as indicated on drawings. Ornamental posts shall be of a nominal size $6" \times 6" - pine$. 3. Wood deck, 5/4" thick T & G Redwood decking. Deck shall pitch
- slightly for water runoff. 4. Plywood shall meet the requirements of APA requirements and specifications:
- 5. Wall and roof sheathing: 5/8" thick, C-D—Ext-Apa, Exterior glue
- 6. Subflooring: 5/8" thick, C—D—Ext—Apa, exterior glue Underlayment: 3/8" thick—
- 7. Underlayment INT-APA Exterior glue
- 8. All wood beams to have a minimum bearing of 4". Double all joists under all partitions
- 9. All details of construction; lintels, headers, posts, beams,
- framing, nailing, etc. shall comply with all minimum standards of New York State Code. 10. Contractor to do all necessary firestopping of stud partitions and pipe
- chases, as required by N.Y. State Code whether specifically shown or not.
- 11. Lumber schedule: Miscellaneous lumber, furring, bridging, blocking to be grade #2 of any species ample in strength to meet the requirements thereof.
- 12. Mooden trimmers, headers, and tail joists over six feet in length,
- unless supported on walls or girders, shall be hung in approved metal stirrups, or hangers. 13. Every six feet, at least one beam or joist which rests on masonry walls,
- shall be secured to such walls by approved metal anchors attached in a manner at or near bottom to be self releasing.
- 14. The ends of wooden beams and joists resting on masonry walls shall be cut to a bevel of three inches in their depth. All girders to bear minimum of 8" on masonry.
- 15. Provide shelf and coat pole in all closets with five shelves in linen closet. 16. Finish woodwork shall be dressed and sanded, free from machine and tool marks, abrasions raised grain or other defects on surfaces exposed to view in the finished work.
- in place. Nail heads of exposed nailing shall be countersunk. All work shall be left clean, free from warp, twist, open joints and other defects

17. Mood finish shall be set straight, plumb and level in true alignment, closely fitted and rigidly secure

- 18. Interior miscellaneous finish carpentry and woodwork to be "C" select of white pine, oak,
- or yellow poplar.
- 19. Interior doors to be clear birch, stain grade. 20. Caulk at all doors and window frames, joints and other surfaces which require the closing of
- a joint between any two surfaces not of the same material. Caulking compound shall be silicone equal to Thiokol sealant by Toch Brothers.
- 21. Contractor to do all flashing required whether specifically shown or not. Tape and apply taping compound in 3 coats to all joints of all sheetrock.

STEEL NOTES

1- All Structural Steel Shall Conform With Aisc Specifications For Structural Steel For Buildings, And Shall Be Based On Astm-A36 With Minimum Yield Point Of 36,000psi.

- 2- All Connection Material Shall Conform To ASTM Requirements:
- A) High Strength Bolts : A325. B) Welding Electrodes: Aws-a5.1, E70 Series.
- C) Bolts Shall Be 3/4" Diameter. D) Open Holes Shall Be 13/16" Diameter, Unless Otherwise Indicated.

3- All Welding Shall Be Done By Licensed Welders And Shall Be Inspected By Approved Welding Agency.

- 4- Provisions Shall Be Made For Connections Of Other Trades Prior To Fabrication. 5- All Steel Members Shall Have Shop Coat Of Primer.
- 6- Loose Lintels Shall Have 6" Bearing Each End.

MOOD NOTES

1- All Exterior Mood Framing Members Shall Be Structural Grade With Min. Fiber Stress Strength Of 1400, And Shall Be Pressure Treated For Exterior Exposure.

2- Contractor To Provide All Steel Connections Required For Fastening Members To Others.

3- Contractor To Refer To "simpson-strong Tie" Manual For Post Plates, Joist / Beam Hangers As Well As Hold Downs And Post Caps Etc...

SCOPE OF WORK:

PROVIDE 2 STORY ADDITION AND RENOVATION TO EXISTING ONE AND HALF STORY STRUCTURE. MORK TO INCLUDE NEW INGROUND POOL UNDER SEPARATE PERMIT. PROVIDE FOR NEW DRIVEWAY, DECK AND GAZEBO. REMOVE EXISTING TREES UNDER SEPARATE PERMIT.

SEPARATE APPLICATIONS

- PLUMBING PERMIT - ELECTRICAL PERMIT
- TREE REMOVAL
- SEPTIC DESIGN

Subject To Damage From: | Winter | Ice Shield Mind Design Snow Design Underlayment Flood Load Special Wind Born Design Required Hazards Freezing Annual Temp. Meathering Depth Speed Topographic region Debris (psf) Category Temp Index zone winds 15*00* 36119C03 or 30 | 115 Mph No No 52.2º F Yes 3'-6" to Heavy less 2007

MR. & MRS. CHRISTOPHER KALIAN

10 Planning Bd. 9.10.2

4 | Planning Bd 5.21.2

3 : Planning Bd 5.10.2

2 Planning Bd 4.14.2

REV.

Planning Bd 3.10.2

DATE

Coord.

6 | Client/PB

5 Client

OWNER:

7.19.2

7.09.2


6.17.2

6.7.21

6.2.21

Architects

955 CENTRAL PARK AVENUI YONKERS, NEW YORK PHONE: 914 6684673 FAX: 914 668 1831 EMAIL: FILES@TFARA.COM

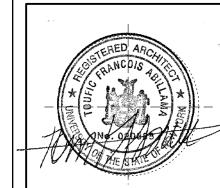

KEY PLAN

PROPOSED ONE FAMILY **DWELLING EXPANSION**

99 BYRAM RIDGE RD., ARMONK, N.Y SBL: 101.01/1/13 ZONE: R-1A

COVER SHEET/MAP /NOTES

Project ID / DATE : 2048/ 10.15.2020

Drawn By: KM Checked By: TFA JULY 19.2021



The Christophor Kalian Residence



10	Planning Bd.	9.10.21
9	ARB	7.19.2
8	ARB	7.09.2
7	Coord.	6.17.2
6	Client/PB	6.7.21
5	Client	6.2.21
4	Planning Bd	5.21.2
3	Planning Bd	5.1 <i>0</i> .2
2	Planning Bd	4.14.2
1	Planning Bd	3.1 <i>0</i> .21
NO.	REV.	DATE


OWNER:

MR. & MRS. CHRISTOPHER KALIAN



1955 CENTRAL PARK AVENUE YONKERS, NEW YORK

PHONE: 914 6684673
FAX: 914 668 1831
EMAIL: FILES@TFARA.COM

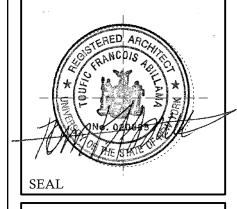

XEY PLAN

PROPOSED
ONE FAMILY
DWELLING
EXPANSION

99 BYRAM RIDGE RD.,
ARMONK, N.Y

SBL: 101.01/1/13 ZONE: R-1A


3D RENDERINGS

Project ID / DATE : 2048/ 10.15.2020

C.02




97 BYRAM RIDGE ROAD

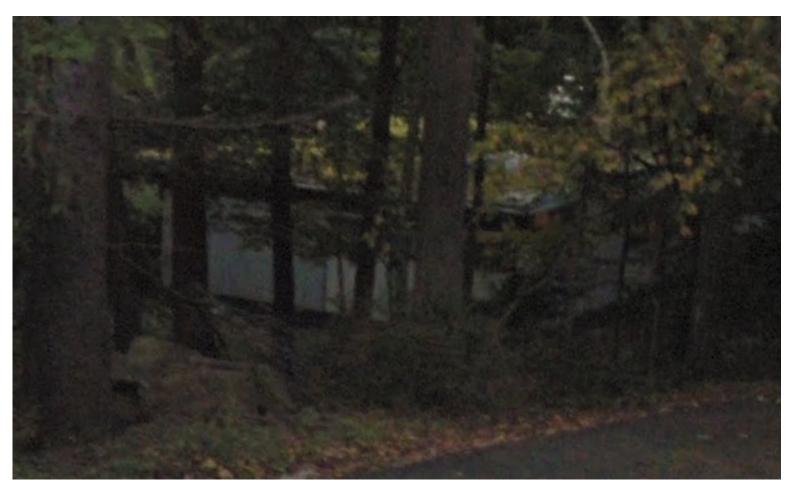


99 BYRAM RIDGE ROAD



99 BYRAM RIDGE ROAD - ADJOINING PROPERTIES

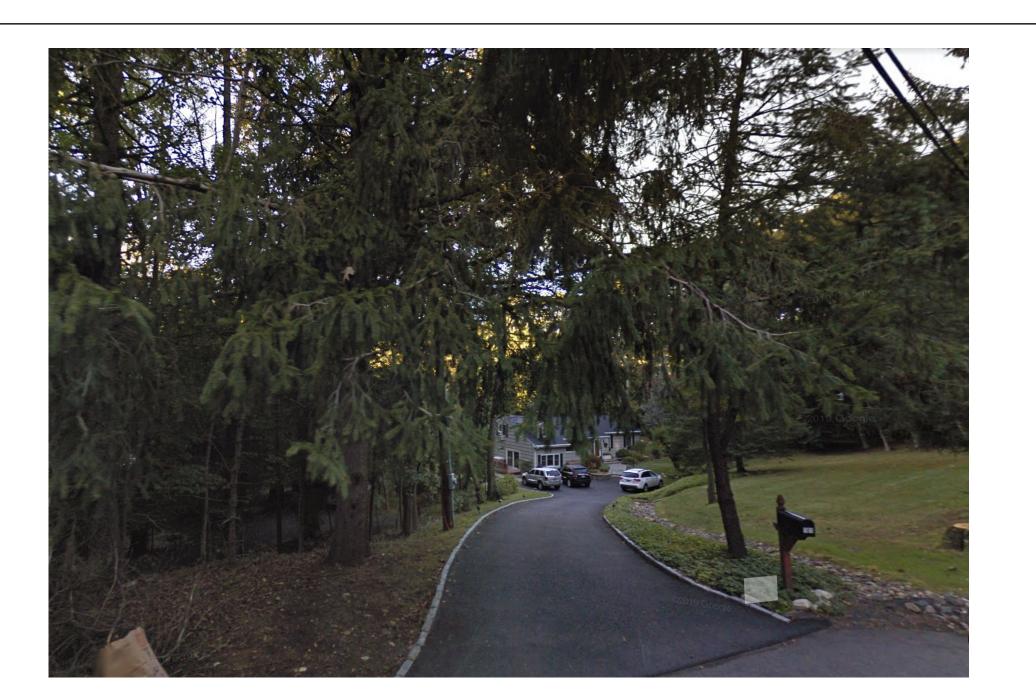

101 BYRAM RIDGE ROAD

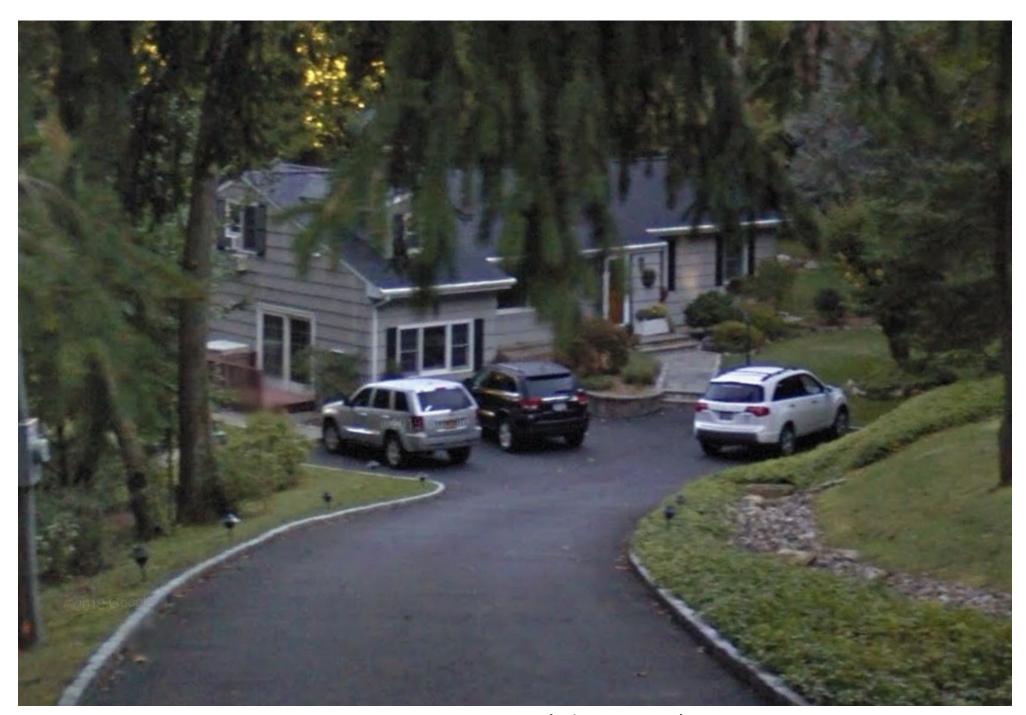

101 BYRAM RIDGE ROAD (close up)



104 BYRAM RIDGE ROAD

10	Planning Bd.	9.10.21
9	ARB	7.19.21
Ø	ARB	7.09.21
7	Coord.	6.17.21
6	Client/PB	6.7.21
IJ	Client	6.2.21
4	Planning Bd	5.21.21
m	Planning Bd	5 .1 <i>0</i> .21
2	Planning Bd	4.14.21
1	Planning Bd	3.1 <i>0</i> .21
NO	RFV	DATE

OWNER:

MR. & MRS. CHRISTOPHER KALIAN



1955 CENTRAL PARK AVENUE YONKERS, NEW YORK PHONE: 914 6684673 FAX: 914 668 1831 EMAIL: FILES@TFARA.COM



KEY PLAN

PROPOSED
ONE FAMILY
DWELLING
EXPANSION

99 BYRAM RIDGE RD.,
ARMONK, N.Y


ARMONK, N.Y

SBL: 101.01/1/13 ZONE: R-1A

AERIAL VIEM & STREETSCAPE

Project ID / DATE : 2048/ 10.15.2020
Sheet Scale:

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10 Planning Bd. 9.10.21 7.19.2 7.09.2 6 Client/PB 6.7.21 5 Client 4 Planning Bd 5.21.2 3 Planning Bd 5.10.2 2 Planning Bd 4.14.2 Planning Bd 3.10.21

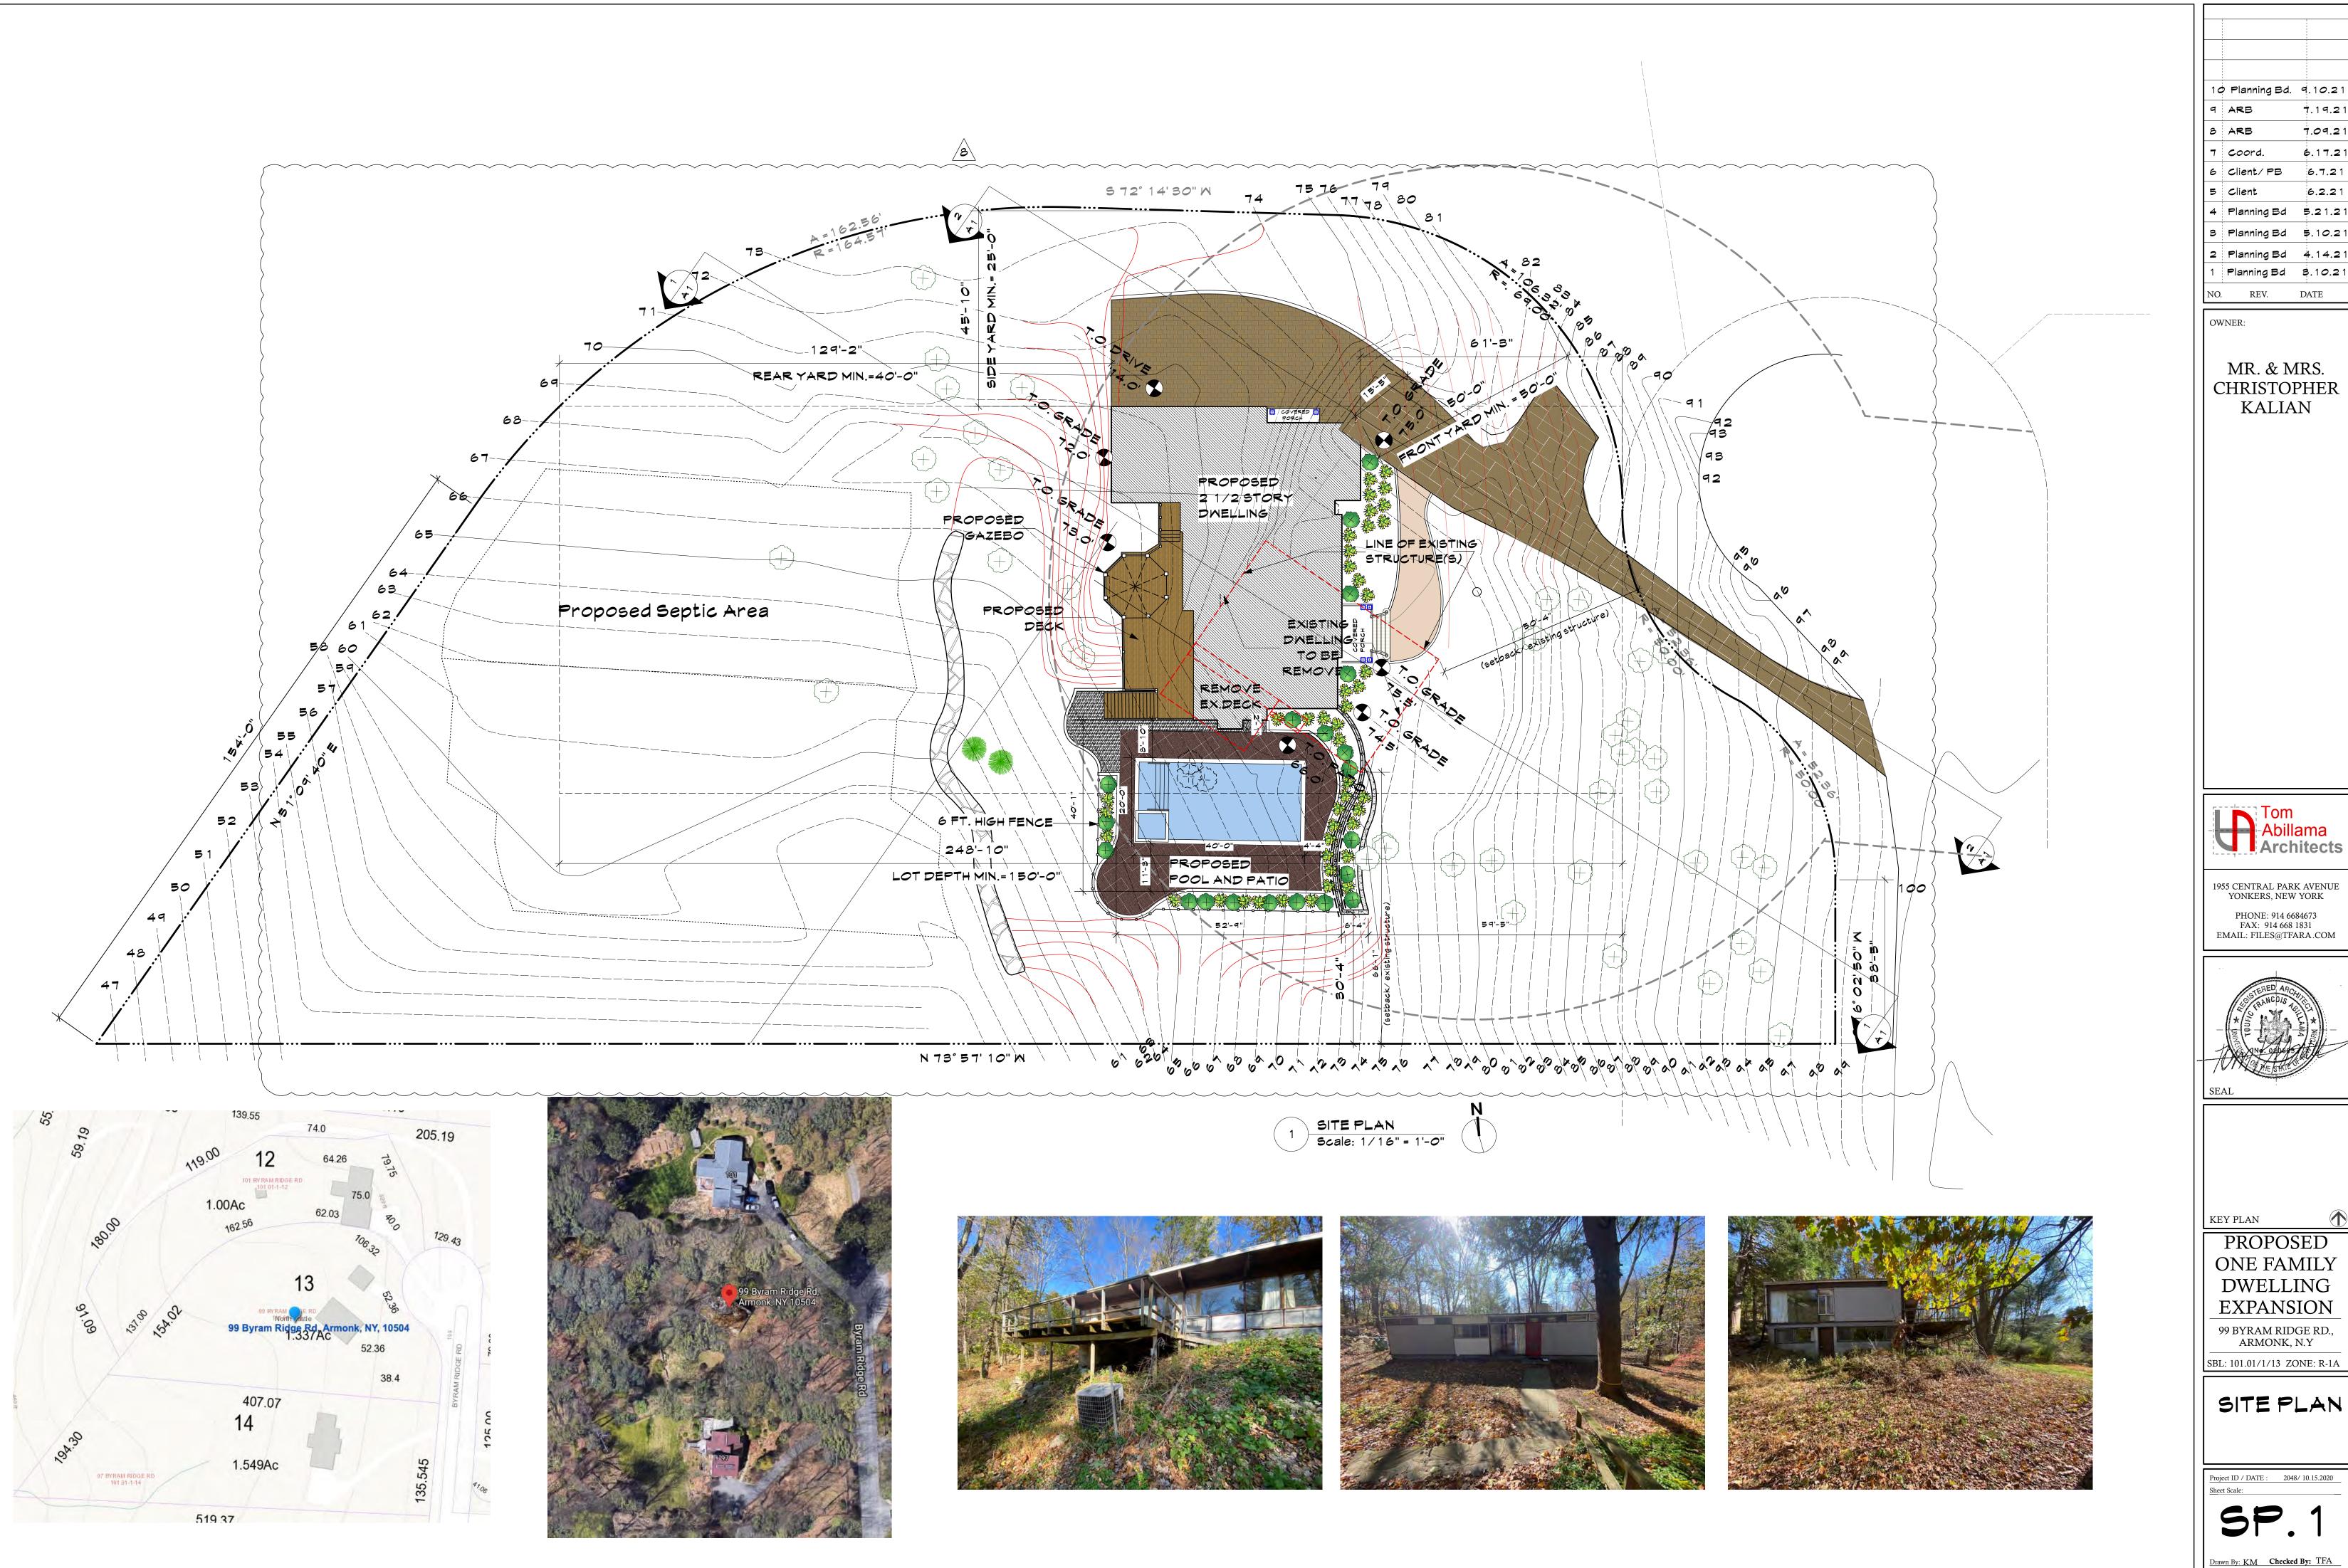MR. & MRS. CHRISTOPHER KALIAN



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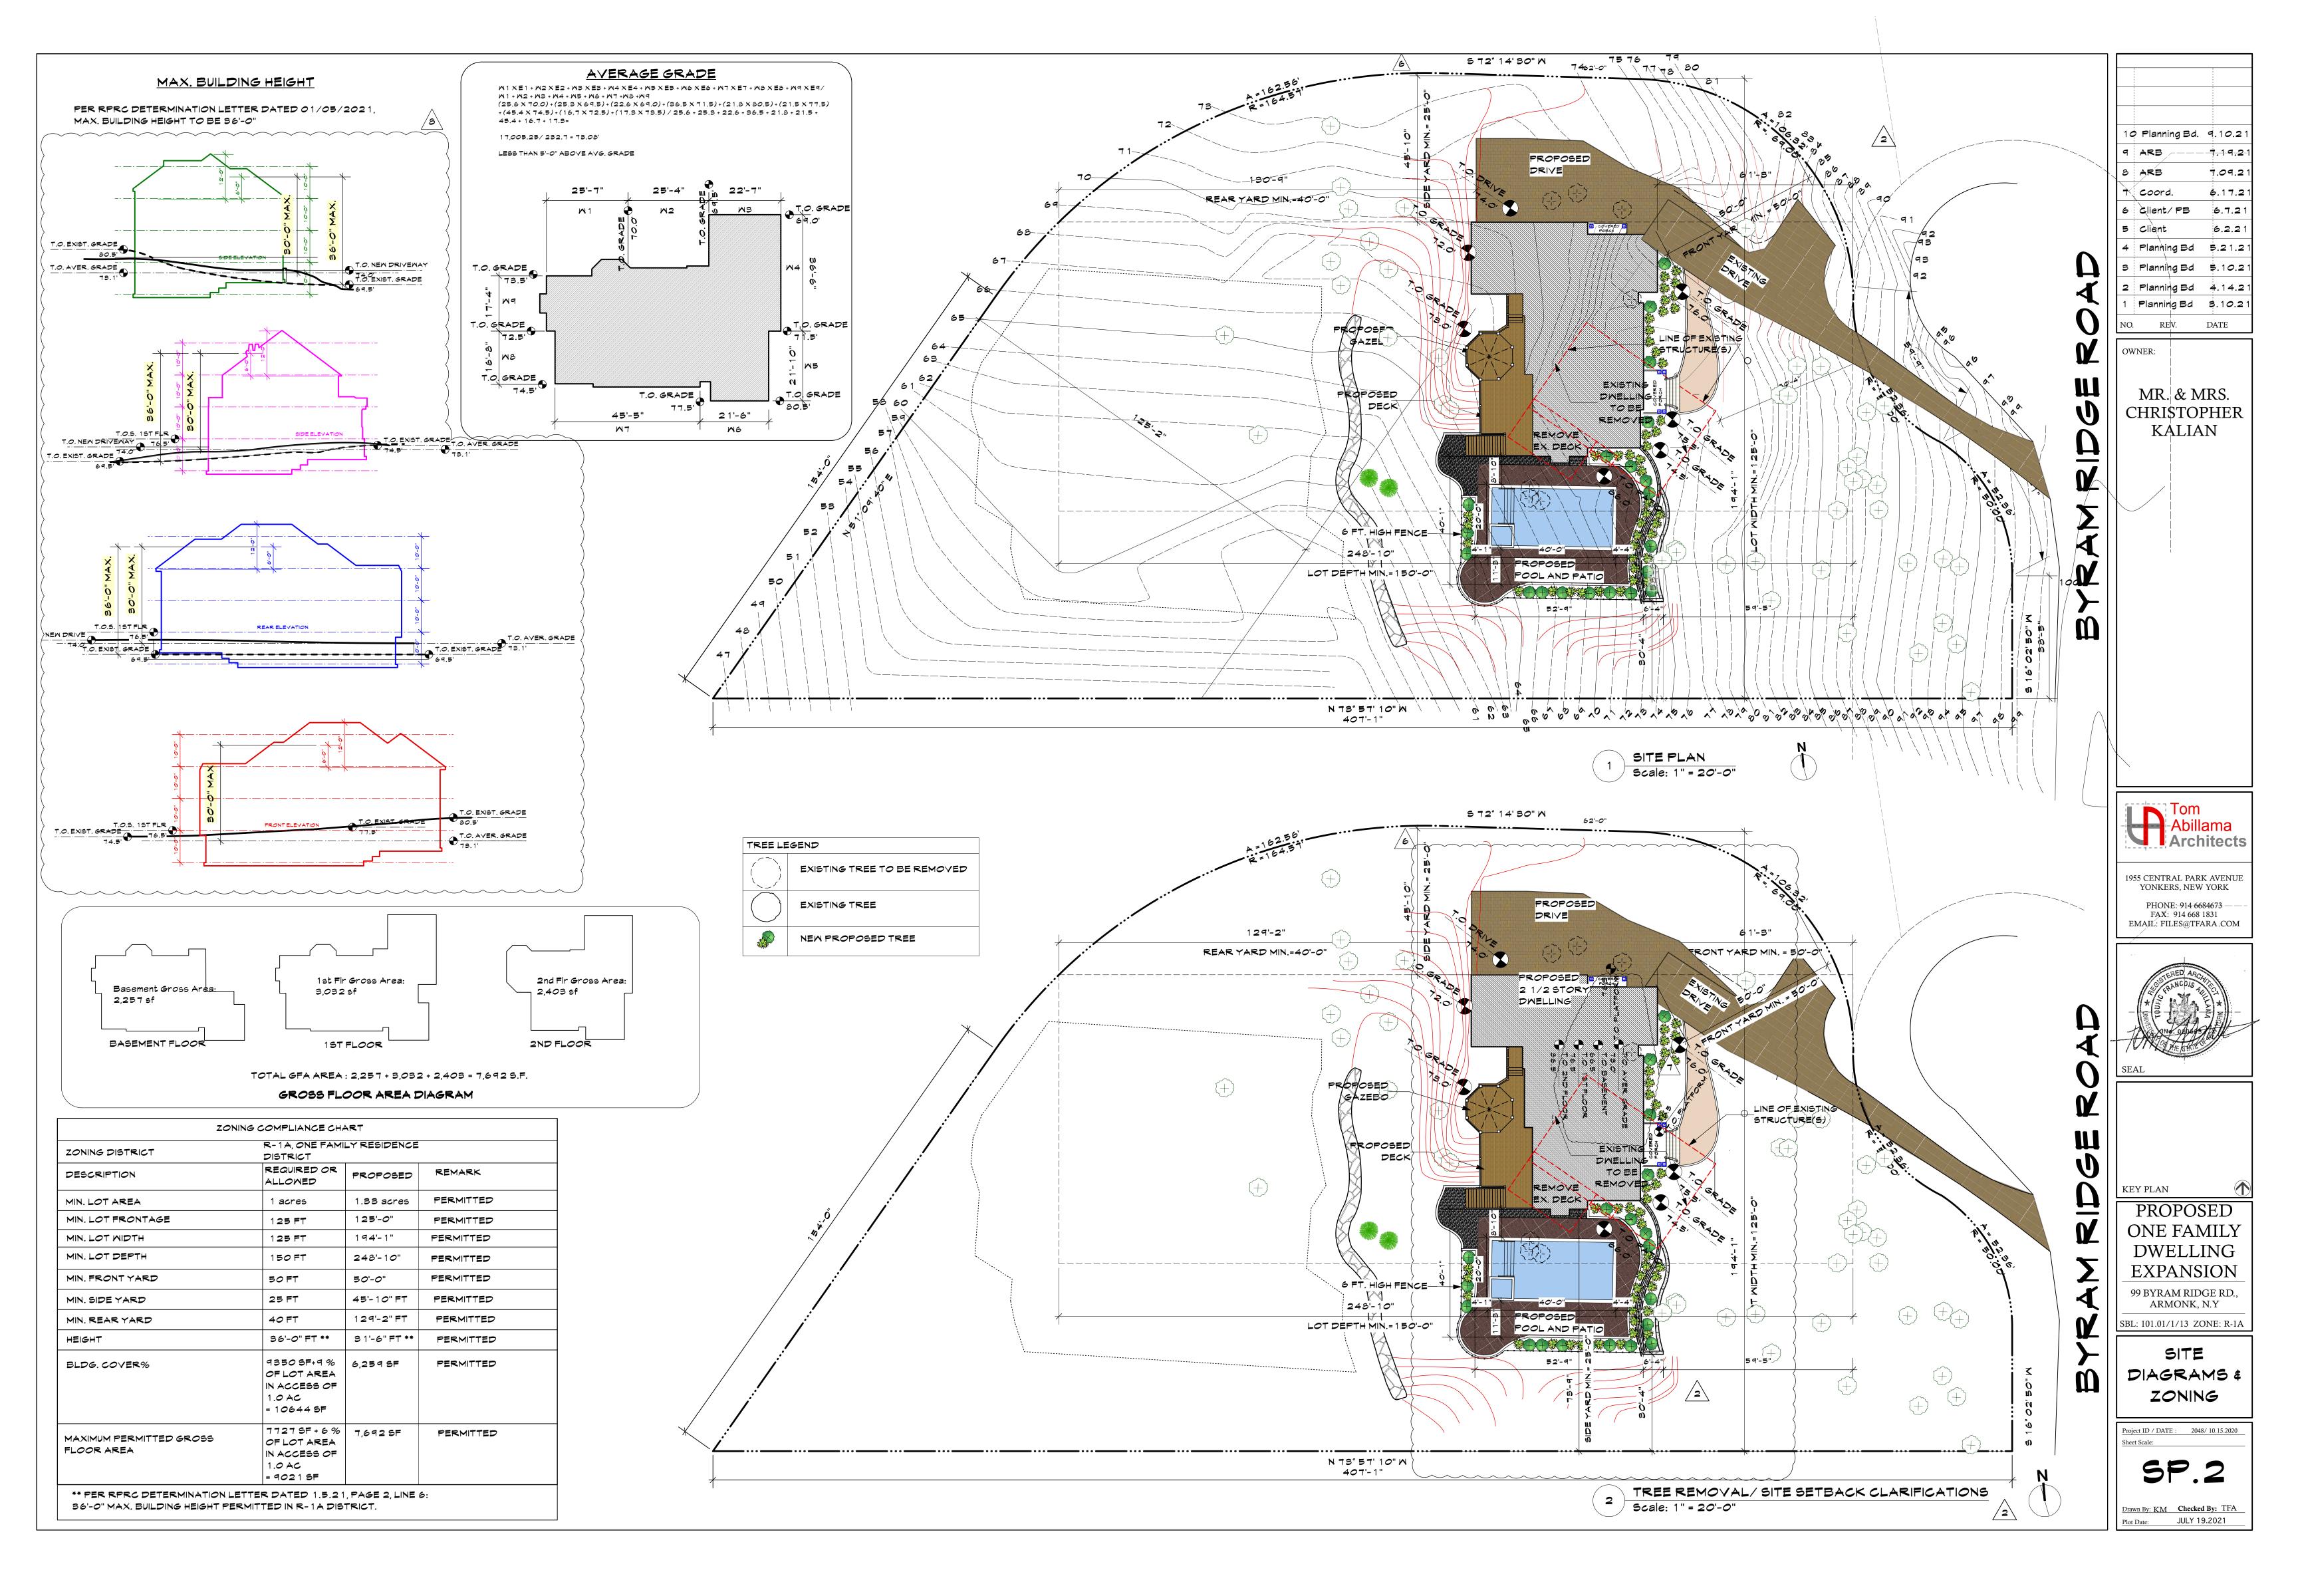



PROPOSED ONE FAMILY **DWELLING EXPANSION** 99 BYRAM RIDGE RD., ARMONK, N.Y


SBL: 101.01/1/13 ZONE: R-1A

Project ID / DATE : 2048/ 10.15.2020
Sheet Scale:

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TRACKING PAD DIAGRAM

AS REQUIRED. CONTRACTOR TO ABIDE BY ALL ENVIRONMENTAL REQUIREMENTS, SUCH AS NOISE, DUST CONTROL, ASBESTOS ABATEMENT, RODENT CONTROL, ETC. ALL MATERIALS TO BE REMOVED SHALL BE DISPENSED OF IN PROPPER MANNER AND AS PER REQUIREMENTS OF THE VILLAGE OF LARCHMONT AND THE COUNTY OF WESTCHESTER.

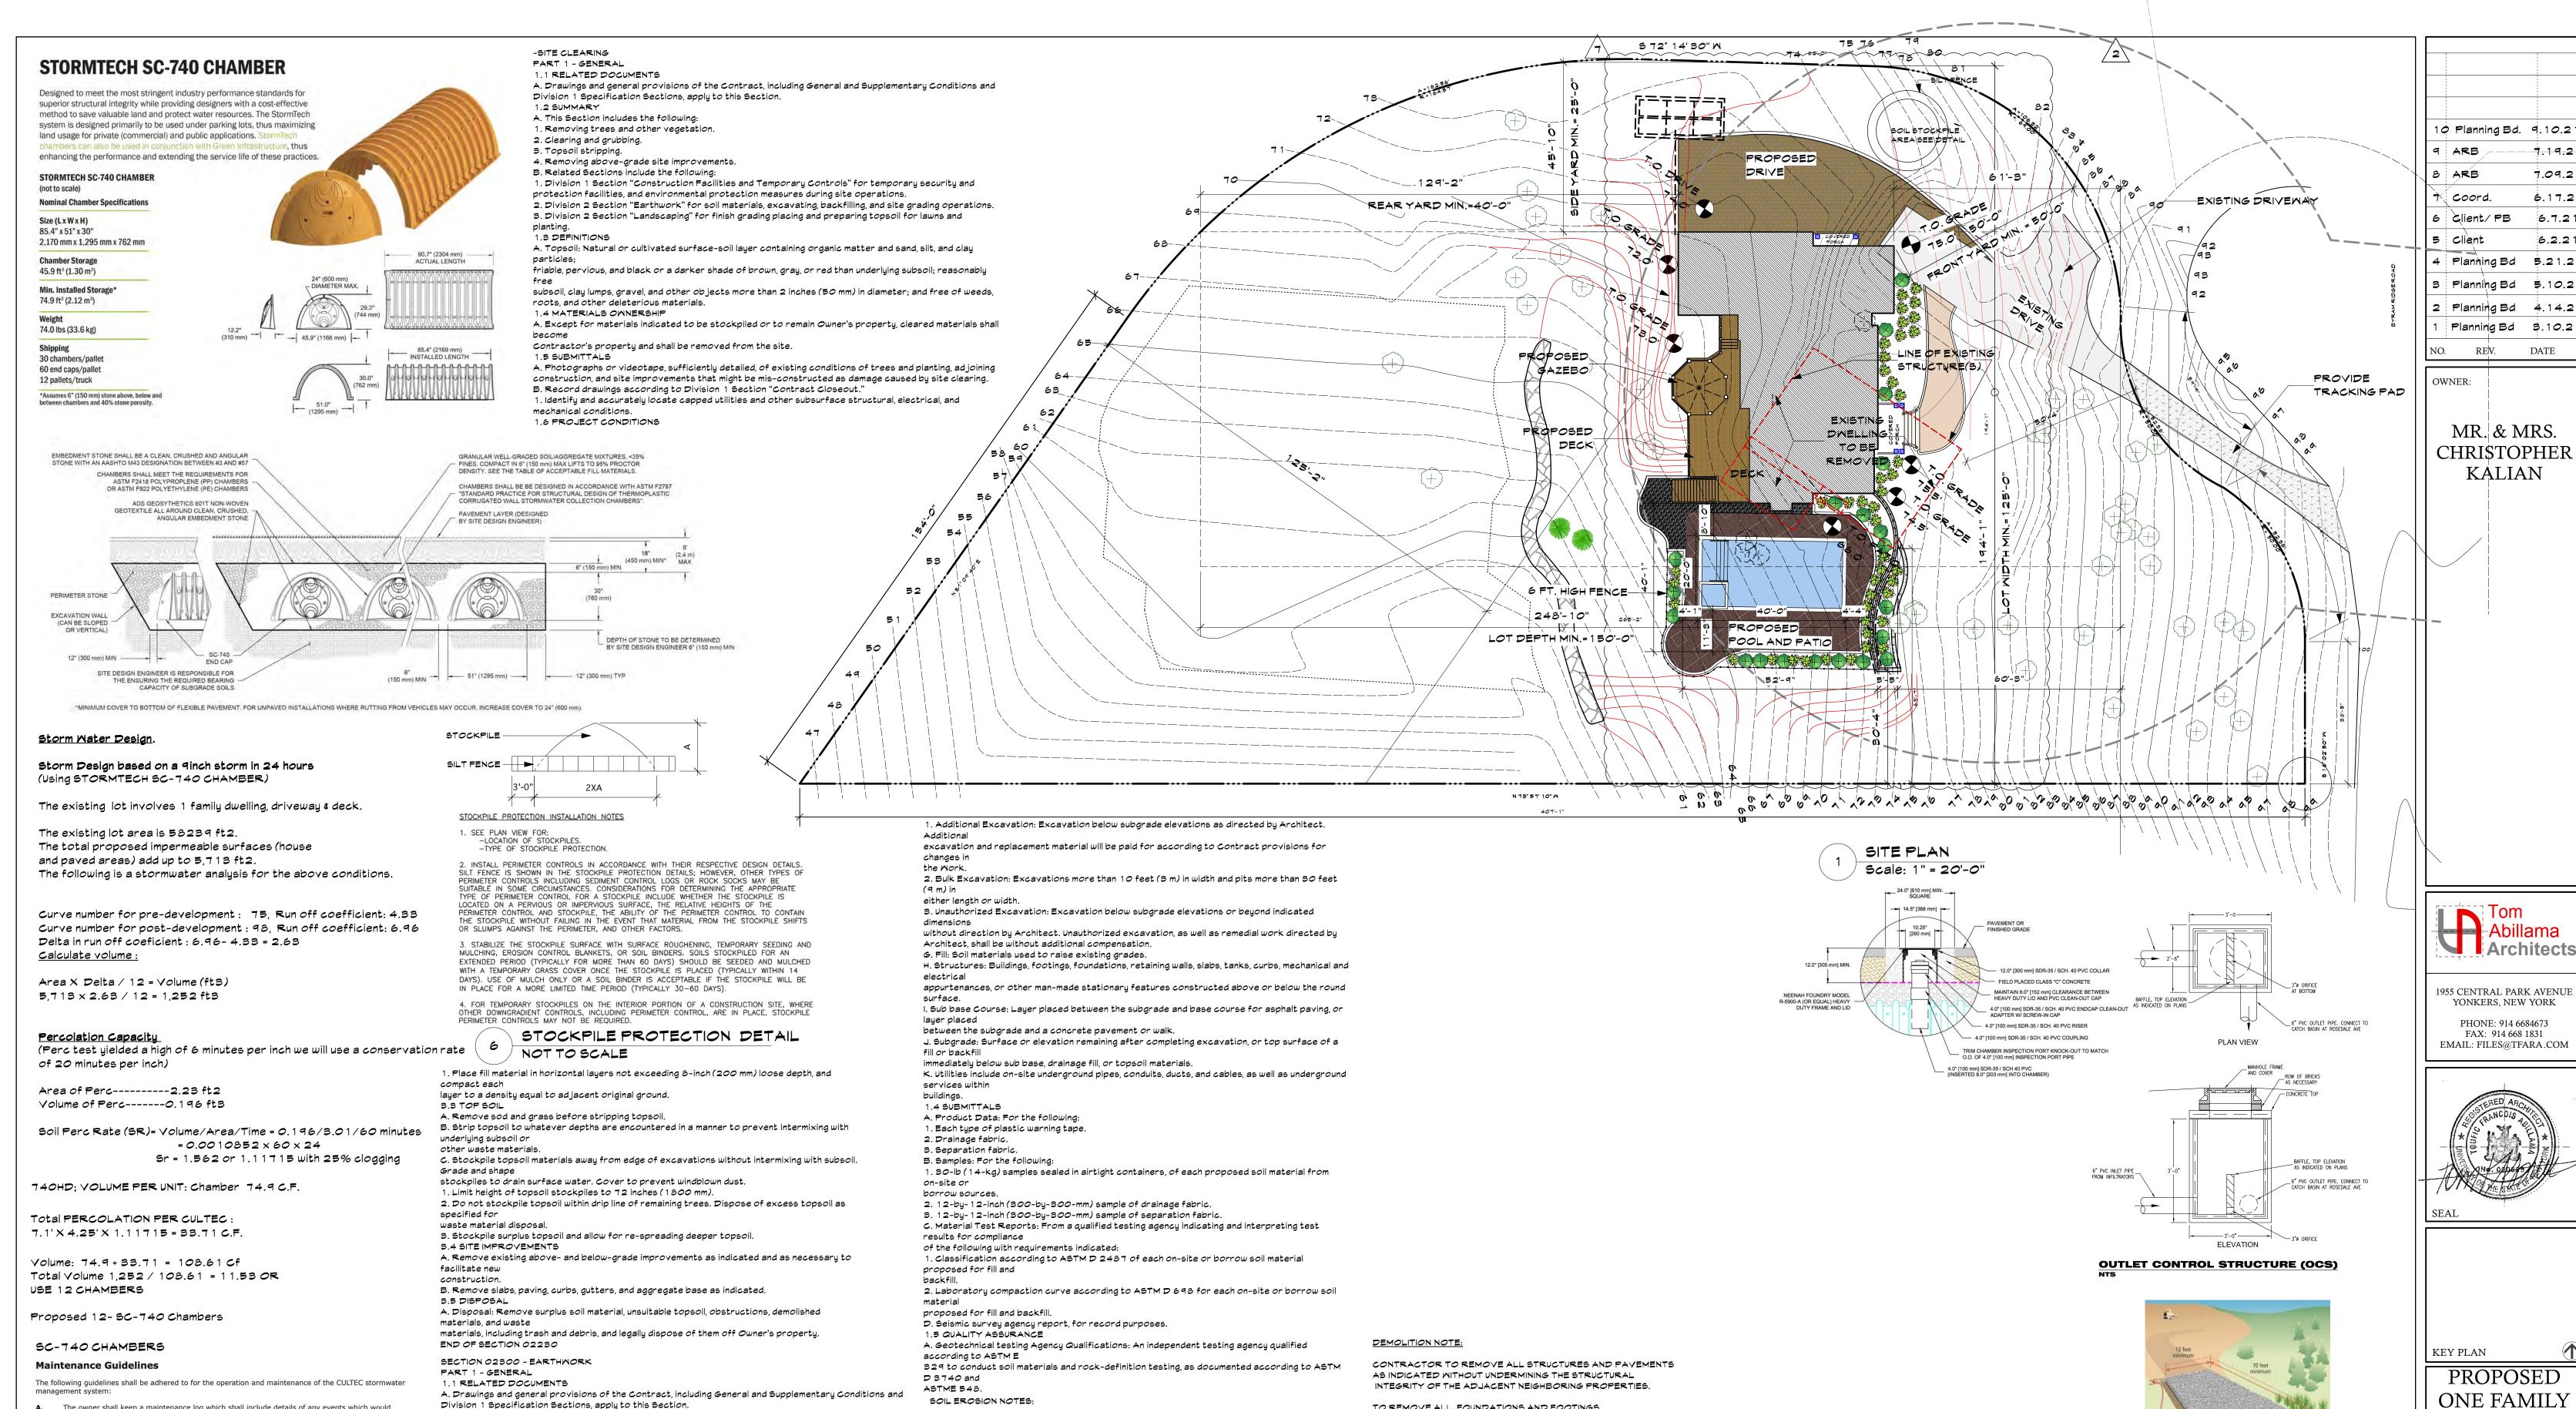SHORING AND BRACING: 1- CONTRACTOR SHALL PROTECT SITE FROM CAVING AND SOIL MOVEMENT.HE SHALL LOCATE SYSTEMS TO CLEAR PERMANENT CONSTRUCTION AND TO PERMIT

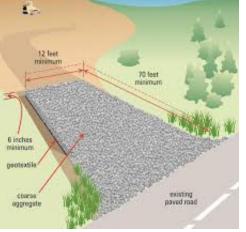ANY STRUCTURAL DAMAGE PRIOR TO DEMOLITION.

CONTRACTOR TO MAKE OWNER/ARCHITECT AWARE OF

FORMING AND FINISHING OF CONCRETE SURFACES.

PERMANENT WORK. INSTALL NEW BRACE PRIOR TO REMOVING OLD BRACE.

SBL: 101.01/1/13 ZONE: R-1A

DWELLING

EXPANSION

99 BYRAM RIDGE RD.,

ARMONK, N.Y

STORMMATER CALCULATIONS

AND DESIGN

Project ID / DATE : 2048/ 10.15.2020

Sheet Scale:

Drawn By: KM Checked By: TFA JULY 19.2021

1 - CONTRACTOR SHALL DO ALL DEMOLITION REQUIRED FOR THE COMPLETION OF WORK SHOWN ON DRAWINGS. 2- HE SHALL ALLOM NO DEBRIS TO ACCUMULATE AND SHALL HAUL AMAY FROM SITE ALL DEBRIS AT

The owner shall keep a maintenance log which shall include details of any events which would

B. The operation and maintenance procedure shall be reviewed periodically and changed to meet site

D. Debris removed from the stormwater management system shall be disposed of in accordance with

No trees to be planted above cultec tanks and 15' away, ground planting and flower w/ shallow roots

Maintenance of the stormwater management system shall be performed by qualified workers and

CONTRACTOR'S EXPENSE.

have an effect on the system's operational capacity.

applicable laws and regulations.

3-HE SHALL PROVIDE PROTECTION OF ALL ADJACENT OR NEIGHBOURING PROPERTY FROM DAMAGE, INJURY AND DISCOMFORT CAUSED BY DUST. HE SHALL PROTECT UTILITY LINES AS REQUIRED.

Division 1 Specification Sections, apply to this Section. 1.2 SUMMARY

A. This Section includes the following: 1. Preparing sub-grades for slabs-on-grade, walks, pavements, lawns, and plantings.

2. Excavating and backfilling for buildings and structures.

3. Drainage course for slabs-on-grade

4. Sub-base course for concrete walks and pavements.

5. Base course for asphalt paving. 6. Subsurface drainage backfill for walls and trenches.

7. Excavating and backfilling trenches within building lines. 8. Excavating and backfilling trenches for buried mechanical and electrical utilities and pits for buried

utility structures.

B. Related Sections include the following: 1. Division 1 Section "Construction Facilities and Temporary Controls."

2. Division 2 Section "Site Clearing" for site stripping, grubbing, removing topsoil, and protecting trees 3. Division 2 Section "Landscaping" for finish grading, including placing and preparing topsoil for lawns

4. Division 3 Section "Cast-in-Place Concrete" for granular course over vapor retarder. 5. Division 15 through 16 Sections for excavating and backfilling buried mechanical and electrical

utilities and buried utility structures.

A. Backfill: Soil materials used to fill an excavation. 1. Initial Backfill: Backfill placed beside and over pipe in a trench, including haunches to support sides 2. Final Backfill: Backfill placed over initial backfill to fill a trench.

B. Base Course: Layer placed between the sub base course and asphalt paving. C. Bedding Course: Layer placed over the excavated subgrade in a trench before laying pipe. D. Borrow: Satisfactory soil imported from off-site for use as fill or backfill. E. Drainage Course: Layer supporting slab-on-grade used to minimize capillary flow of pore water. F. Excavation: Removal of material encountered above subgrade elevations.

4. CONTRACTOR SHALL ALLOW TO A MINIMUM POSSIBLE THE SEDIMENTATION DEBRIS TO THE PUBLIC AND PRIVATE ADJOINING AREAS AND SHALL ASSUME RESPONSIBILITY FOR SUCH CONDITIONS. HE SHALL BRUSH CLEAN ALL DEBRIS FROM SIDEWALKS AND STREETS. 5. METHODS FOR OPEN EXCAVATION EMBANKMENTS NOT REQUIRING SILT FENCES OR STRAW BALES CAN BE EMPLOYED SUBJECT TO SOIL CONDITIONS AND WHERE SLOPES

AS PER REQUIREMENTS OF MUNICIPAL AUTHORITIES HAVING JURISDICTION THEREOF.

1. PRIOR TO STARTING ANY CONSTRUCTION, TEMPORARY SILT TRAPS, SEDIMENTATION

FENCES AND OTHER APPROVED SOIL CONTROL MEASURES SHALL BE PLACED AS

ADDITIONAL SEDIMENT CONTROL MEASURES SHALL BE INSTALLED WHERE DEEMED

TO SUPPLEMENT THE EROSION CONTROL DETAILS AS SHOWN ON THIS DRAWING.

SOIL EROSION NOTES:

AT THE EARLIEST POSSIBLE OPPORTUNITY.

NECESSARY,


NOT EXCEED A PITCH OF 8" IN 12".LOOSE STONE AND ROCK SHALL REMOVED FROM COMPACTED AND SEEDED TOP SOIL SHALL BE INSTALLED FOR SOIL PROTECTION.

6. UNLESS OTHERWISE AGREED BY SEPARATE CONTRACT, THIS ARCHITECT HAS NOT BEEN RETAINED FOR CONSTRUCTION ADMINISTRATION RELATED TO THE WORK THEREOF.

TO REMOVE ALL FOUNDATIONS AND FOOTINGS

2. CONTRACTOR SHALL TAKE EXTRA CARE WITH RESPECT TO LAND EXPOSED DURING DEVELOPMENT. THE EXPOSED LAND AREA SHALL BE KEPT TO A MIN. TIME PERIOD. PERMANENT SITE IMPROVEMENT METHODS AND STRUCTURES SHALL TAKE PLACE 3. CONTRACTOR SHALL ENSURE THE MAINTENANCE OF SOIL EROSION FENCES

> 2- CONTRACTOR SHALL LOCATE BRACING TO CLEAR COLUMNS, FLOOR FRAMING CONSTRUCTION, AND OTHER

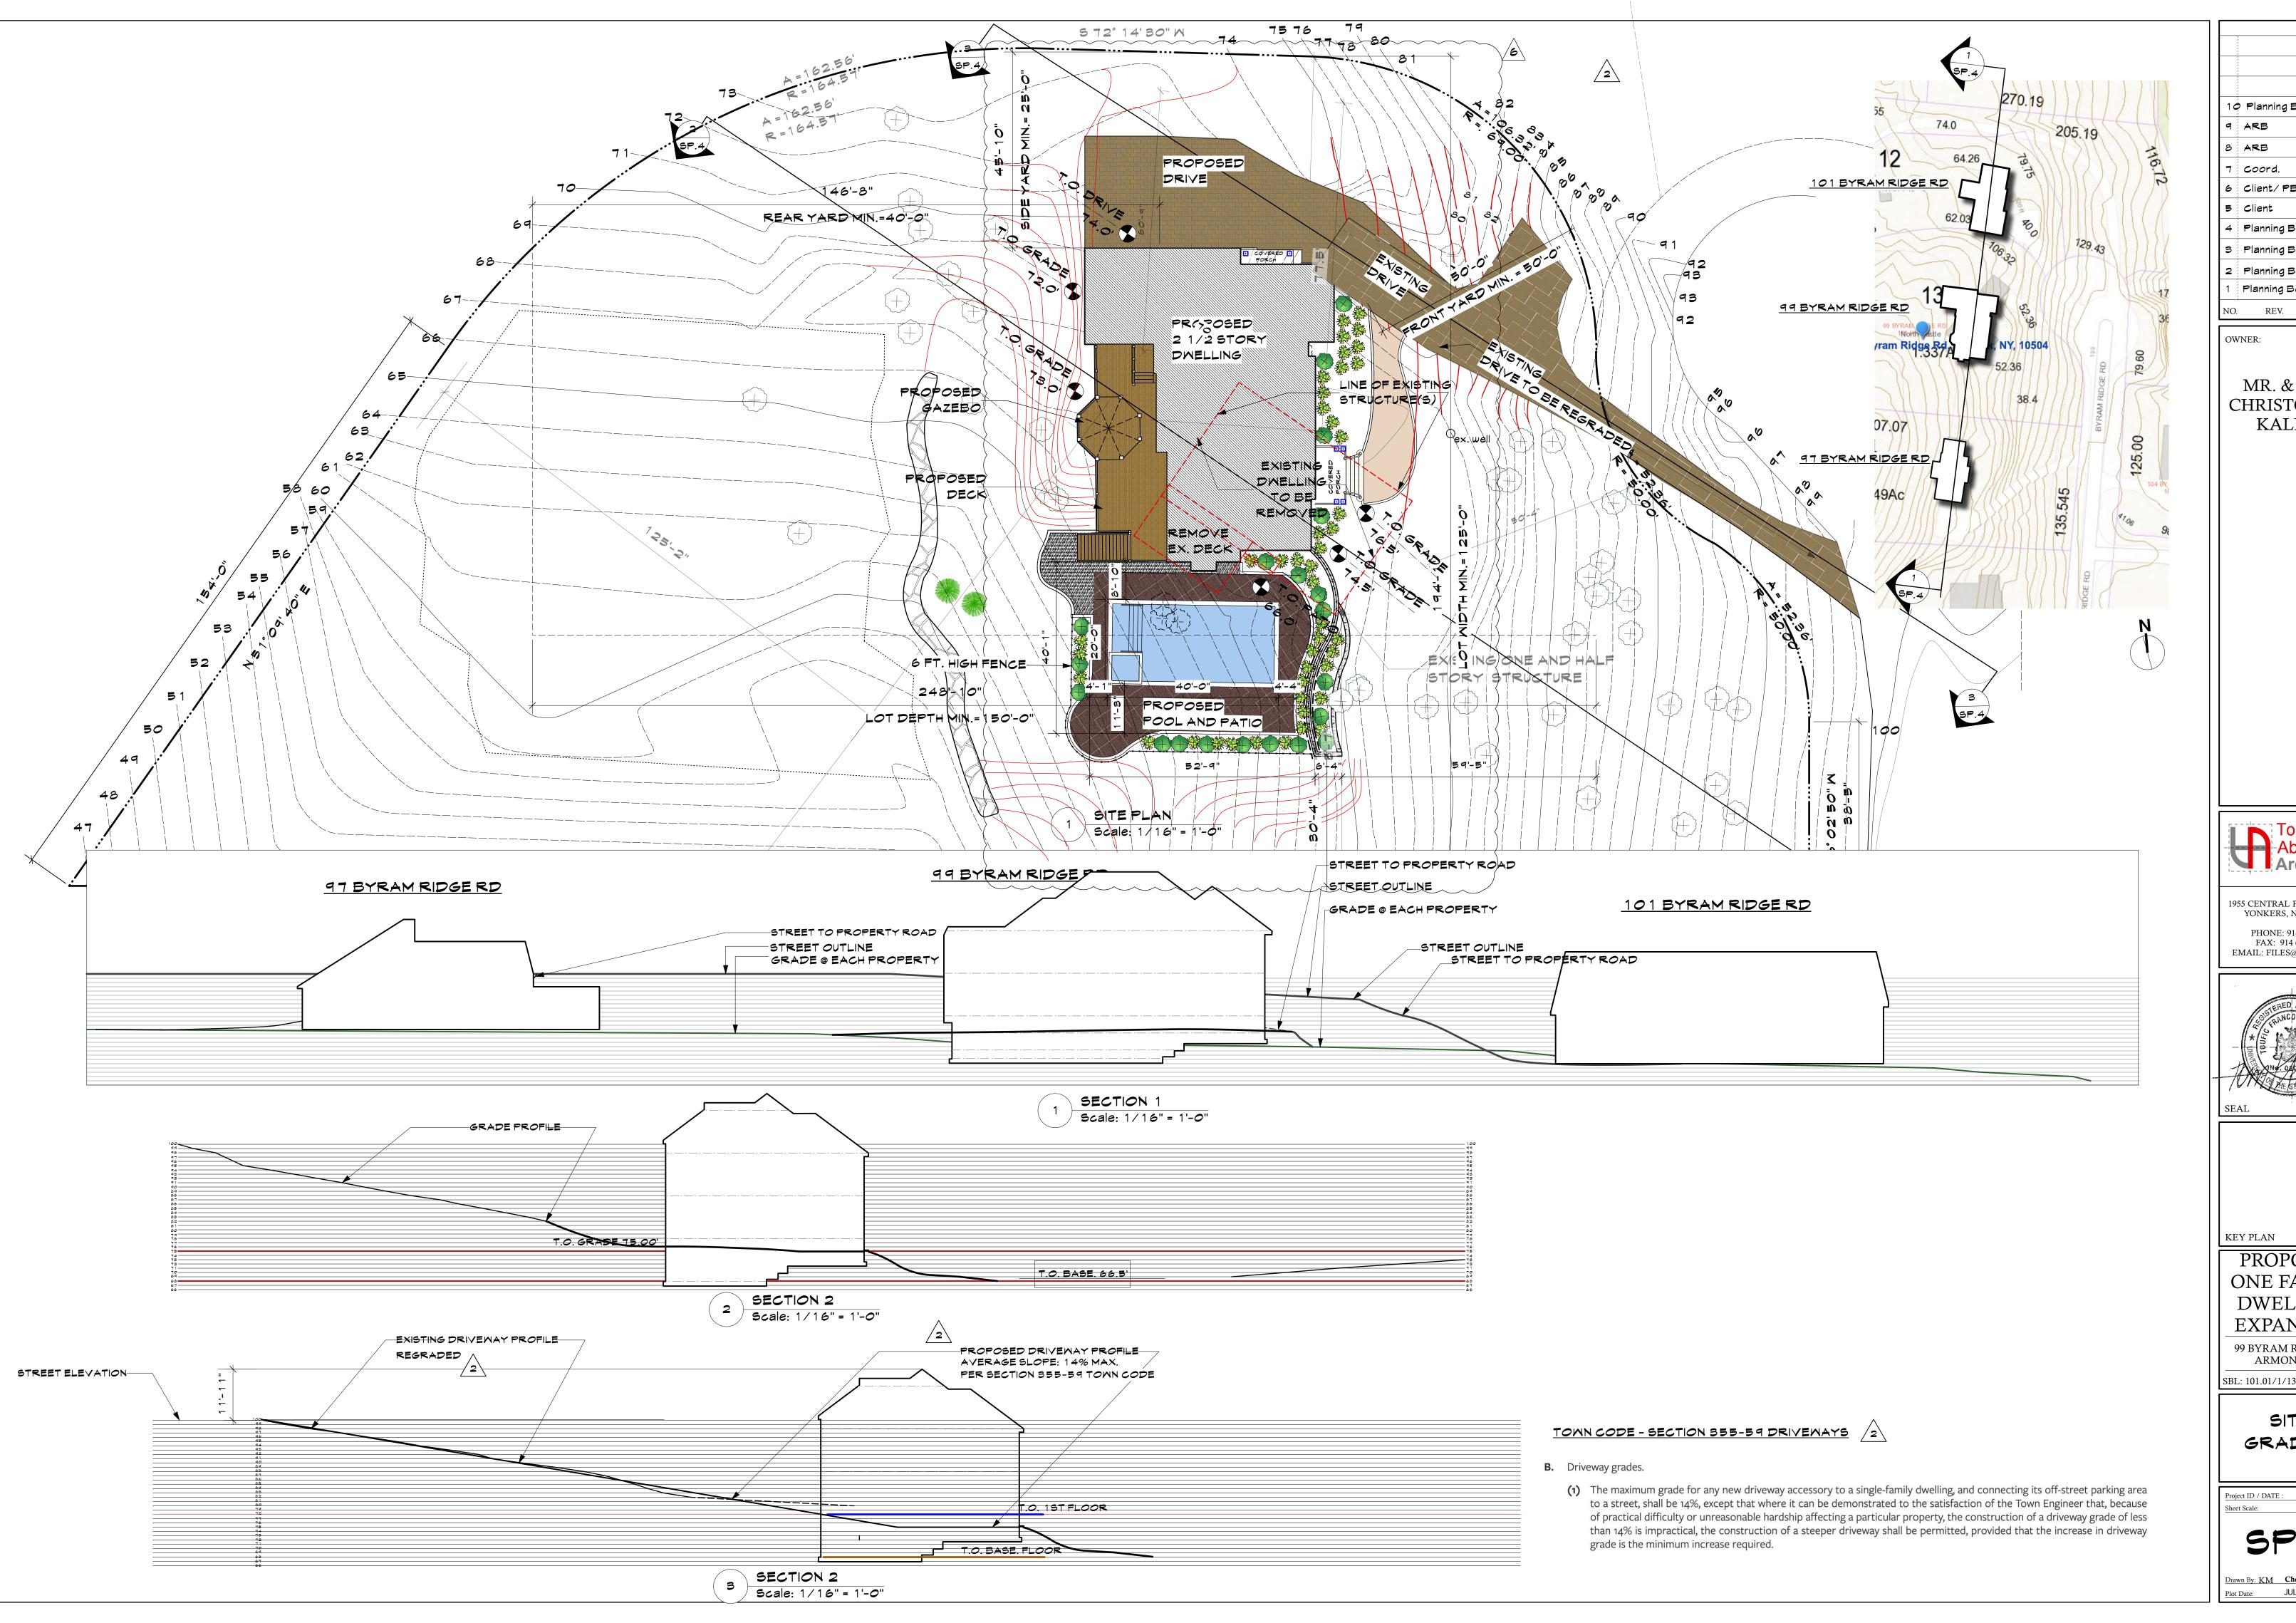

10 Planning Bd. 9.10.2 7.19.2 7.09.2 6 Client/PB 5 Client 4 Planning Bd 5.21.2 3 Planning Bd 5.10.2 Planning Bd 3.10.21

OWNER:

MR. & MRS. CHRISTOPHER KALIAN

1955 CENTRAL PARK AVENUE YONKERS, NEW YORK PHONE: 914 6684673 FAX: 914 668 1831 EMAIL: FILES@TFARA.COM



KEY PLAN


PROPOSED ONE FAMILY **DWELLING EXPANSION** 99 BYRAM RIDGE RD., ARMONK, N.Y

SBL: 101.01/1/13 ZONE: R-1A

SITE GRADING

Project ID / DATE : 2048/ 10.15.2020

Drawn By: KM Checked By: TFA JULY 19.2021

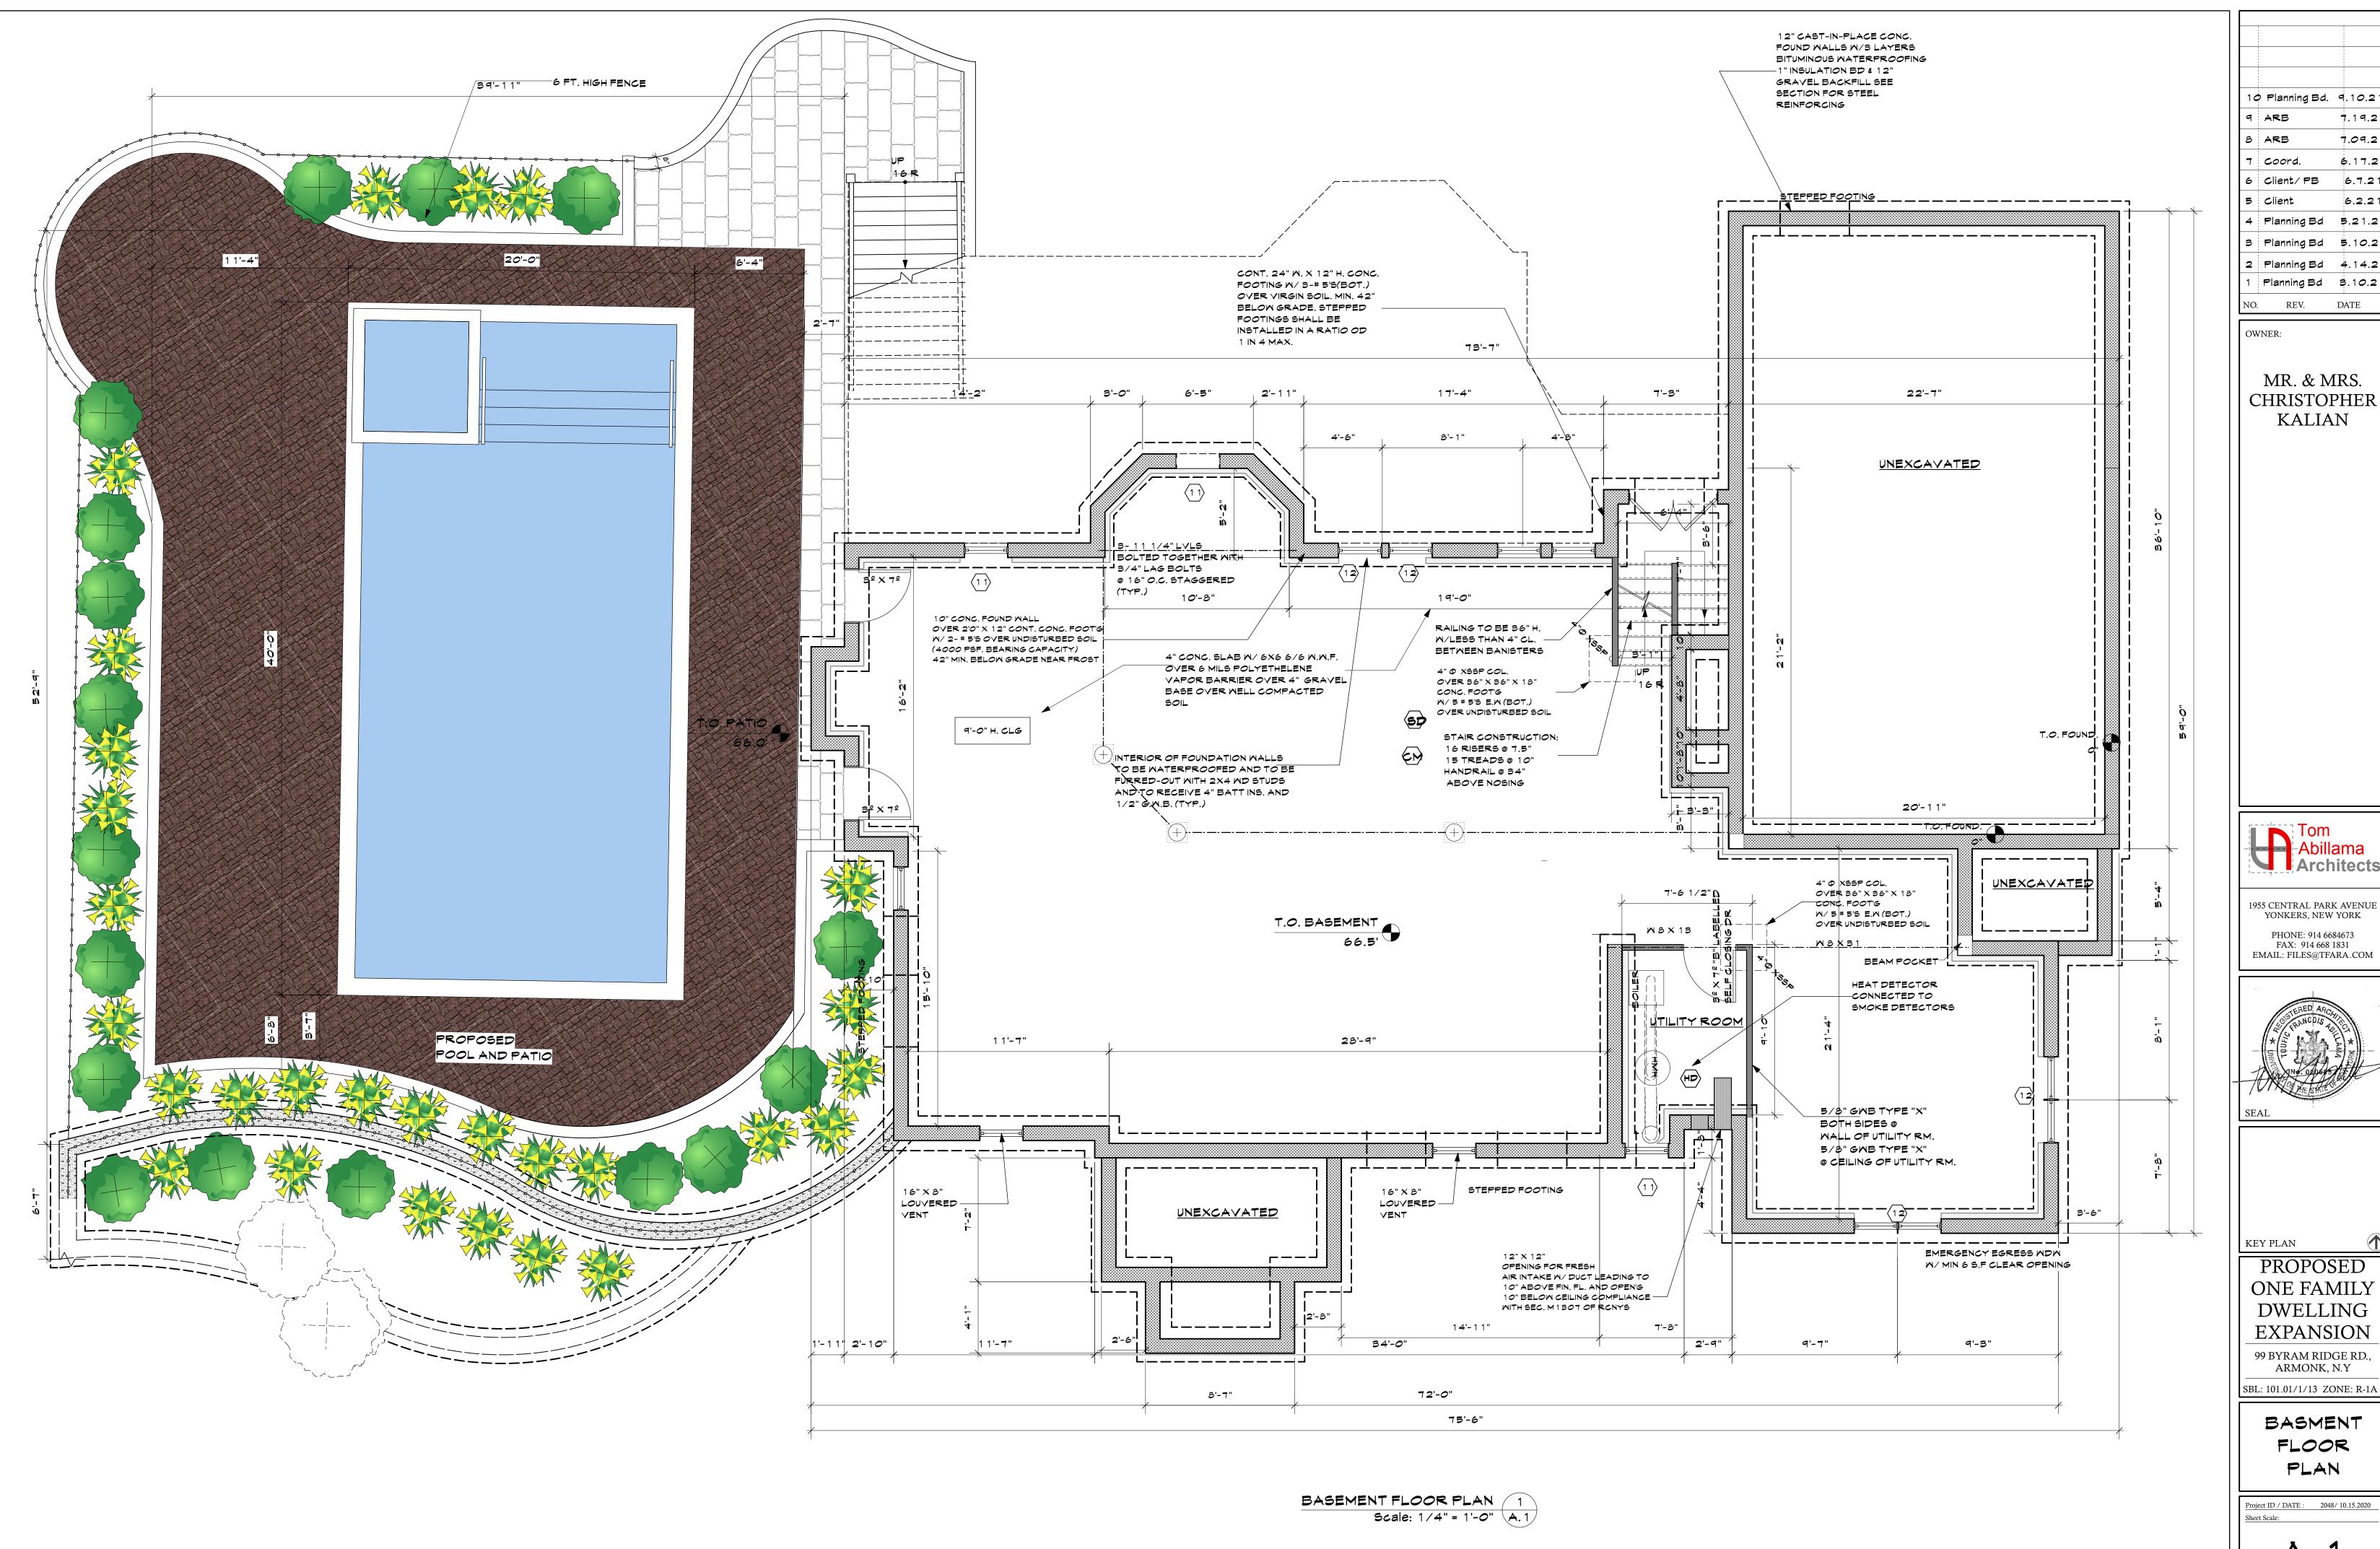

10 Planning Bd. 9.10.21 7.19.2 7.09.2 8 ARB 6.17.2 Coord. 6 Client/PB 6.7.21 5 Client 6.2.21 4 Planning Bd 5.21.2 3 Planning Bd 5.10.2 2 Planning Bd 4.14.2 Planning Bd \$.10.21

> MR. & MRS. CHRISTOPHER KALIAN

Architects

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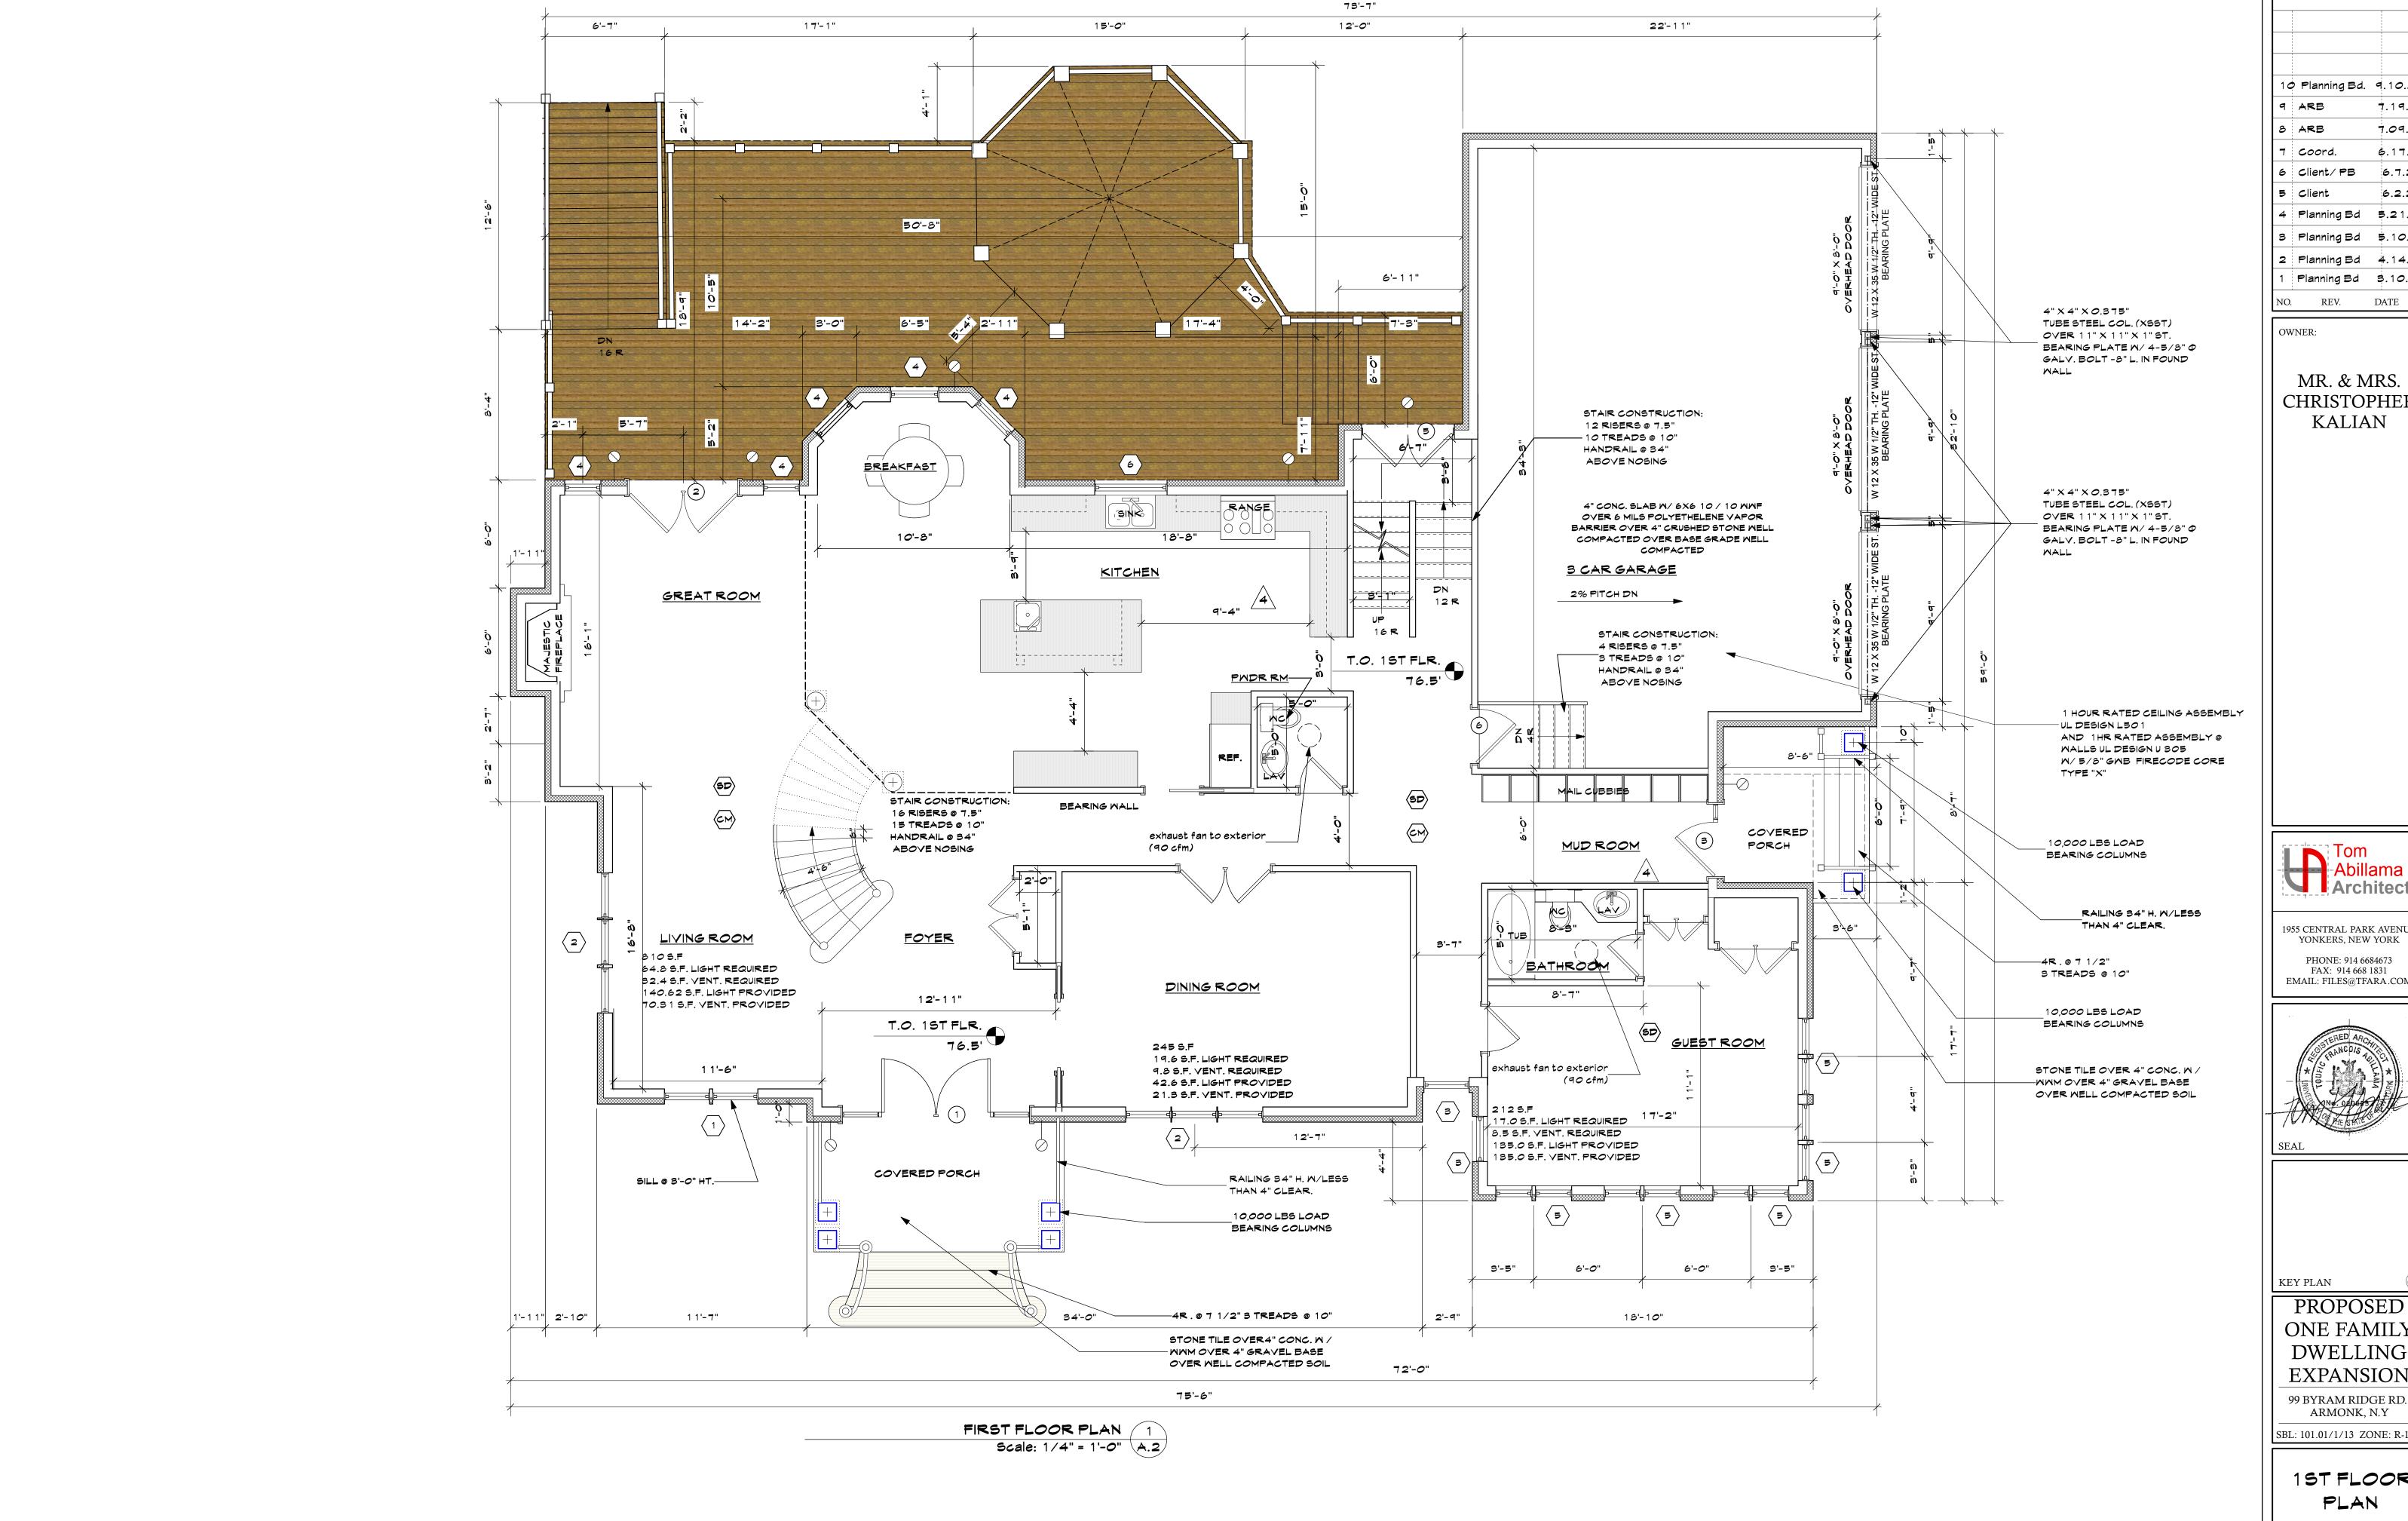
KEY PLAN

PROPOSED ONE FAMILY **DWELLING EXPANSION** 99 BYRAM RIDGE RD., ARMONK, N.Y

> BASMENT FLOOR PLAN

Project ID / DATE : 2048/ 10.15.2020

Drawn By: KM Checked By: TFA JULY 19.2021



10 Planning Bd. 9.10.21 7.19.2 7.09.2 8 ARB 6.17.2 7 Coord. 6 Client/PB 6.7.21 5 Client 4 Planning Bd 5.21.2 3 Planning Bd 5.10.2 2 Planning Bd 4.14.2 Planning Bd 3.10.21

OWNER:

MR. & MRS. CHRISTOPHER KALIAN

Tom
Abillama
Architects

1955 CENTRAL PARK AVENUE YONKERS, NEW YORK PHONE: 914 6684673 FAX: 914 668 1831 EMAIL: FILES@TFARA.COM

KEY PLAN

PROPOSED ONE FAMILY **DWELLING EXPANSION** 99 BYRAM RIDGE RD., ARMONK, N.Y


SBL: 101.01/1/13 ZONE: R-1A

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1ST FLOOR PLAN

Project ID / DATE : 2048/ 10.15.2020

Drawn By: KM Checked By: TFA Plot Date: JULY 19.2021

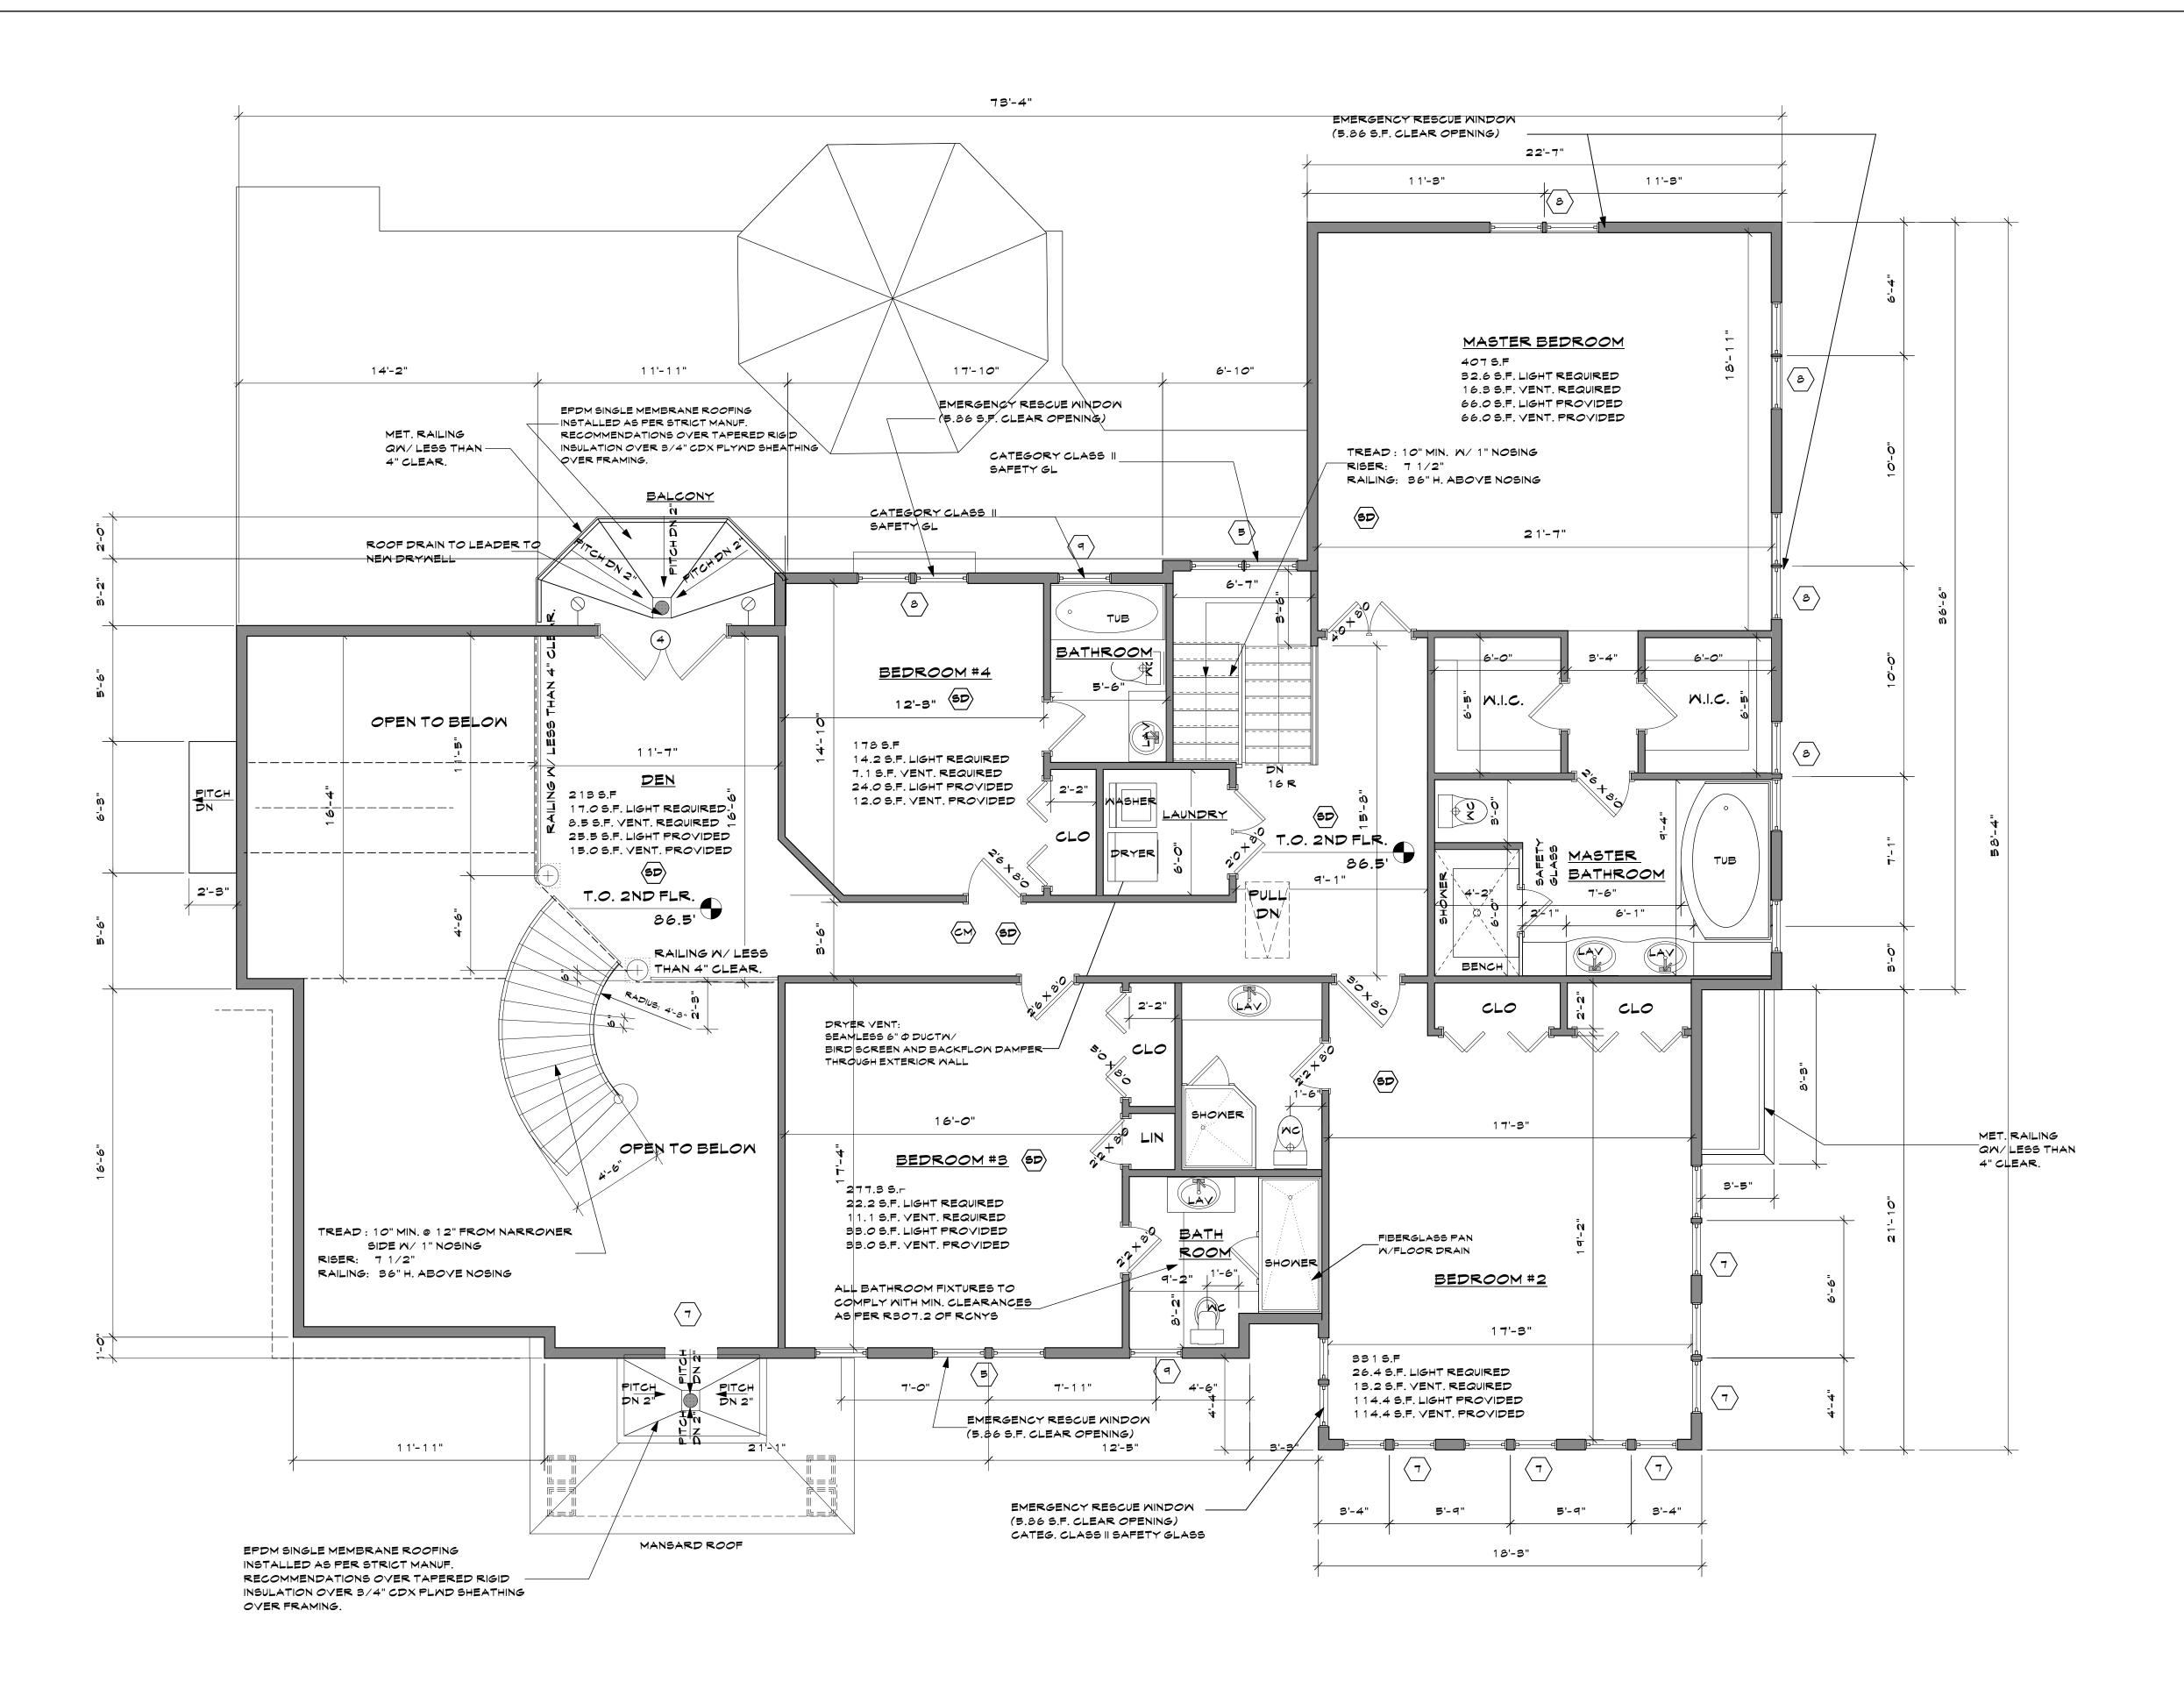

SECOND FLOOR PLAN 1 Scale: 1/4" = 1'-0" A.3 10 Planning Bd. 9.10.21
9 ARB 7.19.21
8 ARB 7.09.21
7 Coord. 6.17.21
6 Client/PB 6.7.21
5 Client 6.2.21
4 Planning Bd 5.21.21
3 Planning Bd 5.10.21
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1 Planning Bd 3.10.21
NO. REV. DATE


OWNER:

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FAX: 914 668 1831
EMAIL: FILES@TFARA.COM



KEY PLAN

PROPOSED
ONE FAMILY
DWELLING
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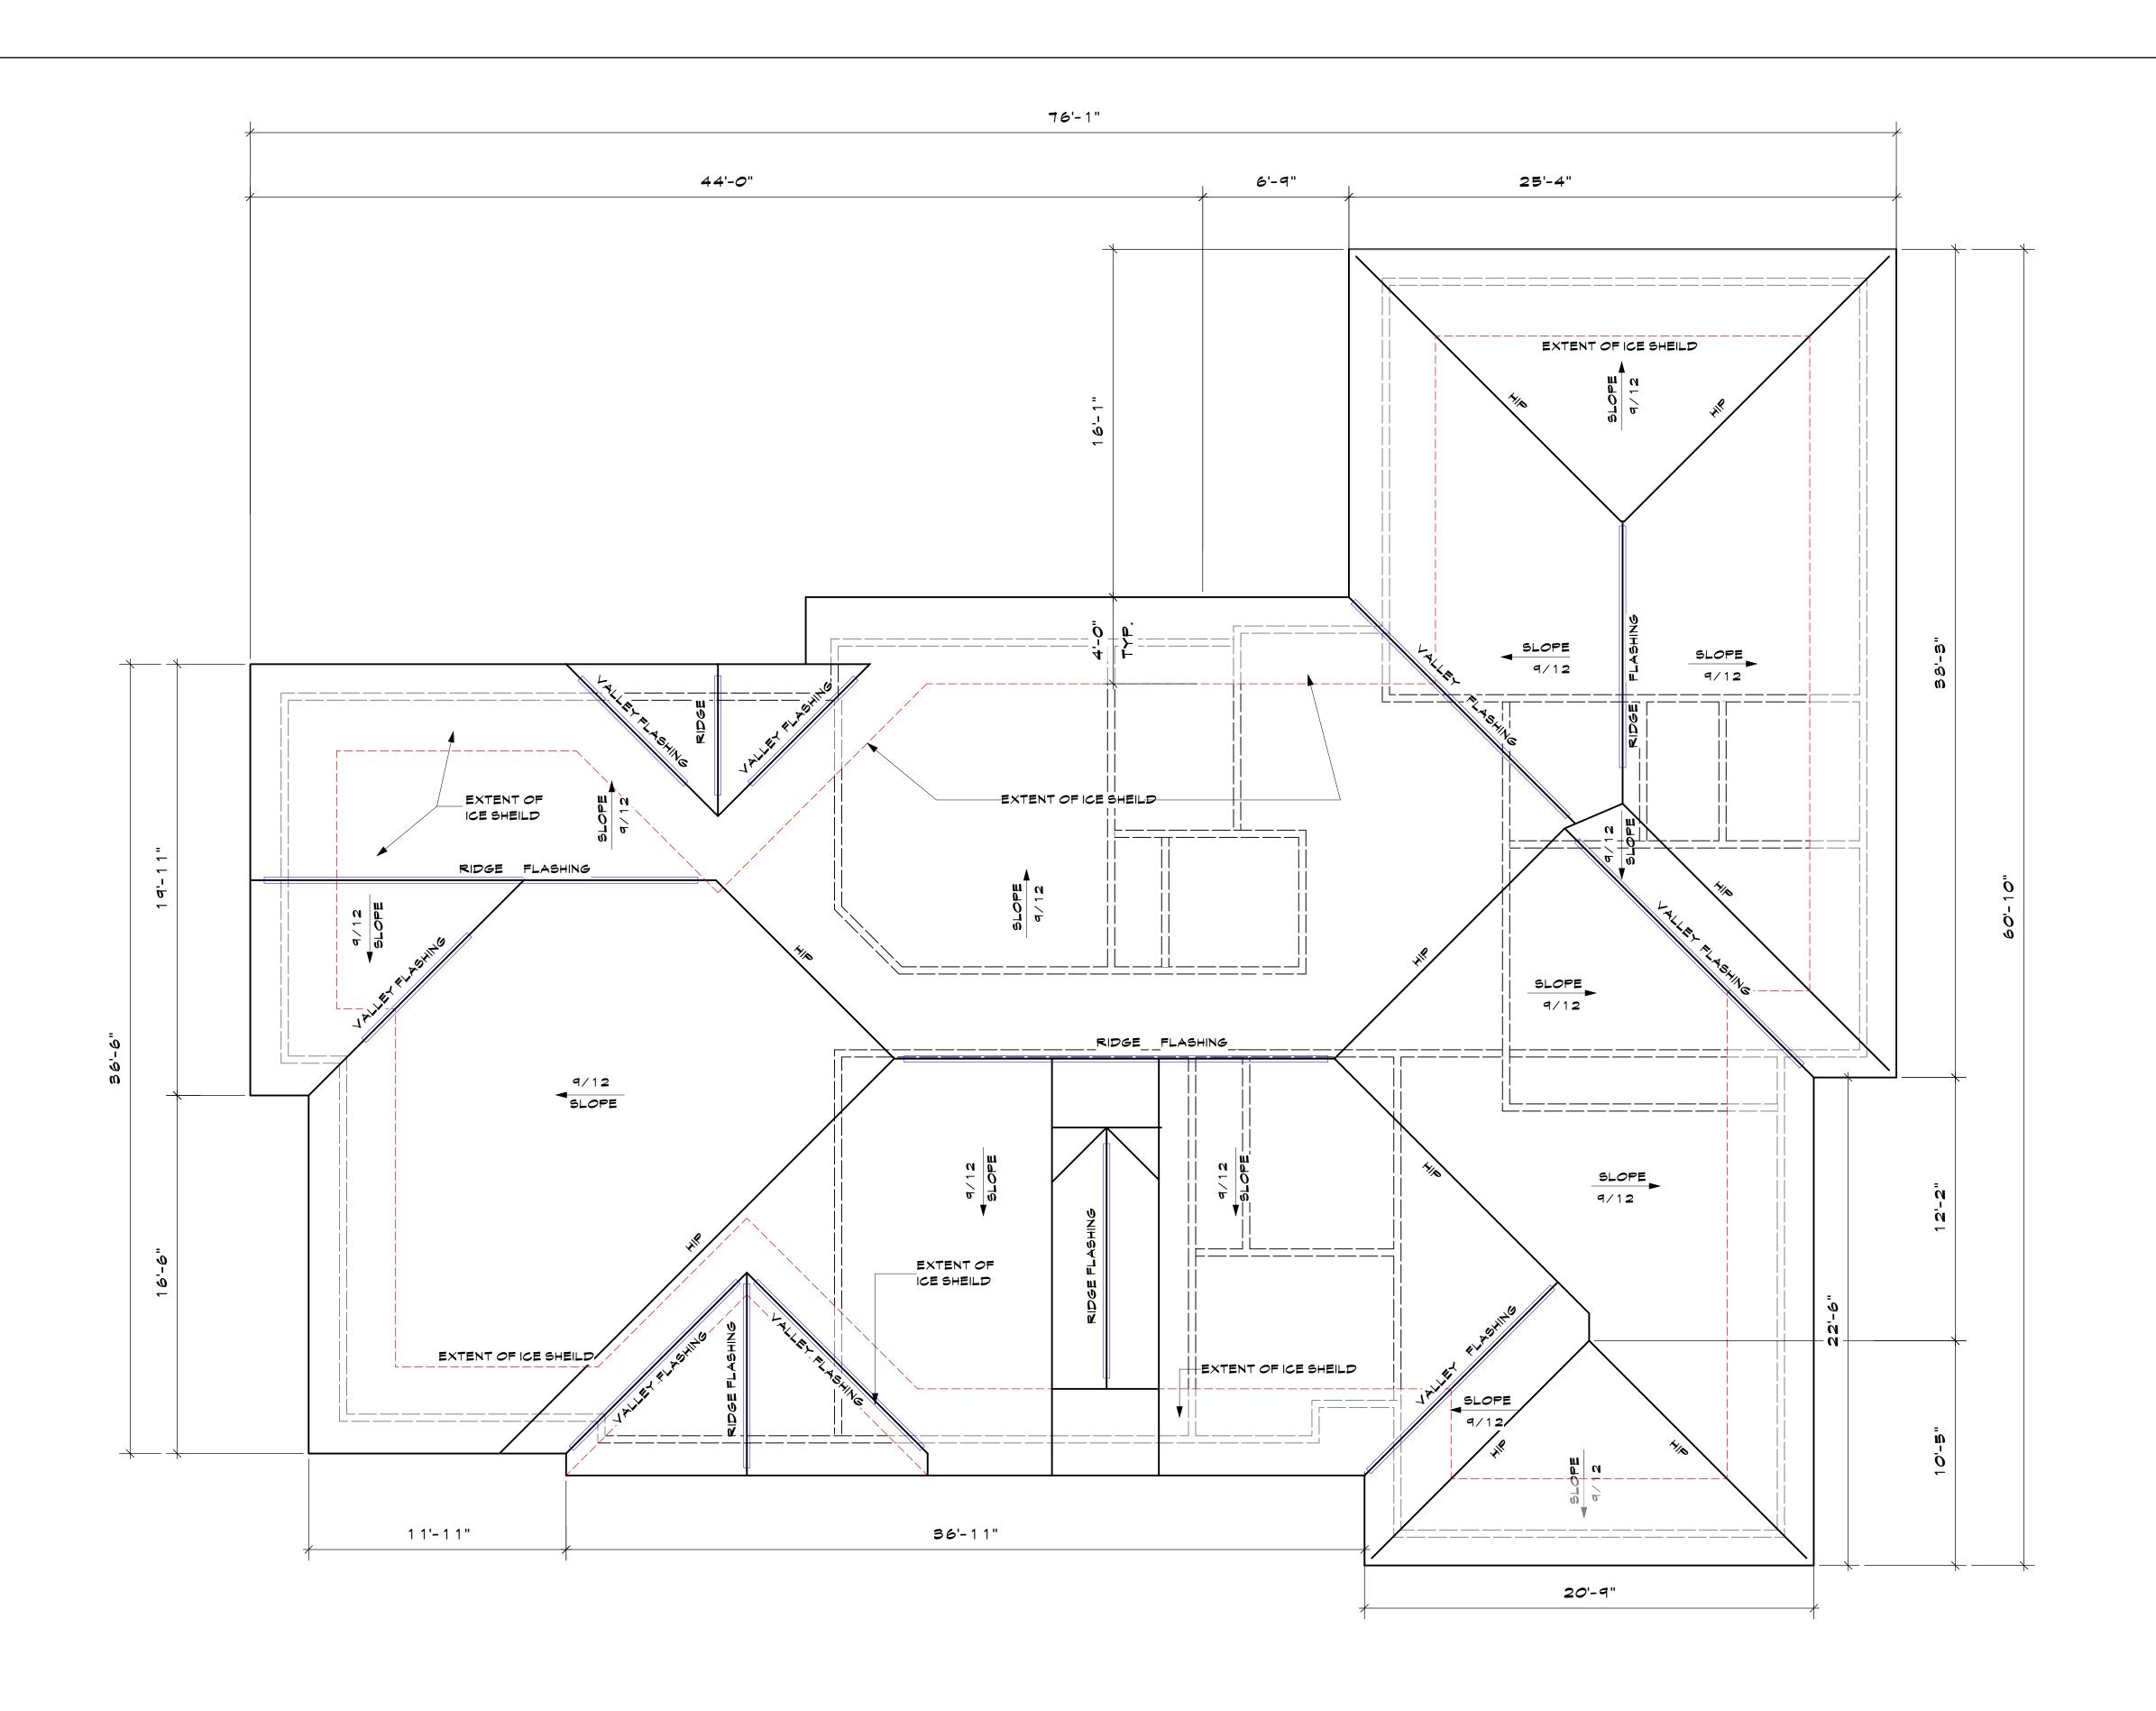
99 BYRAM RIDGE RD.,
ARMONK, N.Y

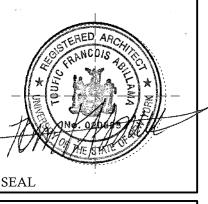SBL: 101.01/1/13 ZONE: R-1A

2ND FLOOR PLAN

Project ID / DATE : 2048/ 10.15.2020

Sheet Scale:





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9	ARB	7.19.21
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7	Coord.	6.17.21
6	Client/PB	6.7.21
5	Client	6.2.21
4	Planning Bd	5.21.21
3	Planning Bd	5 .1 <i>0</i> .21
2	Planning Bd	4.14.21
1	Planning Bd	3.1 <i>0</i> .21
NO.	REV.	DATE

OWNER:

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KEY PLAN

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ONE FAMILY
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99 BYRAM RIDGE RD.,
ARMONK, N.Y


ARMONK, N.Y


SBL: 101.01/1/13 ZONE: R-1A

ROOF PLAN

Project ID / DATE : 2048/ 10.15.2020

A 4

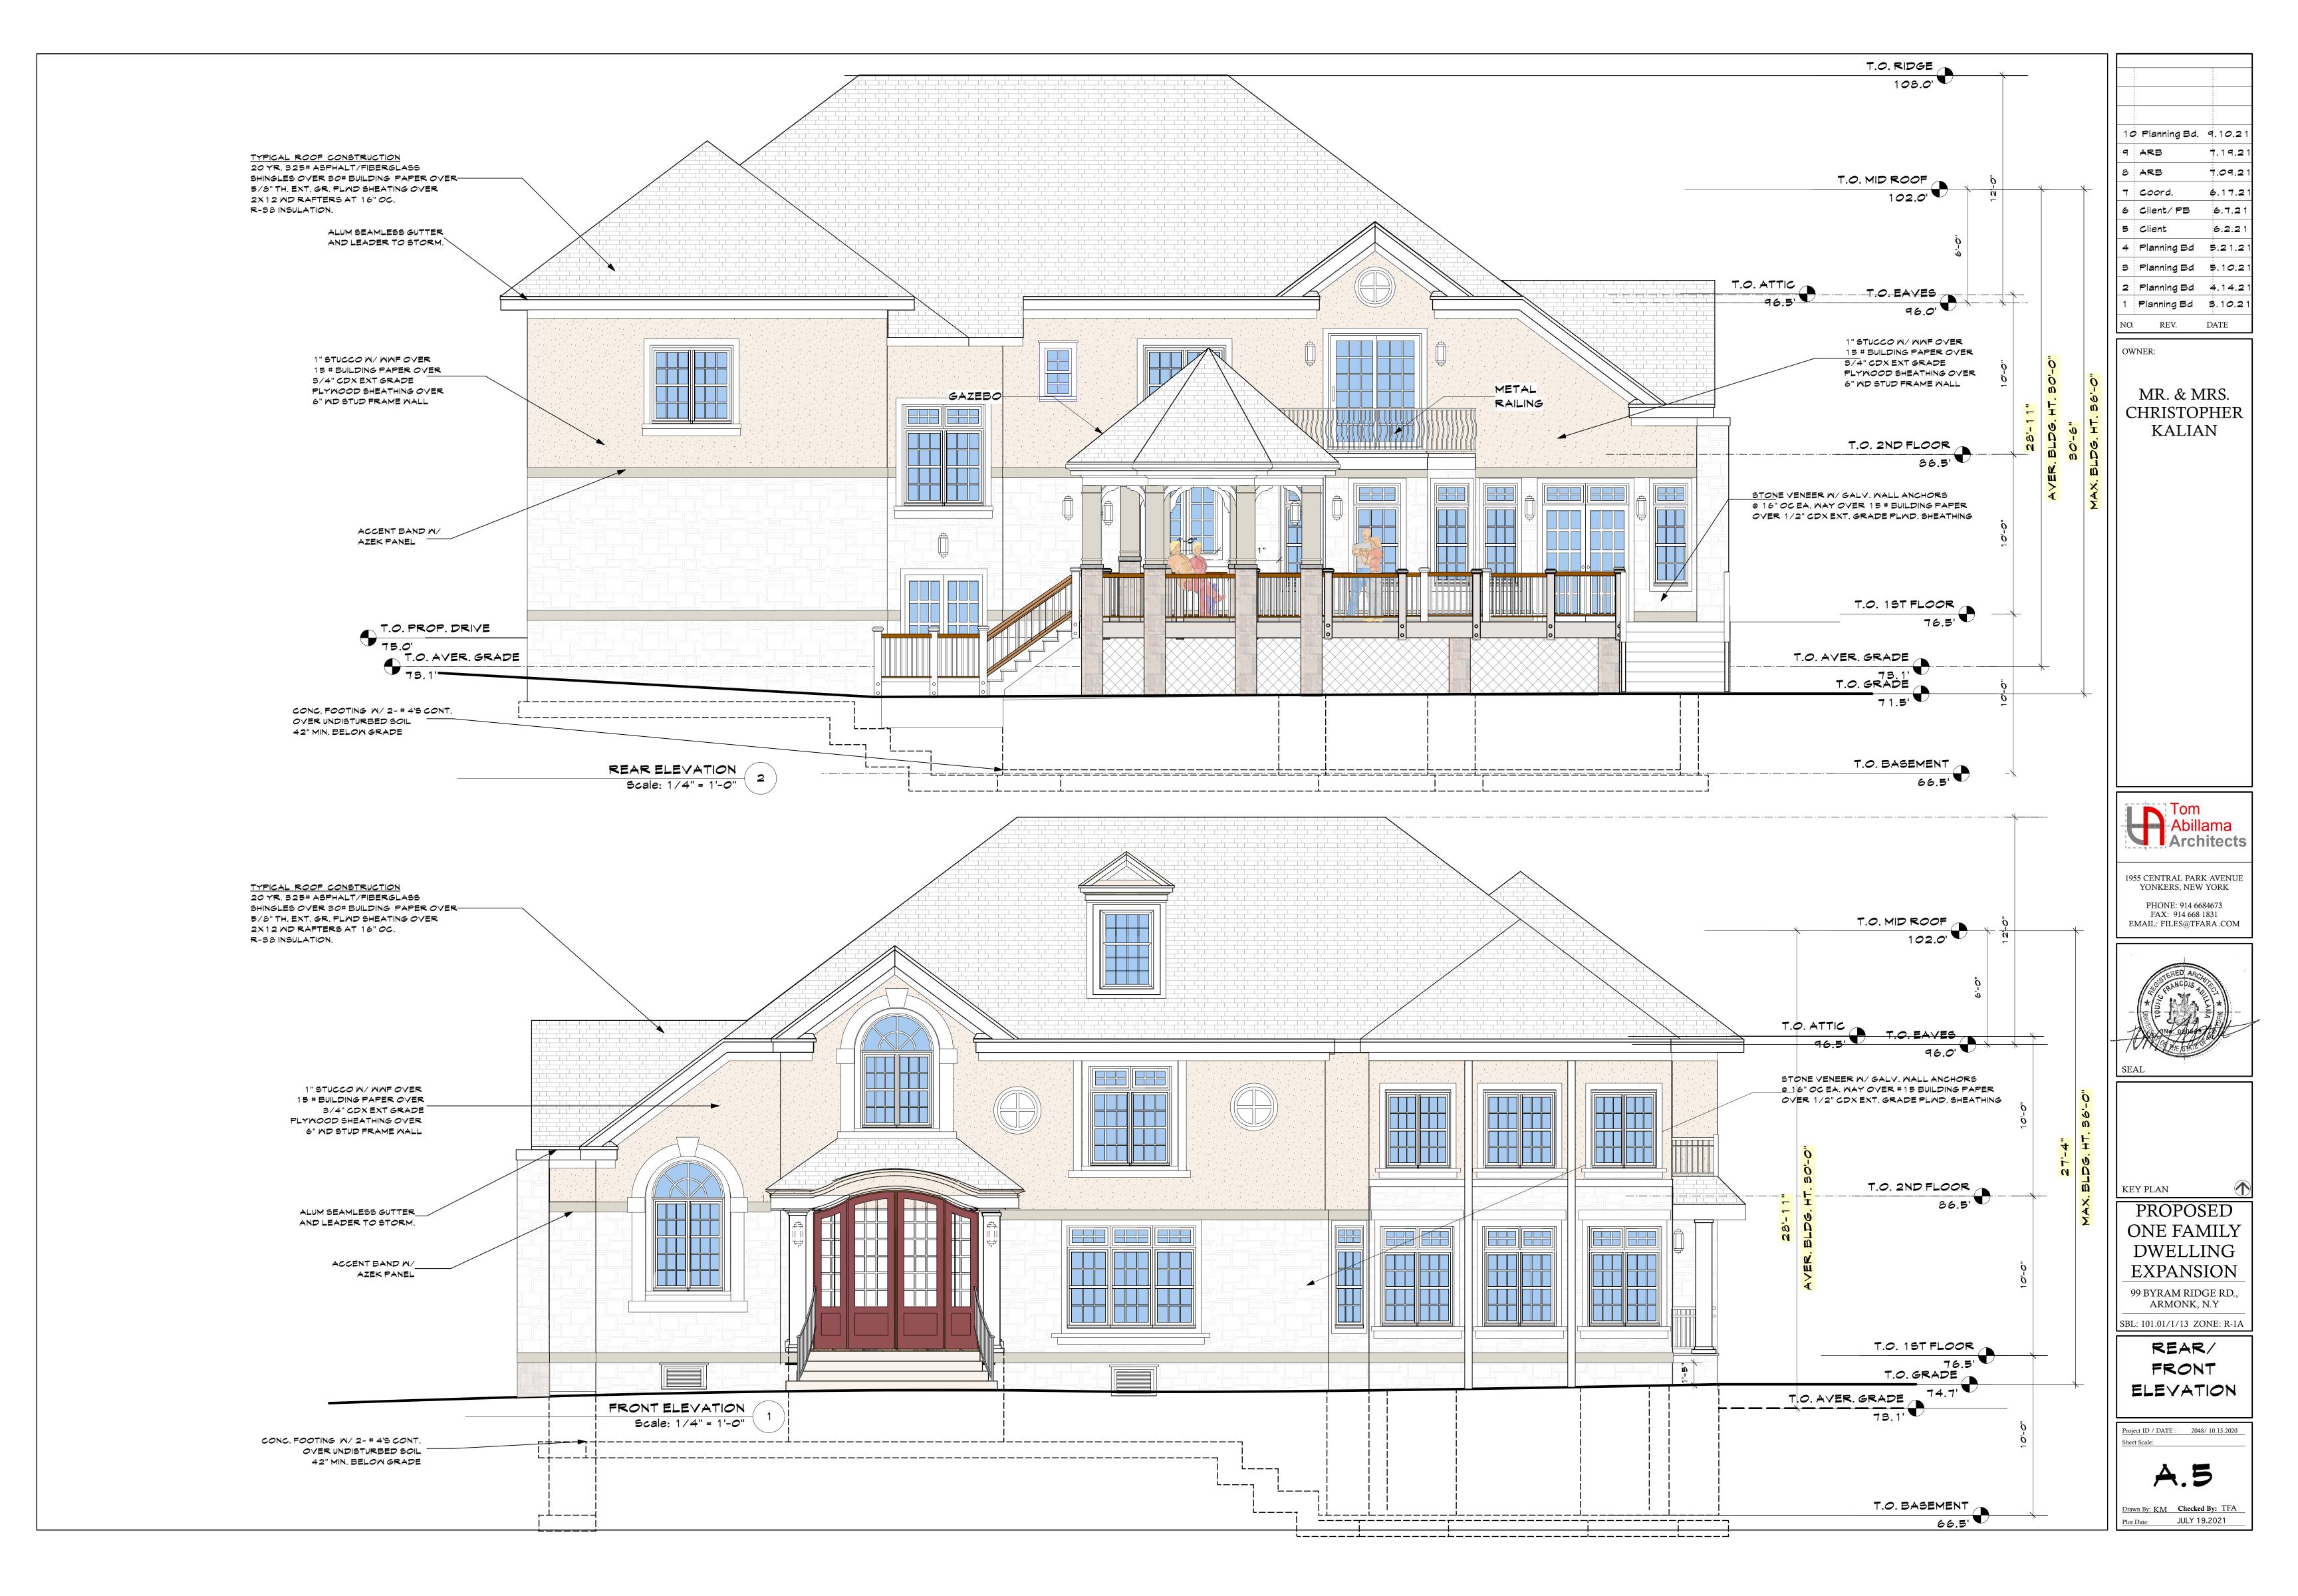

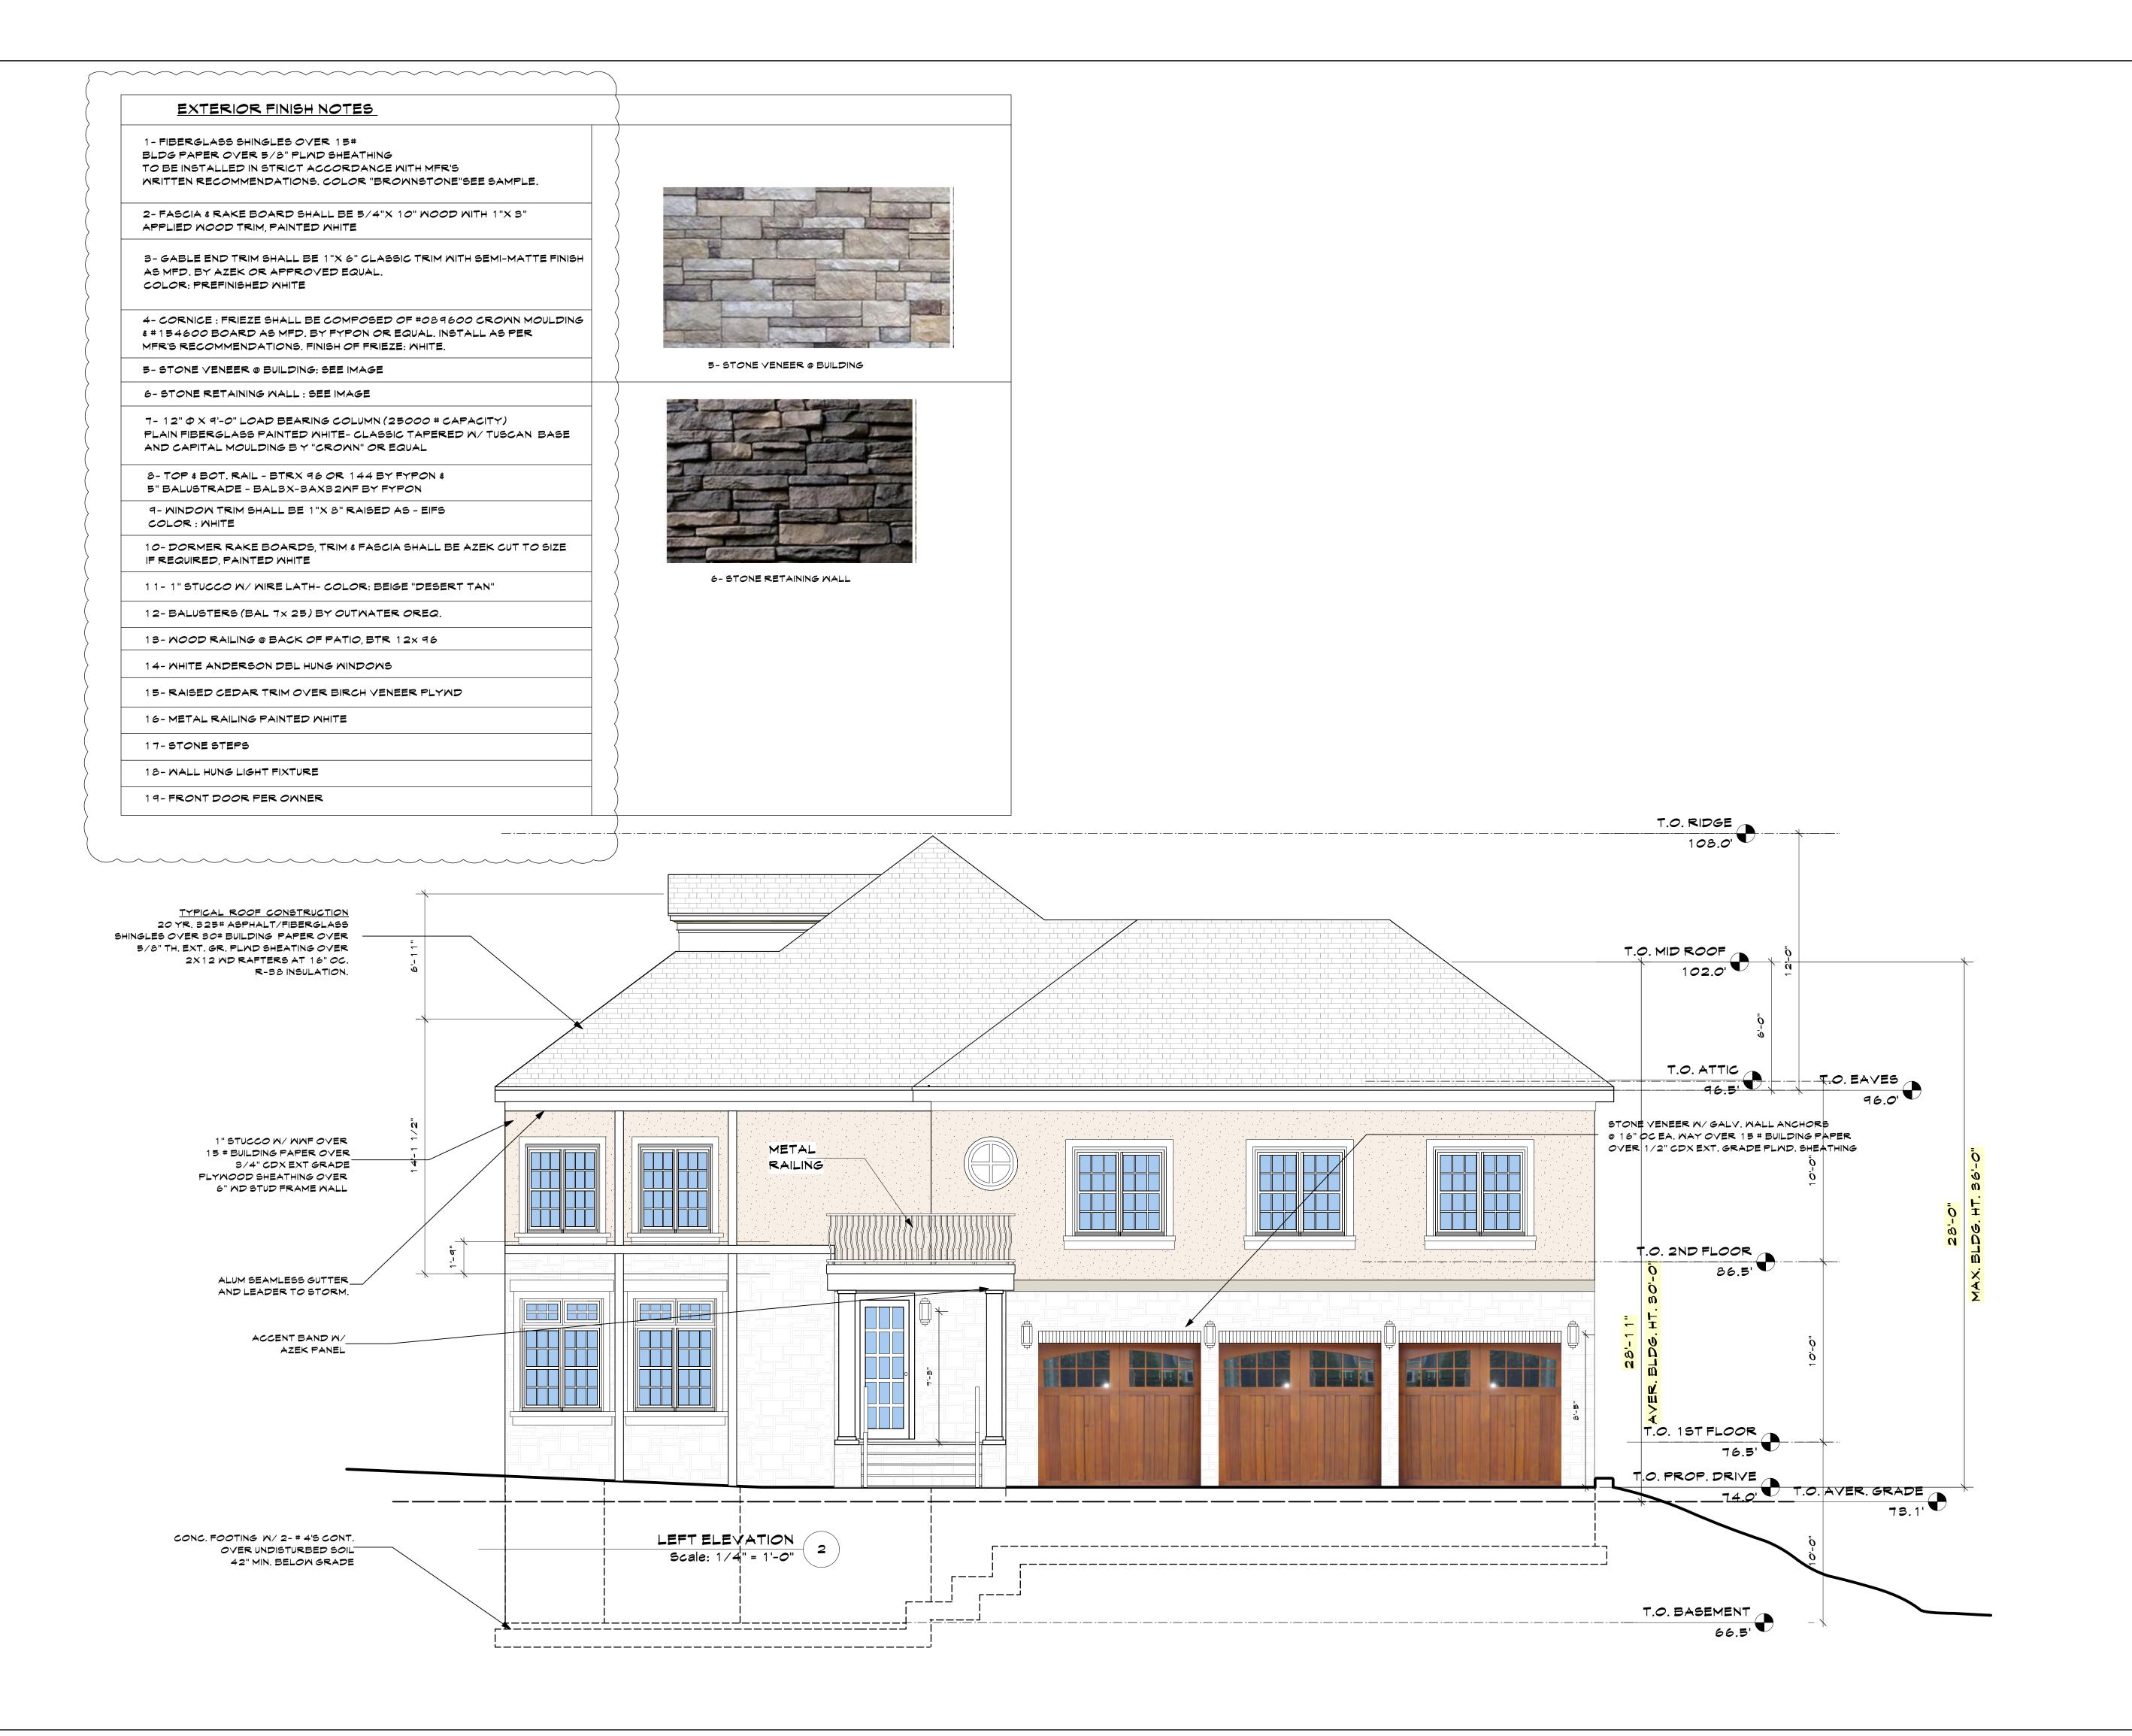

10 Planning Bd. 9.10.21
9 ARB 7.19.21
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NO. REV. DATE

OWNER:

MR. & MRS. CHRISTOPHER KALIAN



1955 CENTRAL PARK AVENUE YONKERS, NEW YORK

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FAX: 914 668 1831
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KEY PLAN

PROPOSED
ONE FAMILY
DWELLING
EXPANSION


99 BYRAM RIDGE RD., ARMONK, N.Y

SBL: 101.01/1/13 ZONE: R-1A

RIGHT SIDE ELEVATION

Project ID / DATE : 2048/ 10.15.2020



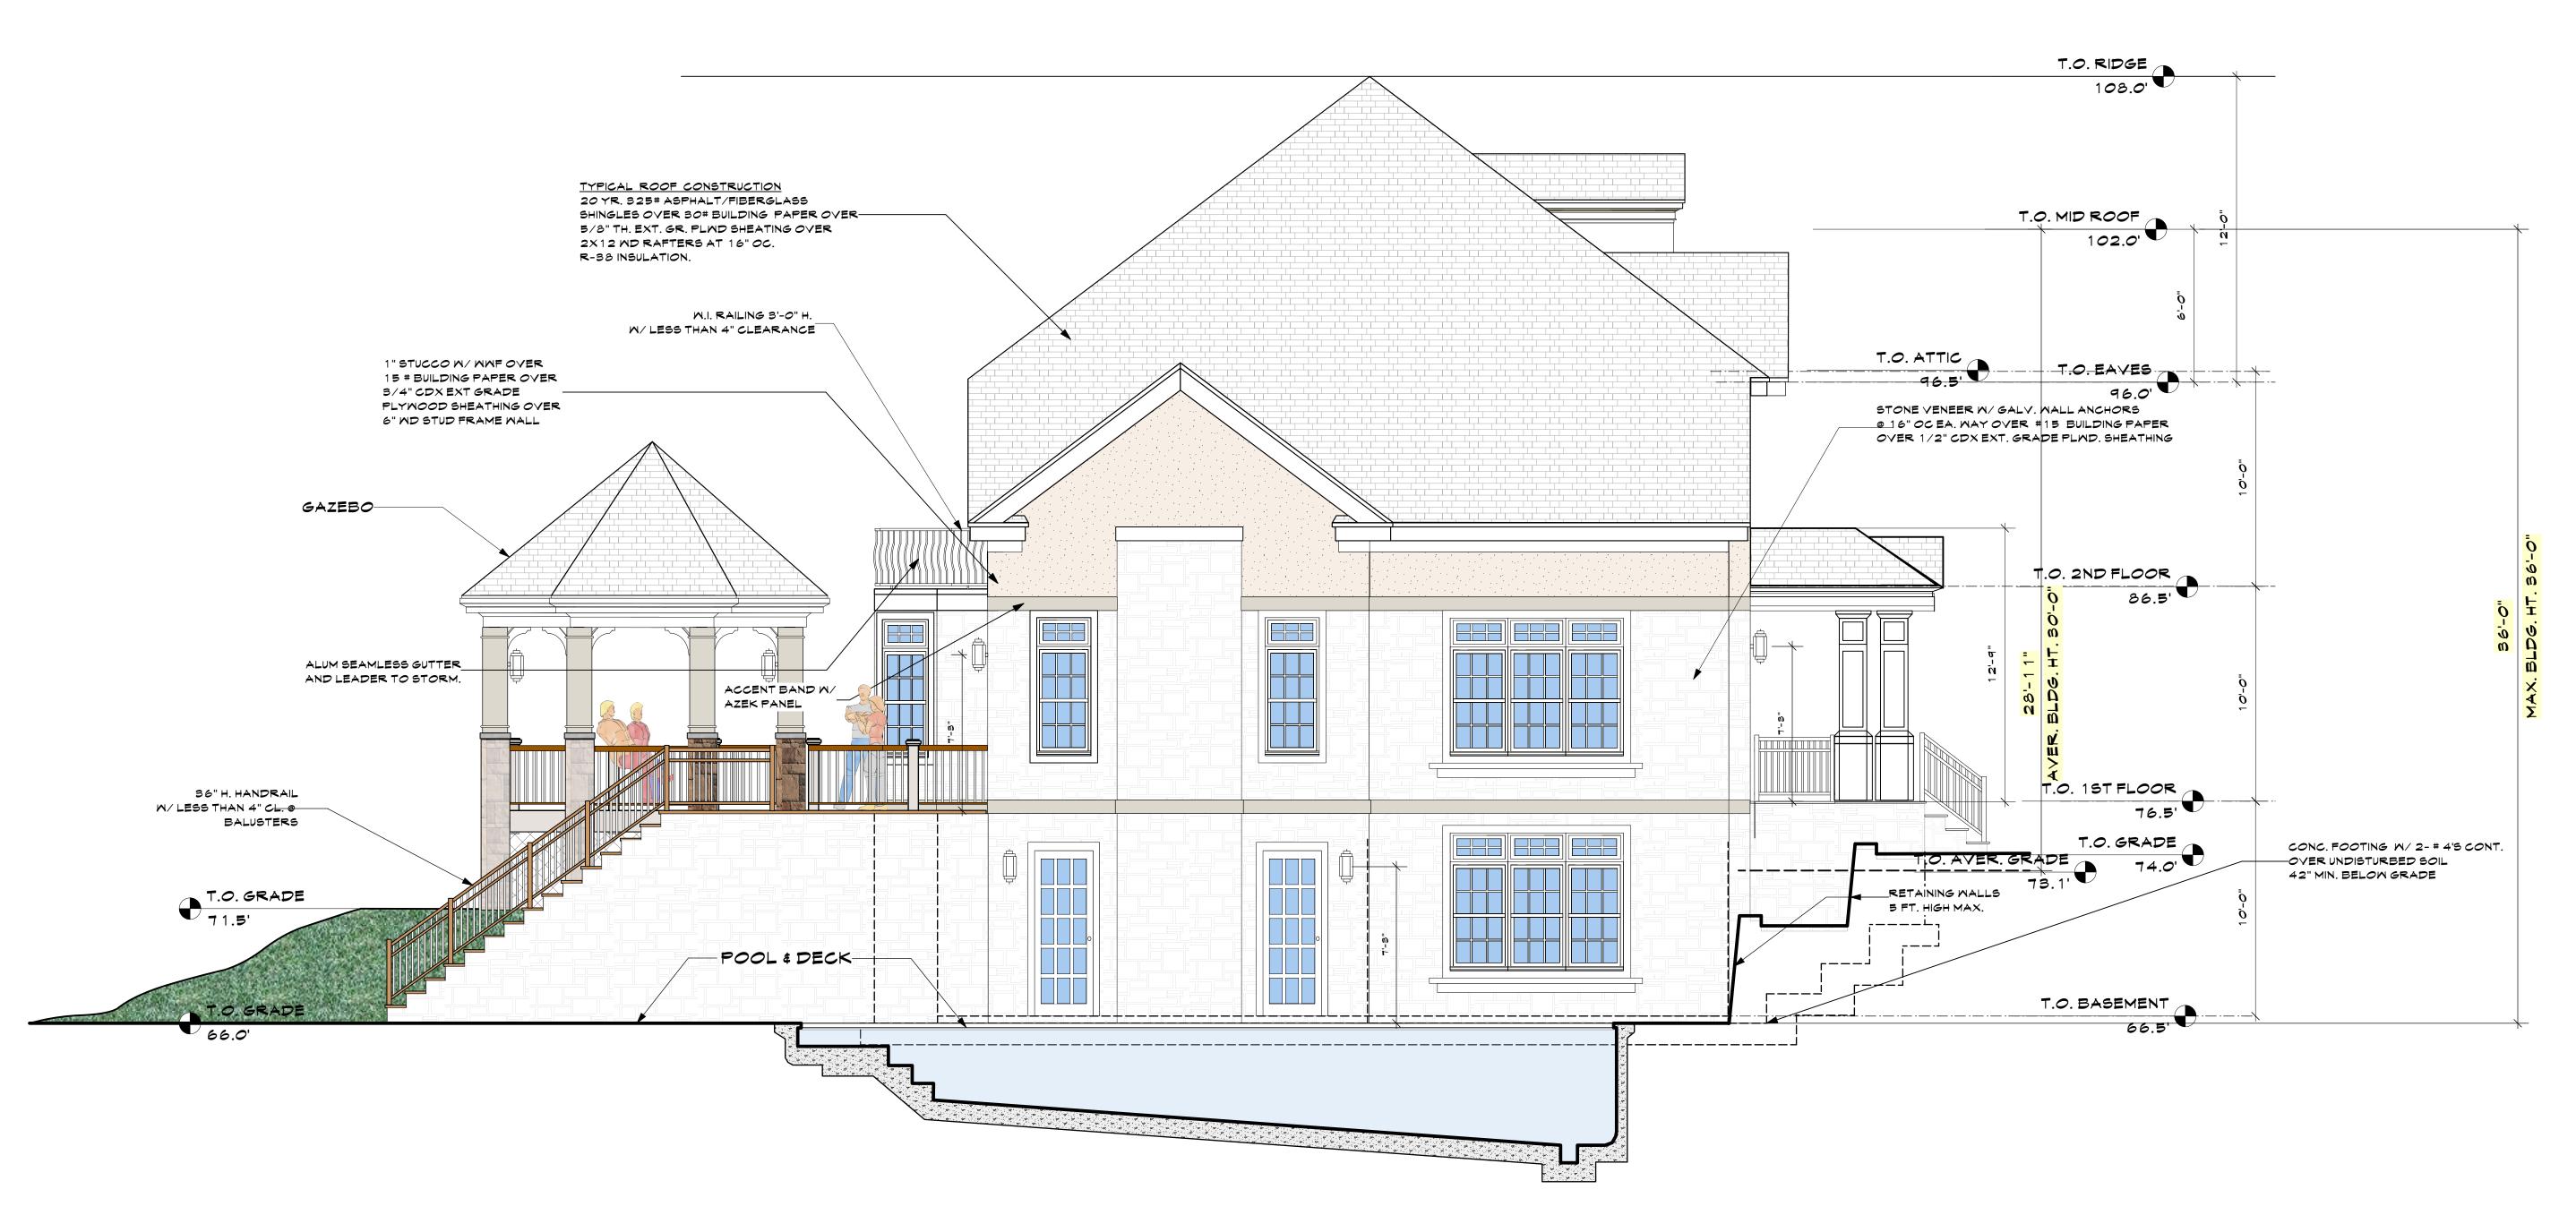

RIGHT SIDE ELEVATION
Scale: 1/4" = 1'-0"

10	Planning Bd.	9.10.21
9	ARB	7.19.2
8	ARB	7.09.2
7	Coord.	6.17.2
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2	Planning Bd	4.14.2
1	Planning Bd	3.10.2
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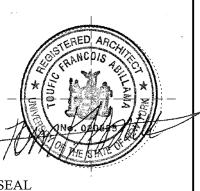
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KEY PLAN

PROPOSED
ONE FAMILY
DWELLING
EXPANSION

99 BYRAM RIDGE RD.,
ARMONK, N.Y


SBL: 101.01/1/13 ZONE: R-1A

LEFT SIDE ELEVATION

Project ID / DATE : 2048/ 10.15.2020

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10 Planning Bd. 9.10.21
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OWNER:

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KEY PLAN

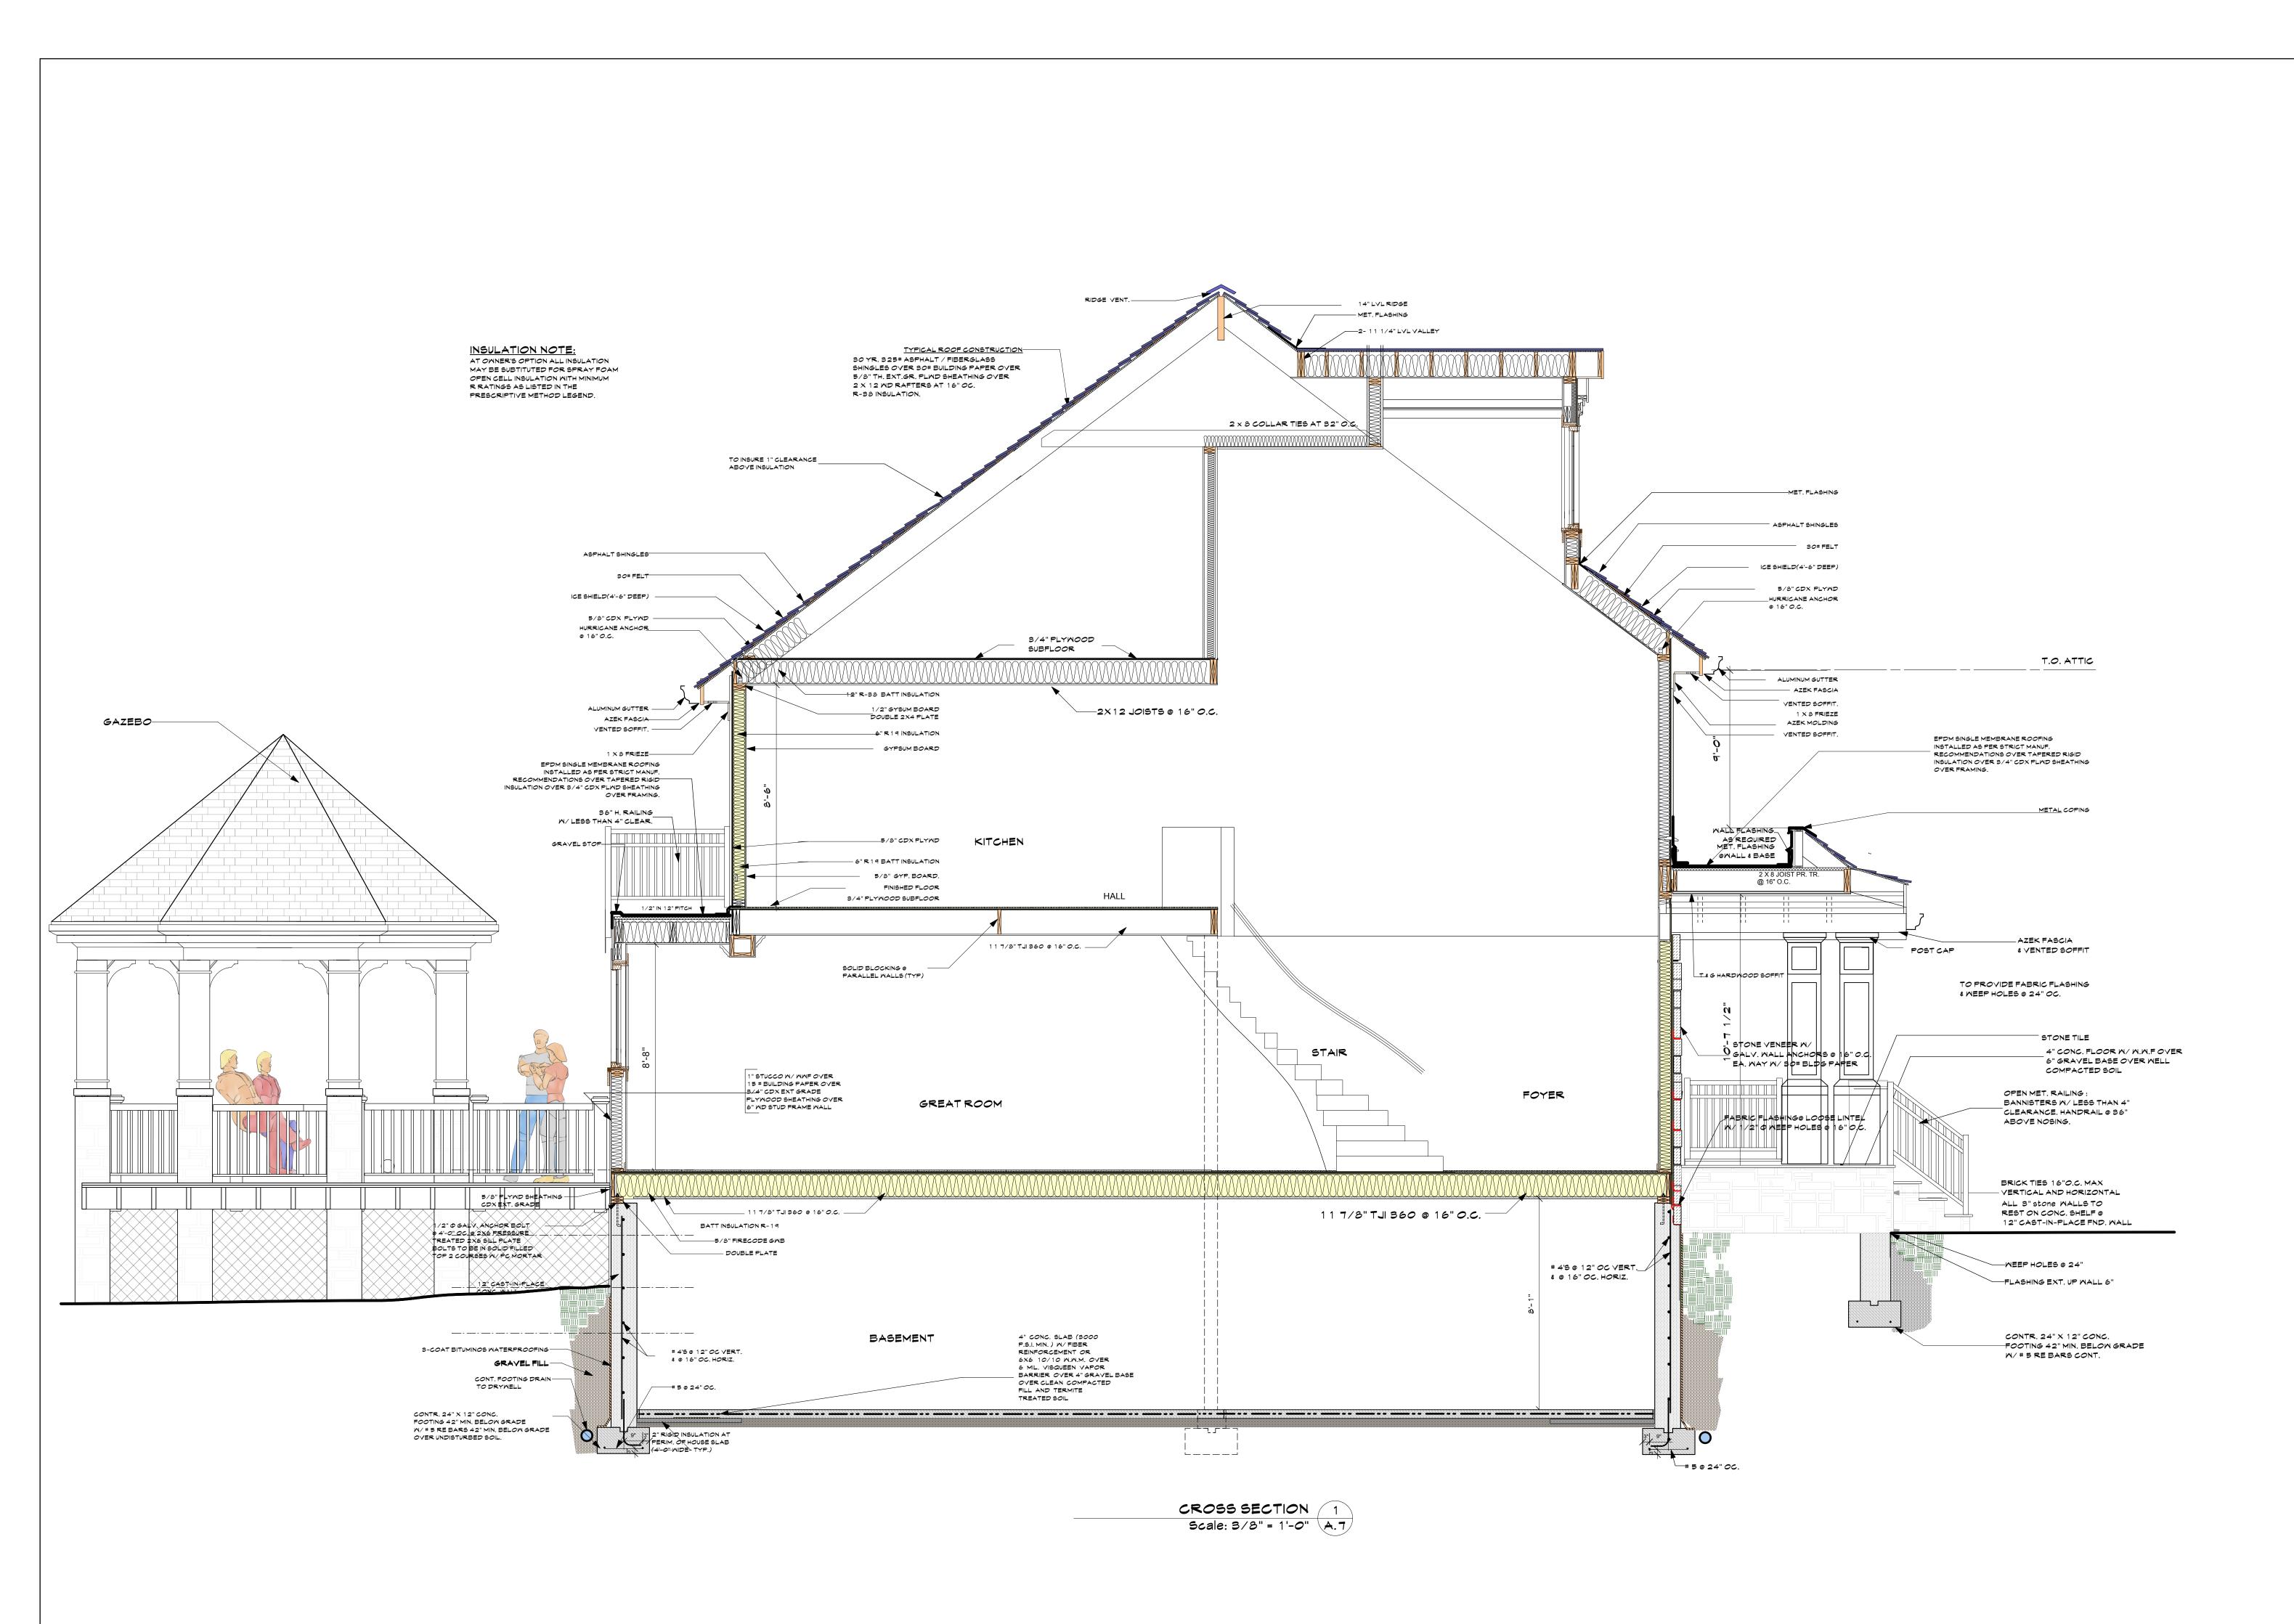PROPOSED
ONE FAMILY
DWELLING
EXPANSION
99 BYRAM RIDGE RD.,
ARMONK, N.Y

CROSS


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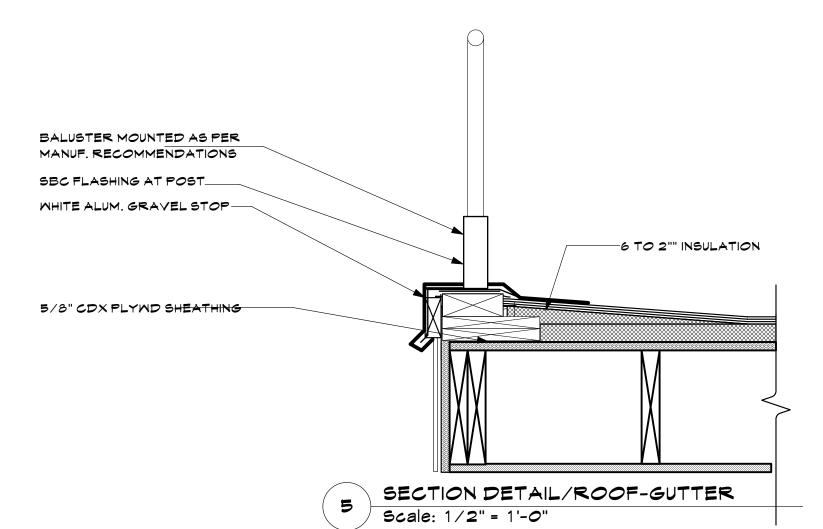
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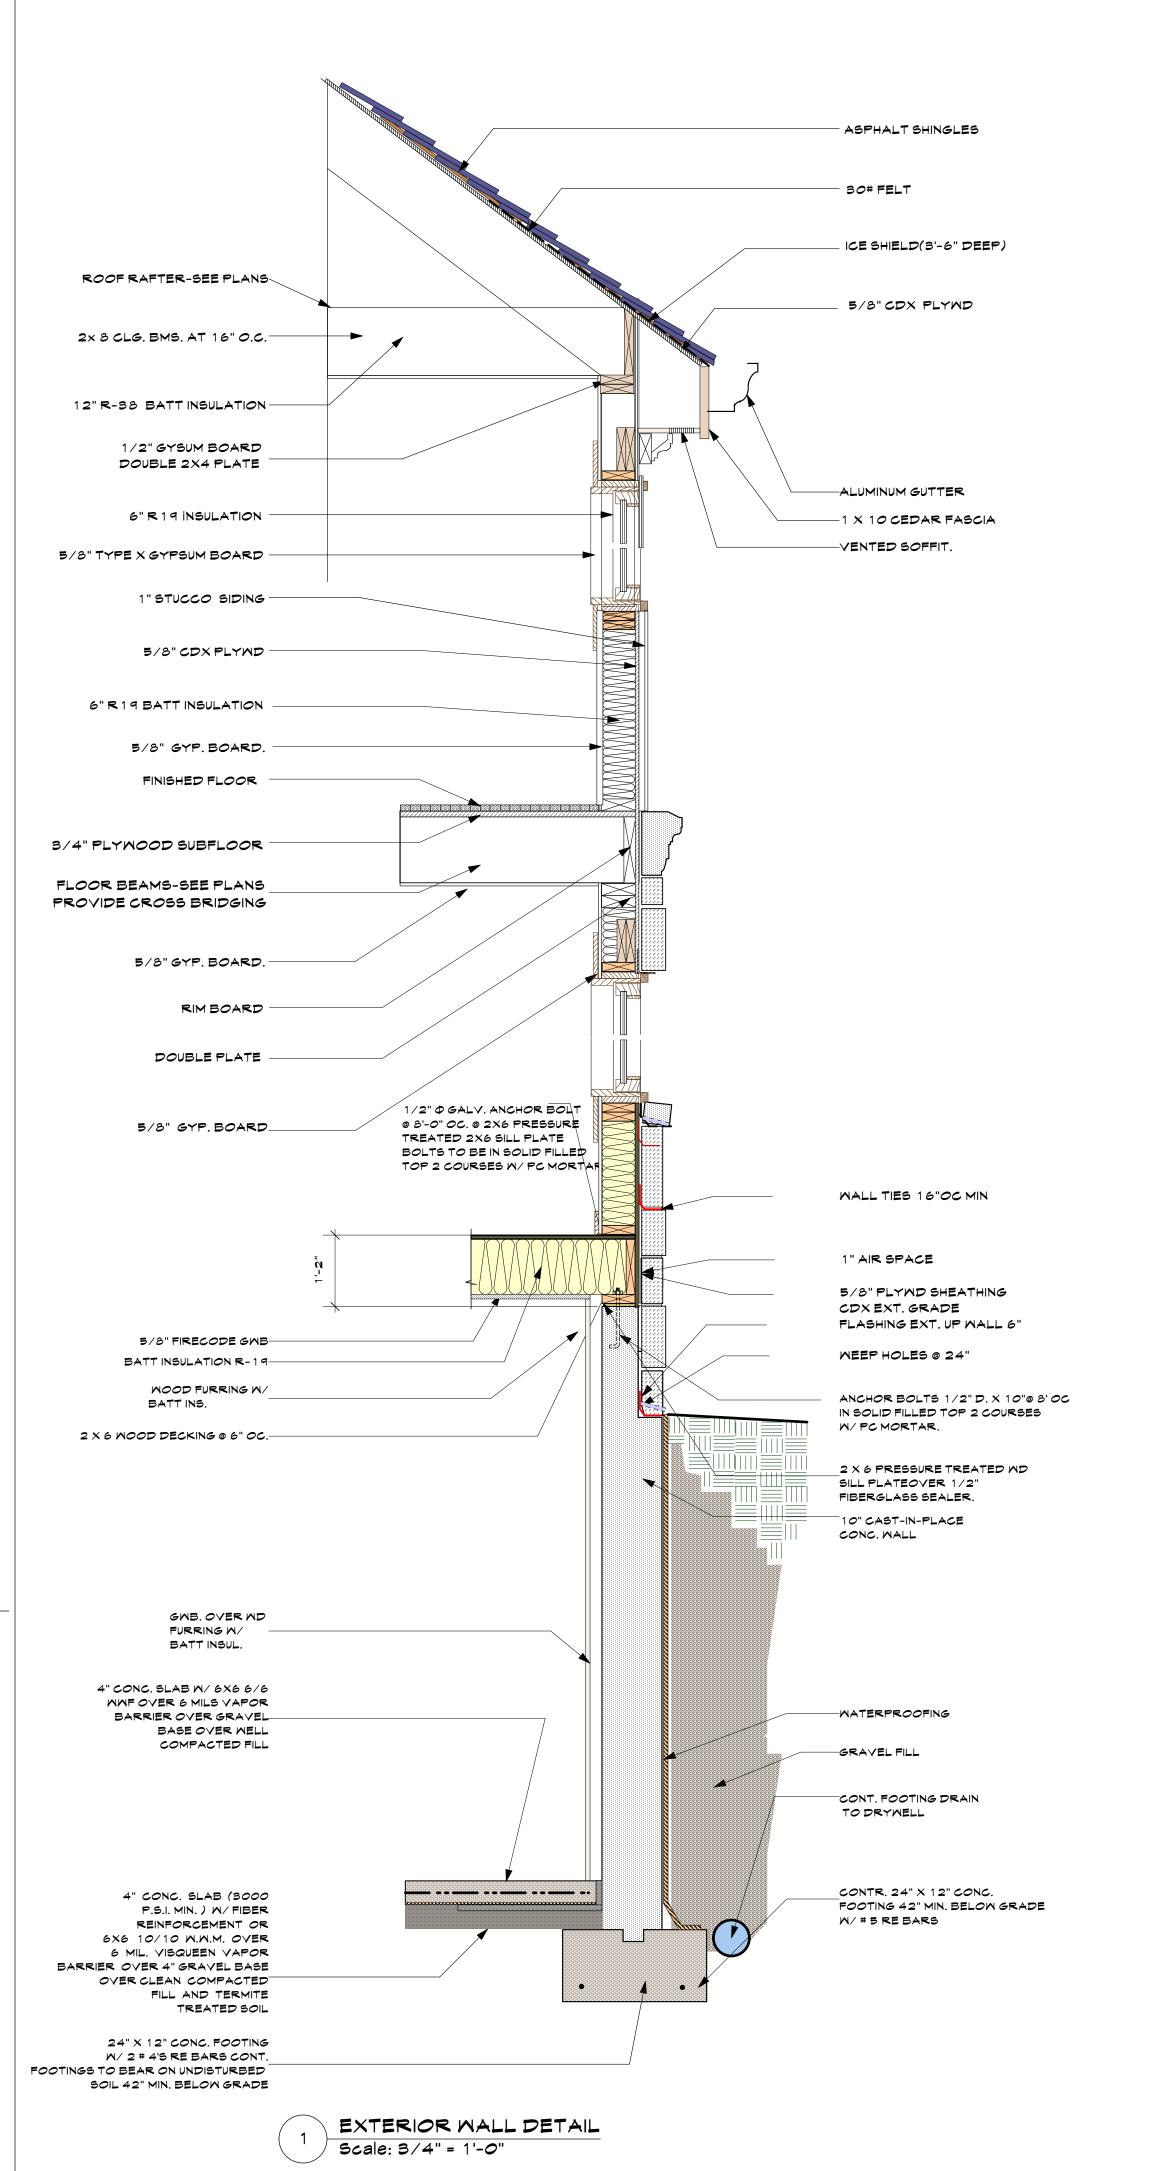
Project ID / DATE : 2048/ 10.15.2020

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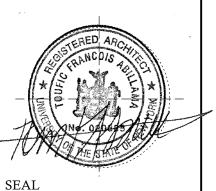
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KEY PLAN

PROPOSED
ONE FAMILY
DWELLING
EXPANSION

99 BYRAM RIDGE RD., ARMONK, N.Y

SBL: 101.01/1/13 ZONE: R-1A

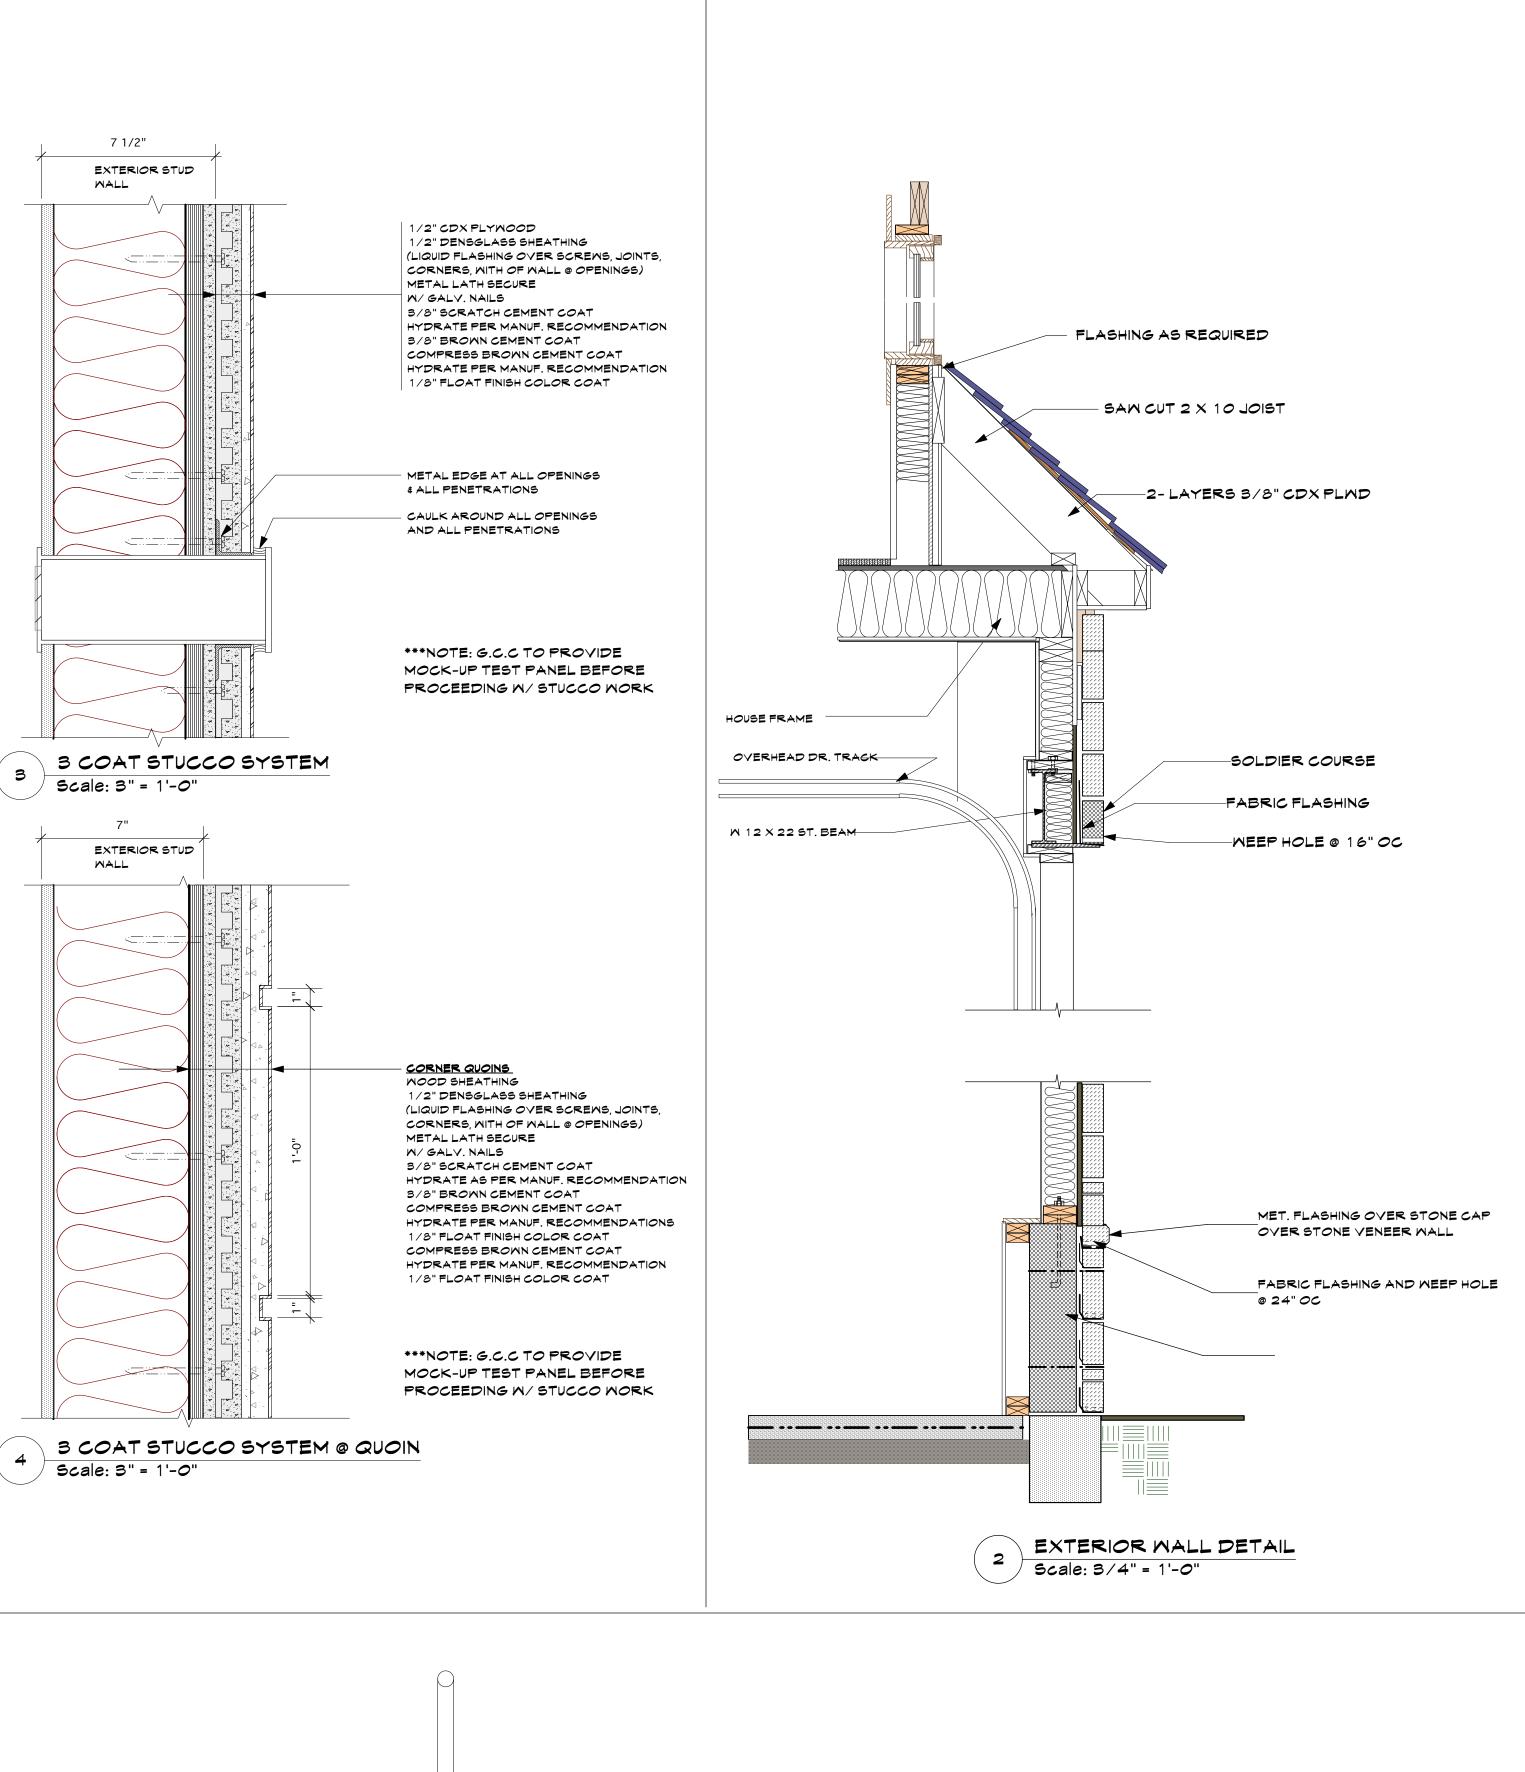
EXTERIOR MALL DETAILS

Project ID / DATE : 2048/ 10.15.2020




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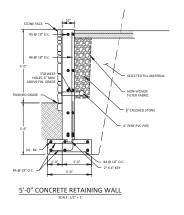
Drawn By: KM Checked By: TFA
Plot Date: JULY 19.2021

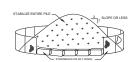


INSTALLATION NOTES:

SOIL STOCKPILE




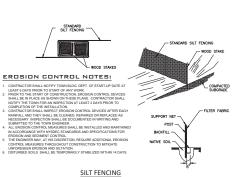

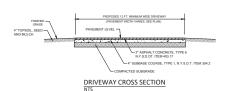





SC-740 INSPECTION PORT

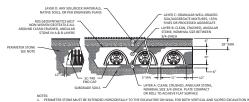

STORMTECH SC-740

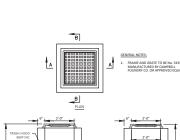

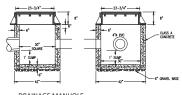

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JORGE B. HERNANDEZ R.A. A.I.A. LICENSE NUMBER: 030424-1 CERTIFICATE NUMBER: 0973256 PAUL A. BERTE, P.E

DATE

10/10/21

BY

100 EXECUTIVE BLVD. SUITE 204 OSSINING, NY 10562

REVISIONS

Eng Comment

DRAWING TITLE: SITE DETAILS

99 BYRAM LLC SINGLE FAMILY RESIDENCE

99 BYRAM RIDGE ROAD ARMONK, NY 10504

TOWN ENGINEER SIGNATURE:

PROJECT:

PROJECT ADDRESS:

SEAL & SIGNATURE



DATE.:	SCALE:
3/1/2021	
PROJECT NO.: 21-030	AS SHOW
DRAWING BY:	DRAWING NO.:
PB	
CHECKED BY:	□ 2 0F 2
PB	

INSTALLATION NOTES:

- 1. STONE SIZE: USE 3° STONE OR RECLAMED OR RECYCLED CONCRETE EDUNALITY.

 1. STONE SIZE: USE 3° STONE OR RECLAMED OR RECYCLED CONCRETE EDUNALITY.

 1. THICKNESS NOT LESS THAN SO (6) NICHES


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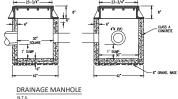
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- IONE.

 F ALL SURFACE WATER FLOWING OR DIVERTED TOWARD
 ENTRANCES SHALL BE PIPED ACROSS THE ENTRANCE. IF
 RACTICAL. A MOUNTABLE BERM WITH A 5:1 SLOPE WILL BE
- PIPMO IS MERICIFICAL. A MOUNTAINE BETWINNING TO SOME WILL BE PREMITTED.


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ANTI-TRACKING DEVICE OR STABILIZED CONSTRUCTION ENTRANCE




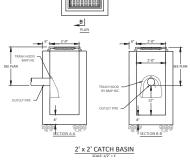

BLUESTONE PAVERS IN STONE DUST (POOL DECK AND WALKWAY)

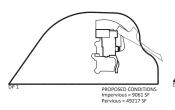

LOT COVEREAGE

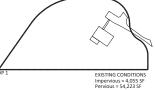

Pervious = 54,2

OWTS DESIGN SUMMARY

PROPOSED DEVELOPMENT SINGLE FAMILY, 5 BEDROOM HON DESIGN FLOW: 200 GPD/BEDROOM = 1,000 G

DEPTH TO GROUNDWATER N/A
DEPTH TO BEDROCK N/A

TOPOGRAPHY/SLOPE 11%

TOTAL LENGTH ABSORPTION TRENCH REQUIRED/PROVIDED = 720 LF

SOIL CLASSIFICATION: ChB & RhD

MISCELLANEOUS DATA

APPLICANT: 99 BYRAM LLC
5 W MAIN ST
ELMSFORD, NY 10523
DR: EDWARD T. GANNON, PLS
CHERRY HILL ROAD
BLOOMING GROVE, NY 1091

INLAND LONG ISLAND SOUND BASIN

MUNICIPALITY: TOWN OF NORTH CASTLE
LOT AREA:
1.3 A C.
PRE DISTRICT:
AMMON TO
TAK MAP
10.10.19.13
WATER DISTRICT:
ONSITE WILL
SEVER DISTRICT:
ONSITE WILL
SEVER DISTRICT:
OSCIPLINE SEDS
SCHOOL DISTRICT:
SEMAN HILLS
DISABALES BASIN:
BYMAN HILLS
BOALHAGE BASIN:
BYMAN HILLS
BOALHAGE BASIN:

EXISTING ZONING DISTRICT: R-1A

WATERSHED:



LOCATION MAP



O EXECUTIVE BLVD. SUITE 20 OSSINING, NY 10562 PHONE: (914) 944-3377

JORGE B. HERNANDEZ R.A. A.I.A. LICENSE NUMBER: 030424-1 CERTIFICATE NUMBER: 0973256

PAUL A. BERTE, P.E

100 EXECUTIVE BLVD. SUITE 204 OSSINING, NY 10562

REVISIONS	DATE	BY
Revised per Town Comments	4/13/21	F
Rev. house location	7/8/21	Г
Submit to PB	8/31/21	Г
Eng Comment	10/10/21	
		L
		L

DRAWING TITLE:
SITE DRAINAGE PLAN

PROJECT:

99 BYRAM LLC SINGLE FAMILY RESIDENCE

PROJECT ADDRESS: 99 BYRAM RIDGE ROAD ARMONK, NY 10504

TOWN ENGINEER SIGNATURE:

ALTERATIONS BY ANY PERSON IN ANY WAY, OR ANY ITEM CONTAINED ON THIS DOCUMENT, LIMESS ACTING LUNDER DESCRIPTION OF THE LEGENER DIAGREE WHOSE PROFESSIONAL SEAL IS AFFORD HERETO, IS A WOLAHON OF TITLE WILL ARTICLE 145 SECTION 7209.2 OF THE NEW YORK STATE EDUCATION LAW.

SEAL & SIGNATURE




DATE::	SCALE:
3/1/2021	1" = 20'-0
PROJECT NO.: 21-030	1 = 20 -0
DRAWING BY: PB	DRAWING NO.:
	1.00.0
CHECKED BY:	1 0F 2
PB	

SOIL TEST FOR STORMWATER DESIGN

Min.	Depth to Water From Ground Surface		Water Level Drop	Soil Rati (Min./ir
Elapsed	Start (in.)	Stop (in.)	Level Drop	drop)
10	23	26	3	3.33
10	23	26	3	3.33
11	23	26	3	3.67

Test Pit #1 ELEV +-71		
Depth 52"	Performed on 8/11/21	
0-4"	Topsoil	
4"-24"	Brown Sandy Loam	
24"-52"	Brown Sandy Loam with 6-10" boulders	
52"	Large boulders not able to be excavated with	

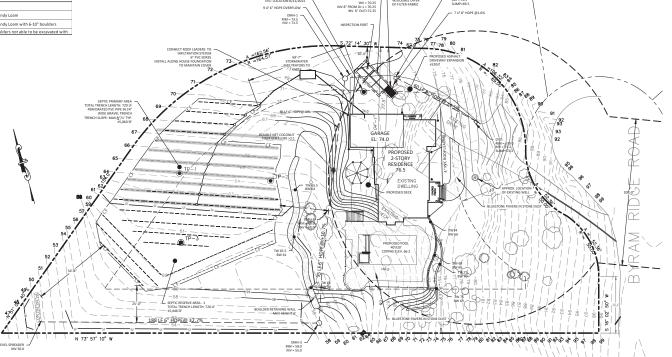

DRAINAGE PLAN
1" = 20'-0"