
PROPOSED RENOVATION OF

The Kalian Residence

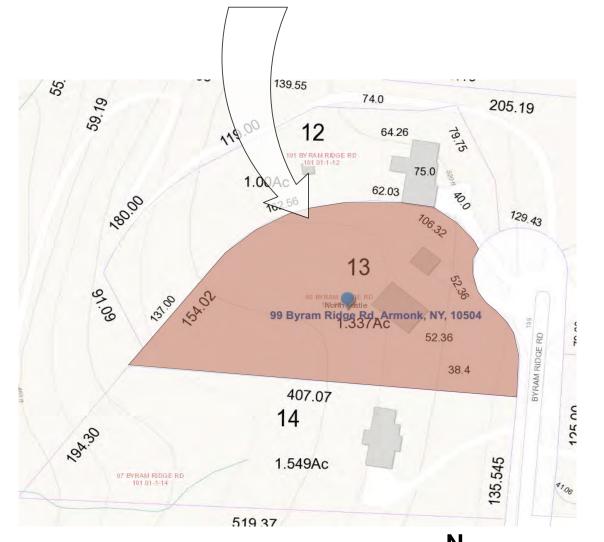


99 Byram Ridge Road, Armonk, NY

OWNER: Mr. & Mrs. Christopher Kalian

Contractor : Ridge Partners


Architect: Tom F. Abillama, AIA



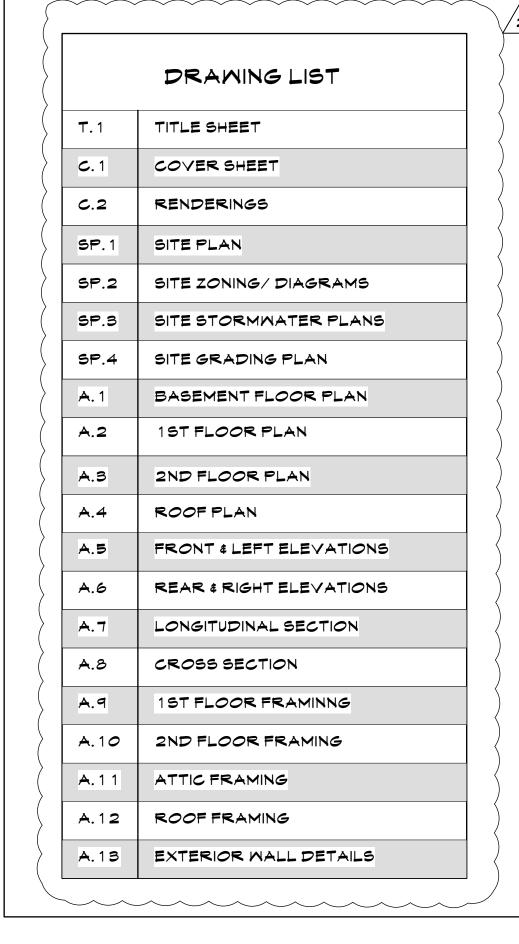

GIS MAP



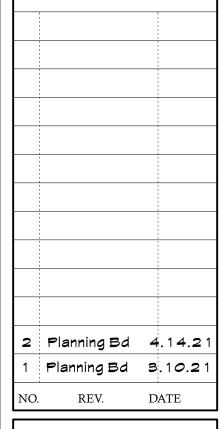


OWNER:

MR. & MRS. CHRISTOPHER KALIAN



PHONE: 914 6684673 FAX: 914 668 1831 EMAIL: FILES@TFARA.COM

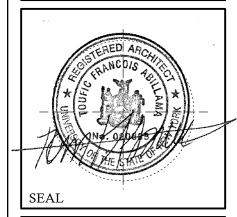

REY PLAN (PROPOSED

ONE FAMILY
DWELLING
EXPANSION


99 BYRAM RIDGE RD.,
ARMONK, N.Y

TITLE SHEET

SBL: 101.01/1/13 ZONE: R-1A

Project ID / DATE : 2048/ 10.15.2020 Sheet Scale:

Drawn By: KM Checked By: TFA
Plot Date: APR.14.2021

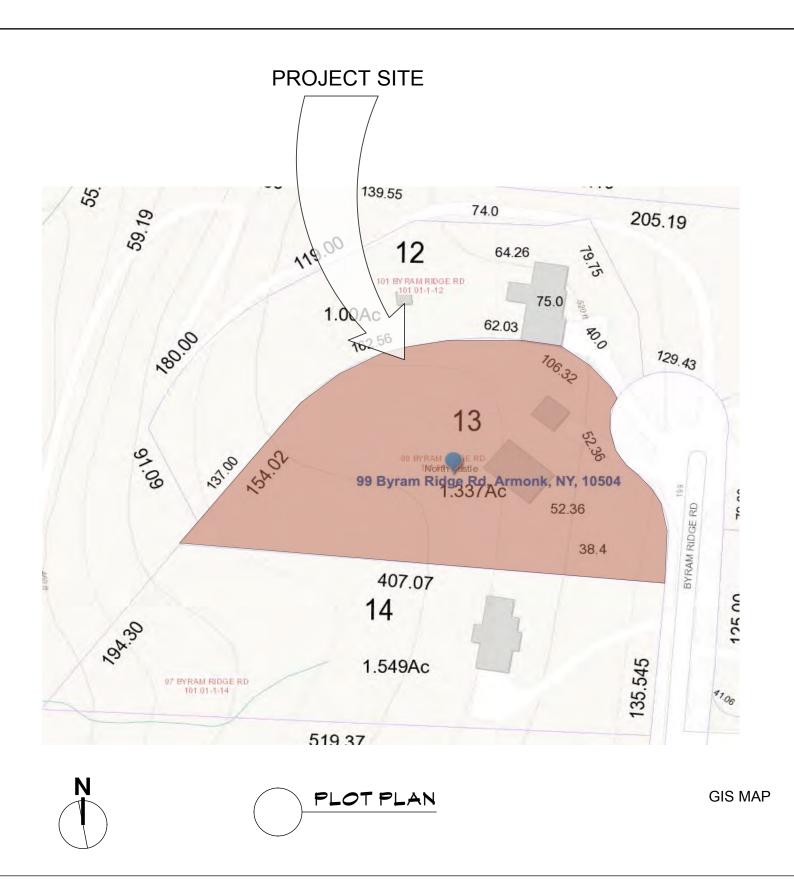

ELECTRICAL NOTES

Mork related to these documents shall include furnishing and installation of every kind of wire/conduit required to make the electric light and power distribution system complete, i.e. providing and connecting service entrance equipment, lighting panels, power panels, switches, outlets, receptacles, back boxes, related components required by the local utility company of all fixtures complete with lamps, clamps, hangers, supports, etc.

All electrical work shall comply with the requirements of the national electric code, latest edition. Should a conflict arise, the code or more stringent requirements shall prevail.

All wiring shall be copper, #12 awg minimum size - #8 and smaller to be solid, #6 and larger to be stranded. Insulation to be NEC 600 volt type, rated @ 75 degrees C and be properly phase color coded for 120/208 V. 3 phase 4-wire service.

Unless noted otherwise, minimum size conduit shall be 1/2" and number of cross marks indicate number of #12 conductors in conduit. Type of conduit used shall be in strict accordance with code provisions concerning same. All conduit runs are to be concealed in floors, walls, and ceilings, except where noted otherwise.

Electrical installation shall be tested for shorts, grounds, operation of low voltage circuitry, night light wiring, stand-by generator and connections to same, etc. Defects shall be remedied at once and the tests re-run as many times as may be required to prove correctness. Balance all phase loading of all panelboards.

The circuits shall be distinctly numbered and identified on the schedule of circuits typewritten to the panelboard. Affix permanent identifying nameplates to all electrical switches, pilot devices, selector switches, etc. Submit samples and list of titles for approval prior to purchase and installation.

PLUMBING NOTES

Installation of all work herein specified shall conform to the requirements of the NY State Plumbing Code, rules and regulations of the North Castle building department, and all other local authorities having jurisdiction, including federal O.S.H.A. specifications.

All materials used shall be new, best of their respective brands and conform to the requirements of all state and local authorities having jurisdiction. Pipework installed under this contract shall be in accordance with the following schedule:

Material

Soil and waste lines[within building]above grade-extra heavy cast iron pipe or dwv copper pipe with sweat solder connections;

Below grade- extra heavy cast iron pipe. soil and waste lines [outside building] extra heavy cast iron pipe. vent pipingstandard weight galvanized pipe or type dwv copper pipe with sweat solder joints. cold and hot water piping underground-typek with flare fittings.

Above grade [within building] type I copper tube with lead free sweat solder connections

Set clevis hangers for the support of copper piping not more than 10 ft on center. set hangers for cast iron pipe not more than 5 ft apart; use 3/8" rod for pipe up to 2" and 1/2" rod for pipes, 2 1/2" and larger. cover all cold water and hot water lines with 1" thick o-c fiberglass light density one piece pipe insulation having frk universal type vapor barrier outer jacket. install as per manufacturer's specifications. cover all valves and fittings with zeston premoulded insulating shapes.

02060 REMOVALS

I. MORK INCLUDED

1. SEE ARCHITECTURAL DEMOLITION DRAWING SEE ALSO MECHANICAL AND ELECTRICAL DRAWINGS.

2. GENERAL REMOVALS AND RELOCATIONS:

- 1. REMOVE AND RELOCATE ALL EXISTING MISCELLANEOUS MECHANICAL AND ELECTRICAL DEVICES AND FIXTURES INCLUDING BUT NOT LIMITED TO: FIRE ALARM, PULLS STATIONS, POWER OUTLETS, LIGHT SMITCHES, THERMOSTATS AND TELEPHONE OUTLETS AS REQUIRED FOR THE INSTALLATION OF NEW YORK.
- 2. REMOVE ALL ITEMS, MATERIALS AND FINISHES REQUIRED FOR THE INSTALLATION OF NEW WORK, OR THE RELOCATION OF EXISTING, AS DESCRIBED IN PERTINENT SECTIONS OF THESE SPECIFICATIONS AND / OR SHOWN ON THE DRAWINGS INCLUDING STRUCTURAL, MECHANICAL END ELECTRICAL DRAWINGS AND SPECIFICATIONS.
- 3. EXISTING WIRING, PIPING OR OTHER LINES WITHIN WALLS OR CEILINGS TO BE REMOVED - VERIFY THAT THESE ARE ABANDONED PRIOR TO REMOVAL. RE-ROUTE ANY LINES THAT ARE STILL IN USE TO MAINTAIN ALL EXISTING SERVICES.

II. MATERIALS - (NA) III. EXECUTION

- 1. ALL REMOVALS AND DEMOLITION SHALL BE IN COMPLIANCE WITH NYS BUILDING CODE, AND ALL APPLICABLE FEDERAL SAFETY REGULATIONS.
- 2. ALL MATERIALS AND ITEMS THAT ARE TO BE REUSED AND RELOCATED IN CONJUNCTION MITH THE NEW MORK SHALL BE CAREFULLY CUT AWAY FROM THE EXISTING ABUTTING WORK TRUE TO LINE AT THE NEAREST JOINT, SURFACE BREAK OR PATTERN LINE TO ENSURE NO NOTICEABLE DIFFERANCE BETWEEN NEW AND EXISTING TO REMAIN. REMOVALS SHALL BE KEPT TO A MINIMUM MATERIALS TO BE REUSED AND RELOCATED SHALL BE PROPERLY HANDLED. TAGGED AND PROPERLY STORED TO PREVENT DAMAGING AND BREAKING.
- 3. CAREFULLY COORDINATE ALL TRADES TO ENSURE PROPER AND ADEQUATE INTERFACE OF THE WORK.
- 4. WHEN WORK IS STOPPED, PROVIDE AND MAINTAIN IN PLACE SUITABLE COVERINGS AND BARRIERS FOR PROTECTION OF THE WORK AND SAFETY FOR ALL PERSONNEL AND BUILDING USERS, PROVIDE PROTECTED PATHS OF EGRESS, PER PHASING REQUIREMENTS, FOR CONTINUOUS PLUBLIC ACCESS TO STAIRS , ESCALATORS AND ENTRANCES / EXITS.
- 5. PROTECT ALL WORK, EXISTING AND NEW, FROM DAMAGE BY ANY CAUSE THROUGHOUT THE DEMOLITION OPERATIONS PROTECTIVE COVERINGS OR BARRIERS SHALL NOT MAR, STAIN OR PENETRATE THE FINISHED MORK.
- 6. COORDINATE ALL ELECTRICAL WORK FOR THE PROPER DISCONNECTIONS, PROTECTIONS AND CAPPINGS: SEE ELECTRICAL DRAWINGS AND SPECIFICATIONS.
- 7. UNDERTAKE WHATEVER PRECAUTIONS ARE NECESSARY TO PREVENT EXCESSIVE DUST DURING DEMOLITION.
- REMOVE ALL PORTIONS OF THE WORK IN A SAFE MANNER WITH CARE TO PREVENT DAMAGE TO ADJACENT AND REMAINING STRUCTURE, FINISHES OR ANY OTHER ITEMS OF PROPERTY.
- 9. ALL MATERIALS UNLESS NOTED TO BE REUSED OR TO BE SALVAGED SHALL BE REMOVED OFF THE PROPERTY TO AN AVAILABLE DUMP OR SITE OF THE CONTRACTOR'S OWN CHOOSING AND ARE TO BE PROPERLY AND RESPONSIBLY DISPOSED OF. NO BURNING OR ON-SITE DISPOSAL IS PERMITTED.
- 10. VERIFY SALVAGE REQUIREMENTS FOR ALL MATERIALS NOTED TO BE REMOVED WITH SAFE HORIZON. MATERIALS NOTED TO BE SALVAGED SHALL BE PROPERLY STORED IN LOCATION PER SAFE HORIZON, INC. DIRECTIONS.
- 11. ALL SPACES ARE TO BE BROOM CLEANED DAILY.
- 12. ALL REMOVALS SHALL LEAVE THE EXISTING SURFACES AND SUBSTRATES FREE AND CLEAN FOR THE PROPER PATCHING AND PREPARATION REQUIRED FOR THE SPECIFIED NEW MATERIALS AND FINISHES.

NOTES: STEEL COL'S SHALL REST ON 12" X 12" 3/4" T. ST. BASE PLATE OVER LEVELLING PLATE OVER NON-SHRINK GROUT W/(4)3/4" \$ 12" LONG ANCHOR BOLTS OVER

3'-0" X 3'-0" X 18 " CONC. FOOTINGS W/(3) # 4'S EA. WAY-BOTTOM.

ALL BEAMS OVER 2 MEMBERS SHALL BE BOLTED TOGETHER M/3/4" THRU-BOLTS @ 18" O.C. STAGGERED.

ALL FLUSH BEAMS SHALL RECEIVE JOIST HANGERS BY SIMPSON OR EQ.

ALL DOORS, WINDOWS SHALL RECEIVE (2) 2X10 HEADERS (TYP.) UNLESS OTHERWISE NOTED ON PLANS.

ALL FOUNDATION WALLS SHALL BE WATERPROOFED W/ 2-COATS OF BITUM. COATING AND BACKFILLED M/GRAVEL

CONSTRUCTION TO BE "V b" SINGLE FAMILY RESIDENTIAL LIVE LOADS = 40 PSF GROUND SNOW LOAD = 30 PSF SNOW LOAD = 30 PSF DEAD LOAD = 15 PSF WIND LOADS = 115 MPH SEISMIC DESIGN: B

1- ALL STRUCTURAL STEEL SHALL CONFORM WITH AISC SPECIFICATIONS FOR STRUCTURAL STEEL FOR BUILDINGS, AND SHALL BE BASED ON ASTM-A36 WITH MINIMUM YIELD POINT OF

- 36.000 PSI. 2- ALL CONNECTION MATERIAL SHALL CONFORM TO ASTM REQUIREMENTS:
- A) HIGH STRENGTH BOLTS : A325.
- B) WELDING ELECTRODES : AWS-A5.1, E70 SERIES. C) BOLTS SHALL BE 3/4" DIAMETER.
- D) OPEN HOLES SHALL BE 13/16" DIAMETER, UNLESS OTHERWISE INDICATED. 3 - ALL WELDING SHALL BE DONE BY LICENSED WELDERS AND SHALL BE INSPECTED BY APPROVED WELDING AGENCY.
- 4- PROVISIONS SHALL BE MADE FOR CONNECTIONS OF OTHER TRADES PRIOR TO FABRICATION.
- 5- ALL STEEL MEMBERS SHALL HAVE SHOP COAT OF PRIMER. 6-LOOSE LINTELS SHALL HAVE 6" BEARING EACH END.

1- ALL FOOTINGS ARE TO REST ON UNDISTURBED SOIL HAVING A MIN. BEARING CAPACITY OF 2 TONS PER SQ. FT. 2- EDGES OF FOOTINGS SHALL NOT BE PLACED AT A GREATER THAN 1 VERTICAL

TO 2 HORIZONTAL SLOPE WITH RESPECT TO ANY OTHER ADJACENT FOOTINGS.

1- ALL CONCRETE SHALL BE STONE AGGREGATE CONCRETE WITH AN ULTIMATE COMPRESSIVE STRENGTH OF 3000# PSI AFTER 28 DAYS. 2- WELDED WIRE FABRIC SHALL HAVE AN ULTIMATE STRENGTH OF 70,000 PSI. 3- ALL STEEL REINFORCEMENT SHALL BE DEFORMED ACCORDING TO ASTM-A615, GRADE 60 AND SHALL HAVE A YIELD POINT OF 40,000 PSI.

- 1- CONCRETE BLOCK SHALL CONFORM TO ASTM C-145, GRADE N-1. 2- MORTAR SHALL CONFORM TO ASTM C-270 TYPE "M".
- 3- NO VINYLIDENE CHLORIDE OR ANY UNAPPROVED CURING ADMIXTURE SHALL BE ALLOWED IN MORTAR MIXTURE.

4- PROVIDE GALV. HORIZONTAL REINFORCEMENTS AT EVERY COURSE JOINT.

ADMINISTRATIVE

THE ARCHITECT/ENGINEER HAS NOT BEEN RETAINED FOR THE SUPERVISION OF WORK & IT REMAINS INCUMBENT ON THE CONTRACTOR TO INFORM THE BUILDING DEPARTMENT OR THE ARCHITECT/ENGINEER OF ANY DISCREPANCIES OR CHANGES ON THE APPROVED PLANS.

NO WORK IS TO BE STARTED UNTIL A BUILDING PERMIT HAS BEEN SECURED AS REQUIRED BY THE GOVERNING AGENCIES.

THE CONTRACTOR IS TO VERIFY ALL DIMENSIONS AND CONDITIONS PRIOR TO THE COMMENCEMENT OF WORK & SHALL REPORT ANDY DISCREPANCIES TO THE ATTENTION OF THE ARCHITECT/ENGINEER BEFORE PROCEEDING.

ALL WORK OF THE VARIOUS TRADES INVOLVED WITH THE CONSTRUCTION OF THIS PROJECT IS TO BE PERFORMED BY CAPABLE AND REPUTABLE CONTRACTORS, LICENSED IN THE STATE OF NEW YORK & AS REQUIRED BY LOCAL AGENCIES.

DO NOT SCALE DIMENSIONS FROM DRAWINGS. WRITTEN DIMENSIONS ARE TO BE FOLLOWED FOR CONSTRUCTION PURPOSES. LARGE SCALE DRAWINGS TAKE PREFERENCE OVER SMALLER SCALE

NO WORK IS TO BE STARTED UNTIL THE PLANS ARE APPROVED BY THE NEW YORK CITY DEPT. OF BUILDING AND A WORK PERMIT IS OBTAINED.

THESE NOTES ARE PART OF THE CONSTRUCTION DOCUMENTS AND SPECIFICATIONS AND ARE TO BE FULLY COMPLIED WITH IN ALL RESPECT. THE CONTRACTOR SHALL BE HELD TO HAVE VISITED THE SITE SO THAT HE MAY DETERMINE THE DIFFICULTIES HE MAY ENCOUNTER DURING CONSTRUCTION.

FOUNDATION AND SUBSOIL CONDITIONS HAVE BEEN DESIGNED BASED ON THE INFORMATION CONTAINED WITHIN THE BORINGS AND/OR TEST PITS AS FURNISHED BY THE OWNER, EXACT FOUNDATION REQUIREMENTS ARE SUBJECT TO CHANGE BASED ON CONTROLLED INSPECTIONS OF SUBSOIL CONDITIONS AND MAY VARY FROM THOSE INDICATED ON THESE

CONTRACTOR IS RESPONSIBLE FOR NOTIFYING UTILITY COMPANIES TO VERIFY EXACT LOCATIONS OF THEIR UTILITY LINES, SERVICE AND OTHER POSSIBLE EQUIPMENT.

THE OWNER SHALL BE RESPONSIBLE FOR THE SAFE MAINTENANCE OF THE BUILDING SITE.

PRIOR TO COMMENCMENT OF WORK THE ADJACENT PROPERTY OWNERS SHALL BE GIVEN 5 DAYS WRITTEN NOTICE BY CERTIFIED MAIL, WHERE ADJACENT PROPERTY IS AFFECTED BY FOUNDATIONS, GRADING EARTH WORK OR DEMO WORK.

AN ACCURATE AND COMPLETED SURVEY, MADE BY A LICENSED SURVEYOR, SHALL BE SUBMITTED TO THE APPLICANT OF RECORD AFTER COMPLETION OF WORK SHOWING THE LOCATION AND ELEVATIONS OF ANY NEW BUILDING OR EXTENSION, FINISHED FLOOR ELEVATION, GRADE ELEVATIONS AND SHALL COMPLY TO THE MINIMUM STANDARDS OF THE NYSSPLS.

GENERAL NOTES

CONTRACTOR SHALL VISIT SITE AND SHALL BE RESPONSIBLE FOR VERIFICATION OF ALL DIMENSIONS, CONDITIONS, WHICH PERTAIN TO THE FABRICATION PROCESSES, OR TO TECHNIQUES FOR CONSTRUCTION AND COORDINATION OF THE WORK OF ALL TRADES, PRIOR TO START OF CONSTRUCTION.

ALL DISCREPANCIES SHALL BE BROUGHT TO THE ATTENTION OF ARCHITECT BEFORE PROCEEDING. THE ELEVATIONS AND AVAILABILITY OF UTILITITIES, SEWER, WATER AND ELECTRIC LINES SHALL BE VERIFIED BY OR DETERMINED BY INTERESTED CONTRACTORS PRIOR TO SUBMISSION OF BID.

CONTRACTORS SHALL ADJUST PITCH OF NEW LINES TO INSURE PROPER AND LEGAL INTERSECTIONS. CONTRACTOR SHALL COORDINATE LOCATIONS FOR STRUCTURAL, MECHANICAL AND ELECTRICAL WORK FOR ALL PITS, SLAB DEPRESSIONS, SLEEVES IN FOUNDATION WALLS, SLABS, AND ROOF OPENINGS, ETC.

CONTRACTOR SHALL VERIFY CONDITIONS OF ADJOINING STRUCTURES WHICH MAY BE AFFECTED, PROVIDE ADEQUATE PROTECTION AND RESTORE TO ORIGINAL CONDITIONS, WHENCE DAMAGE SHOULD RESULT FROM SUCH WORK. THE CONTRACTOR SHALL PROVIDE ALL NECESSARY SHORING AND BRACING FOR ALL BUILDING COMPONENTS IN ORDER TO ADEQUATELY PROTECT AGAINST ANY FAILURES.

CONTRACTOR SHALL SECURE AND PAY FOR ANY AND ALL PERMITS, LICENSES, CERTIFICATES, FEES, ETC., REQUIRED BY THE TOWN OF NORTH CASTLE DEPARTMENT OF BUILDINGS OR ANY AND ALL JURISDICTION AUTHORITIES. CONTRACTOR SHALL OBTAIN A FINAL CERTIFICATE OF OCCUPANCY UPON COMPLETION.

ALL MORK MUST CONFORM TO THE TOWN OF NORTH CASTLE DEPARTMENT OF BUILDINGS, FIRE DEPARTMENT LAWS, RULES AND TO ALL REGULATIONS OF ALL AUTHORITIES HAVING JURISDICTION WHETHER SPECIFICALLY SHOWN OR NOT. [O.S.H.A. REGULATIONS MUST ALSO BE ADHERED TO]. ALL ELECTRIC WORK MUST CONFORM TO NATIONAL ELECTRIC CODE

ANY ITEM SHOWN ON ONE SHEET SHALL BE AS IF CALLED FOR BY ALL SHEETS. FINAL COORDIANTION IS THE RESPONSIBILITY OF

THE CONTRACTOR. CONTRACTOR SHALL NOT SCALE DRAWINGS AND SHALL USE FIGURED DIMENSIONS ONLY. THE GENERAL CONDITIONS OF THE CONTRACT FOR CONSTRUCTION OF BUILDINGS, [STANDARD FORM OF A.I.A. LATEST EDITION A201], ARE PART OF THE CONTRACT DOCUMENTS.

MORK INCLUDED IN THESE CONTRACT DOCUMENTS TO BE ALL LABOR, MATERIALS, AND EQUIPMENT, REQUIRED TO COMPLETE THE PROPOSED CONSTRUCTION AS SHOWN. WORK INCLUDED IN THIS CONTRACT SHALL BE ACCORDING TO THE TRUE INTENT OF THE DRAWINGS AND SHALL BE FIRST CLASS IN ALL RESPECTS.

SUBCONTRACTORS SHALL GUARRANTEE. IN WRITING TO THE OWNER AT CONCLUSION OF JOB. ALL MATERIALS AND MORKMANSHIP FOR A MINIMUM OF ONE YEAR AFTER SUBSTANTIAL COMPLETION.

THE ARCHITECT HAS NOT BEEN RETAINED FOR SUPERVISION OR PERIODIC FIELD OBSERVATIONS AND ASSUMES NO RESPONSIBILITY FOR SAFETY METHODS ON SITE. THE OWNER AND CONTRACTOR SHALL HOLD HARMLESS THE ARCHITECT FROM AND AGAINST ALL CLAIMS, DAMAGES, LOSSES AND EXPENSES INCLUDING ATTORNEY'S FEES ARISING OUT OF OR RESULTING FROM THE PERFORMANCE OF THE WORK BY THE CONTRACTOR.

CONTRACTOR SHALL APPLY TAPING COMPOUND IN 3 COATS TO ALL JOINTS OF ALL SHEETROCK, SHALL PROVIDE TWO COAT HIGH GLOSS PAINT IN THE KITCHEN AREA AND A SATIN FINISH COAT AT ALL OTHER AREAS. INCLUDING CEILINGS. CONTRACTOR TO PROVIDE NEW CERAMIC TILE THROUGHOUT KITCHEN, BATHROOMS, LAUNDRY ROOMS AND ALL OTHER WET FLOOR AREAS. COLORS AS SELECTED BY OWNER. SUBCONTRACTOR IS TO PROVIDE ALL FINISH HARDWARE AS REQUIRED BY THE OWNER FOR ALL NEW DOORS.

SCOPE OF WORK PERTAINS TO THE RENOVATION/ADDITION TO EXISTING ONE FAMILY DWELLING. THESE PLANS ARE BASED ON THE 2020 RCNYS, (APPENDIX J. ALTERATION LEVEL 2-CHAPTER 6), THE TOWN OF NORTH CASTLEMUNICIPAL CODE AND ALL APPLICABLE RULES AND REGULATIONS.

I, TOM F. ABILLAMA R.A. , HEREBY STATE THAT I HAVE PREPARED THESE PLANS AND SPECIFICATIONS, TO THE BEST OF MY KNOWLEDGE, BELIEF AND PROFESSIONAL JUDGEMENT, IN COMPLIANCE WITH THE 2020 ENERGY CODE OF NEW YORK STATE-R 105.2.2 -ZONE 4A

TOM F. ABILLAMA, R.A. ARCHITECT

ENERGY CODE REQUIREMENTS: PRESCRIPTIVE METHOD ZONE 4A CRITERIA (RCNY,2020- N1102.1.2):

- 2-UFACTOR @ SKYLIGHT: .55 3-UFACTOR @ SHGC:.40 4-R VALUE @ ROOF: R-49
- 5-R-VALUE @ WD FRAME WALL: R-21 6-R-VALUE @ MASS WALL: R-13

1-UFACTOR @ GLAZING:.32

- 7-R-VALUE @ FLOOR: R-25 8-R-VALUE @ BASEMENT WALL: R-13 9-R-VALUE @ SLAB: R-10, 2 FT PERIM.
- 10-R-VALUE @ CRAWL SPACE WALL: R-19 1 1 - MAX INFILTR.@ WDWS,SKLTS: 0.3 CFM/SF 12-MAX INFILTR.@ SWING. DRS: 0.5 CFM/SF
- 13- MIN.75% -HIGH EFFICACY LAMPS 14- TESTING PER N1102-.4.1.2

ROUGH CARPENTRY:

- Framing and structural lumber: Douglas Fir #1. Fb=1050 psi, E=1,600,000 . Fv=95 psi. All joists and rafters to have diagonal bridging, 8'-0" o.c. maximum. Solid blocking under ceramic tile. Members of built—up girders, headers or lintels
- shall be spiked or bolted together to act as one unit. 2. Cross bridging of joists 1- 1/4" x 3" max, 3'-0" o.c. Collar ties at cathedral ceilings, 2-2 x 6 @ 4'-0" o.c. max. Exterior carpentry at porches shall be c.c.a. treated
- as indicated on drawings. Ornamental posts shall be of a nominal size $6" \times 6" pine$. 3. Wood deck, 5/4" thick T & G Redwood decking. Deck shall pitch
- slightly for water runoff.
- 4. Plywood shall meet the requirements of APA requirements and specifications: 5. Wall and roof sheathing: 5/8" thick, C-D—Ext-Apa, Exterior glue
- 6. Subflooring: 5/8" thick, C—D—Ext—Apa, exterior glue Underlayment: 3/8" thick—
- 7. Underlayment INT-APA Exterior glue
- 8. All wood beams to have a minimum bearing of 4".
- Double all joists under all partitions 9. All details of construction; lintels, headers, posts, beams,
- framing, nailing, etc. shall comply with all minimum standards of New York State Code.
- 10. Contractor to do all necessary firestopping of stud partitions and pipe chases, as required by N.Y. State Code whether specifically shown or not.
- 11. Lumber schedule: Miscellaneous lumber, furring, bridging, blocking
- to be grade #2 of any species ample in strength to meet the requirements thereof. 12. Mooden trimmers, headers, and tail joists over six feet in length,
- unless supported on walls or girders, shall be hung in approved metal stirrups, or hangers. 13. Every six feet, at least one beam or joist which rests on masonry walls,
- shall be secured to such walls by approved metal anchors attached in a manner at or near bottom to be self releasing.
- 14. The ends of wooden beams and joists resting on masonry walls shall be cut to a bevel of three inches in their depth. All girders to bear minimum of 8" on masonry.
- 15. Provide shelf and coat pole in all closets with five shelves in linen closet. 16. Finish woodwork shall be dressed and sanded, free from machine and tool marks, abrasions raised grain or other defects on surfaces exposed to view in the finished work.
- 17. Mood finish shall be set straight, plumb and level in true alignment, closely fitted and rigidly secure in place. Nail heads of exposed nailing shall be countersunk. All work shall be left clean, free from warp, twist, open joints and other defects
- 18. Interior miscellaneous finish carpentry and woodwork to be "C" select of white pine, oak, or yellow poplar.
- 19. Interior doors to be clear birch, stain grade.
- 20. Caulk at all doors and window frames, joints and other surfaces which require the closing of a joint between any two surfaces not of the same material. Caulking compound shall be silicone equal to Thiokol sealant by Toch Brothers.
- 21. Contractor to do all flashing required whether specifically shown or not. Tape and apply taping compound in 3 coats to all joints of all sheetrock.

STEEL NOTES

1- All Structural Steel Shall Conform With Aisc Specifications For Structural Steel For Buildings, And Shall Be Based On Astm-A36 With Minimum Yield Point Of 36,000psi.

- 2- All Connection Material Shall Conform To ASTM Requirements:
- A) High Strength Bolts : A325. B) Welding Electrodes: Aws-a5.1, E70 Series.
- C) Bolts Shall Be 3/4" Diameter. D) Open Holes Shall Be 13/16" Diameter, Unless Otherwise Indicated.

3- All Welding Shall Be Done By Licensed Welders And Shall Be Inspected By Approved Welding Agency.

- 4- Provisions Shall Be Made For Connections Of Other Trades Prior To Fabrication.
- 5- All Steel Members Shall Have Shop Coat Of Primer. 6- Loose Lintels Shall Have 6" Bearing Each End.

MOOD NOTES

1- All Exterior Mood Framing Members Shall Be Structural Grade With Min. Fiber Stress Strength Of 1400, And Shall Be Pressure Treated For Exterior Exposure.

2- Contractor To Provide All Steel Connections Required For Fastening Members To Others.


3- Contractor To Refer To "simpson-strong Tie" Manual For Post Plates, Joist / Beam Hangers As Well As Hold Downs And Post Caps Etc...

SCOPE OF WORK:

PROVIDE 2 STORY ADDITION AND RENOVATION TO EXISTING ONE AND HALF STORY STRUCTURE. PROVIDE FOR NEW DRIVEWAY, DECK AND GAZEBO. REMOVE EXISTING TREES UNDER SEPARATE PERMIT.

SEPARATE APPLICATIONS

PLUMBING PERMIT ELECTRICAL PERMIT TREE REMOVAL SEPTIC DESIGN

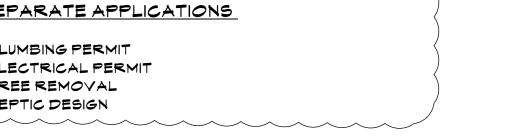

// **2**\

Ground Subject To Damage From: | Winter | Ice Shield Mind Design Snow Design Underlayment Flood Load Special Wind Born Design Required Hazards Freezing Annual Temp. Meathering Depth Speed Topographic region Debris (psf) Category Temp Index zone winds 15*00* 36119C03 or 30 | 115 Mph No No 52.2º F Yes 3'-6" to Heavy less 2007

2 Planning Bd 4.14.2

MR. & MRS.

CHRISTOPHER

KALIAN

OWNER:

Planning Bd 3.10.21

REV. DATE

Tom Abillama 955 CENTRAL PARK AVENUI

YONKERS, NEW YORK

PHONE: 914 6684673

EMAIL: FILES@TFARA.COM

FAX: 914 668 1831



PROPOSED ONE FAMILY **DWELLING EXPANSION**

KEY PLAN

SBL: 101.01/1/13 ZONE: R-1A COVER

99 BYRAM RIDGE RD., ARMONK, N.Y

SHEET/MAP /NOTES

Project ID / DATE : 2048/ 10.15.2020

Drawn By: KM Checked By: TFA APR.14.2021



2 Planning Bd 4.14.21 1 Planning Bd 3.10.21

NO. REV. DATE


)WNER:

MR. & MRS. CHRISTOPHER KALIAN

Tom Abillama Architects

1955 CENTRAL PARK AVENUE YONKERS, NEW YORK

PHONE: 914 6684673
FAX: 914 668 1831
EMAIL: FILES@TFARA.COM

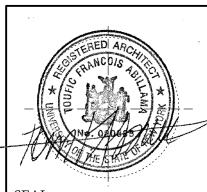

SEAL

KEY PLAN


PROPOSED ONE FAMILY DWELLING EXPANSION

99 BYRAM RIDGE RD., ARMONK, N.Y SBL: 101.01/1/13 ZONE: R-1A

3D

RENDERINGS

Project ID / DATE : 2048/ 10.15.2020
Sheet Scale:

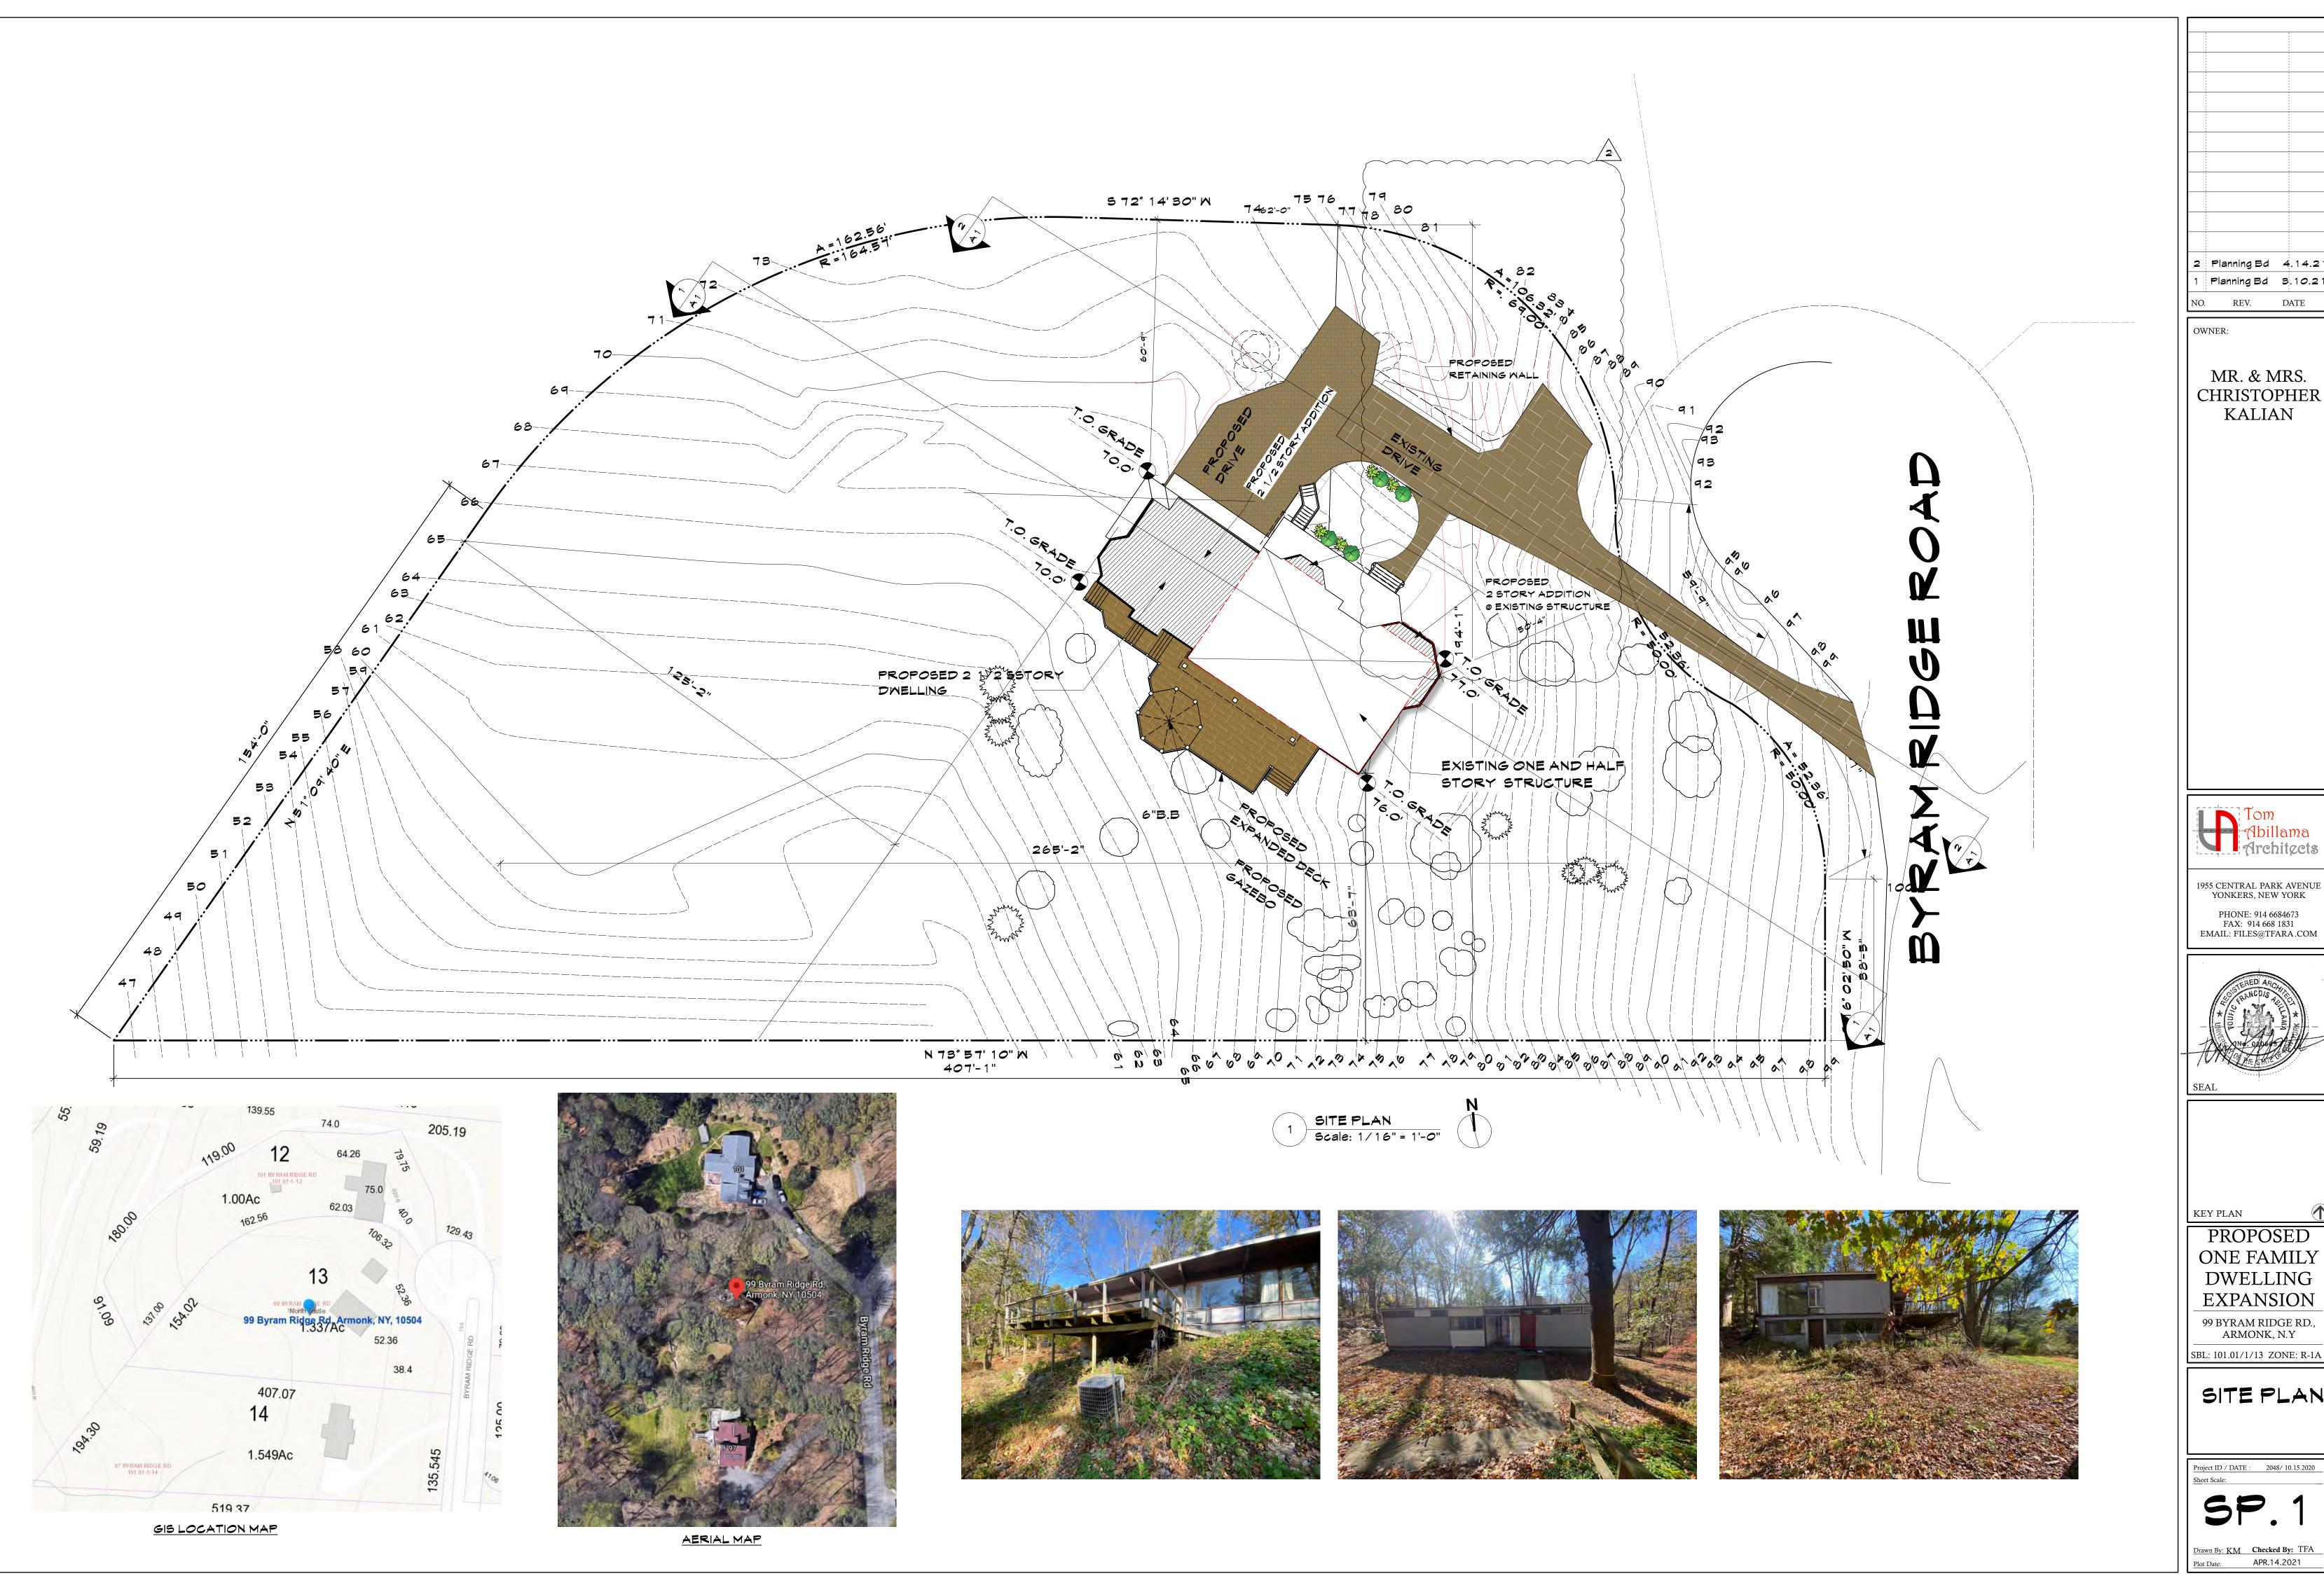

2 Planning Bd 4.14.21 Planning Bd 3.10.21 NO. REV. DATE

MR. & MRS. CHRISTOPHER KALIAN



1955 CENTRAL PARK AVENUE YONKERS, NEW YORK PHONE: 914 6684673 FAX: 914 668 1831 EMAIL: FILES@TFARA.COM



PROPOSED ONE FAMILY **DWELLING EXPANSION** 99 BYRAM RIDGE RD., ARMONK, N.Y

SITE PLAN

SP.



-EXISTING DRIVEWAY

PROVIDE

TRACKING PAD

2 Planning Bd 4.14.2

MR. & MRS.

CHRI\$TOPHER

KALIAN

Tom

1955 CENTRAL PARK AVENUI

YONKERS, NEW YORK

PHONE: 914 6684673

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PROPOSED

ONE FAMILY

DWELLING

EXPANSION

99 BYRAM RIDGE RD.,

ARMONK, N.Y

SBL: 101.01/1/13 ZONE: R-1A

FAX: 914 668 1831

. Architects

REV.

OWNER:

Planning Bd 3.10.2

DATE

(11) 280 HD

SILT FENCE

STRUCTURE

SQIL STOCKPILE

RECHARGERS

CRUSHED STONE


& PROPERTY LINE

SURROUNDED BY 12-INCHES OF

BOTTOM IMPERMEABLE LINER

MIN 10 FT FROM STRUCTURE

CULTEC RECHARGER 280HD

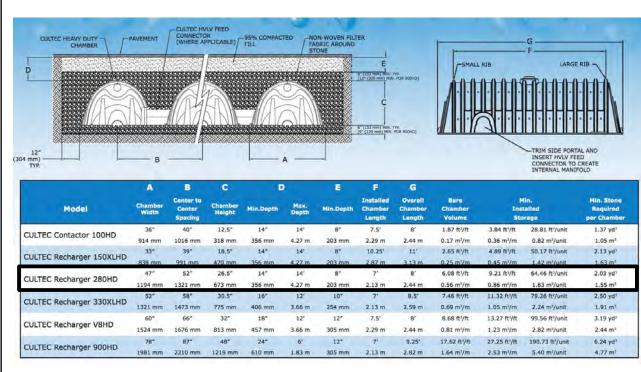

Storm Water Design

Storm Design based on a 9inch storm in 24 hours (Using 280XLHD shallow galley rechargers)

The existing lot involves 1 family dwelling, driveway, pool, deck.

The existing lot area is 58239 ft2. The total proposed impermeable surfaces (house and paved areas) add up to 5,454 ft2. The following is a stormwater analysis for the above conditions.

Curve number for pre-developement: 75, Run off coeficient: 4.33 Curve number for post-developement: 98, Run off coeficient: 6.96 PARTS-EXECUTION Delta in run off coeficient : 6.96-4.33 = 2.63

Area X Delta / 12 = Volume (ft3) 5454 x 2.63 / 12 = 1195 ft3

<u>Percolation Capacity</u>

<u>Calculate volume:</u>

(Perc test yielded a high of 6 minutes per inch we will use a conservation rate

of 20 minutes per inch)

Area of Perc----2.23 ft2 Volume of Perc----0.196 ft3

Soil Perc Rate (SR) = Volume/Area/Time = 0.196/3.01/60 minutes layer to a density equal to adjacent original ground. $= 0.0010852 \times 60 \times 24$

Sr = 1.562 or 1.11715 with 25% clogging

280HD: VOLUME PER UNIT: Chamber 64.46C.F.

Total PERCOLATION PER CULTEC:

5' X 9' X 1.11715 = 50.27 C.F.

Volume: 64.46 + 50.27 = 114.73 Cf Total Volume 1195 / 114.73 = 10.5 OR USE 11 CHAMBERS


Proposed 11-280 Hd Rechargers.

CULTEC RECHARGER 280HD

Maintenance Guidelines

The following guidelines shall be adhered to for the operation and maintenance of the CULTEC stormwater

- A. The owner shall keep a maintenance log which shall include details of any events which would have an effect on the system's operational capacity.
- B. The operation and maintenance procedure shall be reviewed periodically and changed to meet site
- C. Maintenance of the stormwater management system shall be performed by qualified workers and shall follow applicable occupational health and safety requirements.
- **D.** Debris removed from the stormwater management system shall be disposed of in accordance with
- applicable laws and regulations.

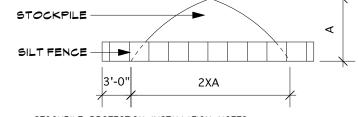

STOCKPILE PROTECTION INSTALLATION NOTES

1. SEE PLAN VIEW FOR: -LOCATION OF STOCKPILES TYPE OF STOCKPILE PROTECTION

2. INSTALL PERIMETER CONTROLS IN ACCORDANCE WITH THEIR RESPECTIVE DESIGN DETAILS LT FENCE IS SHOWN IN THE STOCKPILE PROTECTION DETAILS; HOWEVER, OTHER TYPES OF PERIMETER CONTROLS INCLUDING SEDIMENT CONTROL LOGS OR ROCK SOCKS MAY BE SUITABLE IN SOME CIRCUMSTANCES. CONSIDERATIONS FOR DETERMINING THE APPROPRIATE TYPE OF PERIMETER CONTROL FOR A STOCKPILE INCLUDE WHETHER THE STOCKPILE IS LOCATED ON A PERVIOUS OR IMPERVIOUS SURFACE, THE RELATIVE HEIGHTS OF THE PERIMETER CONTROL AND STOCKPILE, THE ABILITY OF THE PERIMETER CONTROL TO CONTAIN THE STOCKPILE WITHOUT FAILING IN THE EVENT THAT MATERIAL FROM THE STOCKPILE SHIFTS OR SLUMPS AGAINST THE PERIMETER, AND OTHER FACTORS.

3. STABILIZE THE STOCKPILE SURFACE WITH SURFACE ROUGHENING, TEMPORARY SEEDING AND MULCHING, EROSION CONTROL BLANKETS, OR SOIL BINDERS. SOILS STOCKPILED FOR AN EXTENDED PERIOD (TYPICALLY FOR MORE THAN 60 DAYS) SHOULD BE SEEDED AND MULCHED WITH A TEMPORARY GRASS COVER ONCE THE STOCKPILE IS PLACED (TYPICALLY WITHIN 14 DAYS). USE OF MULCH ONLY OR A SOIL BINDER IS ACCEPTABLE IF THE STOCKPILE WILL BE IN PLACE FOR A MORE LIMITED TIME PERIOD (TYPICALLY 30-60 DAYS).

4. FOR TEMPORARY STOCKPILES ON THE INTERIOR PORTION OF A CONSTRUCTION SITE, WHERE OTHER DOWNGRADIENT CONTROLS, INCLUDING PERIMETER CONTROL, ARE IN PLACE, STOCKPILE

E. No trees to be planted above cultec tanks and 15' away, ground planting and flower w/ shallow roots allowed STOCKPILE PROTECTION DETAIL

NOT TO SCALE

. Removing trees and other vegetation.

-SITE CLEARING PART 1 - GENERAL

- 1.1 RELATED DOCUMENTS A. Drawings and general provisions of the Contract, including General and Supplementary Conditions and Division 1 Specification Sections, apply to this Section.
- A. This Section includes the following:
- 2. Clearing and grubbing. 3. Topsoil stripping.
- 4. Removing above-grade site improvements.
- B. Related Sections include the following:
- . Division 1 Section "Construction Facilities and Temporary Controls" for temporary security and protection facilities, and environmental protection measures during site operations. 2. Division 2 Section "Earthwork" for soil materials, excavating, backfilling, and site grading operations.
- 3. Division 2 Section "Landscaping" for finish grading placing and preparing topsoil for lawns and 1.3 DEFINITIONS

friable, pervious, and black or a darker shade of brown, gray, or red than underlying subsoil; reasonably

A. Topsoil: Natural or cultivated surface-soil layer containing organic matter and sand, silt, and clau

subsoil, clay lumps, gravel, and other objects more than 2 inches (50 mm) in diameter; and free of weeds, roots, and other deleterious materials.

1.4 MATERIALS OWNERSHIP A. Except for materials indicated to be stockpiled or to remain Owner's property, cleared materials shall

Contractor's property and shall be removed from the site.

1.5 SUBMITTALS A. Photographs or videotape, sufficiently detailed, of existing conditions of trees and planting, adjoining construction, and site improvements that might be mis-constructed as damage caused by site clearing. B. Record drawings according to Division 1 Section "Contract Closeout."

1. Identify and accurately locate capped utilities and other subsurface structural, electrical, and mechanical conditions. 1.6 PROJECT CONDITIONS

A. Traffic: Minimize interference with adjoining roads, streets, walks, and other adjacent occupied or

facilities during site-clearing operations. 1. Do not close or obstruct streets, walks, or other adjacent occupied or used facilities without

from Owner and authorities having jurisdiction. 2. Provide alternate routes around closed or obstructed traffic ways if required by authorities having

B. Improvements on Adjoining Property: Authority for performing indicated removal and alteration work

property adjoining Owner's property will be obtained by Owner before award of Contract. C. Notify utility locator service for area where Project is located before site clearing. PART 2 - PRODUCTS (Not Applicable)

2.1 SOIL MATERIALS A. Satisfactory Soil Materials: Requirements for satisfactory soil materials are specified in Division 2

"Earthwork."

1. Obtain approved borrow soil materials off-site when satisfactory soil materials are not available

3.1 PREPARATION A. Protect and maintain benchmarks and survey control points from disturbance during construction.

B. Provide erosion-control measures to prevent soil erosion and discharge of soil-bearing water runoff

airborne dust to adjacent properties and walkways. C. Locate and clearly flag trees and vegetation to remain or to be relocated. D. Protect existing site improvements to remain from damage during construction. 1. Restore damaged improvements to their original condition, as acceptable to Owner.

3.2 CLEARING AND GRUBBING A. Remove obstructions, trees, shrubs, grass, and other vegetation to permit installation of new

Removal includes digging out stumps and obstructions and grubbing roots. 1. Do not remove trees, shrubs, and other vegetation indicated to remain or to be relocated. 2. Cut minor roots and branches of trees indicated to remain in a lean and careful manner where such

roots and branches obstruct installation of new construction. 3. Completely remove stumps, roots, obstructions, and debris extending to a depth of 18 inches

4. Use only hand methods for grubbing within drip line of remaining trees.

B. Fill depressions caused by clearing and grubbing operations with satisfactory soil materials, unless excavation or earthwork is indicated.

. Place fill material in horizontal layers not exceeding 8-inch (200 mm) loose depth, and compact each

A. Remove sod and grass before stripping topsoil. B. Strip topsoil to whatever depths are encountered in a manner to prevent intermixing with underlying

other waste materials C. Stockpile topsoil materials away from edge of excavations without intermixing with subsoil. Grade

stockpiles to drain surface water. Cover to prevent windblown dust. 1. Limit height of topsoil stockpiles to 72 inches (1800 mm).

2. Do not stockpile topsoil within drip line of remaining trees. Dispose of excess topsoil as specified

waste material disposal.

3. Stockpile surplus topsoil and allow for re-spreading deeper topsoil. 3.4 SITE IMPROVEMENTS

A. Remove existing above- and below-grade improvements as indicated and as necessary to facilitate construction

B. Remove slabs, paving, curbs, gutters, and aggregate base as indicated. 3.5 DISPOSAL

A. Disposal: Remove surplus soil material, unsuitable topsoil, obstructions, demolished materials, and

materials, including trash and debris, and legally dispose of them off Owner's property END OF SECTION 02230

SECTION 02300 - EARTHWORK

PART 1 - GENERAL 1.1 RELATED DOCUMENTS

A. Drawings and general provisions of the Contract, including General and Supplementary Conditions and Division 1 Specification Sections, apply to this Section. 1.2 SUMMARY

A. This Section includes the following: 1. Preparing sub-grades for slabs-on-grade, walks, pavements, lawns, and plantings.

2. Excavating and backfilling for buildings and structures. 3. Drainage course for slabs-on-grade.

4. Sub-base course for concrete walks and pavements. 5. Base course for asphalt paving.

6. Subsurface drainage backfill for walls and trenches. 7. Excavating and backfilling trenches within building lines. 8. Excavating and backfilling trenches for buried mechanical and electrical utilities and pits for buried

utility structures. B. Related Sections include the following:

1. Division 1 Section "Construction Facilities and Temporary Controls." 2. Division 2 Section "Site Clearing" for site stripping, grubbing, removing topsoil, and protecting trees to remain.

4. Division 3 Section "Cast-in-Place Concrete" for granular course over vapor retarder. 5. Division 15 through 16 Sections for excavating and backfilling buried mechanical and electrical utilities and buried utility structures.

3. Division 2 Section "Landscaping" for finish grading, including placing and preparing topsoil for lawns

1.3 DEFINITIONS A. Backfill: Soil materials used to fill an excavation.

1. Initial Backfill: Backfill placed beside and over pipe in a trench, including haunches to support sides

2. Final Backfill: Backfill placed over initial backfill to fill a trench. B. Base Course: Layer placed between the sub base course and asphalt paving. C. Bedding Course: Layer placed over the excavated subgrade in a trench before laying pipe. D. Borrow: Satisfactory soil imported from off-site for use as fill or backfill.

E. Drainage Course: Layer supporting slab-on-grade used to minimize capillary flow of pore water.

F. Excavation: Removal of material encountered above subgrade elevations.

1 - CONTRACTOR SHALL DO ALL DEMOLITION REQUIRED FOR THE COMPLETION

OF WORK SHOWN ON DRAWINGS. 2- HE SHALL ALLOW NO DEBRIS TO ACCUMULATE AND SHALL HAUL AWAY FROM SITE ALL DEBRIS AT

CONTRACTOR'S EXPENSE.

3- HE SHALL PROVIDE PROTECTION OF ALL ADJACENT OR NEIGHBOURING PROPERTY FROM DAMAGE, INJURY

AND DISCOMFORT CAUSED BY DUST. HE SHALL PROTECT UTILITY LINES AS REQUIRED.

excavation and replacement material will be paid for according to Contract provisions for changes in 2. Bulk Excavation: Excavations more than 10 feet (3 m) in width and pits more than 30 feet (9 m) in

either length or width. 3. Unauthorized Excavation: Excavation below subgrade elevations or beyond indicated dimensions

without direction by Architect. Unauthorized excavation, as well as remedial work directed by Architect, shall be without additional compensation. G. Fill: Soil materials used to raise existing grades. H. Structures: Buildings, footings, foundations, retaining walls, slabs, tanks, curbs, mechanical and electrical appurtenances, or other man-made stationary features constructed above or below the round surface.

EXTENT OF SOIL EROSION

CONTROL STRIP

SILT FENCE

I. Sub base Course: Layer placed between the subgrade and base course for asphalt paving, or layer placed between the subgrade and a concrete pavement or walk. J. Subgrade: Surface or elevation remaining after completing excavation, or top surface of a fill or backfill

immediately below sub base, drainage fill, or topsoil materials. K. Utilities include on-site underground pipes, conduits, ducts, and cables, as well as underground services within

1.4 SUBMITTALS A. Product Data: For the following:

1. Each type of plastic warning tape. 2. Drainage fabric

3. Separation fabric.

B. Samples: For the following:

1. 30-lb (14-kg) samples sealed in airtight containers, of each proposed soil material from on-site or borrow sources.

2. 12-by-12-inch (300-by-300-mm) sample of drainage fabric. 3. 12-by-12-inch (300-by-300-mm) sample of separation fabric.

C. Material Test Reports: From a qualified testing agency indicating and interpreting test results for compliance of the following with requirements indicated: 1. Classification according to ASTM D 2487 of each on-site or borrow soil material proposed for fill and

2. Laboratory compaction curve according to ASTM D 698 for each on-site or borrow soil material proposed for fill and backfill.

D. Seismic survey agency report, for record purposes.

1.5 QUALITY ASSURANCE A. Geotechnical testing Agency Qualifications: An independent testing agency qualified according to ASTM E 329 to conduct soil materials and rock-definition testing, as documented according to ASTM D 3740 and ASTME 548.

SOIL EROSION NOTES:

1. PRIOR TO STARTING ANY CONSTRUCTION, TEMPORARY SILT TRAPS, SEDIMENTATION FENCES AND OTHER APPROVED SOIL CONTROL MEASURES SHALL BE PLACED AS REQUIRED. ADDITIONAL SEDIMENT CONTROL MEASURES SHALL BE INSTALLED WHERE DEEMED NECESSARY, TO SUPPLEMENT THE EROSION CONTROL DETAILS AS SHOWN ON THIS DRAWING.

2. CONTRACTOR SHALL TAKE EXTRA CARE WITH RESPECT TO LAND EXPOSED DURING DEVELOPMENT. THE EXPOSED LAND AREA SHALL BE KEPT TO A MIN. TIME PERIOD. PERMANENT SITE IMPROVEMENT METHODS AND STRUCTURES SHALL TAKE PLACE AT THE EARLIEST POSSIBLE OPPORTUNITY.


3. CONTRACTOR SHALL ENSURE THE MAINTENANCE OF SOIL EROSION FENCES AS PER REQUIREMENTS OF MUNICIPAL AUTHORITIES HAVING JURISDICTION THEREOF. 4. CONTRACTOR SHALL ALLOW TO A MINIMUM POSSIBLE THE SEDIMENTATION DEBRIS

TO THE PUBLIC AND PRIVATE ADJOINING AREAS AND SHALL ASSUME RESPONSIBILITY

FOR SUCH CONDITIONS. HE SHALL BRUSH CLEAN ALL DEBRIS FROM SIDEWALKS AND

5. METHODS FOR OPEN EXCAVATION EMBANKMENTS NOT REQUIRING SILT FENCES OR STRAW BALES CAN BE EMPLOYED SUBJECT TO SOIL CONDITIONS AND WHERE SLOPES DO NOT EXCEED A PITCH OF 8" IN 12". LOOSE STONE AND ROCK SHALL REMOVED FROM SITE, COMPACTED AND SEEDED TOP SOIL SHALL BE INSTALLED FOR SOIL PROTECTION.

6. UNLESS OTHERWISE AGREED BY SEPARATE CONTRACT. THIS ARCHITECT HAS NOT BEEN RETAINED FOR CONSTRUCTION ADMINISTRATION RELATED TO THE WORK THEREOF.

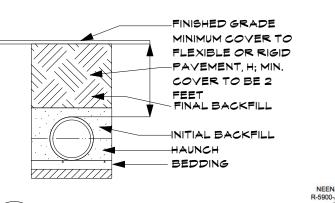

PIPE TRENCH DETAIL

Scale: 1/2" = 1'-0"

FILTER CLOTH (STABI-LINKA T 140N BY MIRAFI)

TO BE FASTENED SECURELY TO POSTS @ TOP

6" MIN. INTO GROUND. OVERLAPS TO BE MIN. 6"

UNDISTURBED GROUND

AND MID SECTIONS AND EMBEDDED MIN.

14.5" [368 mm] |-2'-6" 12.0" [305 mm] MIN 12.0" [300 mm] SDR-35 / SCH. 40 PVC COLLAR FIELD PLACED CLASS "C" CONCRETE 4.0" [100 mm] SDR-35 / SCH. 40 PVC ENDCAP CLEAN-OUT

ADAPTER WI SCREW NAME AND ADAPTER WIND ADAPTER WI SCREW NAME AND ADAPTER WIND ADAP - 4.0" [100 mm] SDR-35 / SCH. 40 PVC RISER 4.0" [100 mm] SDR-35 / SCH. 40 PVC COUPLING

R-5900-A (OR EQUAL) HEAVY DUTY FRAME AND LID PLAN VIEW TRIM CHAMBER INSPECTION PORT KNOCK-OUT TO MATCH O.D. OF 4.0" [100 mm] INSPECTION PORT PIPE CONCRETE TO 2" X 2" X 36" MIN. HEIGHT HARDWOOD FENCE POST @ 10'-0" OC MAX. POSTS TO BE DRIVEN 16" MIN. INTO GROUND.

NOT TO SCALE **OUTLET CONTROL STRUCTURE (OCS)** PROPOSED GRADE SEGMENTED RETAINING WALL (BY LIBERTY STONE) 12" GRAVEL FILL T.O. DRIVE CONCRETE LEVELING PAD -FOUNDATION SOIL

Scale: 1/2" = 1'-0"

SILT FENCE DETAIL

DEMOLITION NOTE: CONTRACTOR TO REMOVE ALL STRUCTURES AND PAVEMENTS AS INDICATED WITHOUT UNDERMINING THE STRUCTURAL

TO REMOVE ALL FOUNDATIONS AND FOOTINGS AS REQUIRED. CONTRACTOR TO ABIDE BY ALL ENVIRONMENTAL REQUIREMENTS, SUCH AS NOISE, DUST CONTROL, ASBESTOS ABATEMENT, RODENT CONTROL, ETC. ALL MATERIALS TO BE REMOVED SHALL BE DISPENSED OF IN PROPPER MANNER AND AS PER REQUIREMENTS OF THE VILLAGE OF LARCHMONT AND THE COUNTY OF WESTCHESTER.

INTEGRITY OF THE ADJACENT NEIGHBORING PROPERTIES.

SHORING AND BRACING: 1- CONTRACTOR SHALL PROTECT SITE FROM CAVING AND SOIL MOVEMENT.HE SHALL LOCATE SYSTEMS TO CLEAR PERMANENT CONSTRUCTION AND TO PERMIT FORMING AND FINISHING OF CONCRETE SURFACES.

ANY STRUCTURAL DAMAGE PRIOR TO DEMOLITION.

CONTRACTOR TO MAKE OWNER/ARCHITECT AWARE OF

2- CONTRACTOR SHALL LOCATE BRACING TO CLEAR COLUMNS, FLOOR FRAMING CONSTRUCTION, AND OTHER PERMANENT WORK. INSTALL NEW BRACE PRIOR TO REMOVING OLD BRACE.

ELEVATION


TRACKING PAD DIAGRAM


DETAIL @ SEGMENTED RETAINING WALL 1" TYPE 2A BITUMINOUS CONCRETE 2" BITUMINOUS CONC BINDER COURSE 4" PREMIXED BITUMINOUS CONC. BASE 6" ROLLED GRAVEL BASE COURSE COMPACTED SUBGRADE PAVEMENT DETAIL Scale: 1/2" = 1'-0"

STORMWATER CALCULATIONS AND DESIGN

> Project ID / DATE : 2048/ 10.15.2020 Sheet Scale:

Drawn By: KM Checked By: TFA APR.14.2021

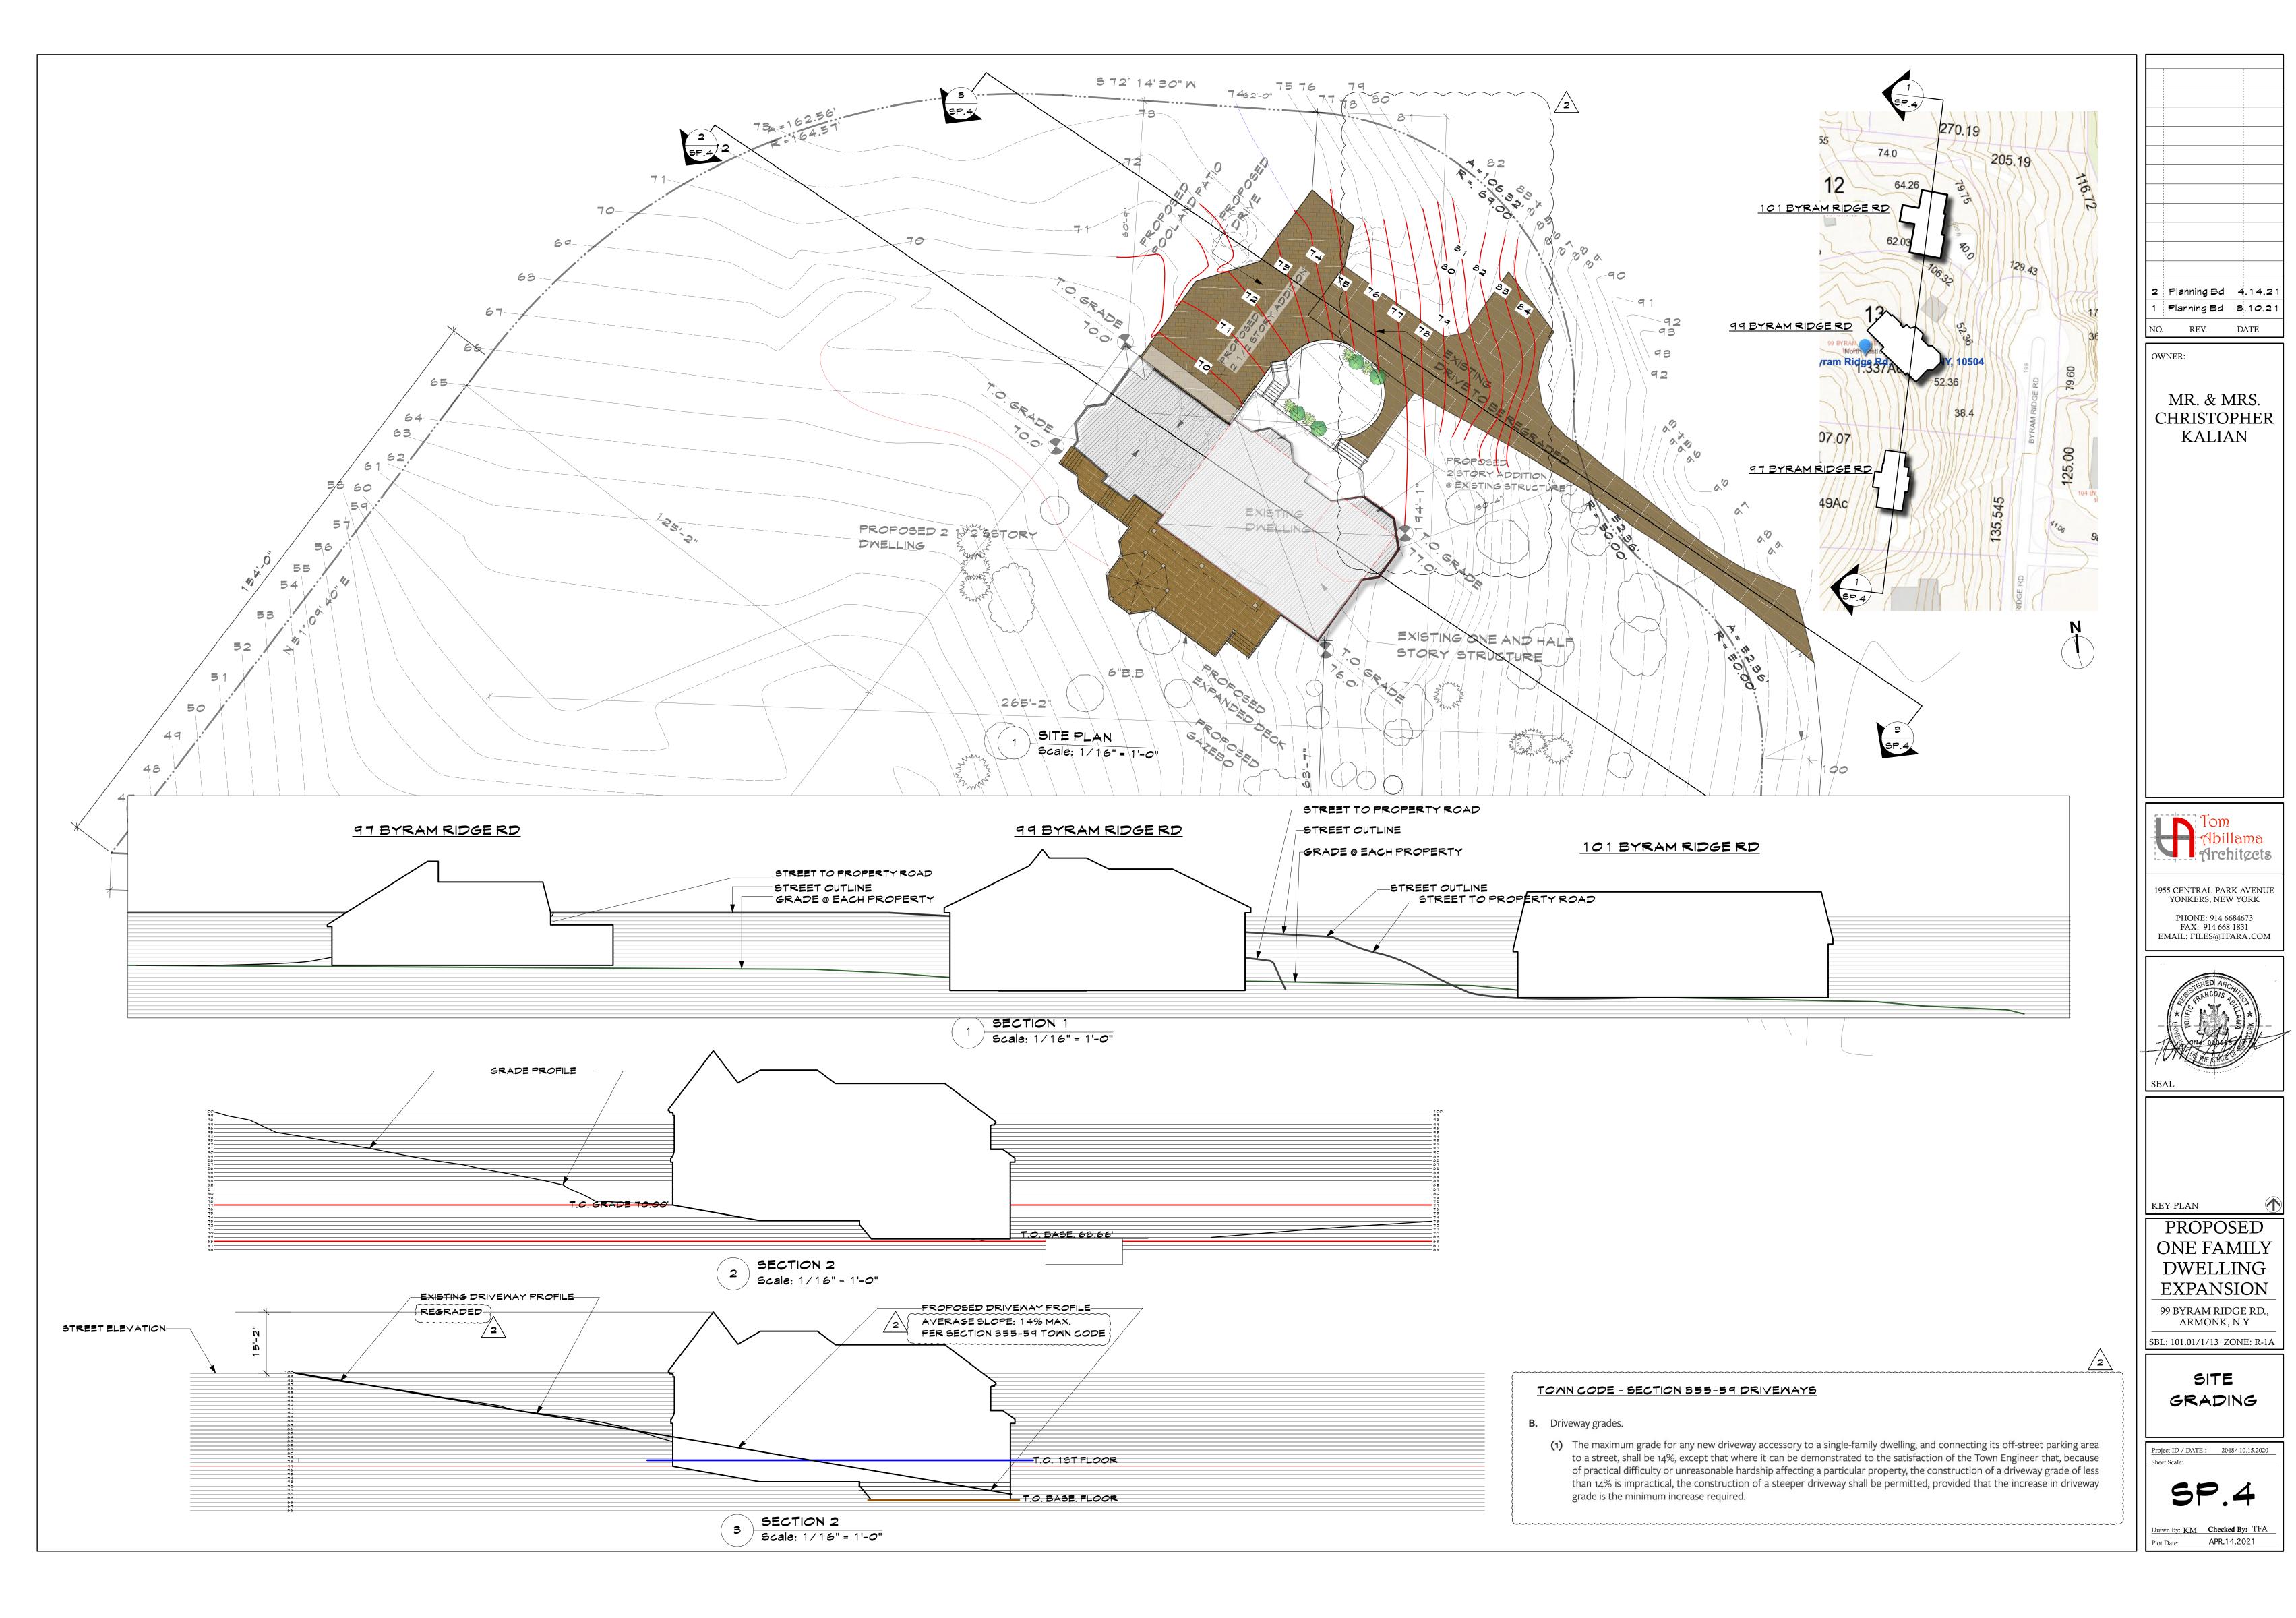

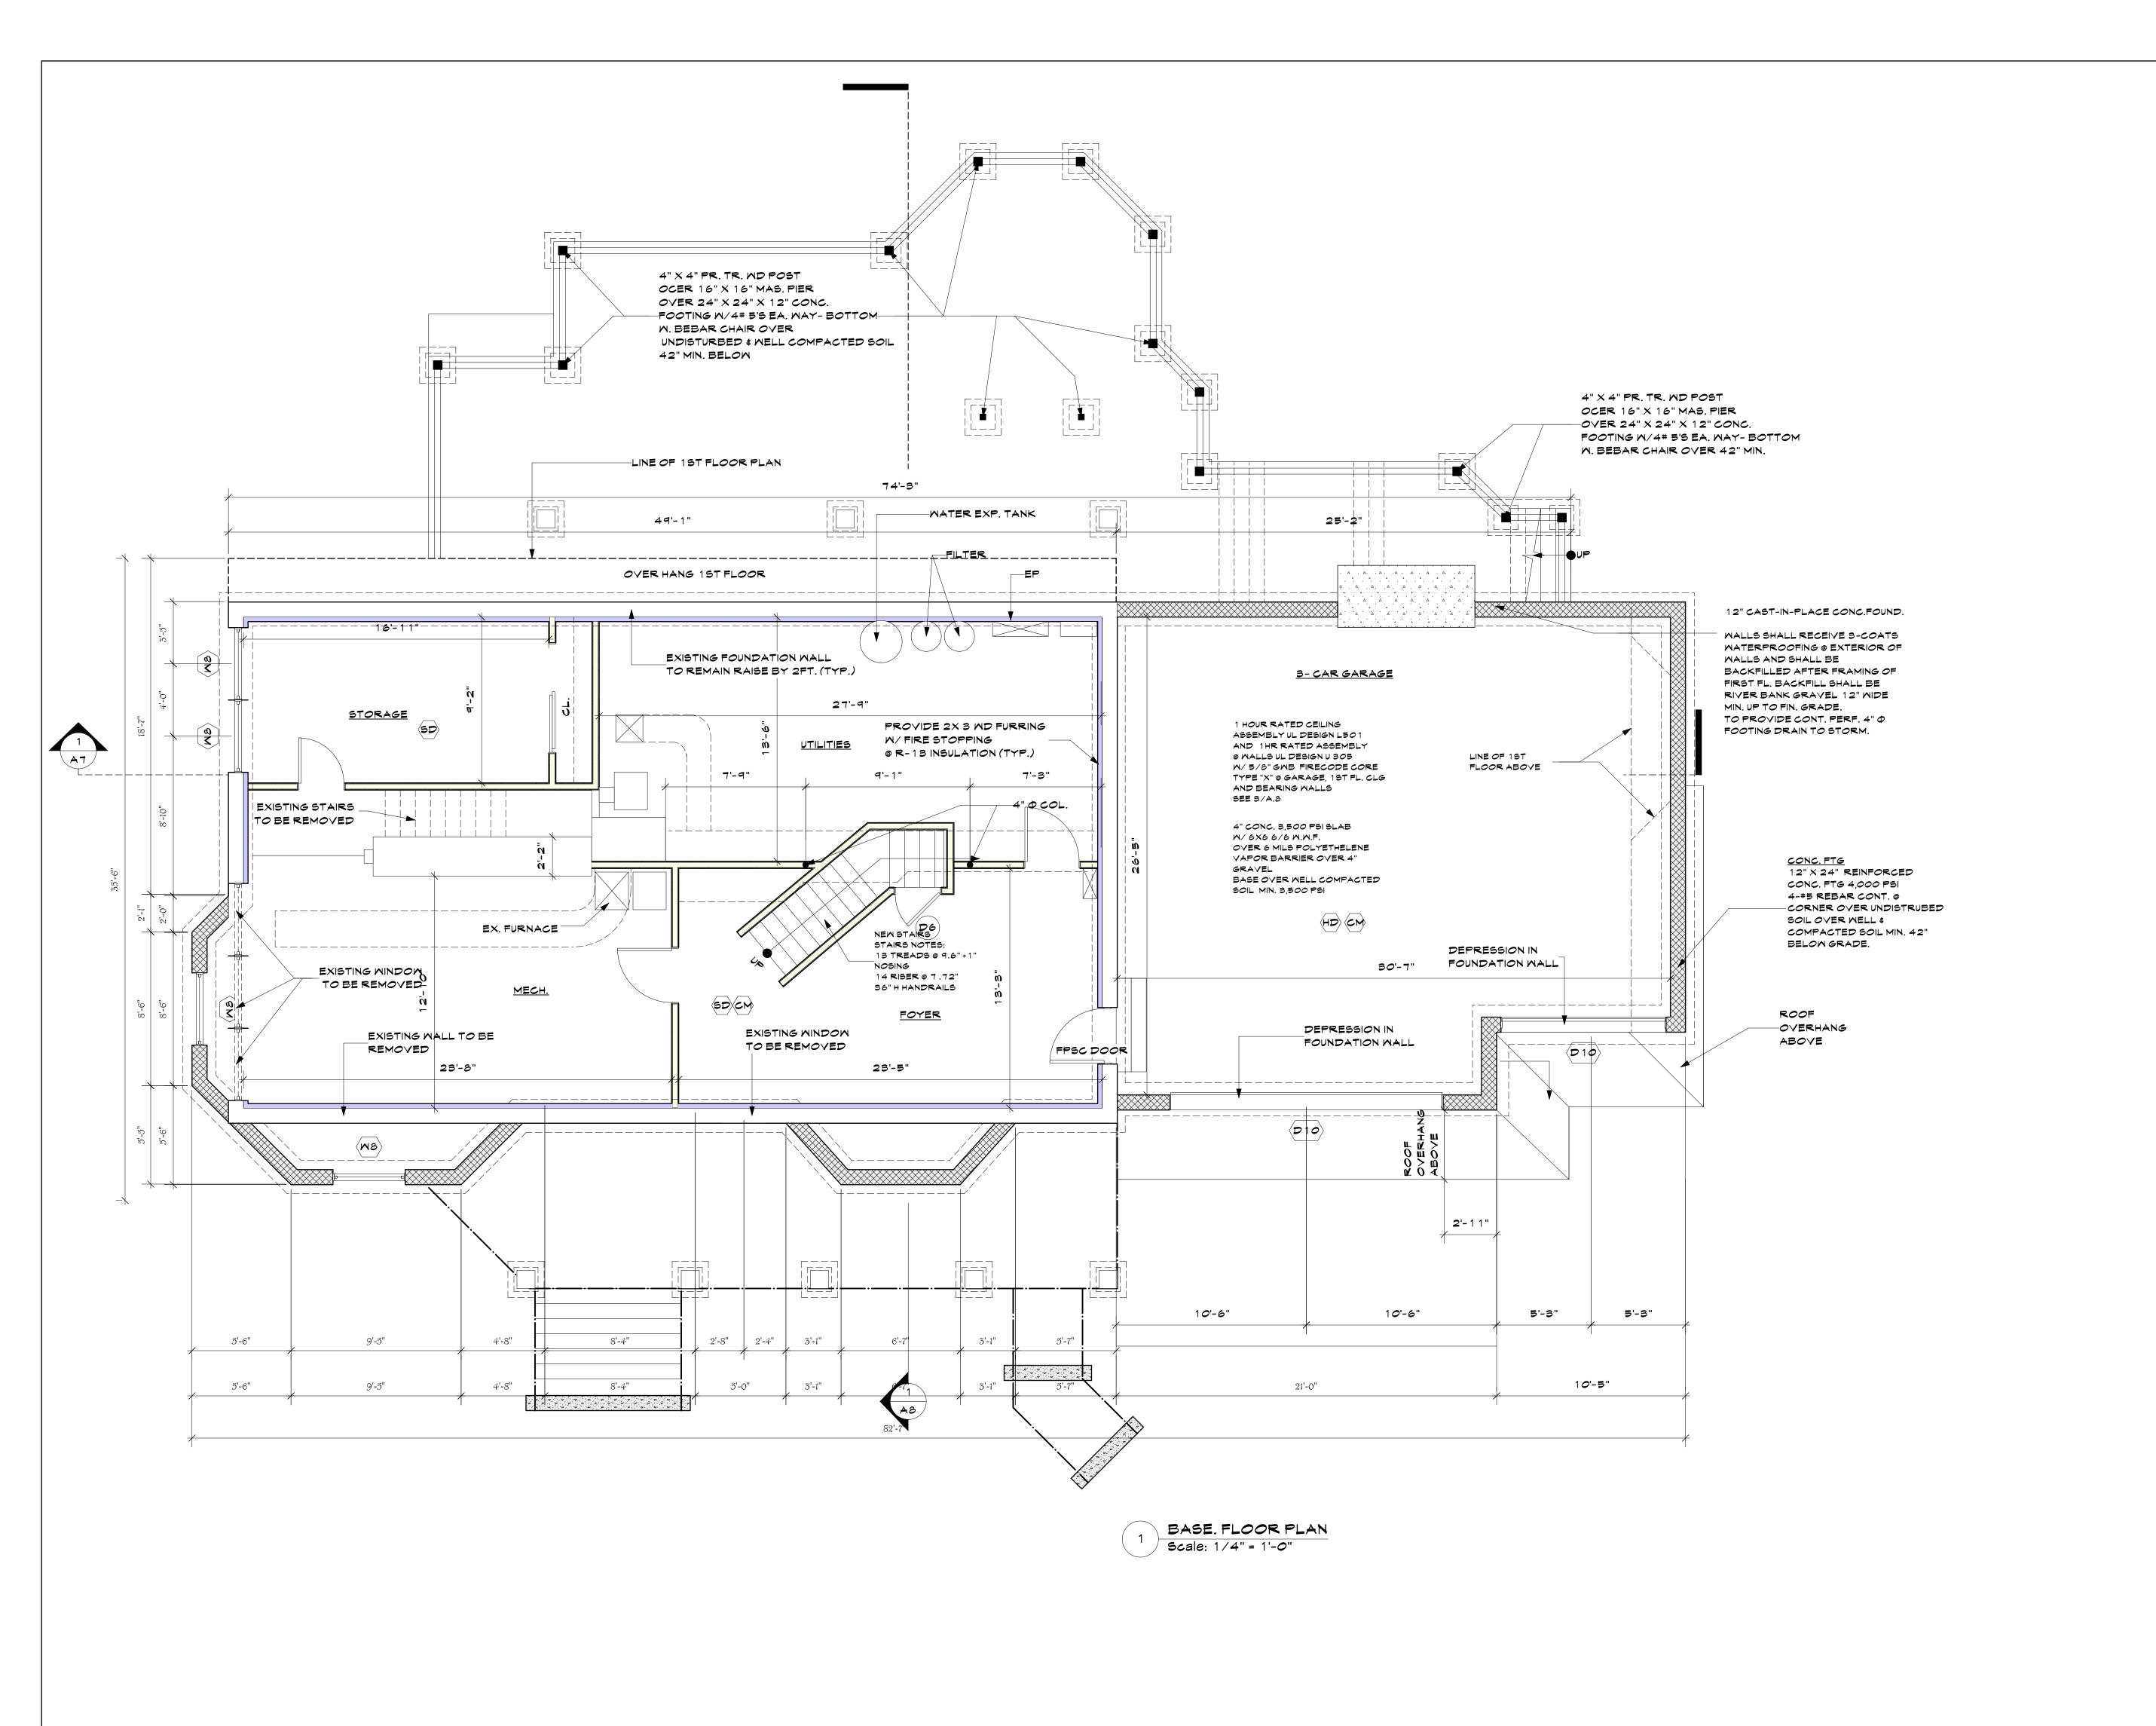

2 Planning Bd 4.14.21
1 Planning Bd 3.10.21
NO. REV. DATE

OWNER:

MR. & MRS. CHRISTOPHER KALIAN



1955 CENTRAL PARK AVENUE YONKERS, NEW YORK

PHONE: 914 6684673
FAX: 914 668 1831
EMAIL: FILES@TFARA.COM



KEY PLAN

PROPOSED
ONE FAMILY
DWELLING
EXPANSION

99 BYRAM RIDGE RD.,
ARMONK, N.Y

SBL: 101.01/1/13 ZONE: R-1A


BASMENT FLOOR PLAN

Project ID / DATE : 2048/ 10.15.2020

Sheet Scale:

A

<u>Drawn By: KM</u> **Checked By:** TFA
Plot Date: APR.14.2021

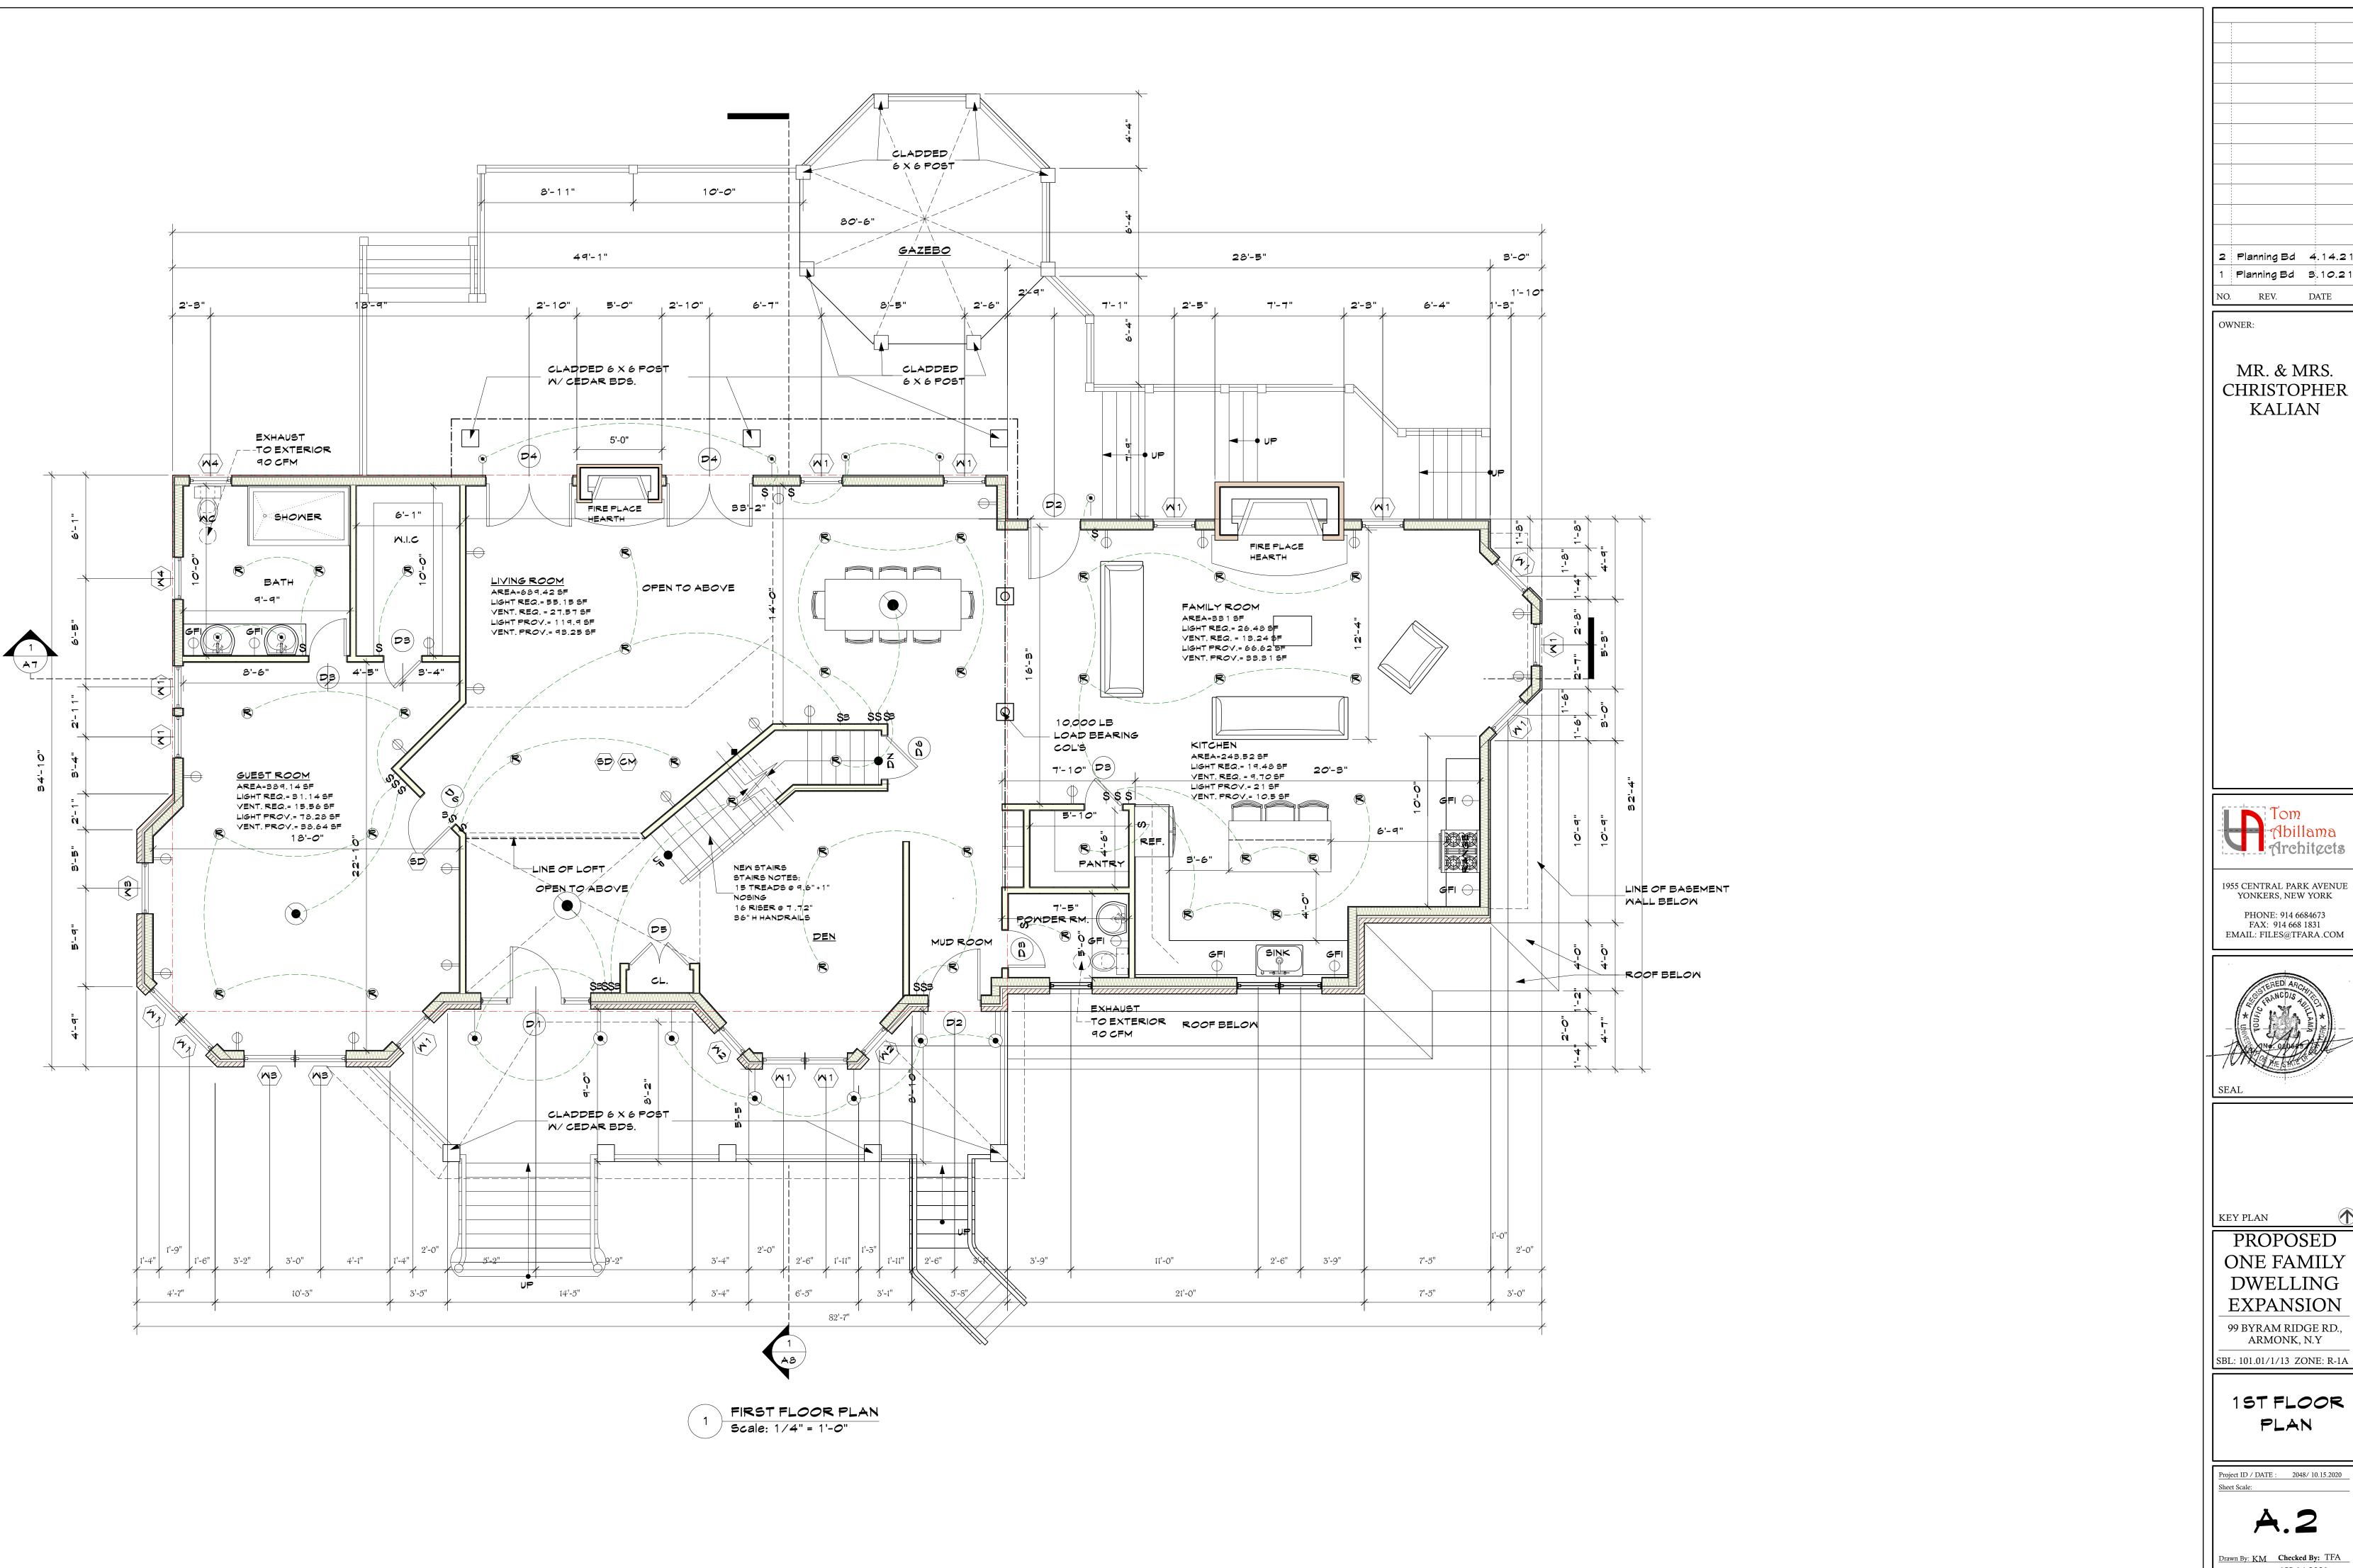

2 Planning Bd 4.14.21 1 Planning Bd 3.10.21 NO. REV. DATE

OWNER:

MR. & MRS. CHRISTOPHER KALIAN

Tom
Abillama
Architects

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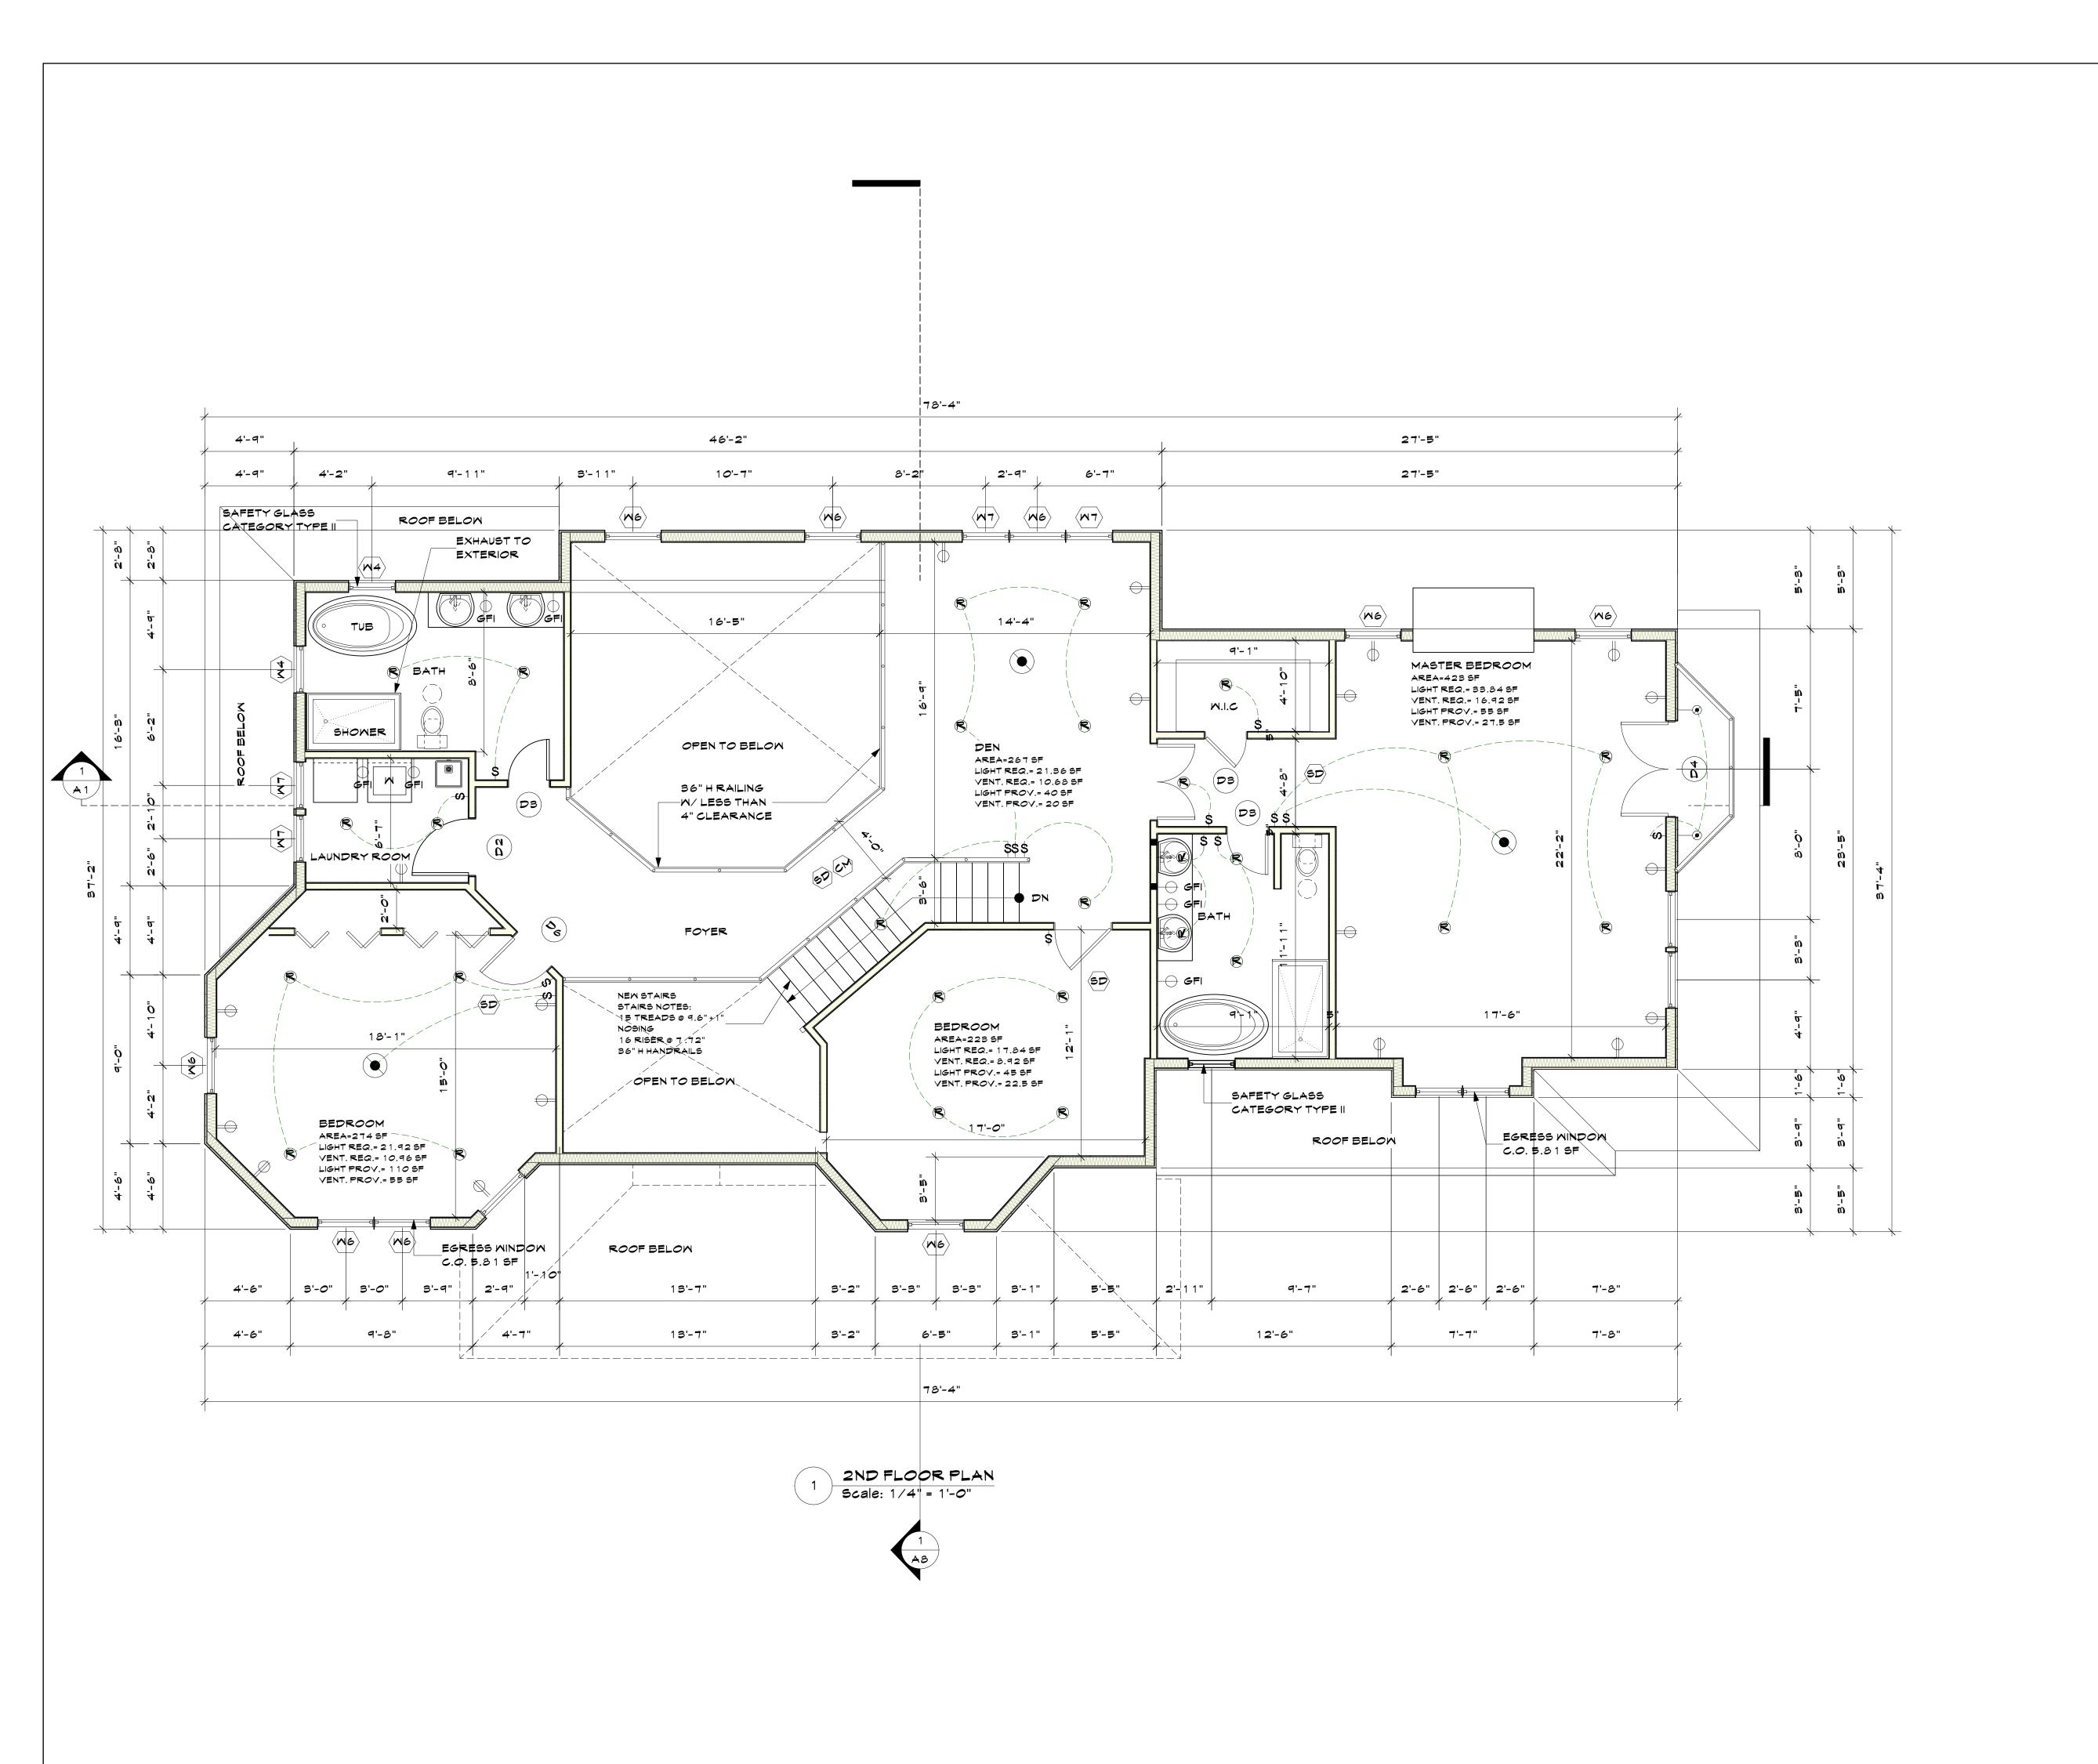
KEY PLAN


PROPOSED ONE FAMILY **DWELLING EXPANSION** 99 BYRAM RIDGE RD., ARMONK, N.Y

PLAN

Project ID / DATE: 2048/ 10.15.2020

Drawn By: KM Checked By: TFA APR.14.2021



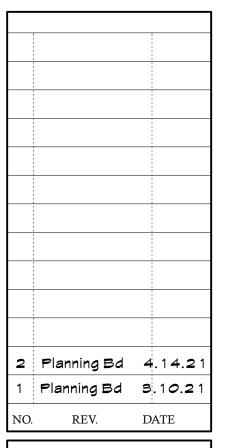

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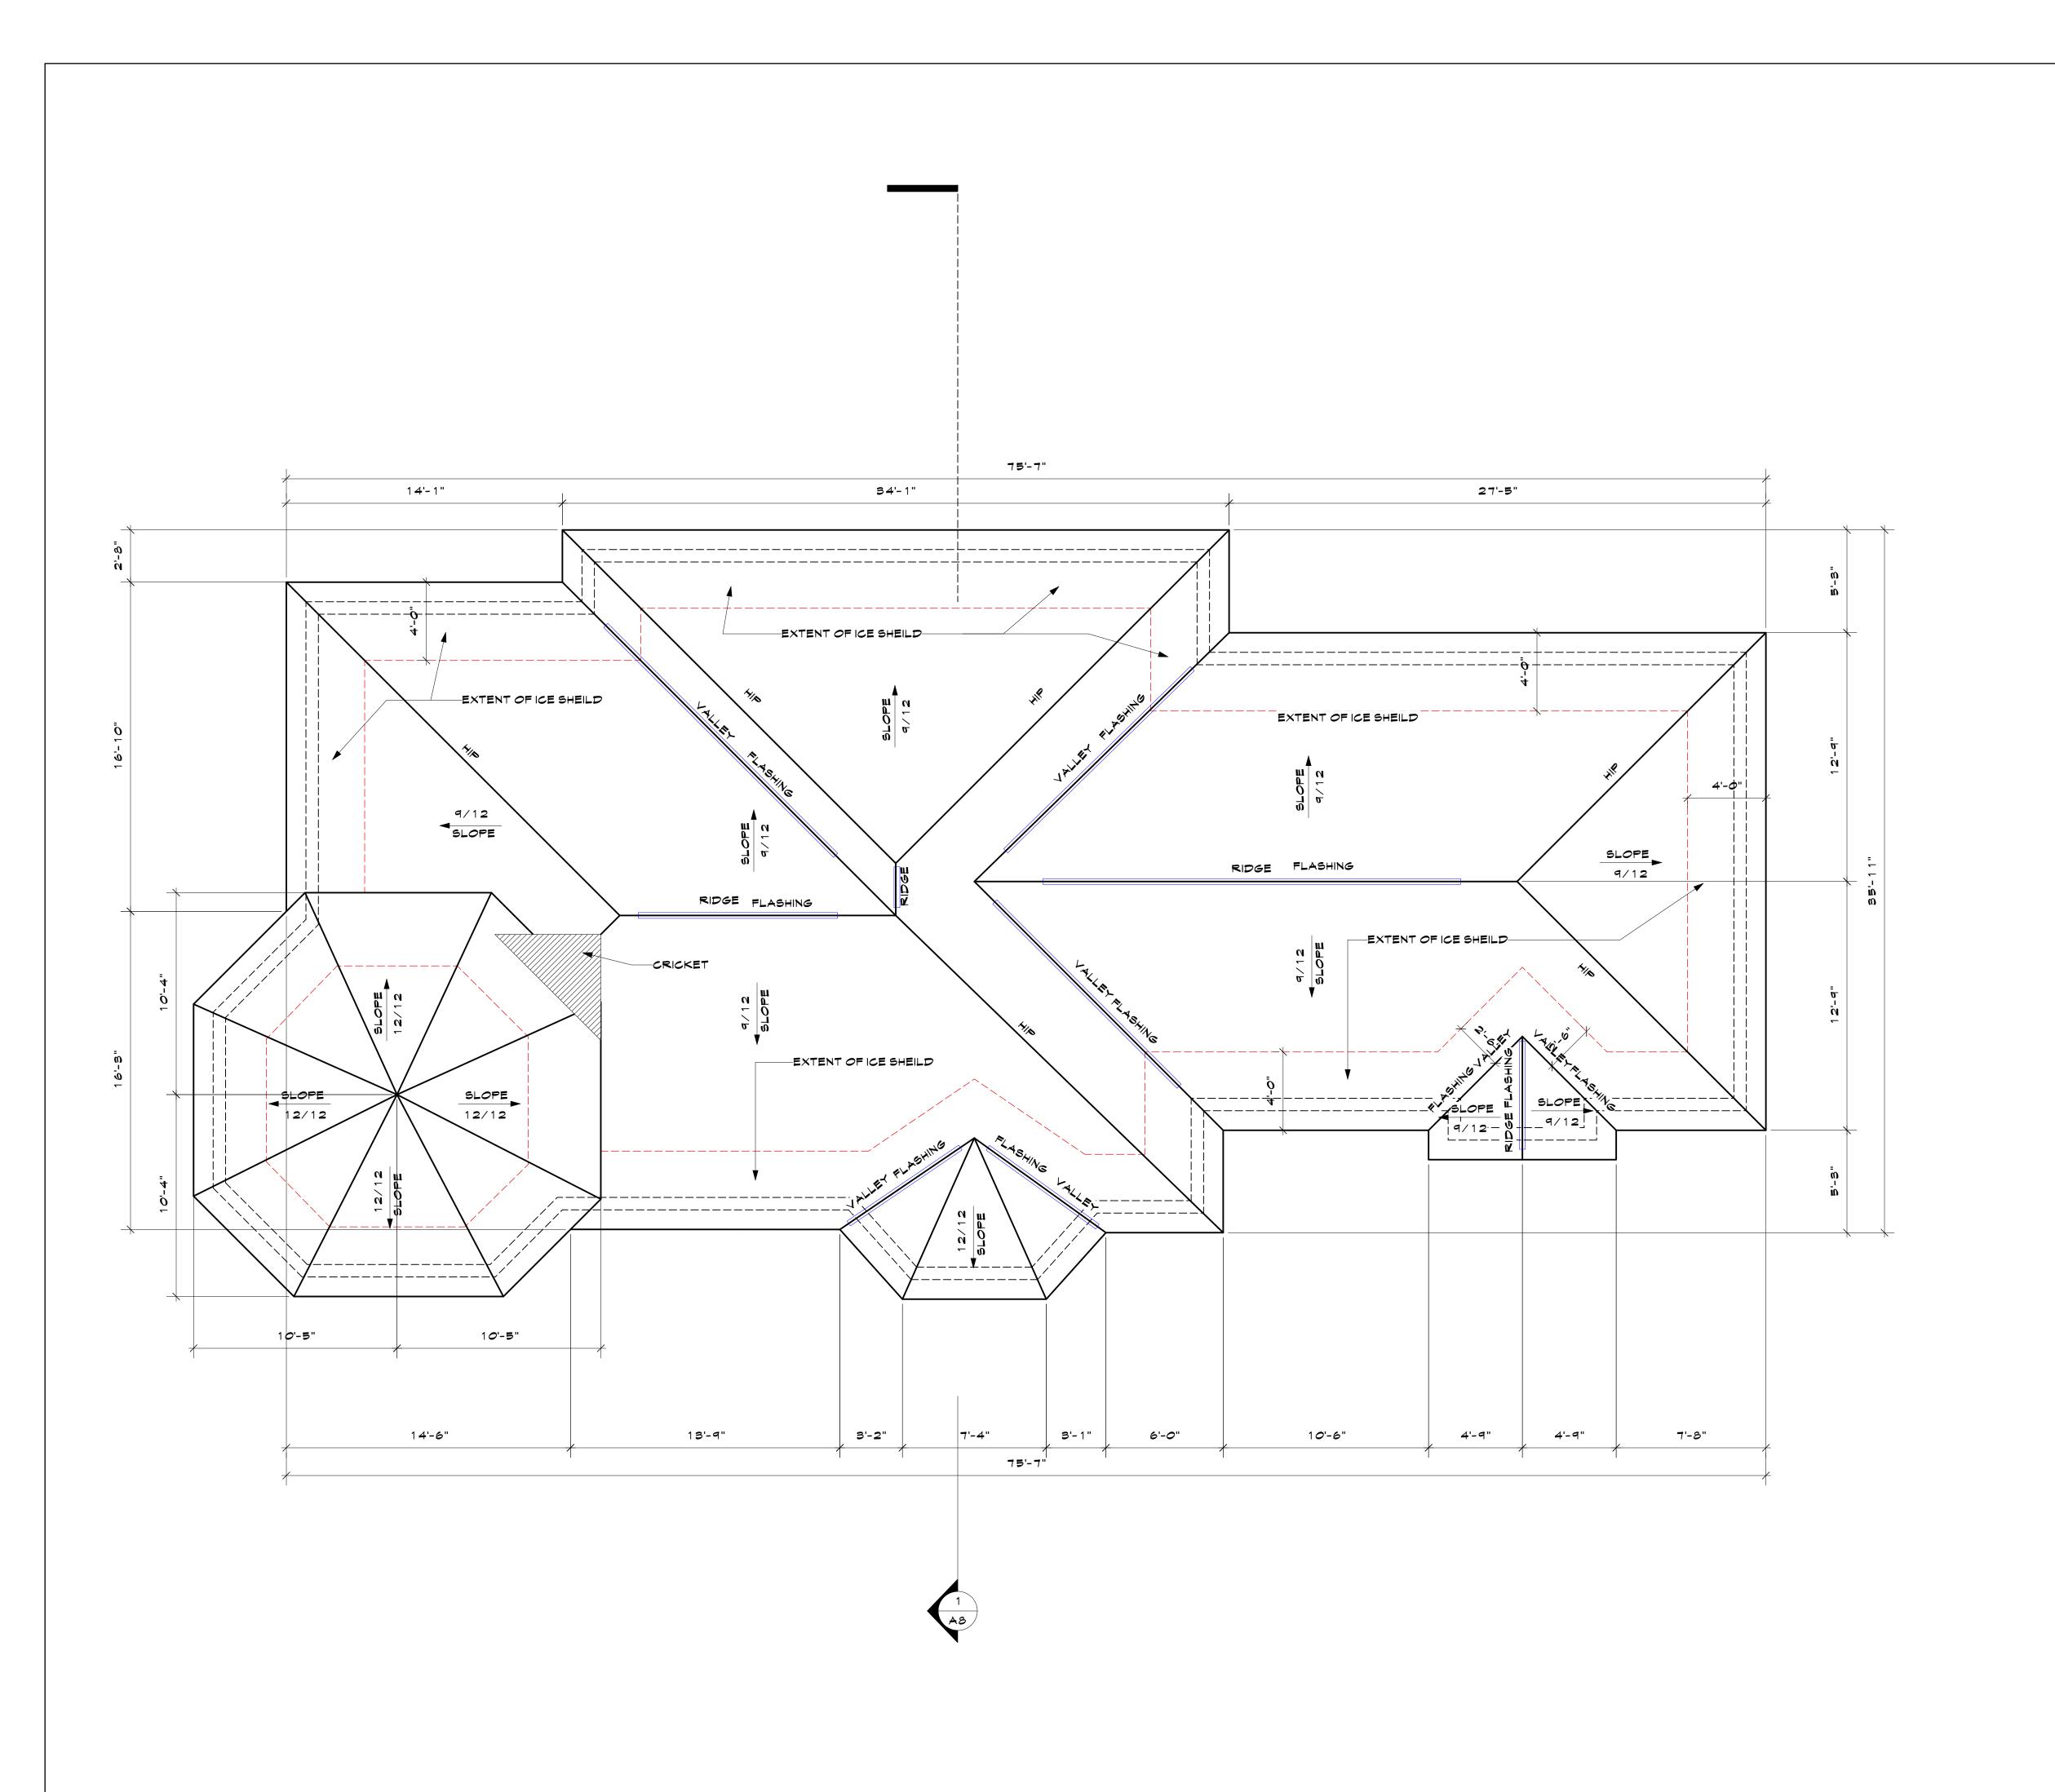
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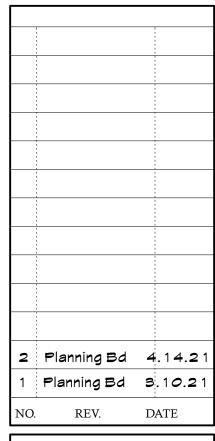
Sheet Scale:

2ND FLOOR PLAN

Project ID / DATE : 2048/ 10.15.2020

A.E





OWNER:

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EXPANSION

99 BYRAM RIDGE RD.,
ARMONK, N.Y

SBL: 101.01/1/13 ZONE: R-1A

ROOF PLAN

Project ID / DATE : 2048/ 10.15.2020



Sheet Scale:

Drawn By: KM Checked By: TFA
Plot Date: APR.14.2021



2 Planning Bd 4.14.21 Planning Bd 3.10.21 REV. DATE

MR. & MRS. CHRISTOPHER KALIAN

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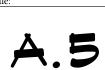


PROPOSED ONE FAMILY **DWELLING EXPANSION** 99 BYRAM RIDGE RD.,

SBL: 101.01/1/13 ZONE: R-1A


LEFT SIDE/ FRONT ELEVATION

Project ID / DATE : 2048/ 10.15.2020



Drawn By: KM Checked By: TFA APR.14.2021



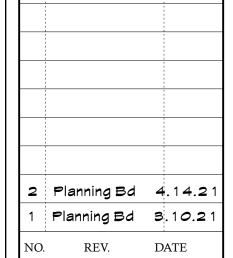

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KEY PLAN

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99 BYRAM RIDGE RD.,
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ARMONK, N.Y


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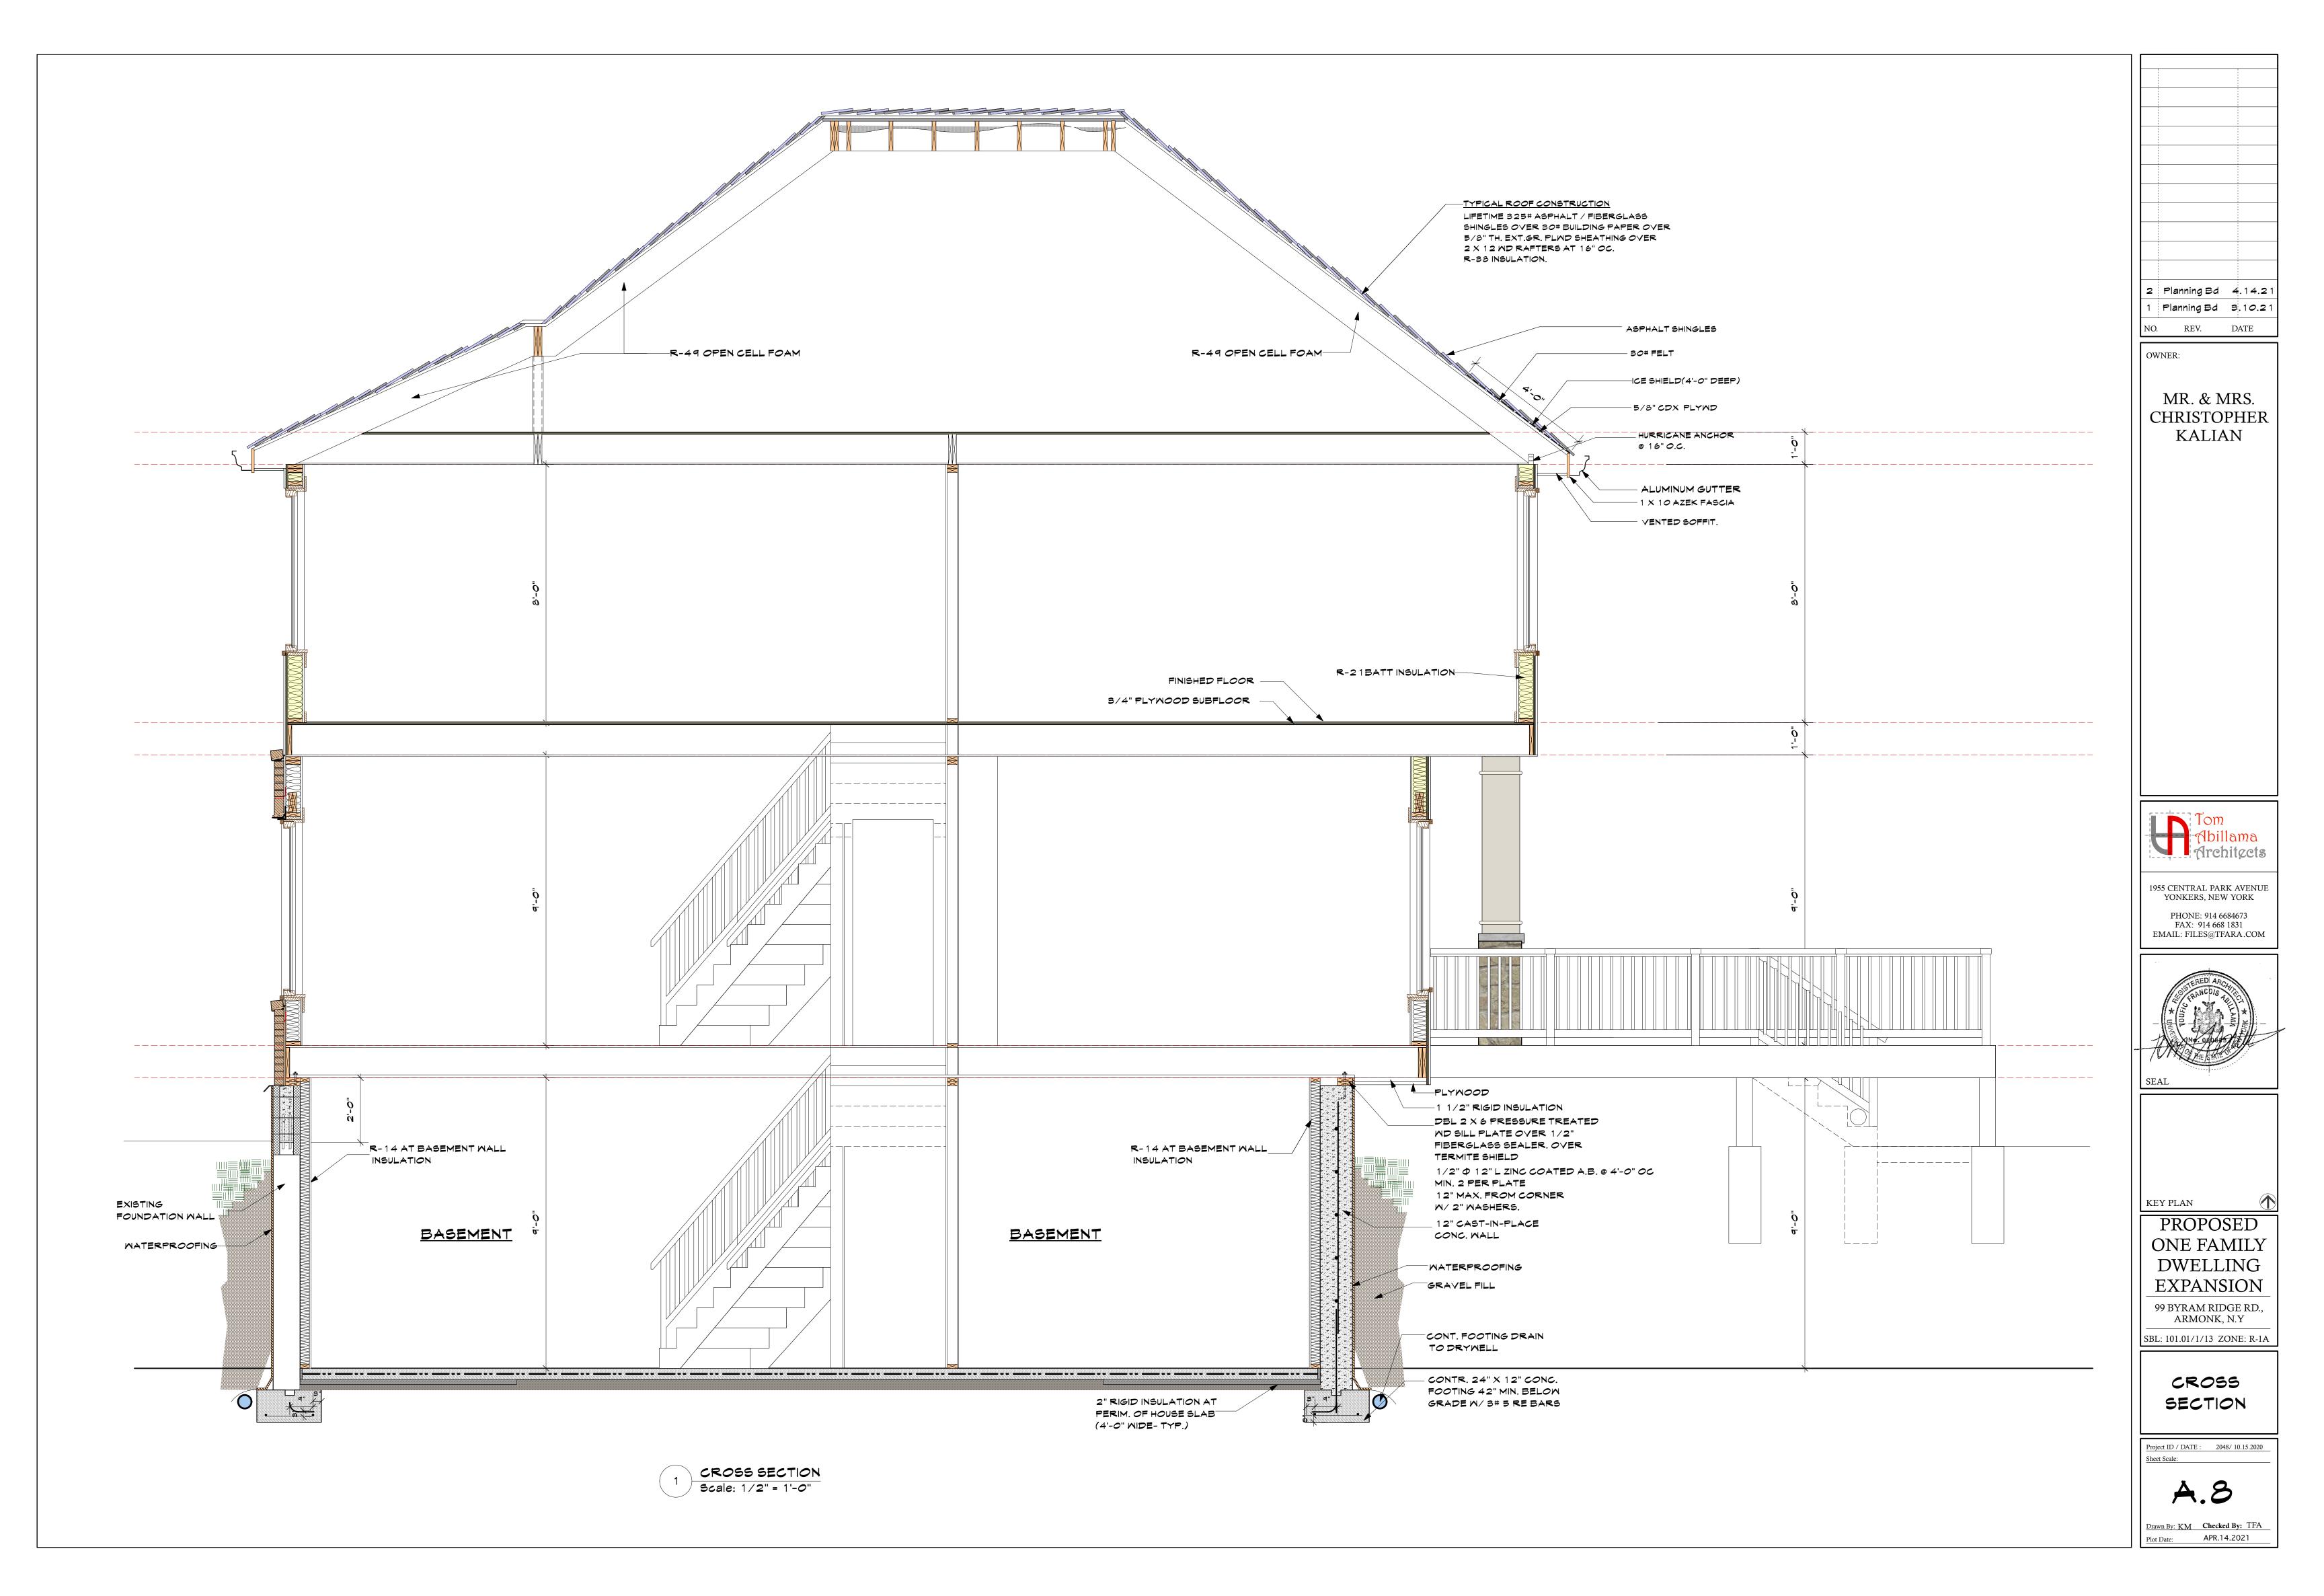
RIGHT SIDE, REAR ELEVATIONS


Project ID / DATE : 2048/ 10.15.2020

Sheet Scale:

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2 Planning Bd 4.14.21 1 Planning Bd 3.10.21 NO. REV. DATE

MR. & MRS. CHRISTOPHER KALIAN

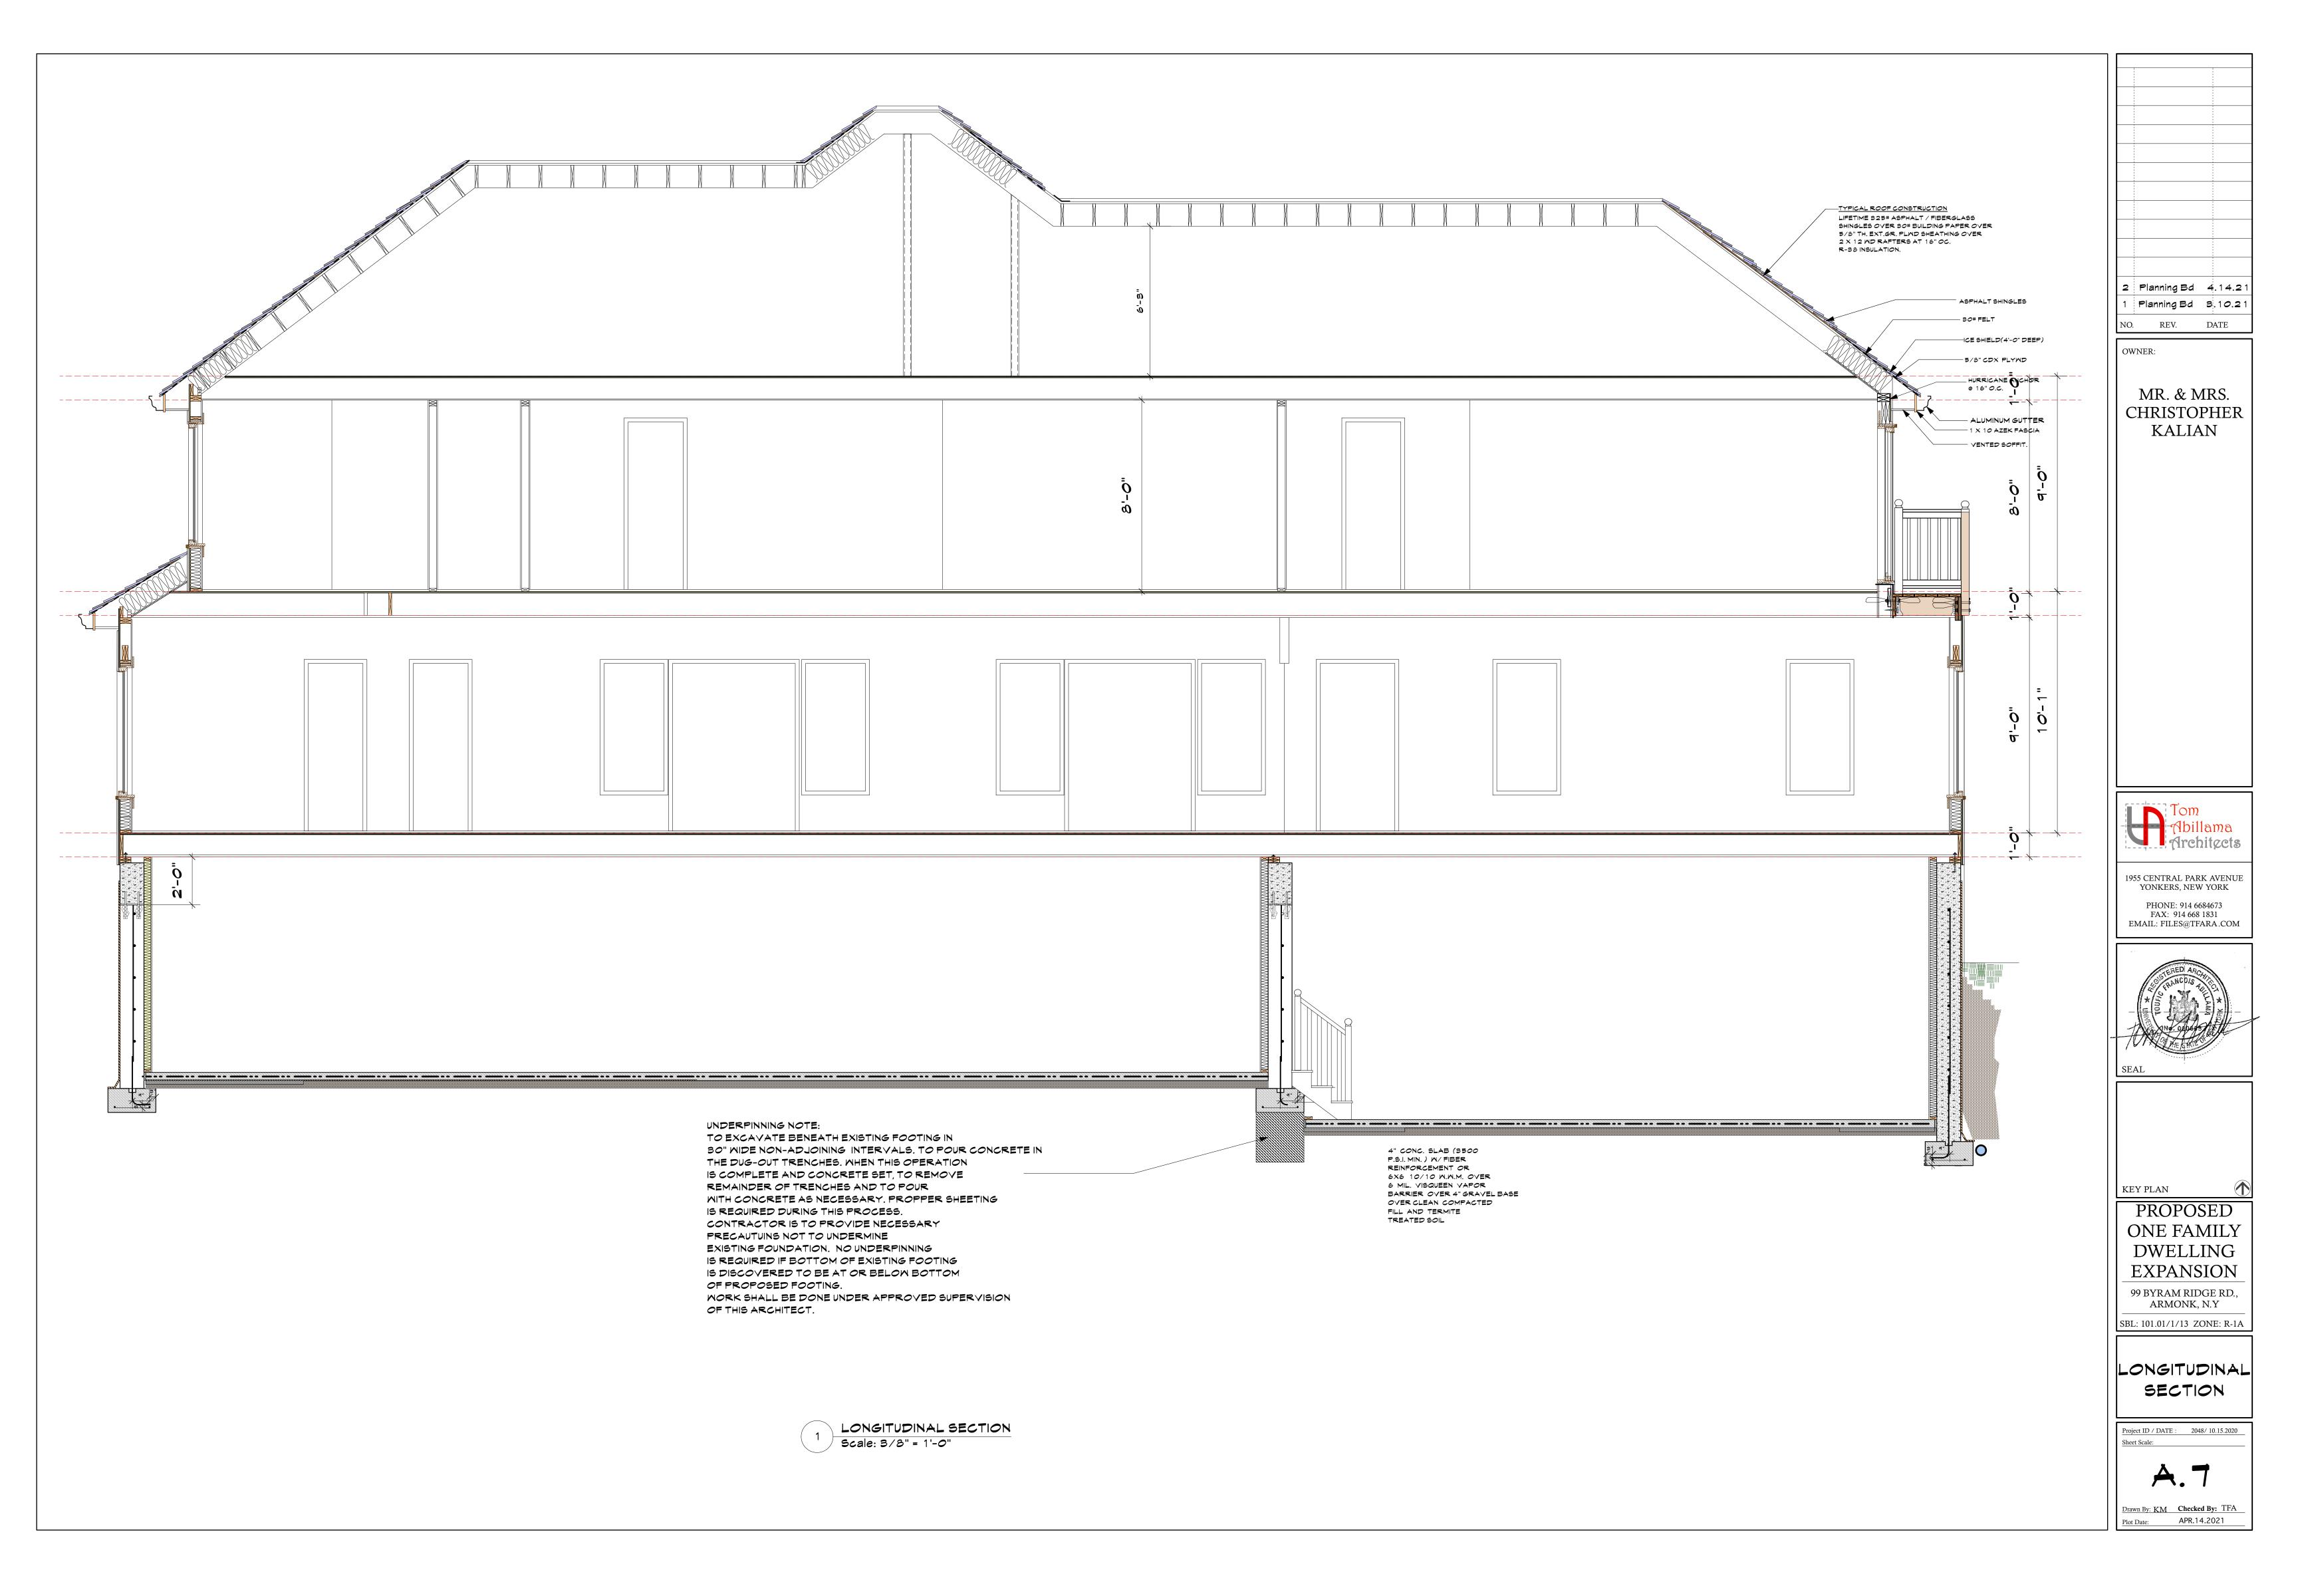
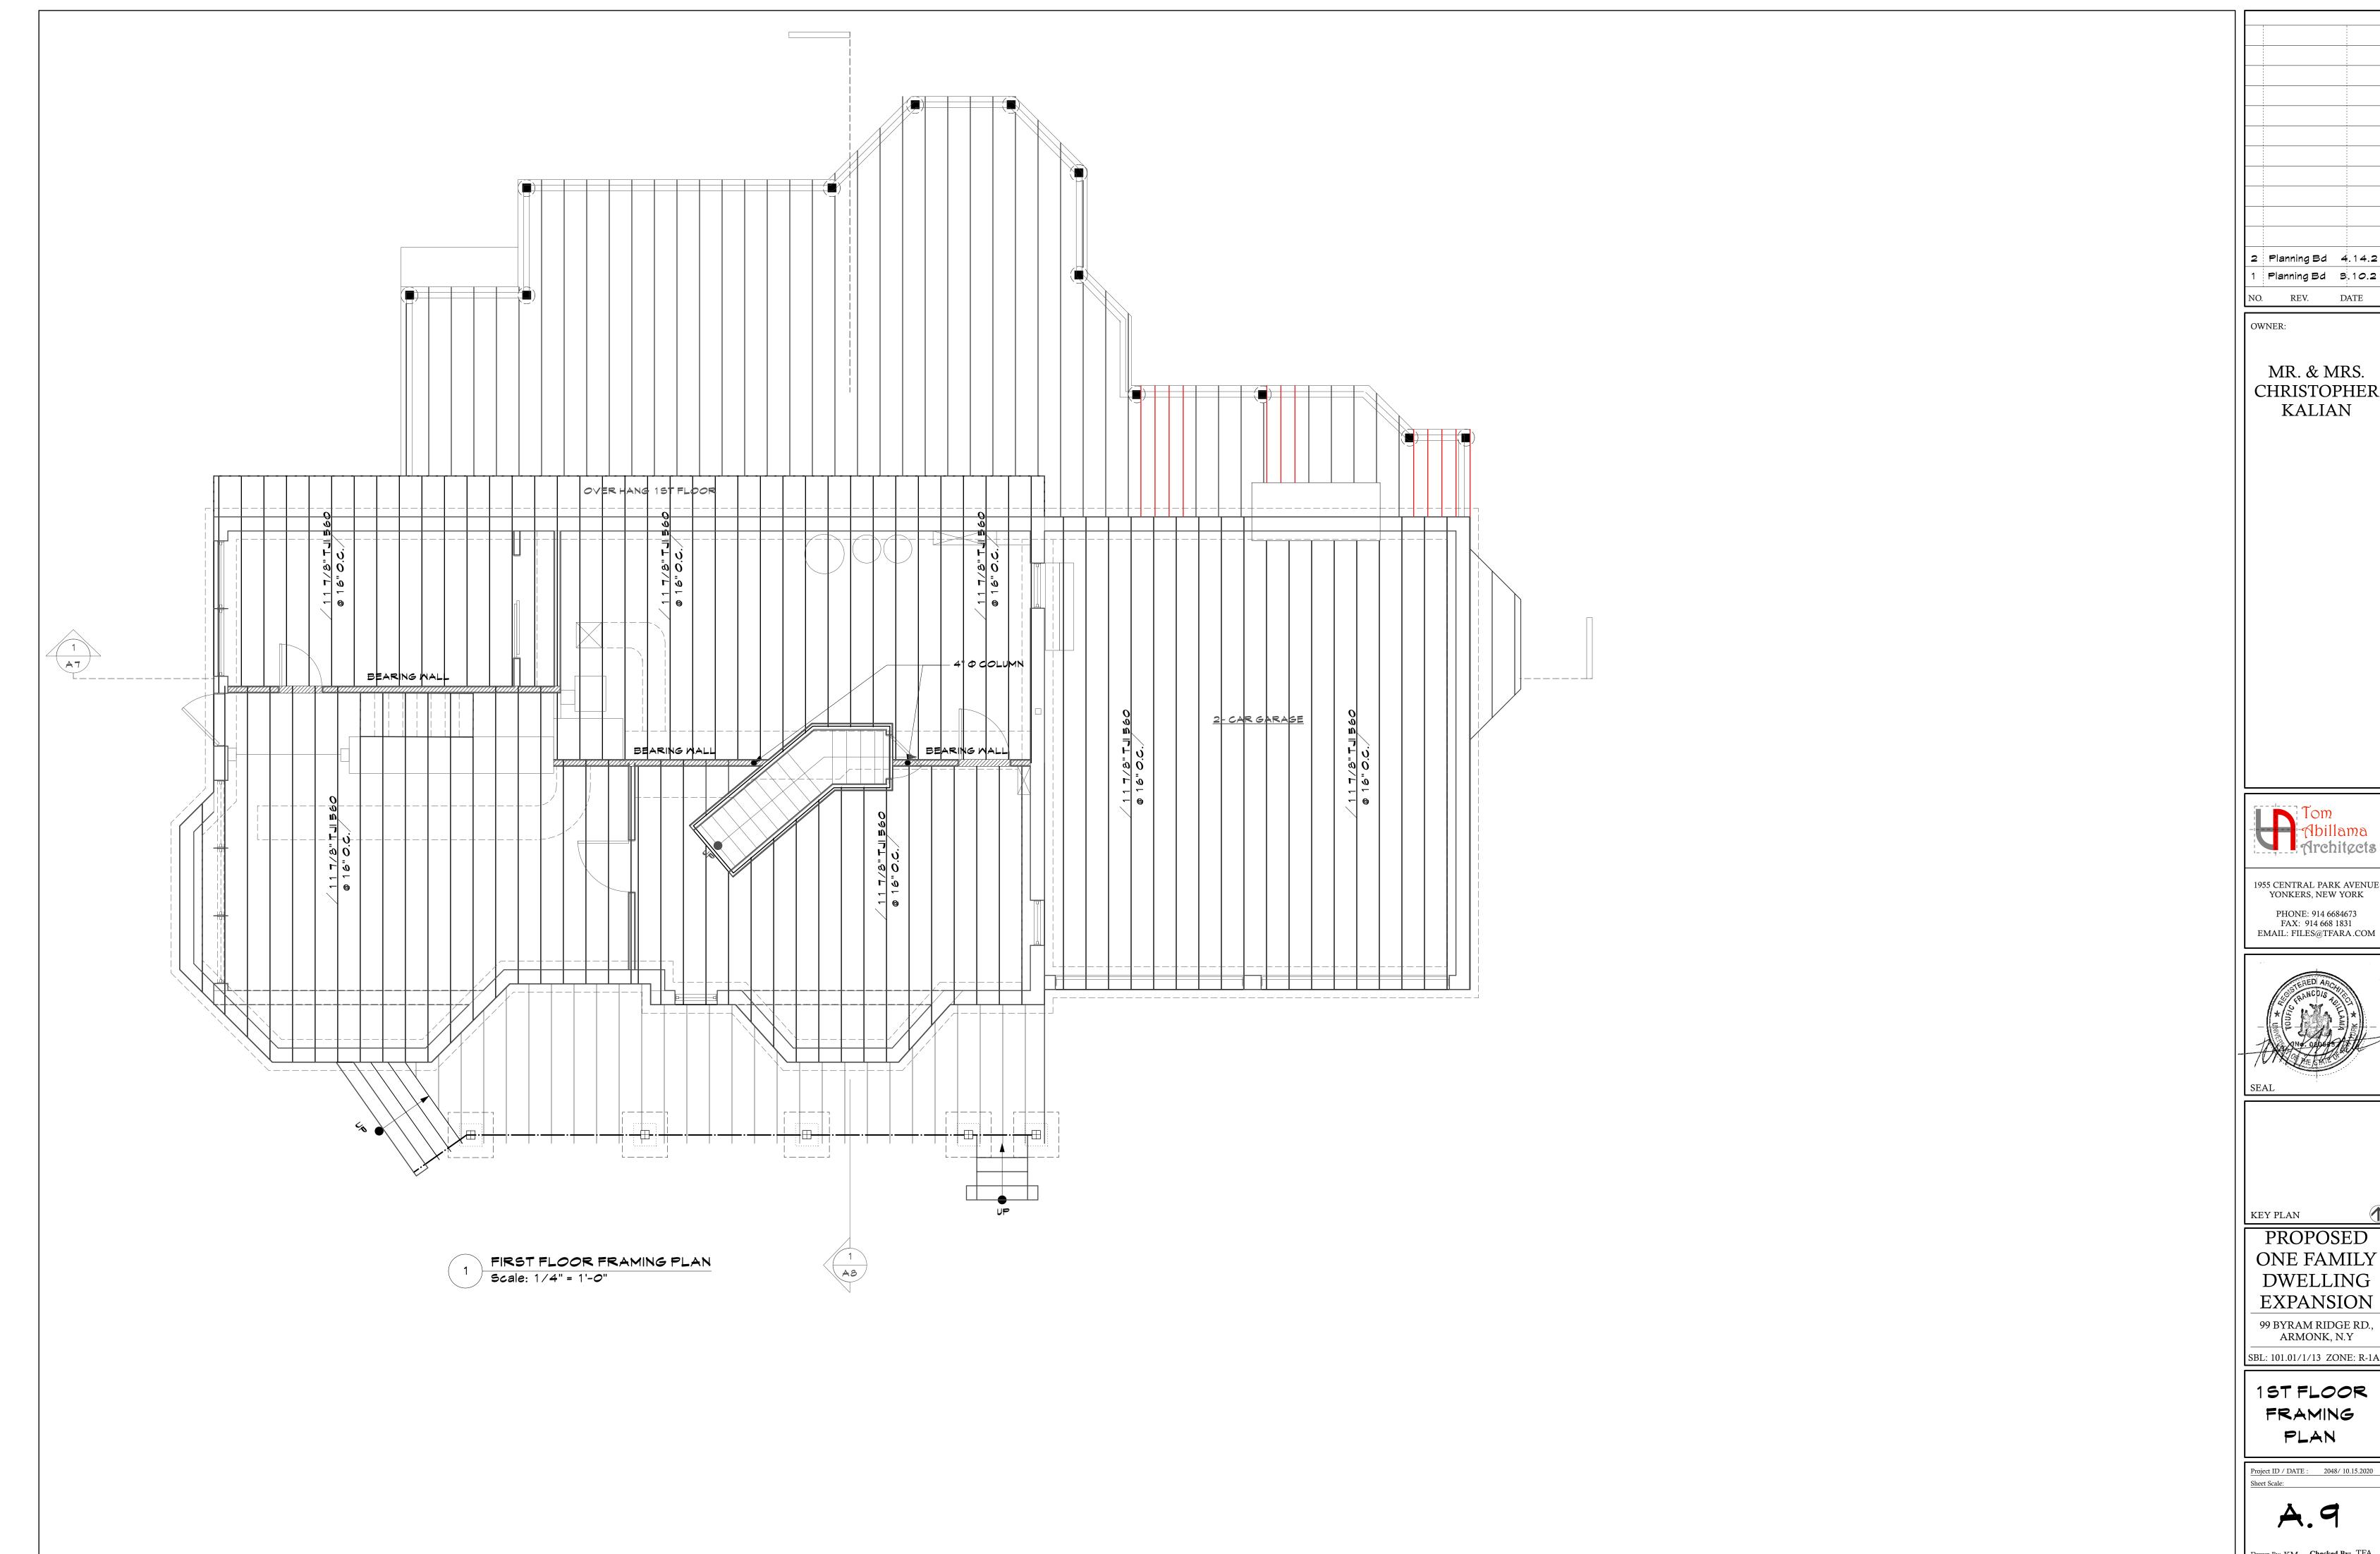
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PROPOSED ONE FAMILY **DWELLING**

99 BYRAM RIDGE RD., ARMONK, N.Y


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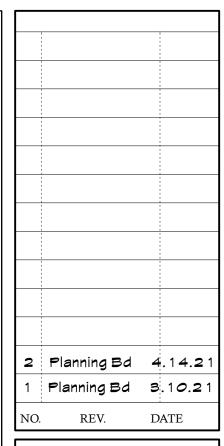
1ST FLOOR FRAMING PLAN

Project ID / DATE : 2048/ 10.15.2020

A.9

Drawn By: KM Checked By: TFA Plot Date: APR.14.2021



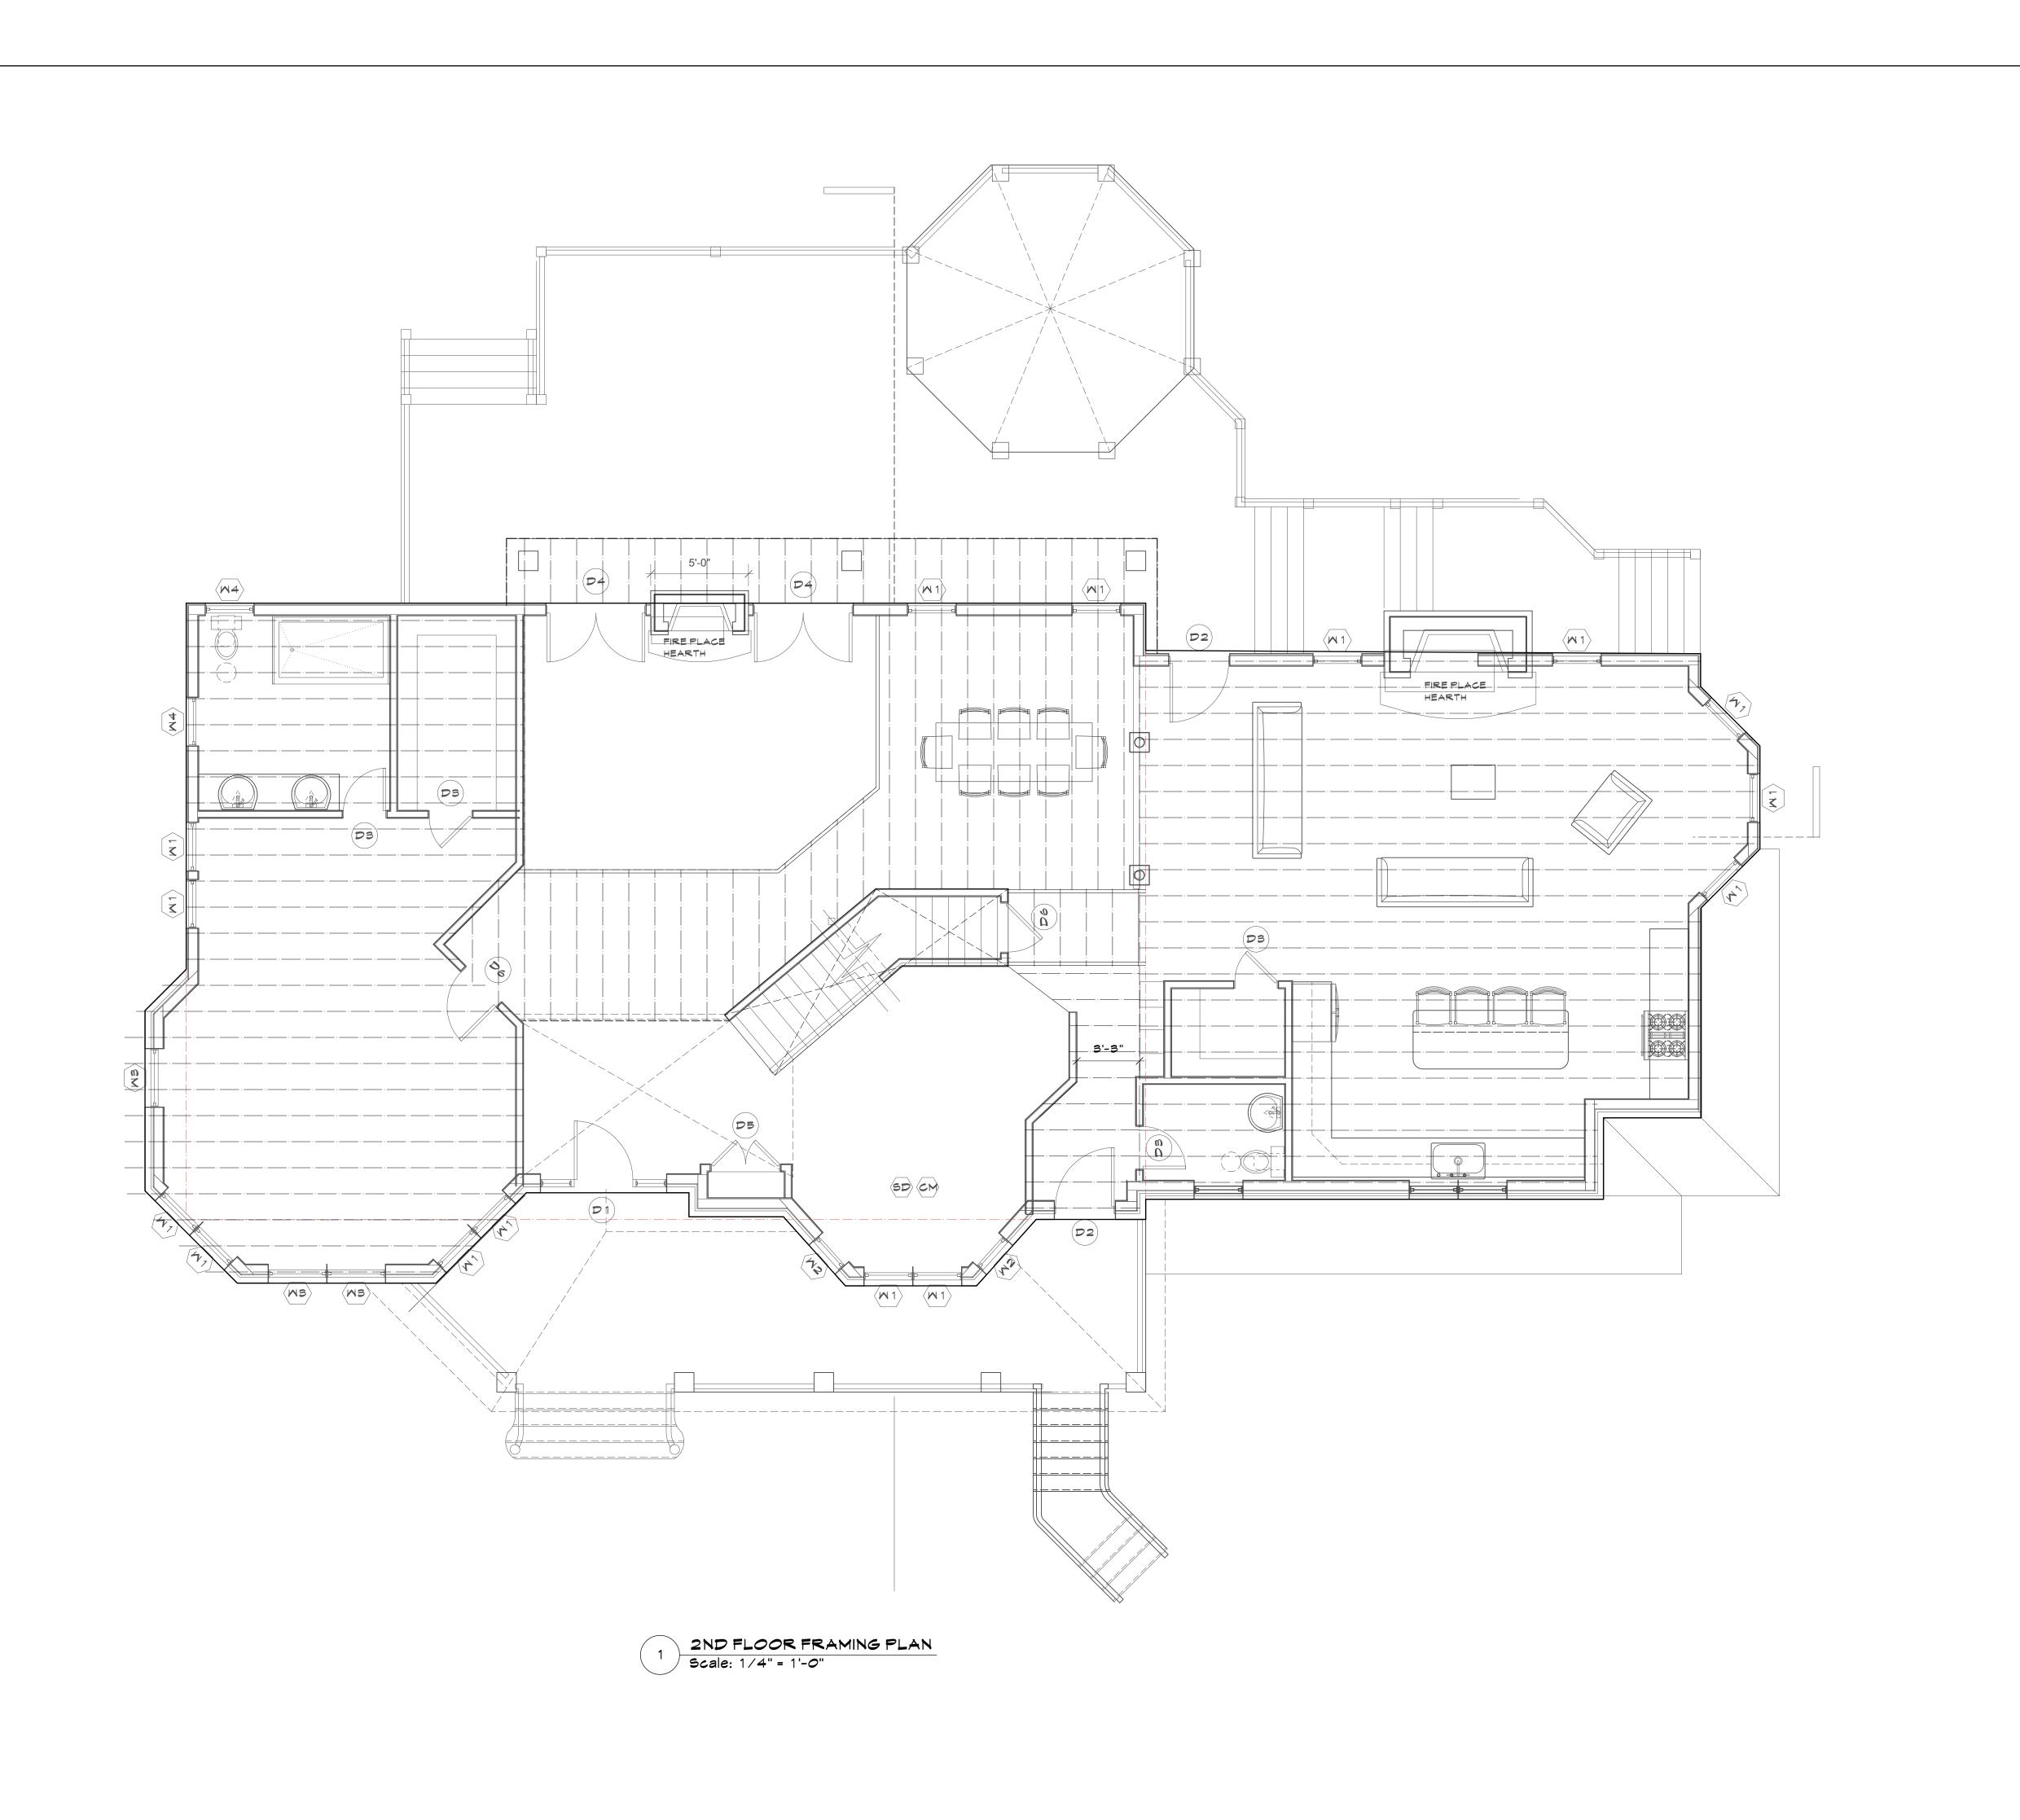

OWNER:

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KEY PLAN

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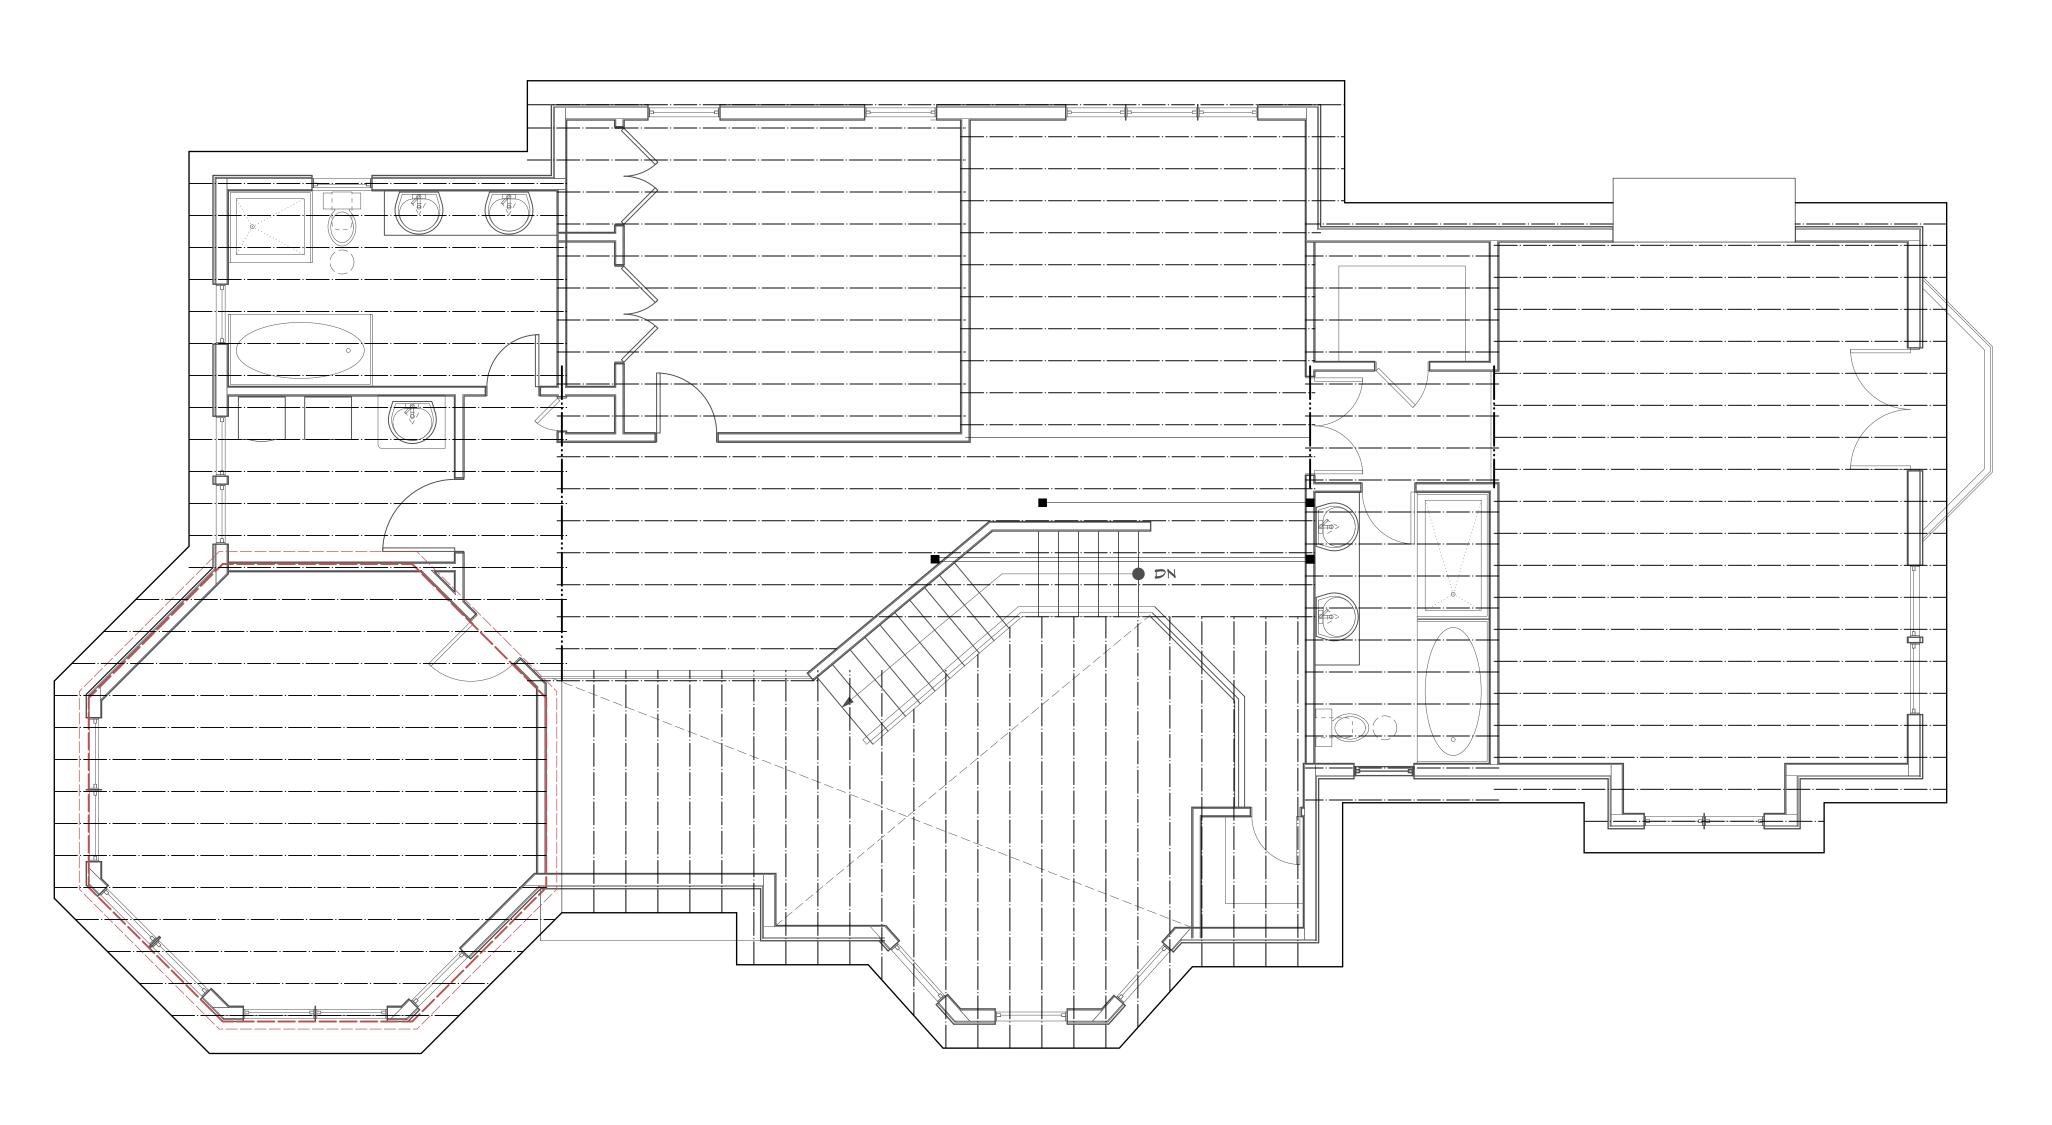
2ND FLOOR FRAMING

SBL: 101.01/1/13 ZONE: R-1A

Project ID / DATE : 2048/ 10.15.2020

PLAN

A 10



1 ATTIC FRAMING PLAN Scale: 1/4" = 1'-0" 2 Planning Bd 4.14.21
1 Planning Bd 3.10.21
NO. REV. DATE

WNER:

MR. & MRS. CHRISTOPHER KALIAN



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KEY PLAN

PROPOSED
ONE FAMILY
DWELLING
EXPANSION

99 BYRAM RIDGE RD.,
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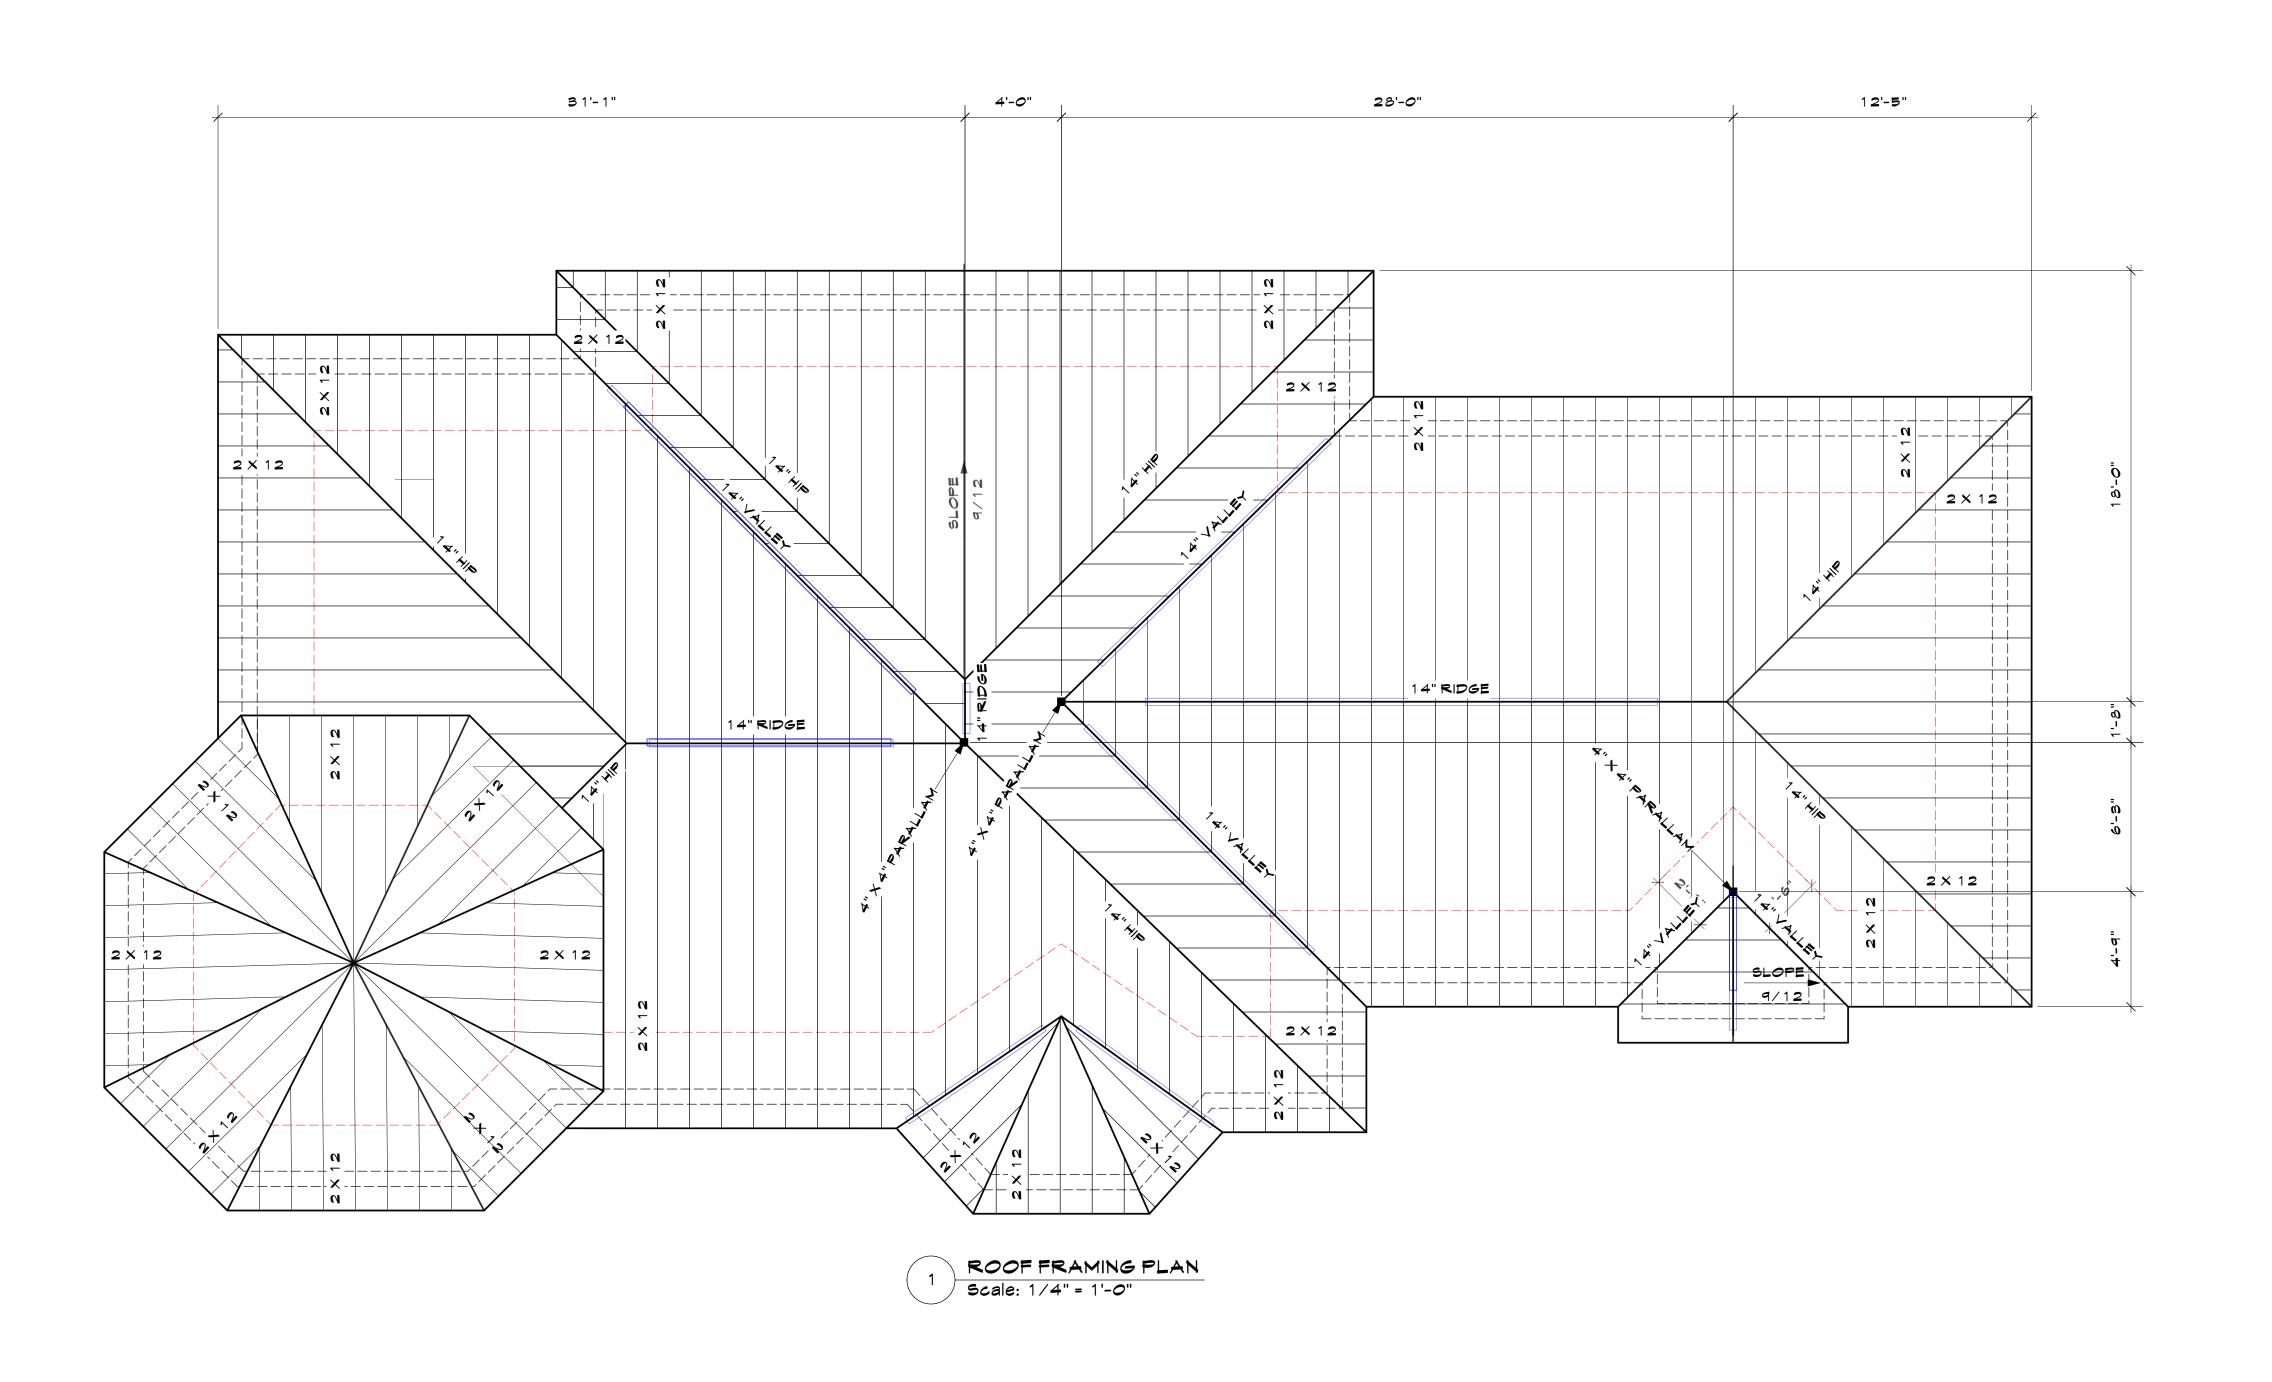
SBL: 101.01/1/13 ZONE: R-1A

ATTIC FRAMING PLAN

Project ID / DATE : 2048/ 10.15.2020

A 1 '

Sheet Scale:






TO PROVIDE PLASTIC STICKER
(8 1/2" X 11") W/ RED COLOR CREST AT
ELECT. METER INDICATING USE OF
ENGINEERED WOOD STRUCTURAL
MEMBERS.
LOCATION IS SUBJECT TO APPROVAL BY
FIRE DEPARTMENT.


PART# TRUSS NY 10
BLDG. CONSTRUCTION TYPE V
ROOF CONSTRUCTION
ENGINEERED FRAMING
AT FLOORS AND BEAMS
AS PER 1265 OF TITLE 19

FOR MORE INFORMATION LOG IN TO THE FOLLOWING LINK:

https://www.safetysign.com/products/7010/ny-type-v-floor-roof-truss-sign

(d) Signs identifying the existence of truss construction shall consist of a circle 6 inches (152.4 mm) in diameter, with a stroke width of ½ inch (12.7 mm). The sign background shall be reflective white in color. The circle and contents shall be reflective red in color, conforming to Pantone matching system (PMS) #187. Where a sign is directly applied to a door or sidelight, it may be a permanent non-fading sticker or decal. Signs not directly applied to doors or sidelights shall be of sturdy, non-fading, weather resistant material.

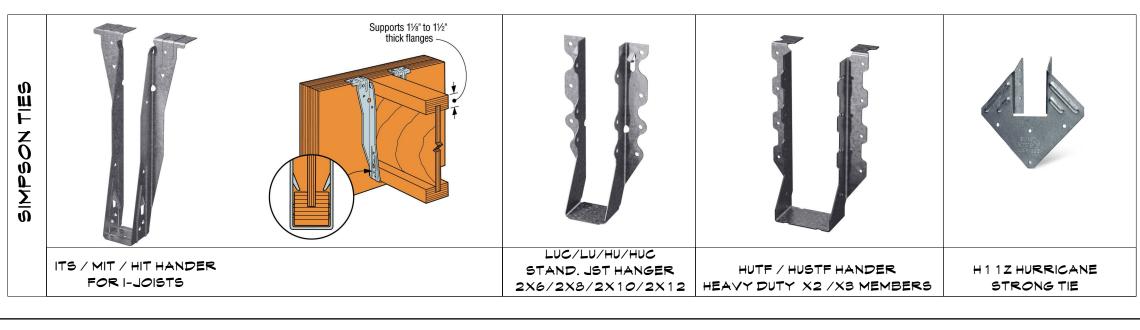

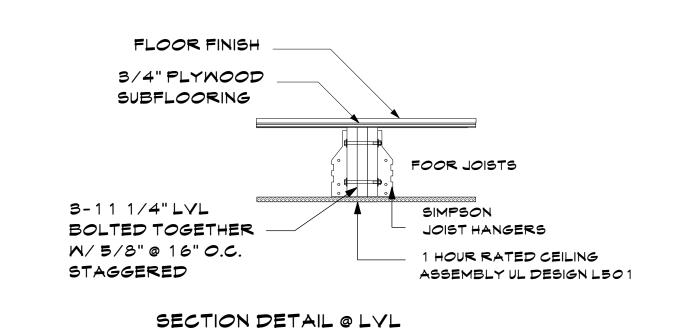

Scale: 3/4" = 1'-0"

2 Planning Bd 4.14.21
1 Planning Bd 3.10.21
NO. REV. DATE

WNER:

MR. & MRS. CHRISTOPHER KALIAN



1955 CENTRAL PARK AVENUE YONKERS, NEW YORK

PHONE: 914 6684673
FAX: 914 668 1831
EMAIL: FILES@TFARA.COM



PROPOSED
ONE FAMILY
DWELLING
EXPANSION


99 BYRAM RIDGE RD., ARMONK, N.Y

SBL: 101.01/1/13 ZONE: R-1A

ROOF FRAMING PLAN

Project ID / DATE : 2048/ 10.15.2020

A 15

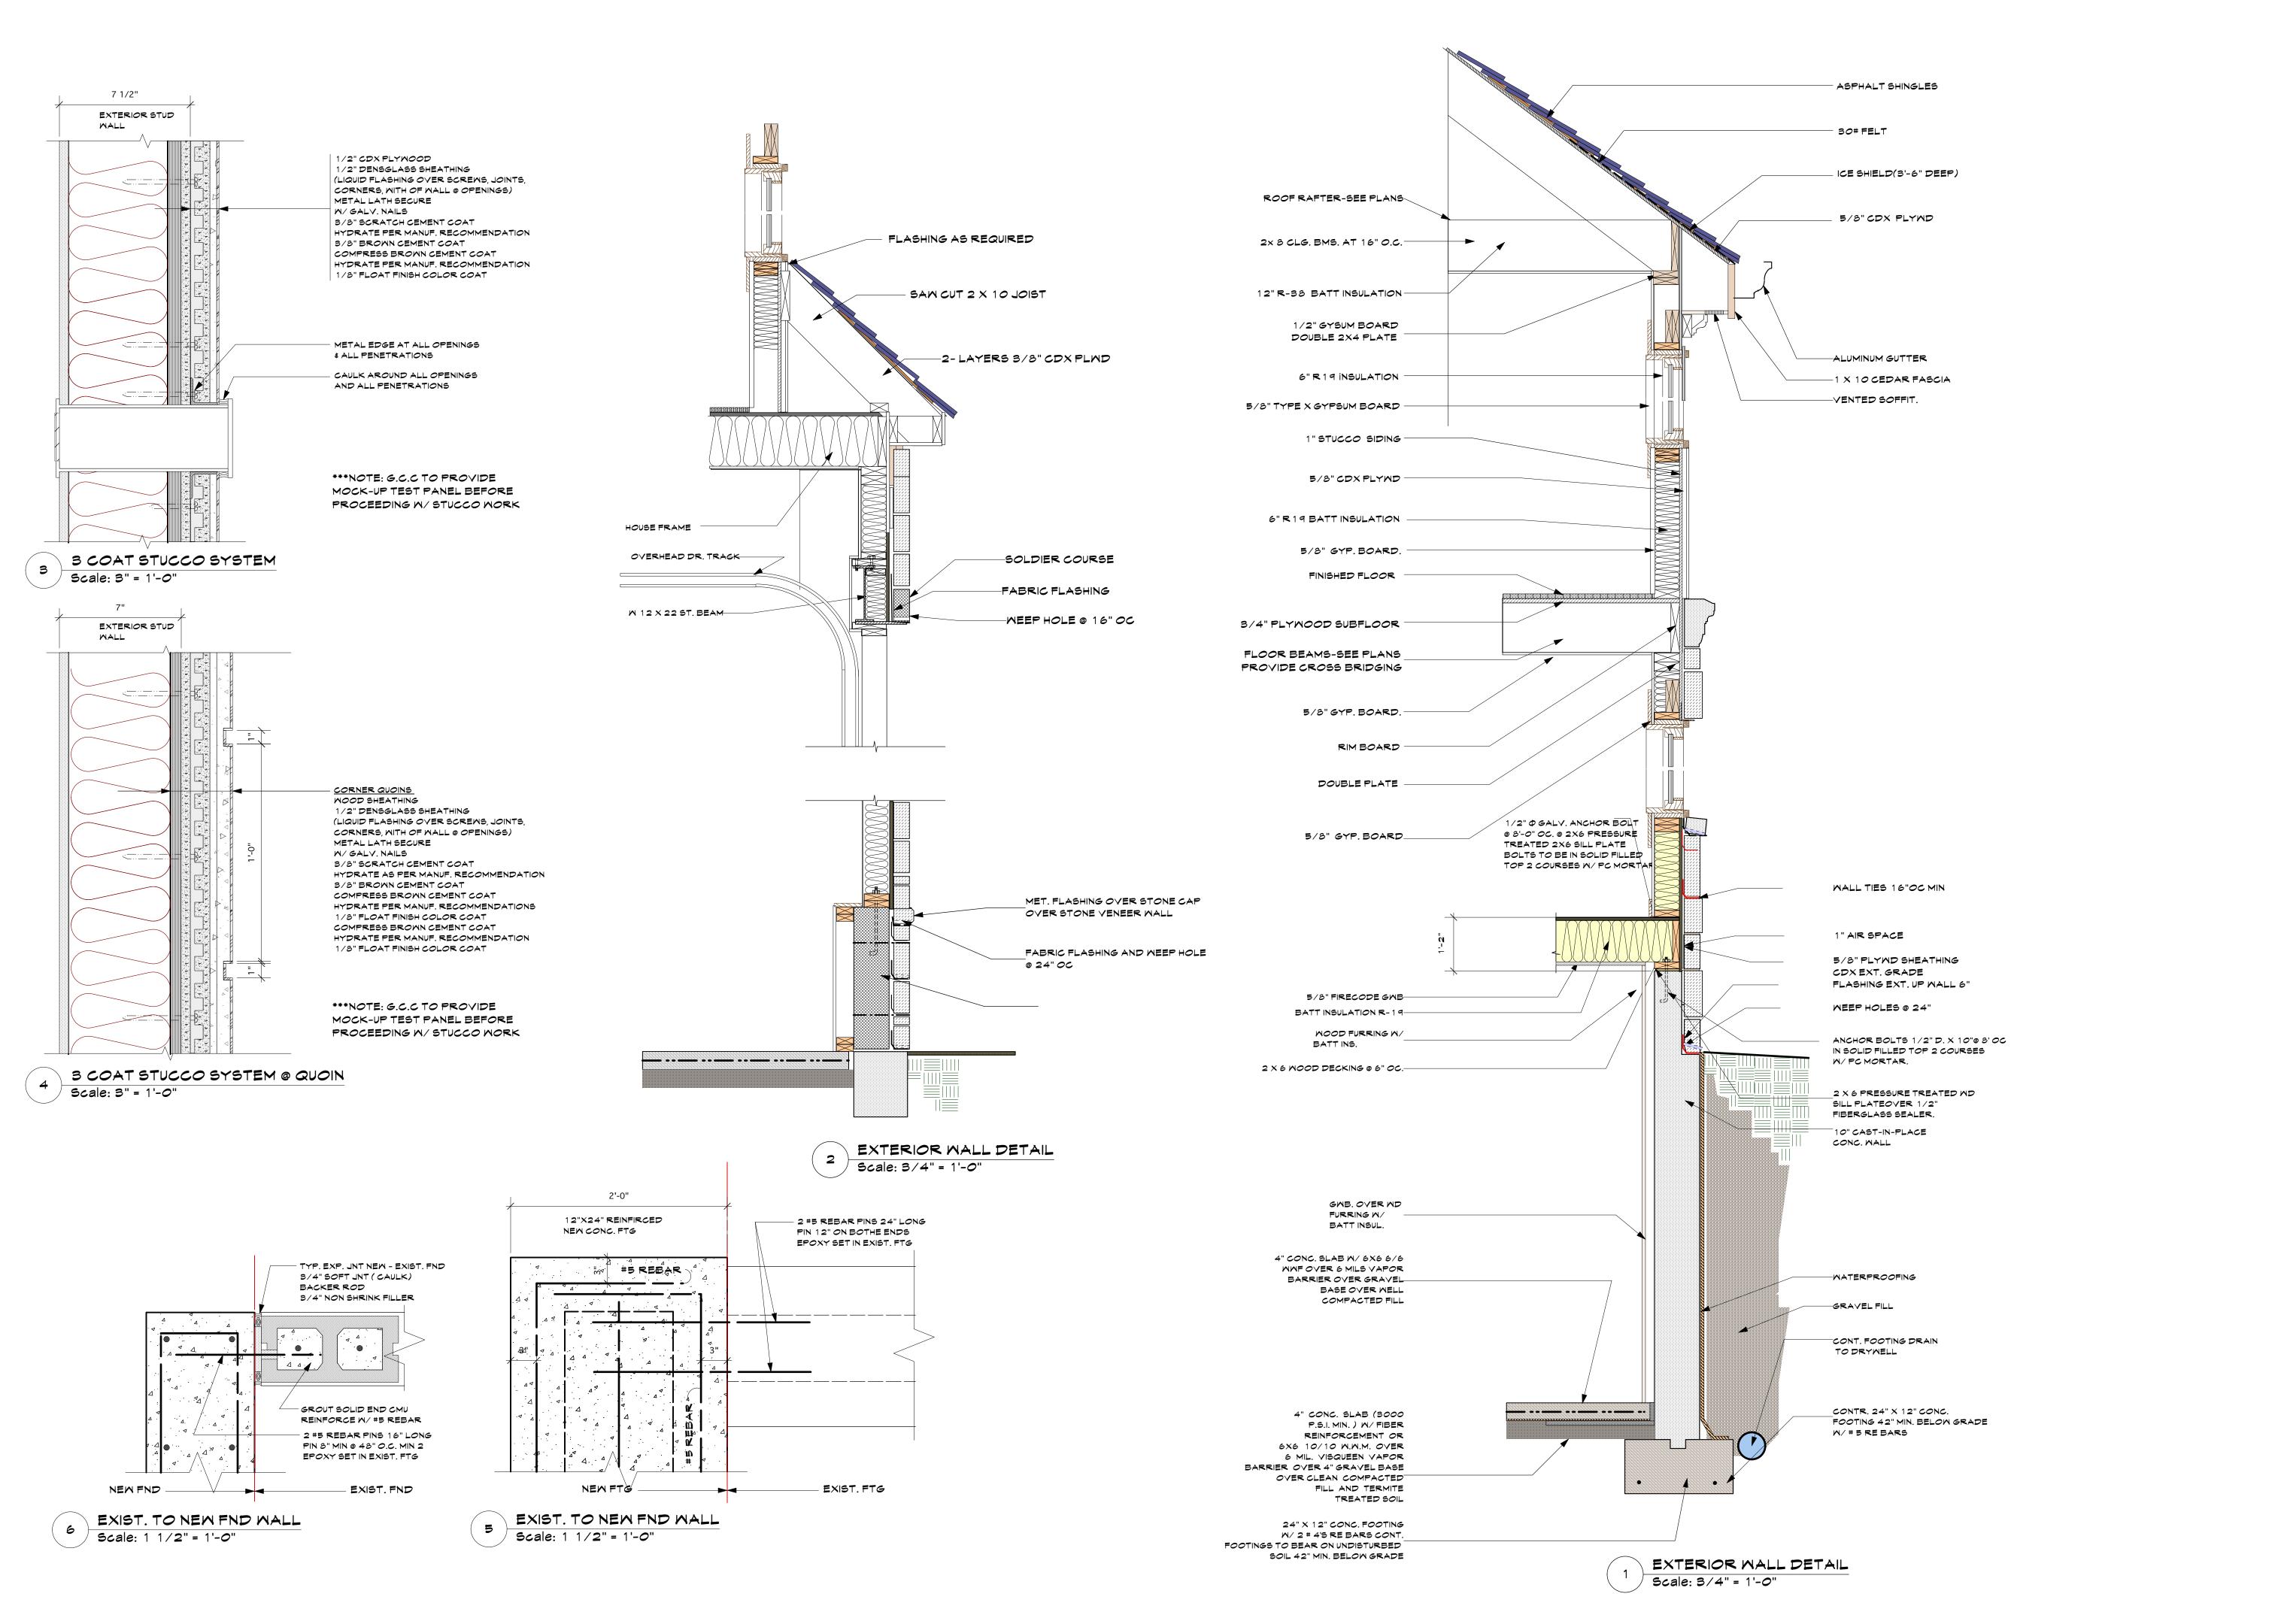

2 Planning Bd 4.14.21
1 Planning Bd 3.10.21
NO. REV. DATE

OWNER:

MR. & MRS. CHRISTOPHER KALIAN



1955 CENTRAL PARK AVENUE YONKERS, NEW YORK

PHONE: 914 6684673
FAX: 914 668 1831
EMAIL: FILES@TFARA.COM



KEY PLAN

PROPOSED
ONE FAMILY
DWELLING
EXPANSION

99 BYRAM RIDGE RD.,
ARMONK, N.Y

EXTERIOR MALL

SBL: 101.01/1/13 ZONE: R-1A

Project ID / DATE : 2048/ 10.15.2020

Sheet Scale:

DETAILS

A.13

Certifications on this boundary survey map signify that the map was prepared in accordance with the current existing Code of Practice for Land Surveys adopted by the New York State Association of Professional Land Surveyors, Inc. The certification is limited to persons for whom the boundary survey map is prepared, to the title company, to the governmental agency, and to the lending institution listed on this boundary survey map.

Any alteration or addition to this survey is a violation of SECTION 7209 of the NEW YORK STATE EDUCATION LAW, except as per SUBDIVISION 2. All certifications hereon are valid for this map and copies thereof only if said map or copies bear the inked or impressed seal of the surveyor whose original signature appears hereon.

GROUND SURFACE AND ARE SUBJECT TO FIELD VERIFICATION BY EXCAVATION Being part of lot 24 as shown on a Map UTILITIES SHOWN DO NOT PURPORT TO CONSTITUTE OR REPRESENT ALL UTILITIES LOCATED UPON OR ADJACENT TO THE SURVEYED PREMISES Entitled "Property Map, George S. Groves, doing business as North Castle Estates. situated in the Town of North Castle, WETLANDS IF ANY ARE NOT SHOWN Westchester County, New York" on File in n/f the Westchester County Clerk's Office as Map number 5794 Monahan S 72°14'30" E 62.03 Frame RIDGE n/f 38.40 Longo 407.07 N 73°57'10" W n/f Dicpinigaitis

EDWARD T. GANNON, P.L.S.

CHERRY HILL ROAD ~ BLOOMING GROVE, NY 10914

egannonsurveying@yahoo.com

CERTIFIED ONLY TO:

Byram LLC World Wide Land Transfer Old Republic National Title Insurance Company

SURVEY OF PROPERTY PREPARED FOR BYRAM LLC

SUBJECT TO ANY EASEMENTS AND/OR SUBSURFACE STRUCTURES RECORDED OR UNRECORDED ARE NOT GUARANTEED UNLESS PHYSICALLY EVIDENT ON THE PREMISES

UNDERGROUND UTILITIES SHOWN HEREON BASED ON UTILITY EVIDENCE VISIBLE AT

SUBJECT TO COVENANTS, EASEMENTS, RESTRICTIONS, CONDITIONS AND AGREEMENTS OF

AT THE TIME OF THE SURVEY

TOWN OF NORTH CASTLE, COUNTY OF WESTCHESTER, STATE OF NEW YORK TAX LOT: SECTION 101.01 - BLOCK 1 - LOT 13

SCALE: 1" = 40' SURVEY DATE: SEPTEMBER 2, 2020 AREA: 58,238.9 SQ.FT.



Re: Chris Kalian 99 Byram Ridge Road Section 101.01, Block 1, Lot 13

Please see our responses below to General Comments from Kellard Sessions dated 4.9.21:

- 1. All references to the pool and associated improvements and calculations have been revised and updated on Sheet C.01.
- 2. On our proposal letter dated 3.10.21 to Mr. Christopher Carthy, Chairman of the Planning Board, we have stated the best use for the property (attached herewith).
- 3. The plans have been clarified and coordinated.
- 4. Minimum yard setbacks have been illustrated on Sheet SP.2.
- 5. Proposed grading shown on Sheet SP.4 and coordinated on SP.1, SP.2 & SP.3.
- 6. A note will be added on DOB submittal, prior to issuance of a building permit, "all walls, equal to or greater than four (4) feet in height, shall be designed by a NYS licensed R.A."
- 7. A note will be added on DOB submittal, prior to the issuance of a certificate of occupancy, "the construction of all walls, equal to or greater than four (4) feet in height, shall be certified by the Design Professional."
- 8. Sheet SP.4 shows existing and proposed driveway profile in compliance with Section 355-59, Driveways of the Town Code.
- 9. See responses to comments #9 thru #14 from ARQ.
- 15. Sheet L-2 dated 3.8.21 from AZ Associates Ltd. shows proposed planting plan and will be coordinated with ARQ for tree removal.
- 16. See response from ARQ.
- 17. All plans have been signed and sealed by the Design Professional.

18. Attaching Survey by Edward T. Gannon dated September 2, 2020.

North Castle Planning Board Kalian – 99 Byram Ridge Road April 9, 2021 Page 2 of 4

location which may also provide for improved driveway access.

- 3. The applicant has provided site plan packages prepared by the Project Architect and Civil Engineer. The plans, however, must be coordinated as it relates to limits of removals of existing features, restoration and/or construction of the driveway, proposed grading and retaining walls, utilities, stormwater collection and mitigation system layout, tree removal and protection, temporary erosion and sediment control, etc. We will reserve detailed comment on these various improvements until the plans have been clarified and coordinated.
- 4. As previously requested, the plan shall illustrate and dimension all required minimum yard setbacks.
- 5. As previously requested, the plan shall illustrate any proposed grading, including spot grades, as appropriate and coordinate same between both plan sets.
- 6. As previously requested, the plan shall include a note clearly stating that "Prior to issuance of a Building Permit, all walls, equal to or greater than four (4) feet in height, shall be designed by a NYS Licensed Professional Engineer." Provide construction details and specifications on the plan.
- 7. As previously requested, the plan shall clearly state that "Prior to the issuance of a Certificate of Occupancy, the construction of all walls, equal to or greater than four (4) feet in height, shall be certified by the Design Professional."
- 8. The plan shall include a driveway profile demonstrating compliance with Section 355-59, Driveways of the Town Code. The profile shall include dimensions, grades and vertical curve data as needed. The plan shall also indicate a maximum curb cut width of 18 ft as required by the Town Highway Department. Any required restoration within the Town right of way shall be illustrated and detailed on the plan.
- 9. As previously requested, the applicant shall submit a Landscape Plan for consideration by the Planning Board. The plan shall include a table summarizing the trees to be removed and indicate the locations of proposed trees, specifying the size, quantity, and species of all proposed planting. In addition, the applicant should consider requesting a waiver from the Westchester County Department of Health to maintain the existing trees located within the area of the proposed septic expansion area.
- 10. The applicant has indicated that a plan has been submitted to the WestchesterCounty Department of Health (WCHD) for review and approval of the proposed septic system. The applicant shall continue to update the Planning Board in this regard.

North Castle Planning Board Kalian – 99 Byram Ridge Road April 9, 2021 Page 3 of 4

- 11. It appears that the minimum required separation distance from the proposed stormwater mitigation system to the existing drilled well, as required by the WCHD, has not been provided. We note that infiltration systems collecting stormwater runoff from paved surfaces, requires a separation distance of 100 feet. The plan shall be revised accordingly.
- 12. As previously requested, the plan shall illustrate the area of the proposed stormwater mitigation system and primary and expansion septic areas to be cordoned off during construction.
- 13. As previously requested, the plan shall clearly illustrate and quantify the proposed limits of disturbance of the overall project. The plan shall note that disturbance limits shall be staked in the field prior to construction. We note that disturbances over 5,000 s.f. will require preparation of a Stormwater Pollution Prevention Plan (SWPPP) in accordance with Chapter 173 Stormwater Management of the Town Code.
- 14. As previously requested, the applicant shall perform deep and percolation soil testing in the vicinity of the proposed mitigation system to be witnessed by the Town Engineer. The test locations and results shall be shown on the plan. Contact this office to schedule the testing.
- 15. As previously requested, the applicant shall provide an updated tree survey for at least all trees within and 20 feet beyond the limit of disturbance. The plan shall illustrate all trees eight (8) inches dbh or greater locatedwithin and ten (10) feet beyond the proposed limit of disturbance to be removed and/or protected.
- 16. As previously requested, the plan shall illustrate the location of all required temporary erosion control measures, including, but not limited to, temporary construction access, silt fence, inlet protection, tree protection, erosion control blankets, construction sequence, etc. Provide details.
- 17. All plans shall be signed and sealed by the Design Professional.
- 18. The plans shall include a note indicating the source of the survey and topographic data, including the referenced datum, utilized for the development of the plan.

As additional information becomes available, we will continue our review. It is noted that an itemized response to all comments will facilitate completeness and efficiency of review.

PLANS REVIEWED, PREPARED BY ARQ, DATED MARCH 1, 2021:

- OWTS Site Plan (Sheet 1 of 2)
- Details (Sheet 2 of 2)

OWTS NOTES

- . THERE SHALL BE NO TREES WITHIN 10 FEET OF THE OWTS.
- THERE ARE NO OWTS WITHIN 200 FEET OF THE WELL UNLESS OTHERWISE SHOWN ON
- THERE ARE NO SOURCES OF CONTAMINATION WITHIN 200 FEET IF THE PROPOSED WELL.
- . THERE ARE NO WELLS WITHIN 200' OF OWTS UNLESS OTHERWISE SHOWN ON PLAN.
- THE PROPOSED OWTS AREA SHALL BE ISOLATED AND PROTECTED AGAINST DAMAGE BY MUNICIPALITY: EROSION, STORAGE OF EARTH OR MATERIALS, DISPLACEMENT, COMPACTION OR OTHER ADVERSE PHYSICAL CHANGE IN THE CHARACTERISTICS OF THE SOIL OR IN THE DRAINAGE LOT AREA:
- IF FOR ANY REASON THE APPROVED CONSTRUCTION PLAN CANNOT BE FOLLOWED, A REVISED PLAN MUST BE PREPARED, SUBMITTED, AND APPROVED BY WCDH.
- THE DESIGN PROFESSIONAL SHALL SUPERVISE THE CONSTRUCTION OF THE OWTS AND WATER DISTRICT: MAKE AN OPEN WORKS INSPECTION.
- WITHIN 24-HOURS OF THE COMPLETION OF THE OWTS, THE DESIGN PROFESSIONAL MUST NOTIFY THE WESTCHESTER COUNTY DEPARTMENT OF HEALTH (WCDH) THAT THE SCHOOL DISTRICT: OWTS IS READY FOR INSPECTION BY SUBMITTING A COMPLETED REQUEST FOR AN OPEN WORKS INSPECTION ON THE APPROPRIATE FORM TO WCDH.
- NO BACKFILLING OF A COMPLETED OWTS CAN OCCUR UNTIL AFTER IT HAS BEEN WATERSHED: INSPECTED AND ACCEPTED BY THE WESTCHESTER COUNTY DEPARTMENT OF HEALTH.
- .0. AFTER BACKFILLING THE OWTS, THE AREA SHALL BE COVERED WITH A MINIMUM OF 4 INCHES OF CLEAN TOP SOIL, SEEDED AND MULCHED.
- 1. THE INSTALLATION OF THE OWTS SHALL BE IN ACCORDANCE WITH THE RULES AND OWTS DESIGN SUMMARY REGULATIONS FOR THE DESIGN AND CONSTRUCTION OF RESIDENTIAL SUBSURFACE SEWAGE TREATMENT SYSTEMS AND DRILLED WELLS IN WESTCHESTER COUNTY, NY.
- 12. ALL PIPES CONNECTING TO TANK AND BOXES SHALL BE CUT FLUSH WITH THE INSIDE WALL OF BOX.
- 13. THE PROPOSED OWTS SHALL BE INSTALLED BY A WESTCHESTER COUNTY LICENSED SEPTIC CONTRACTOR.
- 14. PRIOR TO ANY EXCAVATION ALL UNDERGROUND UTILITIES MUST BE LOCATED. CALL 1-800-962-7962.
- 15. THE WESTCHESTER COUNTY HEALTH DEPARTMENT APPROVAL EXPIRES ONE YEAR FROM THE DATE ON THE APPROVAL STAMP AND IS REQUIRED TO BE RENEWED ON OR BEFORE THE EXPIRATION DATE. THE APPROVAL IS REVOCABLE FOR CAUSE OR MAY BE AMENDED
- .6. THERE ARE NO RESERVOIRS, RESERVOIR STEMS OR CONTROLLED LAKE WITHIN 500 FEET SOIL CLASSIFICATION: ChB & RhD
- OF THE PROPOSED OWTS UNLESS OTHERWISE SHOWN ON PLAN. .7. THERE ARE NO NYSDEC WETLANDS OR WATERCOURSES WITHIN 200 FEET OF THE PROPOSED OWTS UNLESS OTHERWISE SHOWN ON PLAN.
- 18. STORMTECH SC-740 CHAMBERS ARE NOT A PART OF THE OWTS.

OR MODIFIED WHEN CONSIDERED NECESSARY BY THE DEPARTMENT.

- 19. THE PROPOSED FILL FOR THE OWTS AREA IS TO BE RUN OF BANK SAND AND GRAVEL
- 20. ESTIMATED TIME OF CONSTRUCTION: MAY-JUNE 2021

MISCELLANEOUS DATA

99 BYRAM LLC 5 W MAIN ST ELMSFORD, NY 10523

SURVEYOR: EDWARD T. GANNON, PLS

CHERRY HILL ROAD BLOOMING GROVE, NY 10914 PREPARED 9/2/2020

TOWN OF NORTH CASTLE 1.34 AC ARMONK FD TAX MAP 101.01-1-13 ONSITE WELL SEWER DISTRICT: ONSITE SSDS

DRAINAGE BASIN: BYRAM RIVER BASIN

BYRAM HILLS

INLAND LONG ISLAND SOUND BASIN

EXISTING ZONING DISTRICT: R-1A

PROPOSED DEVELOPMENT SINGLE FAMILY, 5 BEDROOM HOME


DESIGN FLOW: 200 GPD/BEDROOM = 1,000 GPD

DEPTH TO GROUNDWATER N/A DEPTH TO BEDROCK N/A

SOIL PERCOLATION RATE = 16-20 MIN/IN

TOPOGRAPHY/SLOPE 11%

TOTAL LENGTH ABSORPTION TRENCH REQUIRED/PROVIDED = 720 LF

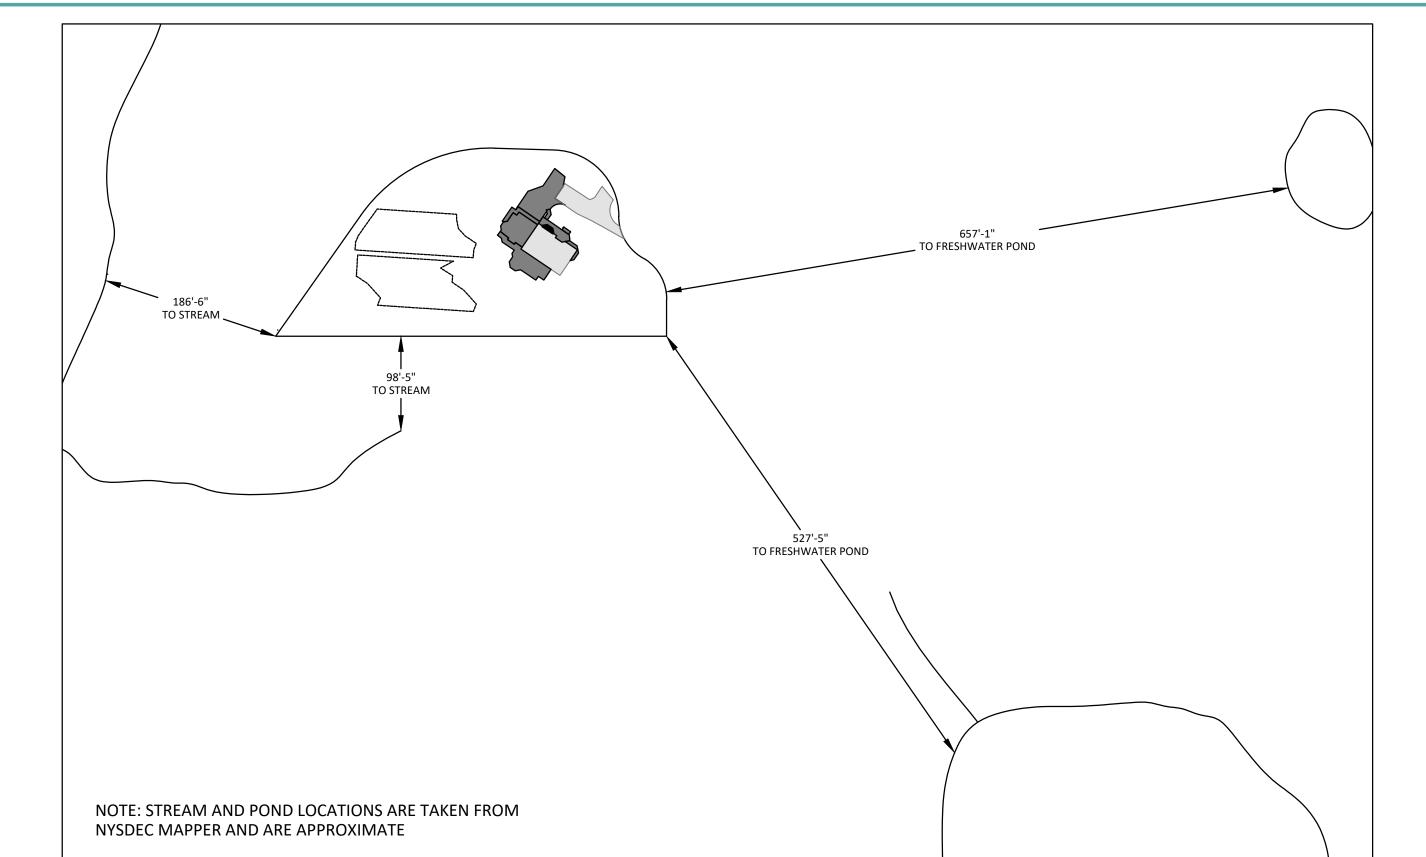



LOCATION MAP

DATE REVISIONS Revised per Town 4/13/21 Comments

100 EXECUTIVE BLVD. SUITE 204 OSSINING, NY 10562

PHONE: (914) 944-3377

FAX: (866) 567-6240

JORGE B. HERNANDEZ R.A. A.I.A.

LICENSE NUMBER: 030424-1

CERTIFICATE NUMBER: 0973256

PAUL A. BERTE, P.E

100 EXECUTIVE BLVD. SUITE 204

OSSINING, NY 10562

ALTERATIONS BY ANY PERSON IN ANY WAY, OR ANY ITEM CONTAINED ON THIS DOCUMENT, UNLESS ACTING UNDER DIRECTION OF THE LICENSED ENGINEER WHOSE PROFESSIONAL SEAL IS AFFIXED HERETO, IS A VIOLATION OF TITLE VIII, ARTICLE 145 SECTION 7209.2 OF THE NEW YORK STATE EDUCATION LAW.

DRAWING TITLE: OWTS SITE PLAN

PROJECT: HT OF FILTER 99 BYRAM, LLC

PROJECT ADDRESS:


OWTS PLAN


99 BYRAM RIDGE ROAD ARMONK, NY 10580

WCDOH SIGNATURE:

SEAL & SIGNATURE

STREAMS AND WATERBODIES 1" = 100'-0"

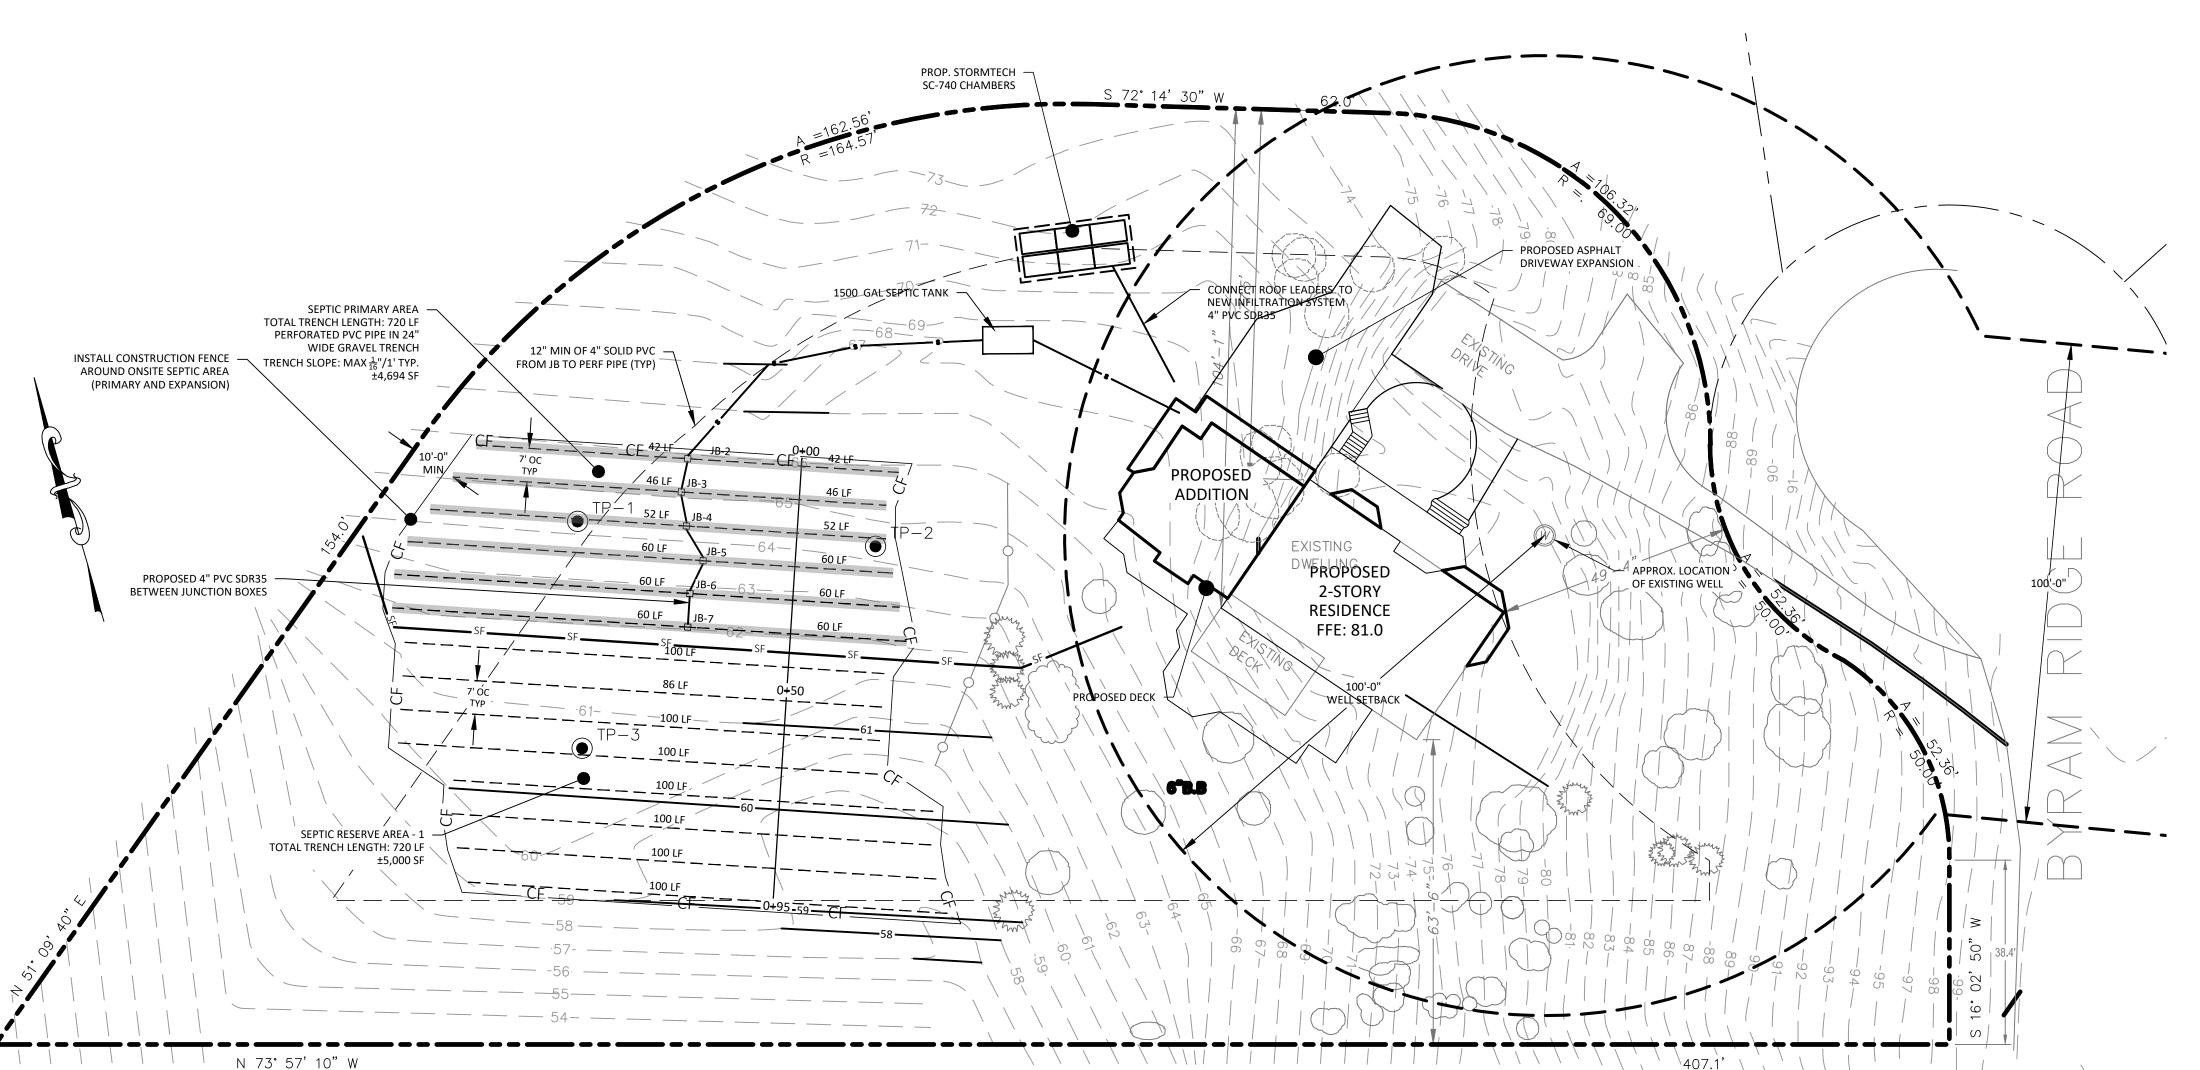

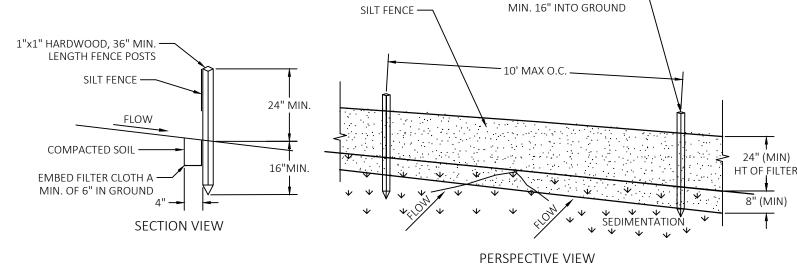

CONSTRUCTION SPECIFICATIONS:


EXISTING —

GROUND

PLAN VIEW

- 1. SILT FENCE TO BE FASTENED SECURELY TO FENCE POSTS WITH STAPLES. POSTS SHALL BE 1"X1" HARDWOOD, OR APPROVED EQUAL.
- WHEN TWO SECTIONS OF FILTER CLOTH ADJOIN EACH OTHER THEY SHALL BE WRAPPED AROUND 2 STAKES, MIN 2X. FILTER CLOTH SHALL BE EITHER FILTER USCF MISF180, MIRAFI 100X OR APPROVED EQUIVALENT.
- . MAINTENANCE SHALL BE PERFORMED AS NEEDED, REINFORCE AREA LOW POINTS WITH ADDITIONAL STAKES OR OTHER MATERIALS (AS RECOMMENDED BY ENGINEER). MATERIAL SHALL BE REMOVED WHEN SEDIMENT LOAD REACHES 50% HEIGHT OF FENCE.

SILT FENCE INSTALLATION DETAIL

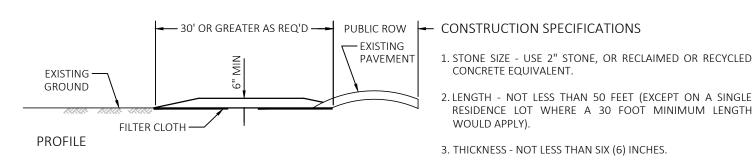

PROVIDE APPROPRIATE

PUBLIC R.O.W.

TRANSITION BETWEEN STABILIZED CONSTRUCTION ENTRANCE AND

30' OR GREATER AS REQ'D --

12' (MIN)

25' R —

1"x1" HARDWOOD, 36" MIN. —

¬

LENGTH FENCE POSTS DRIVEN

CONCRETE EQUIVALENT. 2. LENGTH - NOT LESS THAN 50 FEET (EXCEPT ON A SINGLE RESIDENCE LOT WHERE A 30 FOOT MINIMUM LENGTH WOULD APPLY).

3. THICKNESS - NOT LESS THAN SIX (6) INCHES.

4. WIDTH - TWELVE (12) FOOT MINIMUM. BUT NOT LESS THAN THE FULL WIDTH AT POINTS WHERE INGRESS OR EGRESS OCCURS. TWENTY-FOUR (24) FOOT IF SINGLE ENTRANCE TO

5. FILTER CLOTH - WILL BE PLACED OVER THE ENTIRE AREA PRIOR TO PLACING OF STONE.

6. SURFACE WATER - ALL SURFACE WATER FLOWING OR DIVERTED TOWARD CONSTRUCTION ENTRANCES SHALL BE PIPED ACROSS THE ENTRANCE. IF PIPING IS IMPRACTICAL. A MOUNTABLE BERM WITH 5:1 SLOPES WILL BE PERMITTED 7. MAINTENANCE - THE ENTRANCE SHALL BE MAINTAINED IN A

CONDITION WHICH WILL PREVENT TRACKING OR FLOWING

OF SEDIMENT ONTO PUBLIC RIGHTS-OF-WAY, ALL SEDIMENT SPILLED, DROPPED, WASHED OR TRACTED ONTO PUBLIC RIGHTS-OF-WAY MUST BE REMOVED IMMEDIATELY. 8. WHEN WASHING IS REQUITED, IT SHALL BE DONE ON A AREA STABILISED WITH STONE AND WHICH DRAINS INTO AN

APPROVED SEDIMENT TRAPPING DEVICE. 9. PERIODIC INSPECTION AND NEEDED MAINTENANCE SHALL BE PROVIDED AFTER EACH RAIN.

STABILIZED CONSTRUCTION ENTRANCE

EXISTING

PAVEMENT

NOTE: NOT TO BE USED FOR CONSTRUCTION

SCALE: 1" = 20'-0' PROJECT NO.: 21-030 DRAWING BY: DRAWING NO.: 1 OF 2 CHECKED BY: