OWTS NOTES

- . THERE SHALL BE NO TREES WITHIN 10 FEET OF THE OWTS.
- THERE ARE NO OWTS WITHIN 200 FEET OF THE WELL UNLESS OTHERWISE SHOWN ON
- THERE ARE NO SOURCES OF CONTAMINATION WITHIN 200 FEET IF THE PROPOSED WELL.
- THERE ARE NO WELLS WITHIN 200' OF OWTS UNLESS OTHERWISE SHOWN ON PLAN.
- THE PROPOSED OWTS AREA SHALL BE ISOLATED AND PROTECTED AGAINST DAMAGE BY MUNICIPALITY: EROSION, STORAGE OF EARTH OR MATERIALS, DISPLACEMENT, COMPACTION OR OTHER ADVERSE PHYSICAL CHANGE IN THE CHARACTERISTICS OF THE SOIL OR IN THE DRAINAGE LOT AREA:
- IF FOR ANY REASON THE APPROVED CONSTRUCTION PLAN CANNOT BE FOLLOWED, A REVISED PLAN MUST BE PREPARED, SUBMITTED, AND APPROVED BY WCDH.
- THE DESIGN PROFESSIONAL SHALL SUPERVISE THE CONSTRUCTION OF THE OWTS AND WATER DISTRICT: MAKE AN OPEN WORKS INSPECTION.
- WITHIN 24-HOURS OF THE COMPLETION OF THE OWTS, THE DESIGN PROFESSIONAL MUST NOTIFY THE WESTCHESTER COUNTY DEPARTMENT OF HEALTH (WCDH) THAT THE SCHOOL DISTRICT: OWTS IS READY FOR INSPECTION BY SUBMITTING A COMPLETED REQUEST FOR AN OPEN WORKS INSPECTION ON THE APPROPRIATE FORM TO WCDH.
- NO BACKFILLING OF A COMPLETED OWTS CAN OCCUR UNTIL AFTER IT HAS BEEN WATERSHED: INSPECTED AND ACCEPTED BY THE WESTCHESTER COUNTY DEPARTMENT OF HEALTH.
- .0. AFTER BACKFILLING THE OWTS, THE AREA SHALL BE COVERED WITH A MINIMUM OF 4 INCHES OF CLEAN TOP SOIL, SEEDED AND MULCHED.
- 1. THE INSTALLATION OF THE OWTS SHALL BE IN ACCORDANCE WITH THE RULES AND OWTS DESIGN SUMMARY REGULATIONS FOR THE DESIGN AND CONSTRUCTION OF RESIDENTIAL SUBSURFACE

SEWAGE TREATMENT SYSTEMS AND DRILLED WELLS IN WESTCHESTER COUNTY, NY.

- 12. ALL PIPES CONNECTING TO TANK AND BOXES SHALL BE CUT FLUSH WITH THE INSIDE WALL OF BOX.
- 13. THE PROPOSED OWTS SHALL BE INSTALLED BY A WESTCHESTER COUNTY LICENSED SEPTIC CONTRACTOR.
- 14. PRIOR TO ANY EXCAVATION ALL UNDERGROUND UTILITIES MUST BE LOCATED. CALL 1-800-962-7962.
- 15. THE WESTCHESTER COUNTY HEALTH DEPARTMENT APPROVAL EXPIRES ONE YEAR FROM THE DATE ON THE APPROVAL STAMP AND IS REQUIRED TO BE RENEWED ON OR BEFORE THE EXPIRATION DATE. THE APPROVAL IS REVOCABLE FOR CAUSE OR MAY BE AMENDED
- .6. THERE ARE NO RESERVOIRS, RESERVOIR STEMS OR CONTROLLED LAKE WITHIN 500 FEET SOIL CLASSIFICATION: ChB & RhD OF THE PROPOSED OWTS UNLESS OTHERWISE SHOWN ON PLAN.

OR MODIFIED WHEN CONSIDERED NECESSARY BY THE DEPARTMENT.

- .7. THERE ARE NO NYSDEC WETLANDS OR WATERCOURSES WITHIN 200 FEET OF THE PROPOSED OWTS UNLESS OTHERWISE SHOWN ON PLAN.
- 18. STORMTECH SC-740 CHAMBERS ARE NOT A PART OF THE OWTS.
- 19. THE PROPOSED FILL FOR THE OWTS AREA IS TO BE RUN OF BANK SAND AND GRAVEL
- 20. ESTIMATED TIME OF CONSTRUCTION: MAY-JUNE 2021

MISCELLANEOUS DATA

99 BYRAM LLC 5 W MAIN ST ELMSFORD, NY 10523

EDWARD T. GANNON, PLS CHERRY HILL ROAD

BLOOMING GROVE, NY 10914 PREPARED 9/2/2020

BYRAM HILLS

INLAND LONG ISLAND SOUND BASIN

TOWN OF NORTH CASTLE

1.34 AC ARMONK FD TAX MAP 101.01-1-13 ONSITE WELL SEWER DISTRICT: ONSITE SSDS

DRAINAGE BASIN: BYRAM RIVER BASIN

EXISTING ZONING DISTRICT: R-1A

PROPOSED DEVELOPMENT SINGLE FAMILY, 5 BEDROOM HOME


DESIGN FLOW: 200 GPD/BEDROOM = 1,000 GPD DEPTH TO GROUNDWATER N/A


DEPTH TO BEDROCK N/A

SOIL PERCOLATION RATE = 16-20 MIN/IN

TOPOGRAPHY/SLOPE 11%

TOTAL LENGTH ABSORPTION TRENCH REQUIRED/PROVIDED = 720 LF

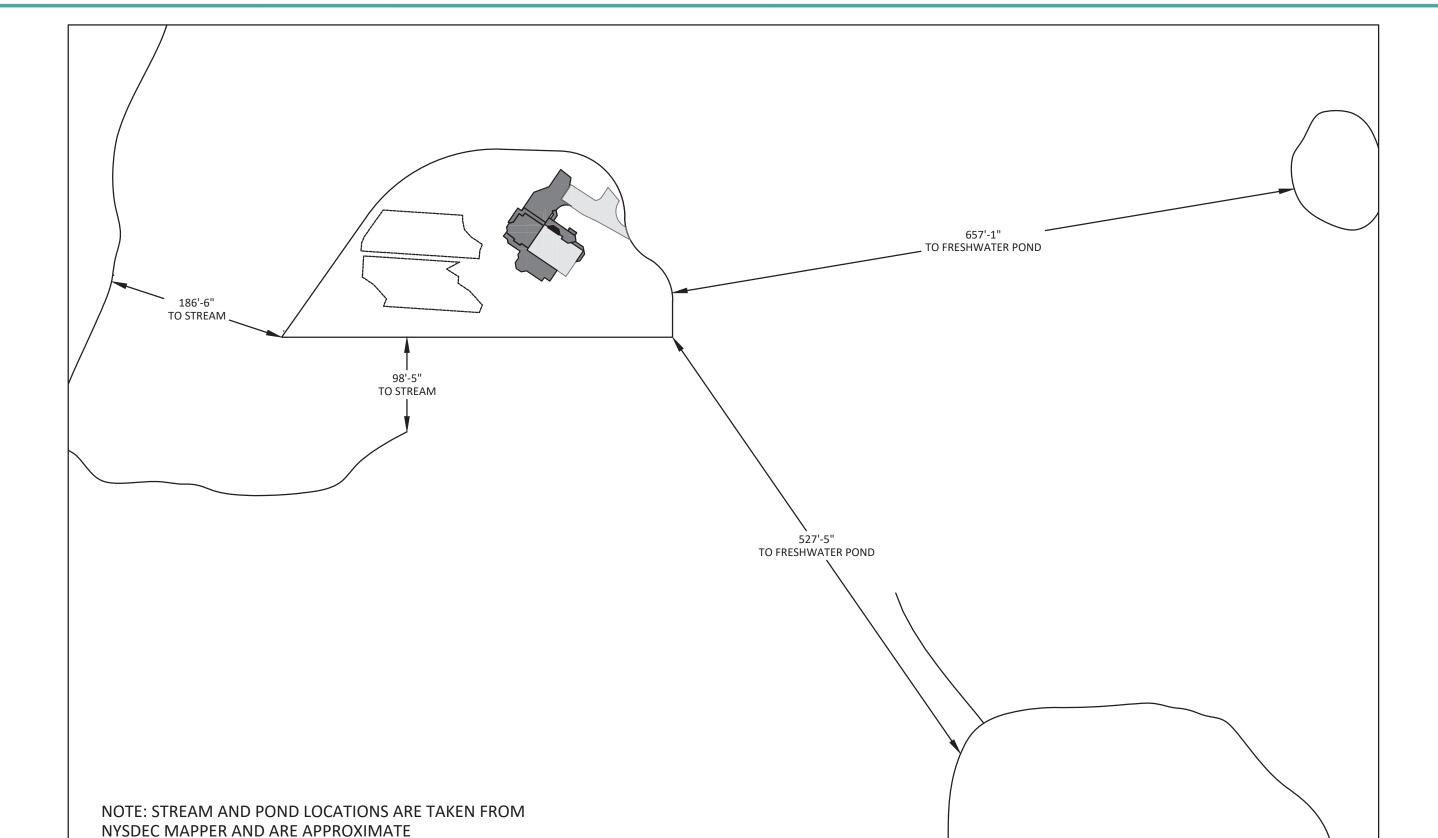

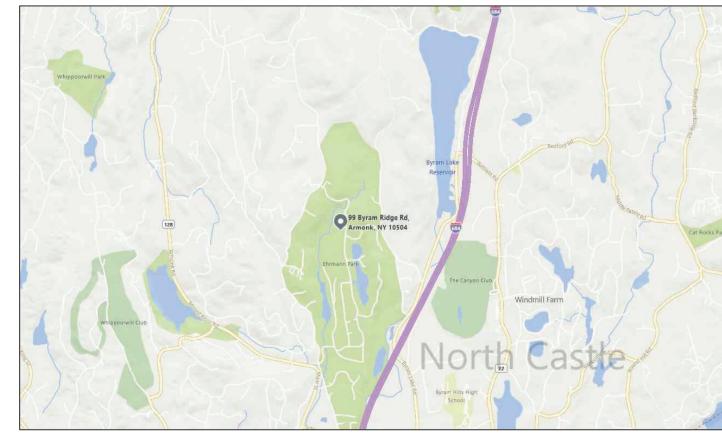

LOCATION MAP

ALTERATIONS BY ANY PERSON IN ANY WAY, OR ANY ITEM CONTAINED ON THIS DOCUMENT, UNLESS ACTING UNDER DIRECTION OF THE LICENSED ENGINEER WHOSE PROFESSIONAL SEAL IS AFFIXED HERETO, IS A VIOLATION OF TITLE VIII, ARTICLE 145 SECTION 7209.2 OF THE NEW YORK STATE EDUCATION LAW.

100 EXECUTIVE BLVD. SUITE 204 OSSINING, NY 10562

PHONE: (914) 944-3377

FAX: (866) 567-6240

JORGE B. HERNANDEZ R.A. A.I.A.

LICENSE NUMBER: 030424-1

CERTIFICATE NUMBER: 0973256

PAUL A. BERTE, P.E

DATE

100 EXECUTIVE BLVD. SUITE 204

Revised per Town 4/13/21

Rev.house loacation 7/8/21

OSSINING, NY 10562

REVISIONS

Comments

DRAWING TITLE: OWTS SITE PLAN

PROJECT: HT OF FILTER 99 BYRAM, LLC


> PROJECT ADDRESS: 99 BYRAM RIDGE ROAD


ARMONK, NY 10580

WCDOH SIGNATURE:

OWTS PLAN

STREAMS AND WATERBODIES 1" = 100'-0"

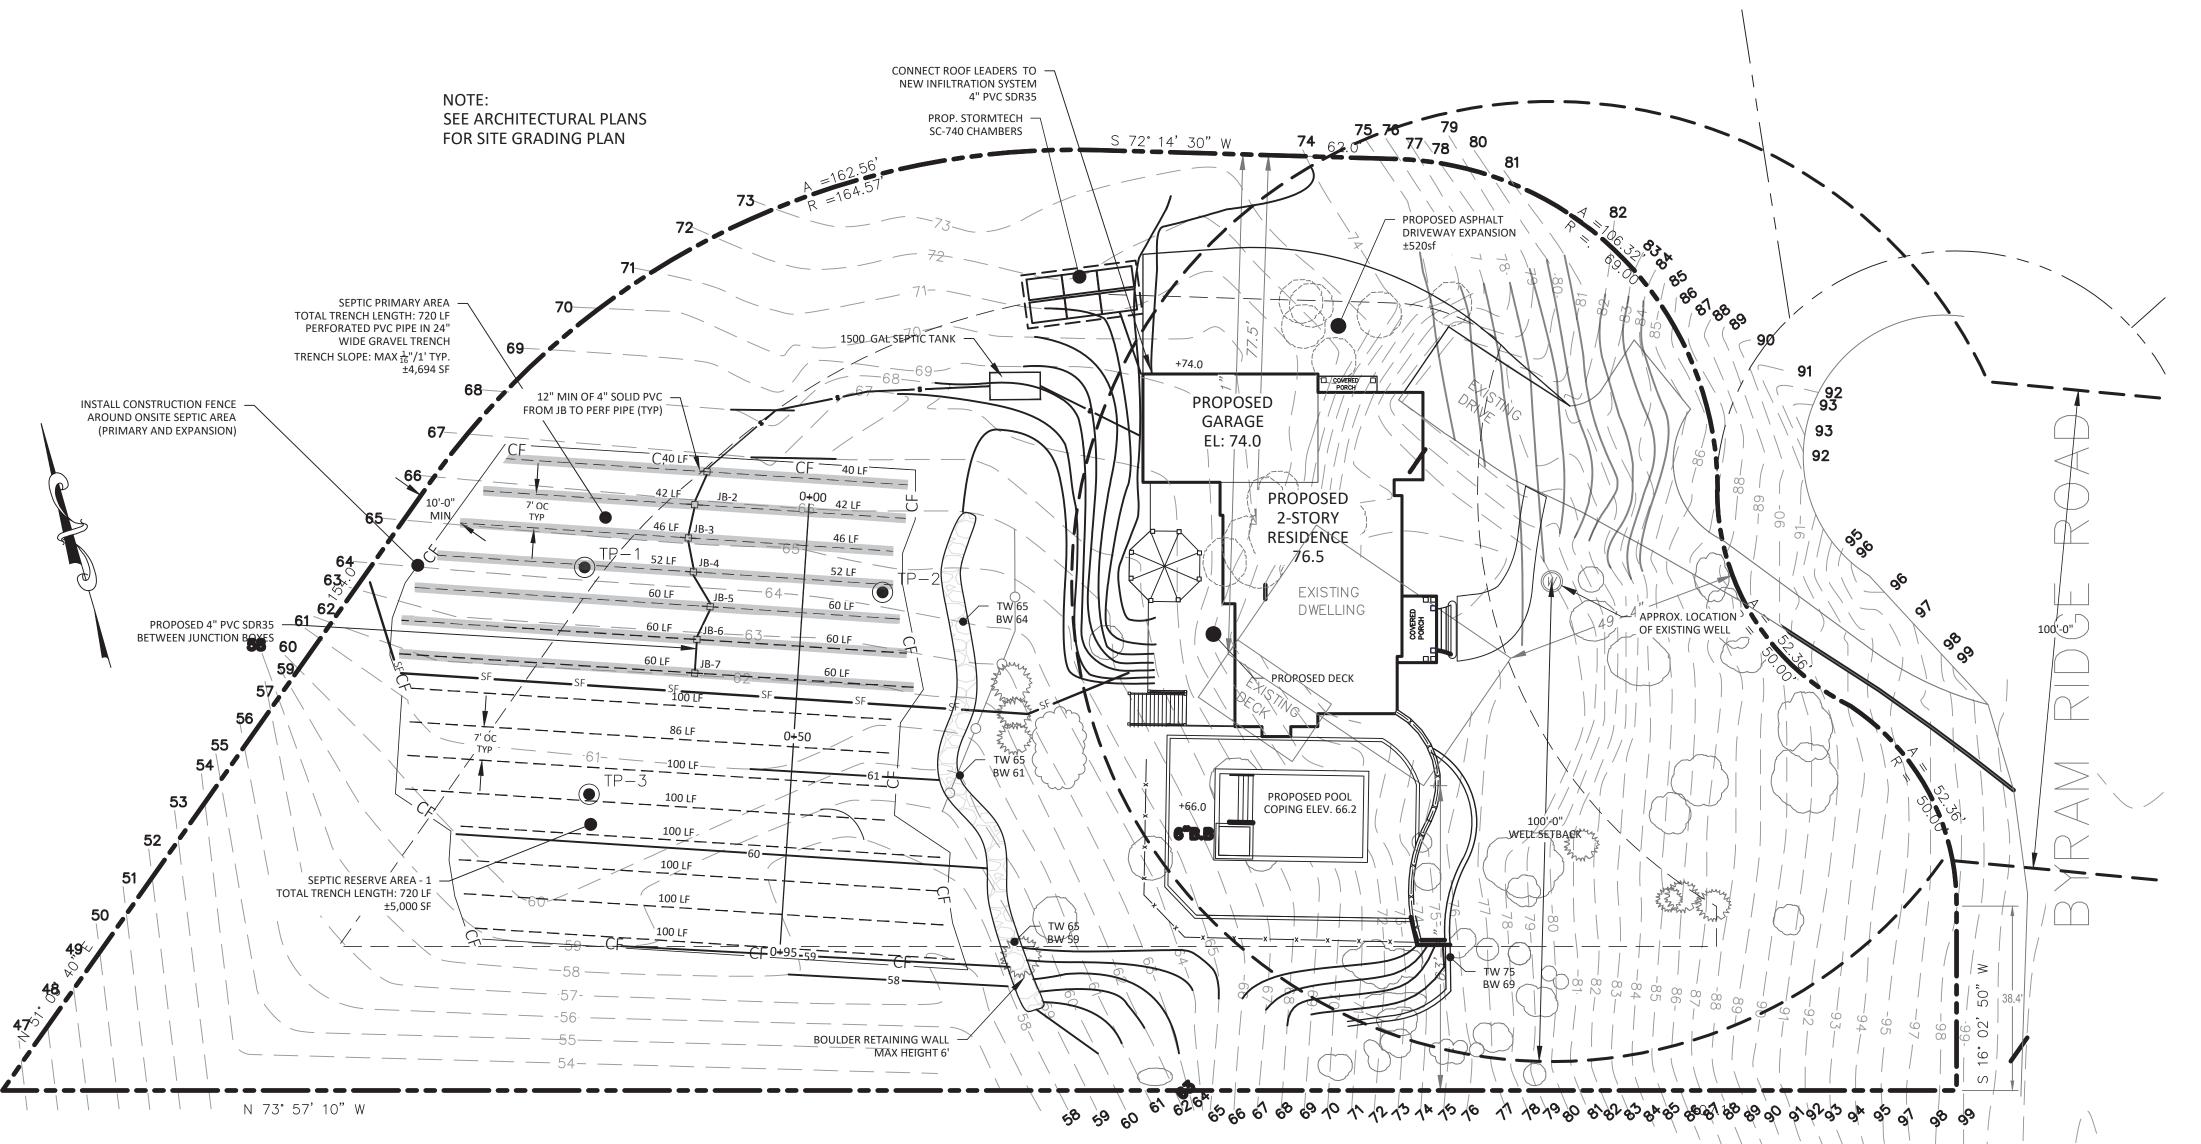

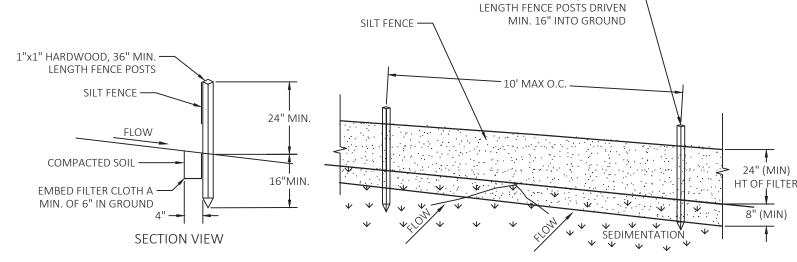

CONSTRUCTION SPECIFICATIONS:


EXISTING —

PLAN VIEW

GROUND

- SILT FENCE TO BE FASTENED SECURELY TO FENCE POSTS WITH STAPLES. POSTS SHALL BE 1"X1" HARDWOOD, OR APPROVED EQUAL.
- WHEN TWO SECTIONS OF FILTER CLOTH ADJOIN EACH OTHER THEY SHALL BE WRAPPED AROUND 2 STAKES, MIN 2X. FILTER CLOTH SHALL BE
- 3. MAINTENANCE SHALL BE PERFORMED AS NEEDED, REINFORCE AREA LOW POINTS WITH ADDITIONAL STAKES OR OTHER MATERIALS (AS RECOMMENDED BY ENGINEER). MATERIAL SHALL BE REMOVED WHEN SEDIMENT LOAD REACHES 50% HEIGHT OF FENCE.

SILT FENCE INSTALLATION DETAIL

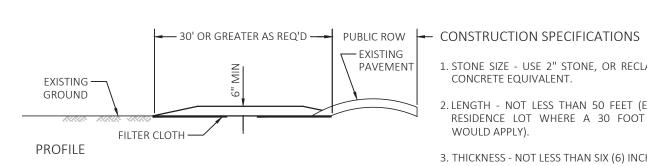

PROVIDE APPROPRIATE

PUBLIC R.O.W.

TRANSITION BETWEEN STABILIZED CONSTRUCTION ENTRANCE AND

30' OR GREATER AS REQ'D

12' (MIN)

25' R —

EITHER FILTER USCF MISF180, MIRAFI 100X OR APPROVED EQUIVALENT.

1"x1" HARDWOOD, 36" MIN. —

¬

PERSPECTIVE VIEW

1. STONE SIZE - USE 2" STONE, OR RECLAIMED OR RECYCLED CONCRETE EQUIVALENT. 2. LENGTH - NOT LESS THAN 50 FEET (EXCEPT ON A SINGLE RESIDENCE LOT WHERE A 30 FOOT MINIMUM LENGTH

WOULD APPLY). 3. THICKNESS - NOT LESS THAN SIX (6) INCHES.

4. WIDTH - TWELVE (12) FOOT MINIMUM. BUT NOT LESS THAN THE FULL WIDTH AT POINTS WHERE INGRESS OR EGRESS OCCURS. TWENTY-FOUR (24) FOOT IF SINGLE ENTRANCE TO

5. FILTER CLOTH - WILL BE PLACED OVER THE ENTIRE AREA PRIOR TO PLACING OF STONE.

6. SURFACE WATER - ALL SURFACE WATER FLOWING OR DIVERTED TOWARD CONSTRUCTION ENTRANCES SHALL BE PIPED ACROSS THE ENTRANCE. IF PIPING IS IMPRACTICAL. A MOUNTABLE BERM WITH 5:1 SLOPES WILL BE PERMITTED '. MAINTENANCE - THE ENTRANCE SHALL BE MAINTAINED IN A

CONDITION WHICH WILL PREVENT TRACKING OR FLOWING OF SEDIMENT ONTO PUBLIC RIGHTS-OF-WAY, ALL SEDIMENT SPILLED, DROPPED, WASHED OR TRACTED ONTO PUBLIC RIGHTS-OF-WAY MUST BE REMOVED IMMEDIATELY. 8. WHEN WASHING IS REQUITED, IT SHALL BE DONE ON A AREA STABILISED WITH STONE AND WHICH DRAINS INTO AN

APPROVED SEDIMENT TRAPPING DEVICE. 9. PERIODIC INSPECTION AND NEEDED MAINTENANCE SHALL

STABILIZED CONSTRUCTION ENTRANCE


PAVEMENT

NOTE: NOT TO BE USED FOR CONSTRUCTION


BE PROVIDED AFTER EACH RAIN.




3/1/21 PROJECT NO.: 21-030	1" = 20'-0
DRAWING BY: SB	DRAWING NO.:
CHECKED BY:	1 OF 2

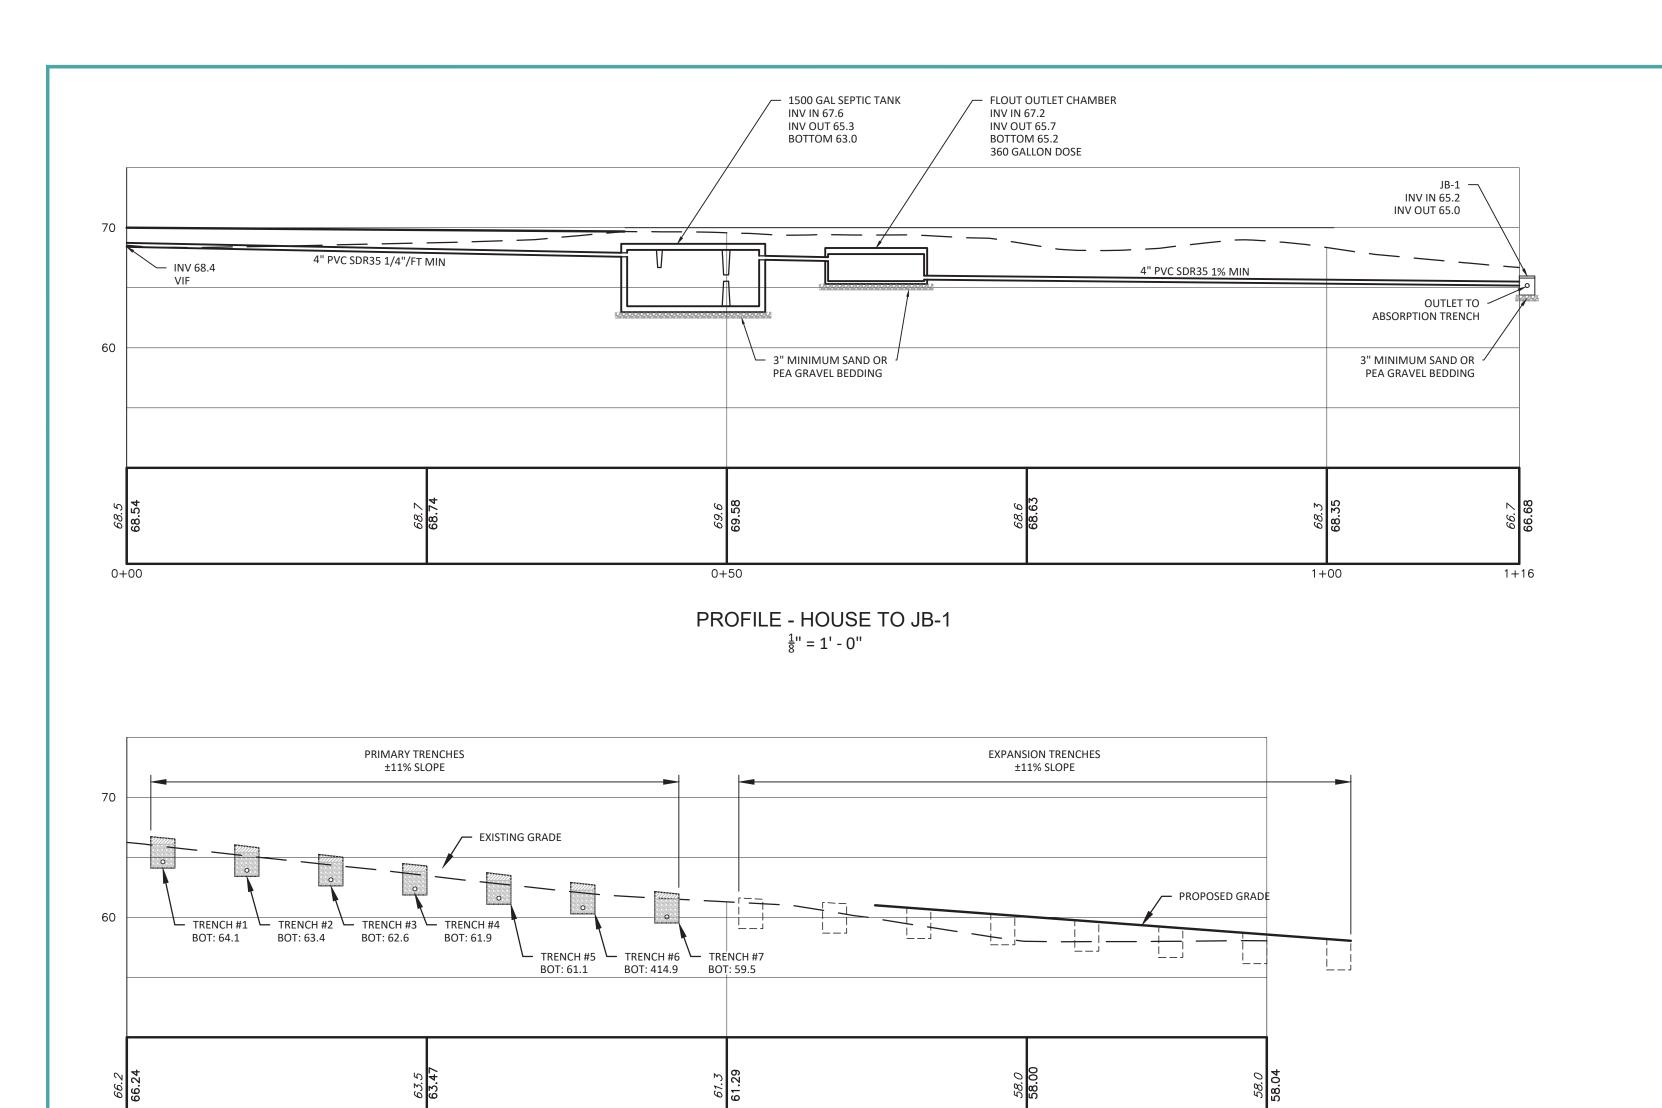


PROFILE - ABSORPTION TRENCHES $\frac{1}{8}$ " = 1' - 0"

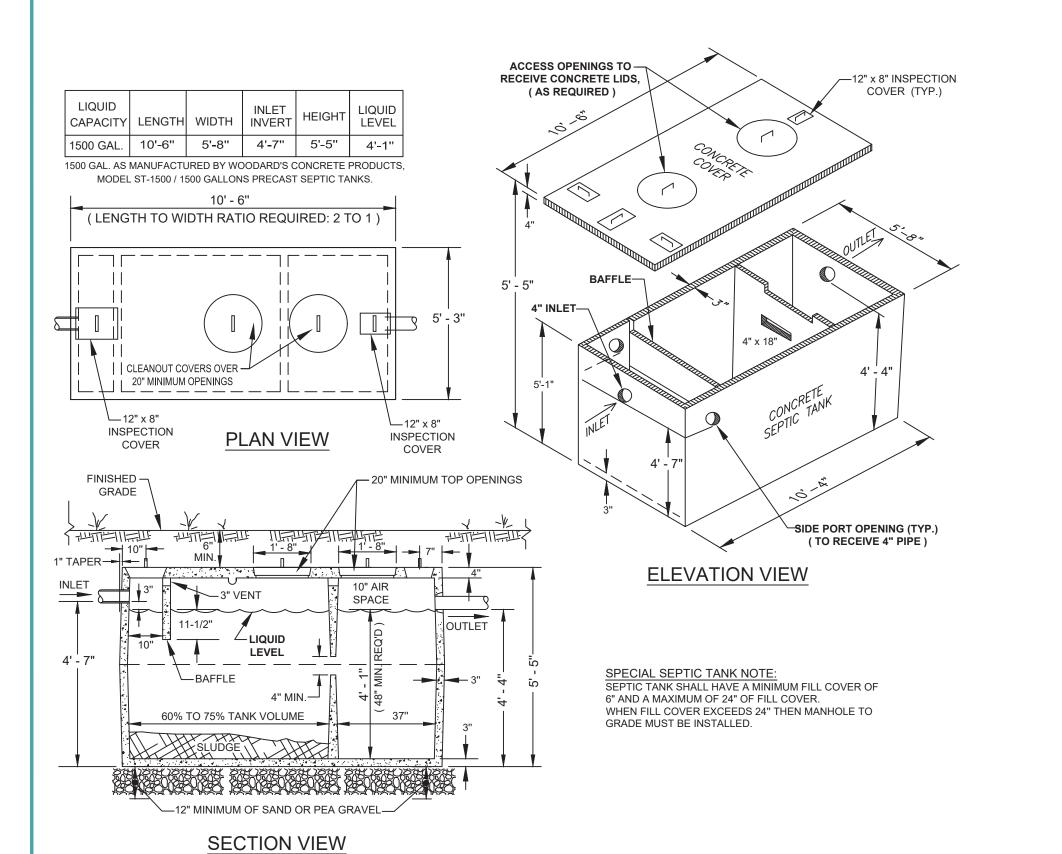

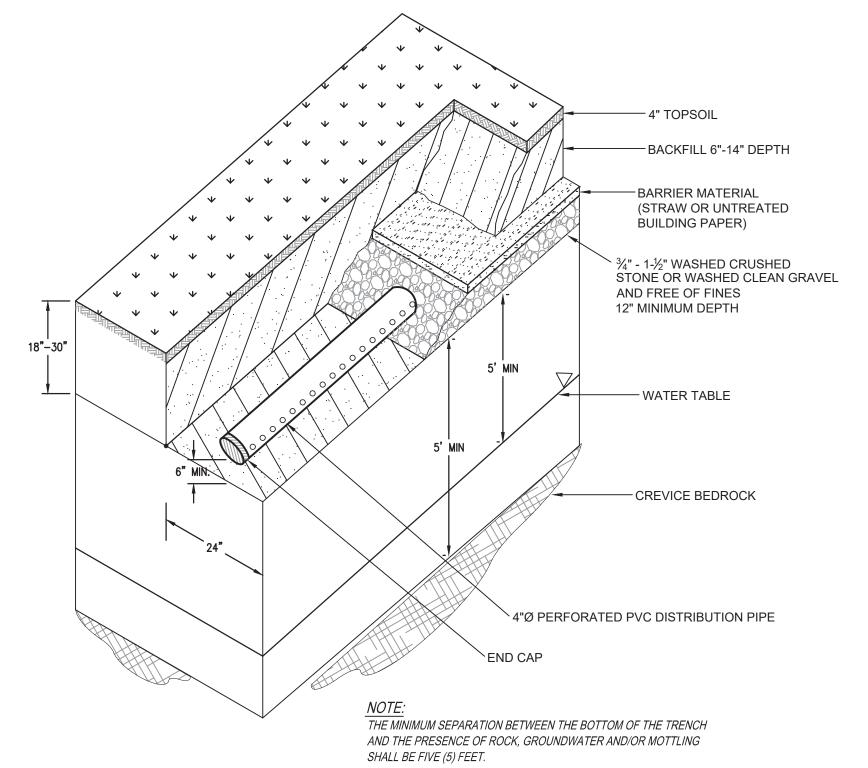

ABSORPTION TRENCH DETAIL

N.T.S.

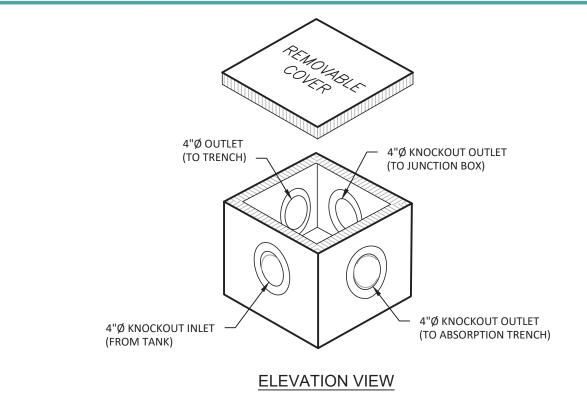


SPECIAL JUNCTION BOX NOTES:

GROUND LEVEL.

- 1. MAXIMUM COVER DEPTH ON JUNCTION BOX SHALL
- 2. THE BOTTOM OF THE JUNCTION BOX MUST BE LEVEL AND SUPPORTED SOLIDLY BELOW THE FROST LINE AND THE FOOTING IS TO EXTEND TO 36" BELOW THE
- 3. WATERPROOFED MASONRY CONSTRUCTION.
- 4. TIGHT JOINT PIPE FROM SEPTIC TANK TO BOX AND BETWEEN ALL BOXES.

5. PIPES TO BE CUT FLUSH WITH INSIDE WALL OF BOX.

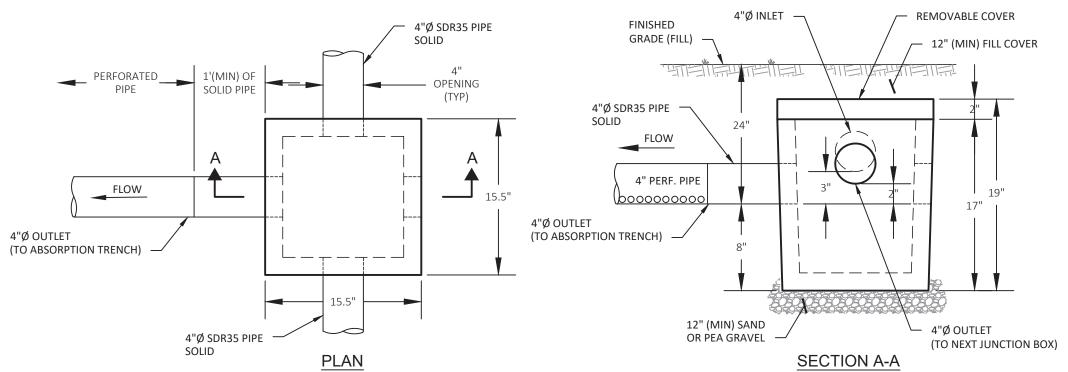

JUNCTION BOX DETAIL



100 EXECUTIVE BLVD. SUITE 204 OSSINING, NY 10562 PHONE: (914) 944-3377 FAX: (866) 567-6240

JORGE B. HERNANDEZ R.A. A.I.A. LICENSE NUMBER: 030424-1 CERTIFICATE NUMBER: 0973256

PAUL A. BERTE, P.E

100 EXECUTIVE BLVD. SUITE 204 OSSINING, NY 10562

REVISIONS	DATE	BY

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DRAWING TITLE: DETAILS

PROJECT:

99 BYRAM, LLC OWTS PLAN


PROJECT ADDRESS: 99 BYRAM RIDGE ROAD ARMONK, NY 10580


WCDOH SIGNATURE:

SEAL & SIGNATURE



	DAIL.:	SCALE:
	3/1/21 PROJECT NO.: 21-030	AS SHOWN
	DRAWING BY:	DRAWING NO.:
NOTE: NOT TO BE USED FOR CONSTRUCTION	SB CHECKED BY: PB	2 OF 2
	Г D	

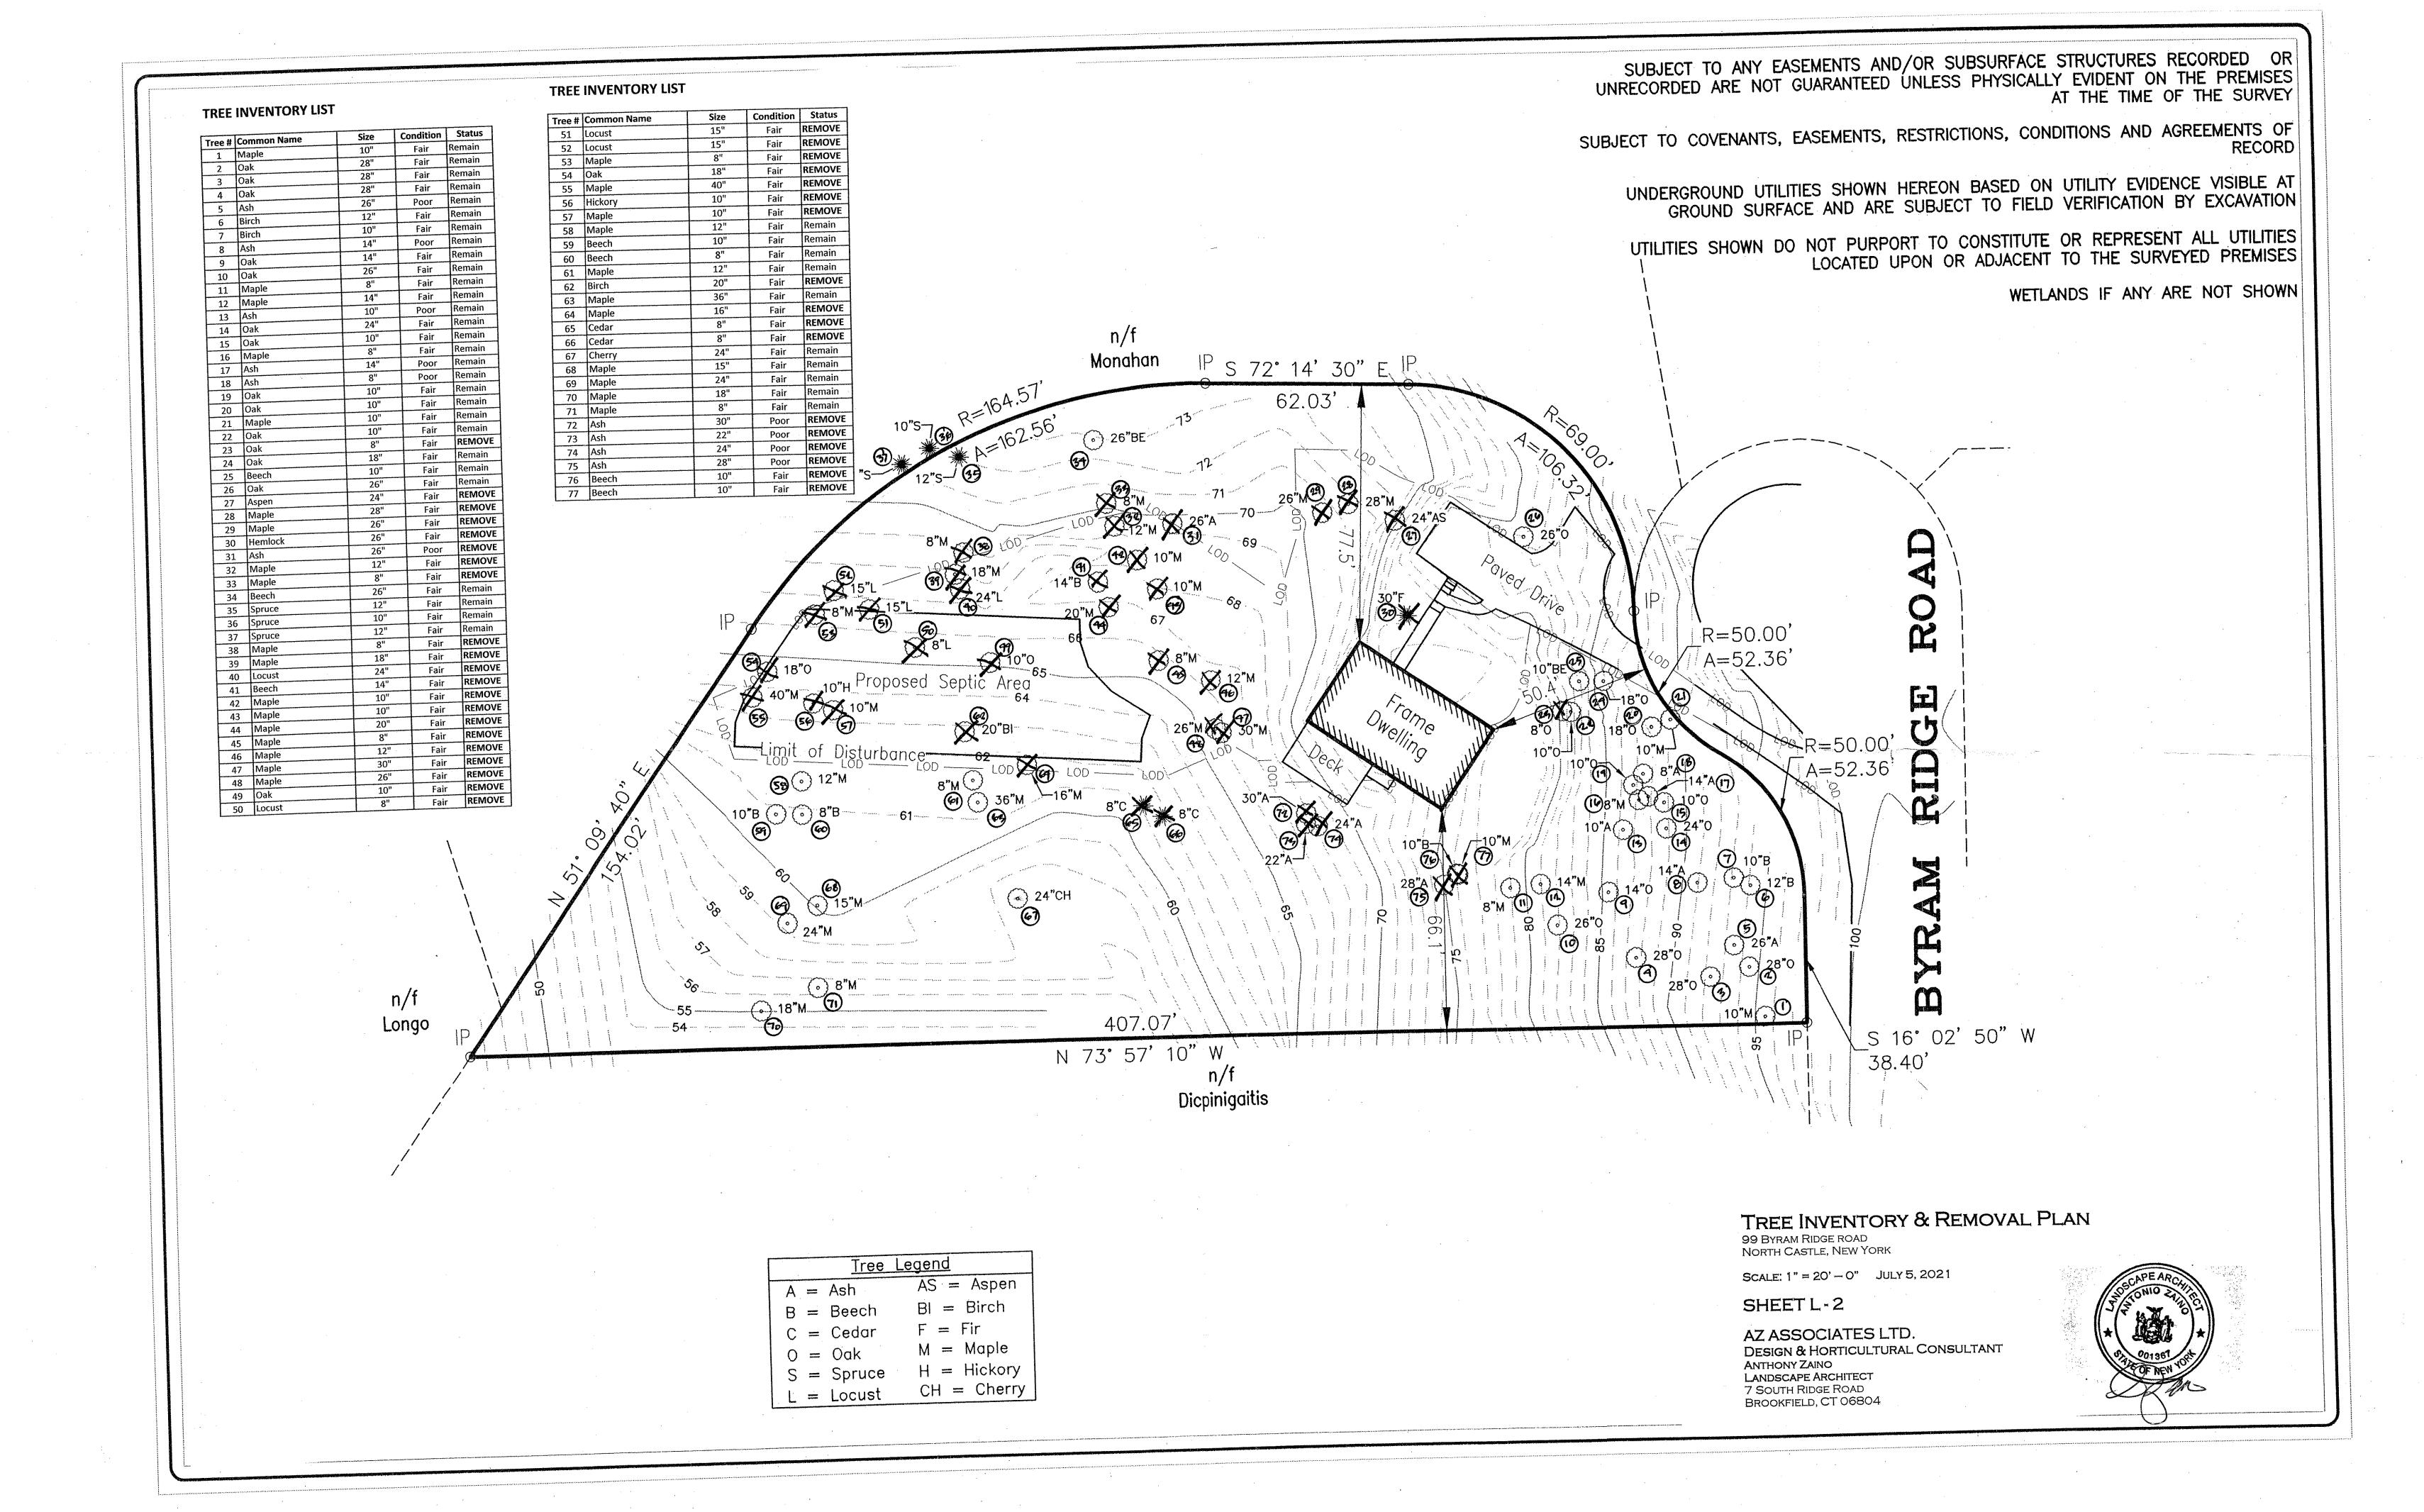

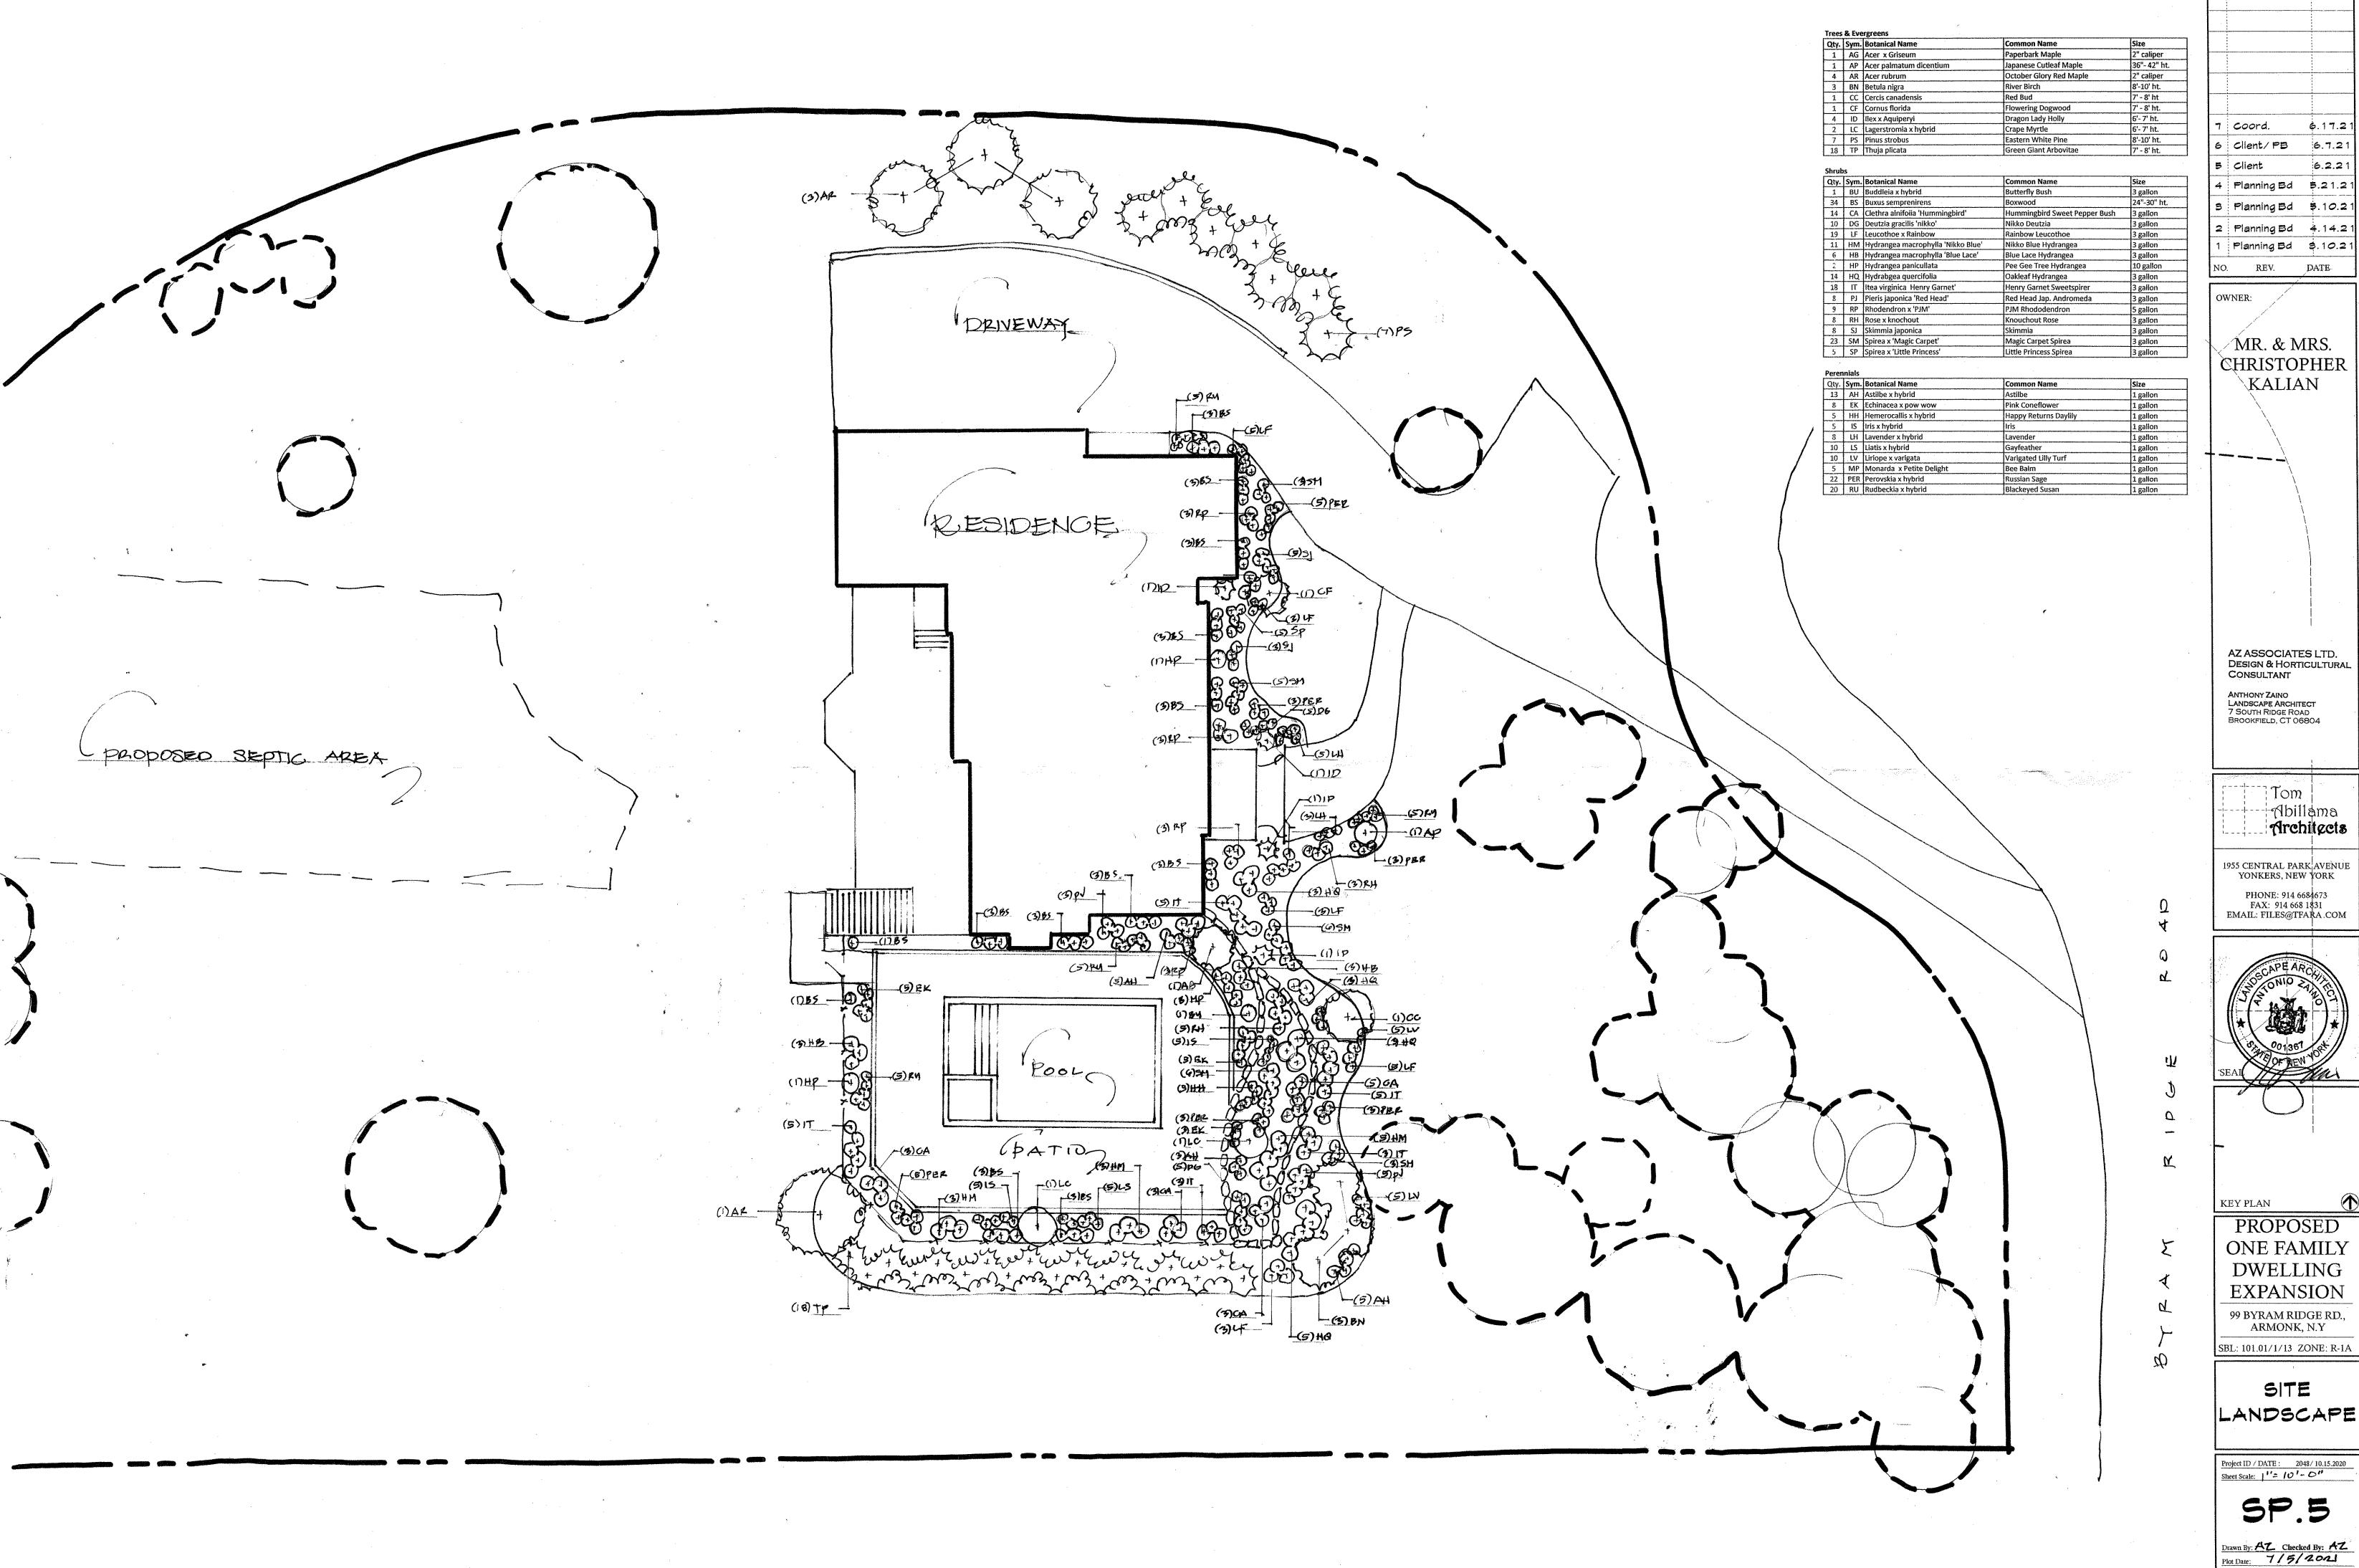

6.17.21 6.7.21 6.2.21 Planning Bd 5.21.21 B Planning Bd \$.10.21 2 Planning Bd 4.14.2 Planning Bd \$.10.21


> MR. & MRS. CHRISTOPHER KALIAN

AZ ASSOCIATES LTD. DESIGN & HORTICULTURAL CONSULTANT

BROOKFIELD, CT 06804

Abillama Architects

1955 CENTRAL PARK AVENUE YONKERS, NEW YORK PHONE: 914 6684673

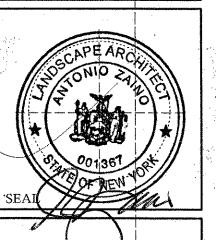

ONE FAMILY **DWELLING EXPANSION**

SITE


Project ID / DATE : 2048/10.15.2020

Sheet Scale: | ''= /0' - O''

SP.5

PROPOSED RENOVATION OF

The Kalian Residence

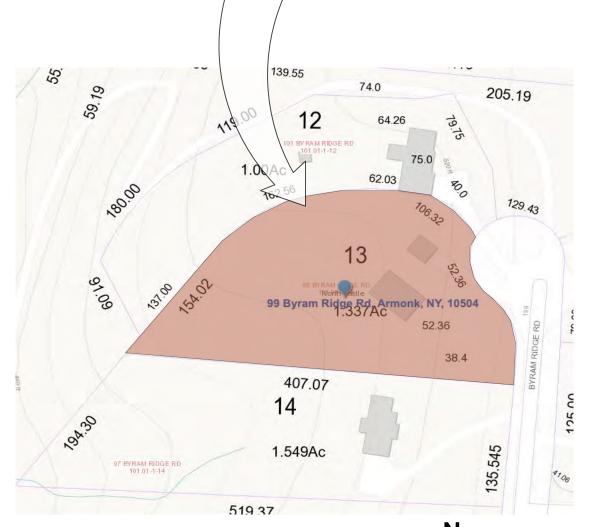

99 Byram Ridge Road, Armonk, NY

OWNER: Mr. & Mrs. Christopher Kalian

Contractor: Ridge Partners


Architect: Tom F. Abillama, AIA



	DRAWING LIST
T. 1	TITLE SHEET
c . 1	COVER SHEET
C.2	RENDERINGS
C.3	STREETSCAPE
SP.1	SITE PLAN
SP.2	SITE ZONING/ DIAGRAMS
SP.3	SITE STORMMATER PLANS
SP.4	SITE GRADING PLAN
A.1	BASEMENT FLOOR PLAN
A.2	1ST FLOOR PLAN
A.S	2ND FLOOR PLAN
A.4	ROOF PLAN
Ą. ق	FRONT & REAR ELEVATIONS
A.6	RIGHT ELEVATION
A.7	LEFT ELEVATION/ SECTION
A.8	CROSS SECTION
A.9	EXTERIOR WALL DETAILS
A.10	GAZEBO DETAILS






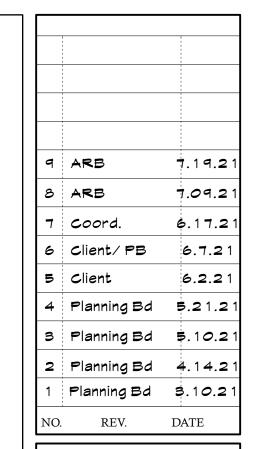

MR. & MRS. **CHRISTOPHER** KALIAN





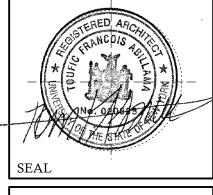

PROPOSED ONE FAMILY **DWELLING EXPANSION**

TITLE SHEET

Drawn By: KM Checked By: TFA



The Kalian Residence

99 Byram Ridge Road, Armonk, NY

	i 	
9	ARB	7.19.21
8	ARB	7.09.21
7	Coord.	6.17.21
6	Client/ PB	6.7.21
5	Client	6.2.21
4	Planning Bd	5.21.21
3	Planning Bd	5.10.21
2	Planning Bd	4.14.21
1	Planning Bd	3.10.21
NΩ	REV	DATE

OWNER:

MR. & MRS. CHRISTOPHER KALIAN



PHONE: 914 6684673 FAX: 914 668 1831 EMAIL: FILES@TFARA.COM



VEV DI ANI

PROPOSED
ONE FAMILY
DWELLING
EXPANSION

99 BYRAM RIDGE RD.,

ARMONK, N.Y

COVER

Project ID / DATE : 2048/ 10.15.2020

T.2

Drawn By: KM Checked By: TFA



The Kalian Residence

99 Byram Ridge Road, Armonk, NY

	i	
	1 1 1	
9	ARB	7.19.21
8	ARB	7.09.21
7	Coord.	6.17.21
6	Client/ PB	6.7.21
5	Client	6.2.21
4	Planning Bd	5.21.21
3	Planning Bd	5.10.21
2	Planning Bd	4.14.21
1	Planning Bd	3.10.21
NO.	REV.	DATE

OWNER:

MR. & MRS. CHRISTOPHER KALIAN



955 CENTRAL PARK AVENUE YONKERS, NEW YORK PHONE: 914 6684673 FAX: 914 668 1831 EMAIL: FILES@TFARA.COM



KEY PLAN

PROPOSED
ONE FAMILY
DWELLING
EXPANSION
99 BYRAM RIDGE RD.,


ARMONK, N.Y

COVER

Project ID / DATE : 2048/ 10.15.202

T.3

Drawn By: KM Checked By: TFA

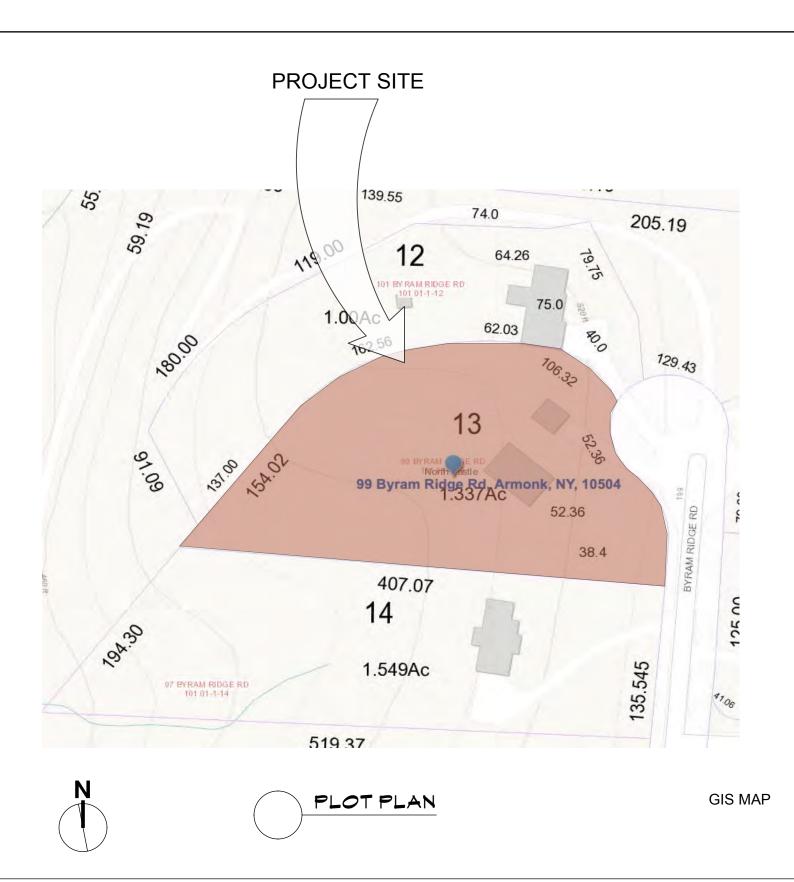

ELECTRICAL NOTES

Mork related to these documents shall include furnishing and installation of every kind of wire/conduit required to make the electric light and power distribution system complete, i.e. providing and connecting service entrance equipment, lighting panels, power panels, switches, outlets, receptacles, back boxes, related components required by the local utility company of all fixtures complete with lamps, clamps, hangers, supports, etc.

All electrical work shall comply with the requirements of the national electric code, latest edition. Should a conflict arise, the code or more stringent requirements shall prevail.

All wiring shall be copper, #12 awg minimum size - #8 and smaller to be solid, #6 and larger to be stranded. Insulation to be NEC 600 volt type, rated @ 75 degrees C and be properly phase color coded for 120/208 V. 3 phase 4-wire service.

Unless noted otherwise, minimum size conduit shall be 1/2" and number of cross marks indicate number of #12 conductors in conduit. Type of conduit used shall be in strict accordance with code provisions concerning same. All conduit runs are to be concealed in floors, walls, and ceilings, except where noted otherwise.

Electrical installation shall be tested for shorts, grounds, operation of low voltage circuitry, night light wiring, stand-by generator and connections to same, etc. Defects shall be remedied at once and the tests re-run as many times as may be required to prove correctness. Balance all phase loading of all panelboards.

The circuits shall be distinctly numbered and identified on the schedule of circuits typewritten to the panelboard. Affix permanent identifying nameplates to all electrical switches, pilot devices, selector switches, etc. Submit samples and list of titles for approval prior to purchase and installation.

PLUMBING NOTES

Installation of all work herein specified shall conform to the requirements of the NY State Plumbing Code, rules and regulations of the North Castle building department, and all other local authorities having jurisdiction, including federal O.S.H.A. specifications.

All materials used shall be new, best of their respective brands and conform to the requirements of all state and local authorities having jurisdiction. Pipework installed under this contract shall be in accordance with the following schedule:

Material

Soil and waste lines[within building]above grade-extra heavy cast iron pipe or dwv copper pipe with sweat solder connections;

Below grade- extra heavy cast iron pipe. soil and waste lines [outside building] extra heavy cast iron pipe. vent pipingstandard weight galvanized pipe or type dwv copper pipe with sweat solder joints. cold and hot water piping underground-typek with flare fittings.

Above grade [within building] type I copper tube with lead free sweat solder connections

Set clevis hangers for the support of copper piping not more than 10 ft on center. set hangers for cast iron pipe not more than 5 ft apart; use 3/8" rod for pipe up to 2" and 1/2" rod for pipes, 2 1/2" and larger. cover all cold water and hot water lines with 1" thick o-c fiberglass light density one piece pipe insulation having frk universal type vapor barrier outer jacket. install as per manufacturer's specifications. cover all valves and fittings with zeston premoulded insulating shapes.

02060 REMOVALS

I. MORK INCLUDED

- 1. SEE ARCHITECTURAL DEMOLITION DRAWING SEE ALSO MECHANICAL AND ELECTRICAL DRAWINGS.
- 2. GENERAL REMOVALS AND RELOCATIONS:
- 1. REMOVE AND RELOCATE ALL EXISTING MISCELLANEOUS MECHANICAL AND ELECTRICAL DEVICES AND FIXTURES INCLUDING BUT NOT LIMITED TO: FIRE ALARM, PULLS STATIONS, POWER OUTLETS, LIGHT SMITCHES, THERMOSTATS AND TELEPHONE OUTLETS AS REQUIRED FOR THE INSTALLATION OF NEW YORK.
- 2. REMOVE ALL ITEMS, MATERIALS AND FINISHES REQUIRED FOR THE INSTALLATION OF NEW WORK, OR THE RELOCATION OF EXISTING, AS DESCRIBED IN PERTINENT SECTIONS OF THESE SPECIFICATIONS AND / OR SHOWN ON THE DRAWINGS INCLUDING STRUCTURAL, MECHANICAL END ELECTRICAL DRAWINGS AND SPECIFICATIONS.
- 3. EXISTING WIRING, PIPING OR OTHER LINES WITHIN WALLS OR CEILINGS TO BE REMOVED - VERIFY THAT THESE ARE ABANDONED PRIOR TO REMOVAL. RE-ROUTE ANY LINES THAT ARE STILL IN USE TO MAINTAIN ALL EXISTING SERVICES.
- II. MATERIALS (NA)

III. EXECUTION

- 1. ALL REMOVALS AND DEMOLITION SHALL BE IN COMPLIANCE WITH NYS BUILDING CODE, AND ALL APPLICABLE FEDERAL SAFETY REGULATIONS.
- 2. ALL MATERIALS AND ITEMS THAT ARE TO BE REUSED AND RELOCATED IN CONJUNCTION MITH THE NEW MORK SHALL BE CAREFULLY CUT AWAY FROM THE EXISTING ABUTTING WORK TRUE TO LINE AT THE NEAREST JOINT, SURFACE BREAK OR PATTERN LINE TO ENSURE NO NOTICEABLE DIFFERANCE BETWEEN NEW AND EXISTING TO REMAIN. REMOVALS SHALL BE KEPT TO A MINIMUM MATERIALS TO BE REUSED AND RELOCATED SHALL BE PROPERLY HANDLED. TAGGED AND PROPERLY STORED TO PREVENT DAMAGING AND BREAKING.
- 3. CAREFULLY COORDINATE ALL TRADES TO ENSURE PROPER AND ADEQUATE INTERFACE OF THE WORK.
- 4. WHEN WORK IS STOPPED, PROVIDE AND MAINTAIN IN PLACE SUITABLE COVERINGS AND BARRIERS FOR PROTECTION OF THE WORK AND SAFETY FOR ALL PERSONNEL AND BUILDING USERS, PROVIDE PROTECTED PATHS OF EGRESS, PER PHASING REQUIREMENTS, FOR CONTINUOUS PLUBLIC ACCESS TO STAIRS , ESCALATORS AND ENTRANCES / EXITS.
- 5. PROTECT ALL WORK, EXISTING AND NEW, FROM DAMAGE BY ANY CAUSE THROUGHOUT THE DEMOLITION OPERATIONS PROTECTIVE COVERINGS OR BARRIERS SHALL NOT MAR, STAIN OR PENETRATE THE FINISHED MORK.
- 6. COORDINATE ALL ELECTRICAL WORK FOR THE PROPER DISCONNECTIONS, PROTECTIONS AND CAPPINGS: SEE ELECTRICAL DRAWINGS AND SPECIFICATIONS.
- 7. UNDERTAKE WHATEVER PRECAUTIONS ARE NECESSARY TO PREVENT EXCESSIVE DUST DURING DEMOLITION.
- REMOVE ALL PORTIONS OF THE WORK IN A SAFE MANNER WITH CARE TO PREVENT DAMAGE TO ADJACENT AND REMAINING STRUCTURE, FINISHES OR ANY OTHER ITEMS OF PROPERTY.
- 9. ALL MATERIALS UNLESS NOTED TO BE REUSED OR TO BE SALVAGED SHALL BE REMOVED OFF THE PROPERTY TO AN AVAILABLE DUMP OR SITE OF THE CONTRACTOR'S OWN CHOOSING AND ARE TO BE PROPERLY AND RESPONSIBLY DISPOSED OF. NO BURNING OR ON-SITE DISPOSAL IS PERMITTED.
- 10. VERIFY SALVAGE REQUIREMENTS FOR ALL MATERIALS NOTED TO BE REMOVED WITH SAFE HORIZON. MATERIALS NOTED TO BE SALVAGED SHALL BE PROPERLY STORED IN LOCATION PER SAFE HORIZON, INC. DIRECTIONS.
- 11. ALL SPACES ARE TO BE BROOM CLEANED DAILY.
- 12. ALL REMOVALS SHALL LEAVE THE EXISTING SURFACES AND SUBSTRATES FREE AND CLEAN FOR THE PROPER PATCHING AND PREPARATION REQUIRED FOR THE SPECIFIED NEW MATERIALS AND FINISHES.

NOTES: STEEL COL'S SHALL REST ON 12" X 12"

3/4" T. ST. BASE PLATE OVER LEVELLING PLATE OVER NON-SHRINK GROUT W/(4)3/4" \$ 12" LONG ANCHOR BOLTS OVER

3'-0" X 3'-0" X 18 " CONC. FOOTINGS W/(3) # 4'S EA. WAY-

@ 18" O.C. STAGGERED.

BOTTOM.

ALL BEAMS OVER 2 MEMBERS SHALL BE BOLTED TOGETHER M/3/4" THRU-BOLTS

ALL FLUSH BEAMS SHALL RECEIVE JOIST HANGERS BY SIMPSON OR EQ.

ALL DOORS, WINDOWS SHALL RECEIVE (2) 2X10 HEADERS (TYP.) UNLESS OTHERWISE NOTED ON PLANS.

ALL FOUNDATION WALLS SHALL BE WATERPROOFED W/ 2-COATS OF BITUM. COATING AND BACKFILLED M/GRAVEL

CONSTRUCTION TO BE "V b" SINGLE FAMILY RESIDENTIAL LIVE LOADS = 40 PSF GROUND SNOW LOAD = 30 PSF SNOW LOAD = 30 PSF DEAD LOAD = 15 PSF WIND LOADS = 115 MPH SEISMIC DESIGN: B

1- ALL STRUCTURAL STEEL SHALL CONFORM WITH AISC SPECIFICATIONS FOR STRUCTURAL STEEL FOR BUILDINGS, AND SHALL BE BASED ON ASTM-A36 WITH MINIMUM YIELD POINT OF

- 36.000 PSI. 2- ALL CONNECTION MATERIAL SHALL CONFORM TO ASTM REQUIREMENTS:
- A) HIGH STRENGTH BOLTS : A325.
- B) WELDING ELECTRODES : AWS-A5.1, E70 SERIES. C) BOLTS SHALL BE 3/4" DIAMETER.
- D) OPEN HOLES SHALL BE 13/16" DIAMETER, UNLESS OTHERWISE INDICATED. 3 - ALL WELDING SHALL BE DONE BY LICENSED WELDERS AND SHALL BE INSPECTED BY APPROVED WELDING AGENCY.
- 4- PROVISIONS SHALL BE MADE FOR CONNECTIONS OF OTHER TRADES PRIOR TO FABRICATION.
- 5- ALL STEEL MEMBERS SHALL HAVE SHOP COAT OF PRIMER. 6-LOOSE LINTELS SHALL HAVE 6" BEARING EACH END.

1- ALL FOOTINGS ARE TO REST ON UNDISTURBED SOIL HAVING A MIN. BEARING CAPACITY OF 2 TONS PER SQ. FT. 2- EDGES OF FOOTINGS SHALL NOT BE PLACED AT A GREATER THAN 1 VERTICAL

TO 2 HORIZONTAL SLOPE WITH RESPECT TO ANY OTHER ADJACENT FOOTINGS.

1- ALL CONCRETE SHALL BE STONE AGGREGATE CONCRETE WITH AN ULTIMATE COMPRESSIVE STRENGTH OF 3000# PSI AFTER 28 DAYS. 2- WELDED WIRE FABRIC SHALL HAVE AN ULTIMATE STRENGTH OF 70,000 PSI. 3- ALL STEEL REINFORCEMENT SHALL BE DEFORMED ACCORDING TO ASTM-A615, GRADE 60 AND SHALL HAVE A YIELD POINT OF 40,000 PSI.

- 1- CONCRETE BLOCK SHALL CONFORM TO ASTM C-145, GRADE N-1. 2- MORTAR SHALL CONFORM TO ASTM C-270 TYPE "M".
- 3- NO VINYLIDENE CHLORIDE OR ANY UNAPPROVED CURING ADMIXTURE SHALL BE ALLOWED IN MORTAR MIXTURE.
- 4- PROVIDE GALV. HORIZONTAL REINFORCEMENTS AT EVERY COURSE JOINT.

ADMINISTRATIVE

THE ARCHITECT/ENGINEER HAS NOT BEEN RETAINED FOR THE SUPERVISION OF WORK & IT REMAINS INCUMBENT ON THE CONTRACTOR TO INFORM THE BUILDING DEPARTMENT OR THE ARCHITECT/ENGINEER OF ANY DISCREPANCIES OR CHANGES ON THE APPROVED PLANS.

NO WORK IS TO BE STARTED UNTIL A BUILDING PERMIT HAS BEEN SECURED AS REQUIRED BY THE GOVERNING AGENCIES.

THE CONTRACTOR IS TO VERIFY ALL DIMENSIONS AND CONDITIONS PRIOR TO THE COMMENCEMENT OF WORK & SHALL REPORT ANDY DISCREPANCIES TO THE ATTENTION OF THE ARCHITECT/ENGINEER BEFORE PROCEEDING.

ALL WORK OF THE VARIOUS TRADES INVOLVED WITH THE CONSTRUCTION OF THIS PROJECT IS TO BE PERFORMED BY CAPABLE AND REPUTABLE CONTRACTORS, LICENSED IN THE STATE OF NEW YORK & AS REQUIRED BY LOCAL AGENCIES.

DO NOT SCALE DIMENSIONS FROM DRAWINGS. WRITTEN DIMENSIONS ARE TO BE FOLLOWED FOR CONSTRUCTION PURPOSES. LARGE SCALE DRAWINGS TAKE PREFERENCE OVER SMALLER SCALE

NO WORK IS TO BE STARTED UNTIL THE PLANS ARE APPROVED BY THE NEW YORK CITY DEPT. OF BUILDING AND A WORK PERMIT IS OBTAINED.

THESE NOTES ARE PART OF THE CONSTRUCTION DOCUMENTS AND SPECIFICATIONS AND ARE TO BE FULLY COMPLIED WITH IN ALL RESPECT. THE CONTRACTOR SHALL BE HELD TO HAVE VISITED THE SITE SO THAT HE MAY DETERMINE THE DIFFICULTIES HE MAY ENCOUNTER DURING CONSTRUCTION.

FOUNDATION AND SUBSOIL CONDITIONS HAVE BEEN DESIGNED BASED ON THE INFORMATION CONTAINED WITHIN THE BORINGS AND/OR TEST PITS AS FURNISHED BY THE OWNER, EXACT FOUNDATION REQUIREMENTS ARE SUBJECT TO CHANGE BASED ON CONTROLLED INSPECTIONS OF SUBSOIL CONDITIONS AND MAY VARY FROM THOSE INDICATED ON THESE

CONTRACTOR IS RESPONSIBLE FOR NOTIFYING UTILITY COMPANIES TO VERIFY EXACT LOCATIONS OF THEIR UTILITY LINES, SERVICE AND OTHER POSSIBLE EQUIPMENT.

THE OWNER SHALL BE RESPONSIBLE FOR THE SAFE MAINTENANCE OF THE BUILDING SITE.

PRIOR TO COMMENCMENT OF WORK THE ADJACENT PROPERTY OWNERS SHALL BE GIVEN 5 DAYS WRITTEN NOTICE BY CERTIFIED MAIL, WHERE ADJACENT PROPERTY IS AFFECTED BY FOUNDATIONS, GRADING EARTH WORK OR DEMO WORK.

AN ACCURATE AND COMPLETED SURVEY, MADE BY A LICENSED SURVEYOR, SHALL BE SUBMITTED TO THE APPLICANT OF RECORD AFTER COMPLETION OF WORK SHOWING THE LOCATION AND ELEVATIONS OF ANY NEW BUILDING OR EXTENSION, FINISHED FLOOR ELEVATION, GRADE ELEVATIONS AND SHALL COMPLY TO THE MINIMUM STANDARDS OF THE NYSSPLS.

GENERAL NOTES

CONTRACTOR SHALL VISIT SITE AND SHALL BE RESPONSIBLE FOR VERIFICATION OF ALL DIMENSIONS, CONDITIONS, WHICH PERTAIN TO THE FABRICATION PROCESSES, OR TO TECHNIQUES FOR CONSTRUCTION AND COORDINATION OF THE WORK OF ALL TRADES, PRIOR TO START OF CONSTRUCTION.

ALL DISCREPANCIES SHALL BE BROUGHT TO THE ATTENTION OF ARCHITECT BEFORE PROCEEDING. THE ELEVATIONS AND AVAILABILITY OF UTILITITIES, SEWER, WATER AND ELECTRIC LINES SHALL BE VERIFIED BY OR DETERMINED BY INTERESTED CONTRACTORS PRIOR TO SUBMISSION OF BID.

CONTRACTORS SHALL ADJUST PITCH OF NEW LINES TO INSURE PROPER AND LEGAL INTERSECTIONS. CONTRACTOR SHALL COORDINATE LOCATIONS FOR STRUCTURAL, MECHANICAL AND ELECTRICAL WORK FOR ALL PITS, SLAB DEPRESSIONS, SLEEVES IN FOUNDATION WALLS, SLABS, AND ROOF OPENINGS, ETC.

CONTRACTOR SHALL VERIFY CONDITIONS OF ADJOINING STRUCTURES WHICH MAY BE AFFECTED, PROVIDE ADEQUATE PROTECTION AND RESTORE TO ORIGINAL CONDITIONS, WHENCE DAMAGE SHOULD RESULT FROM SUCH WORK. THE CONTRACTOR SHALL PROVIDE ALL NECESSARY SHORING AND BRACING FOR ALL BUILDING COMPONENTS IN ORDER TO ADEQUATELY PROTECT AGAINST ANY FAILURES.

CONTRACTOR SHALL SECURE AND PAY FOR ANY AND ALL PERMITS, LICENSES, CERTIFICATES, FEES, ETC., REQUIRED BY THE TOWN OF NORTH CASTLE DEPARTMENT OF BUILDINGS OR ANY AND ALL JURISDICTION AUTHORITIES. CONTRACTOR SHALL OBTAIN A FINAL CERTIFICATE OF OCCUPANCY UPON COMPLETION.

ALL MORK MUST CONFORM TO THE TOWN OF NORTH CASTLE DEPARTMENT OF BUILDINGS, FIRE DEPARTMENT LAWS, RULES AND TO ALL REGULATIONS OF ALL AUTHORITIES HAVING JURISDICTION WHETHER SPECIFICALLY SHOWN OR NOT. [O.S.H.A. REGULATIONS MUST ALSO BE ADHERED TO]. ALL ELECTRIC WORK MUST CONFORM TO NATIONAL ELECTRIC CODE

ANY ITEM SHOWN ON ONE SHEET SHALL BE AS IF CALLED FOR BY ALL SHEETS. FINAL COORDIANTION IS THE RESPONSIBILITY OF THE CONTRACTOR. CONTRACTOR SHALL NOT SCALE DRAWINGS AND SHALL USE FIGURED DIMENSIONS ONLY. THE GENERAL CONDITIONS OF THE CONTRACT FOR CONSTRUCTION OF BUILDINGS, [STANDARD FORM OF A.I.A. LATEST EDITION A201], ARE PART OF THE CONTRACT DOCUMENTS.

MORK INCLUDED IN THESE CONTRACT DOCUMENTS TO BE ALL LABOR, MATERIALS, AND EQUIPMENT, REQUIRED TO COMPLETE THE PROPOSED CONSTRUCTION AS SHOWN. WORK INCLUDED IN THIS CONTRACT SHALL BE ACCORDING TO THE TRUE INTENT OF THE DRAWINGS AND SHALL BE FIRST CLASS IN ALL RESPECTS.

MORKMANSHIP FOR A MINIMUM OF ONE YEAR AFTER SUBSTANTIAL COMPLETION. THE ARCHITECT HAS NOT BEEN RETAINED FOR SUPERVISION OR PERIODIC FIELD OBSERVATIONS AND ASSUMES NO RESPONSIBILITY FOR SAFETY METHODS ON SITE. THE OWNER AND CONTRACTOR SHALL HOLD HARMLESS THE ARCHITECT FROM

AND AGAINST ALL CLAIMS, DAMAGES, LOSSES AND EXPENSES INCLUDING ATTORNEY'S FEES ARISING OUT OF OR RESULTING

SUBCONTRACTORS SHALL GUARRANTEE. IN WRITING TO THE OWNER AT CONCLUSION OF JOB. ALL MATERIALS AND

FROM THE PERFORMANCE OF THE WORK BY THE CONTRACTOR. CONTRACTOR SHALL APPLY TAPING COMPOUND IN 3 COATS TO ALL JOINTS OF ALL SHEETROCK, SHALL PROVIDE TWO COAT

HIGH GLOSS PAINT IN THE KITCHEN AREA AND A SATIN FINISH COAT AT ALL OTHER AREAS. INCLUDING CEILINGS. CONTRACTOR TO PROVIDE NEW CERAMIC TILE THROUGHOUT KITCHEN, BATHROOMS, LAUNDRY ROOMS AND ALL OTHER WET FLOOR AREAS. COLORS AS SELECTED BY OWNER. SUBCONTRACTOR IS TO PROVIDE ALL FINISH HARDWARE AS REQUIRED BY THE OWNER FOR ALL NEW DOORS.

SCOPE OF WORK PERTAINS TO THE RENOVATION/ADDITION TO EXISTING ONE FAMILY DWELLING. THESE PLANS ARE BASED ON THE 2020 RCNYS, (APPENDIX J. ALTERATION LEVEL 2-CHAPTER 6), THE TOWN OF NORTH CASTLEMUNICIPAL CODE AND ALL APPLICABLE RULES AND REGULATIONS.

I, TOM F. ABILLAMA R.A. , HEREBY STATE THAT I HAVE PREPARED THESE PLANS AND SPECIFICATIONS, TO THE BEST OF MY KNOWLEDGE, BELIEF AND PROFESSIONAL JUDGEMENT, IN COMPLIANCE WITH THE 2020 ENERGY CODE OF NEW YORK STATE-R 105.2.2 -ZONE 4A

TOM F. ABILLAMA, R.A. ARCHITECT

ENERGY CODE REQUIREMENTS: PRESCRIPTIVE METHOD ZONE 4A CRITERIA (RCNY,2020- N1102.1.2):

- 2-UFACTOR @ SKYLIGHT: .55 3-UFACTOR @ SHGC:.40 4-R VALUE @ ROOF: R-49
- 5-R-VALUE @ WD FRAME WALL: R-21 6-R-VALUE @ MASS WALL: R-13 7-R-VALUE @ FLOOR: R-25

1-UFACTOR @ GLAZING:.32

- 8-R-VALUE @ BASEMENT WALL: R-13 9-R-VALUE @ SLAB: R-10, 2 FT PERIM. 10-R-VALUE @ CRAWL SPACE WALL: R-19 1 1 - MAX INFILTR.@ WDWS,SKLTS: 0.3 CFM/SF
- 12-MAX INFILTR.@ SWING. DRS: 0.5 CFM/SF 13- MIN.75% -HIGH EFFICACY LAMPS
- 14- TESTING PER N1102-.4.1.2

ROUGH CARPENTRY:

- Framing and structural lumber: Douglas Fir #1. Fb=1050 psi, E=1,600,000 Fv=95 psi. All joists and rafters to have diagonal bridging, 8'-0" o.c. maximum. Solid blocking under ceramic tile. Members of built—up girders, headers or lintels
- shall be spiked or bolted together to act as one unit. 2. Cross bridging of joists 1- 1/4" x 3" max, 3'-0" o.c. Collar ties at cathedral ceilings,
- 2-2 x 6 @ 4'-0" o.c. max. Exterior carpentry at porches shall be c.c.a. treated as indicated on drawings. Ornamental posts shall be of a nominal size $6" \times 6" - pine$. 3. Wood deck, 5/4" thick T & G Redwood decking. Deck shall pitch
- slightly for water runoff.
- 4. Plywood shall meet the requirements of APA requirements and specifications: 5. Wall and roof sheathing: 5/8" thick, C-D—Ext-Apa, Exterior glue
- 6. Subflooring: 5/8" thick, C—D—Ext—Apa, exterior glue Underlayment: 3/8" thick—
- 7. Underlayment INT-APA Exterior glue
- 8. All wood beams to have a minimum bearing of 4". Double all joists under all partitions
- 9. All details of construction; lintels, headers, posts, beams, framing, nailing, etc. shall comply with all minimum standards of New York State Code.
- 10. Contractor to do all necessary firestopping of stud partitions and pipe
- chases, as required by N.Y. State Code whether specifically shown or not. 11. Lumber schedule: Miscellaneous lumber, furring, bridging, blocking
- to be grade #2 of any species ample in strength to meet the requirements thereof. 12. Mooden trimmers, headers, and tail joists over six feet in length,
- unless supported on walls or girders, shall be hung in approved metal stirrups, or hangers.
- 13. Every six feet, at least one beam or joist which rests on masonry walls, shall be secured to such walls by approved metal anchors attached in a manner
- at or near bottom to be self releasing. 14. The ends of wooden beams and joists resting on masonry walls shall be cut to a bevel of
- three inches in their depth. All girders to bear minimum of 8" on masonry. 15. Provide shelf and coat pole in all closets with five shelves in linen closet. 16. Finish woodwork shall be dressed and sanded, free from machine and tool marks, abrasions raised grain or other defects on surfaces exposed to view in the finished work.
- 17. Mood finish shall be set straight, plumb and level in true alignment, closely fitted and rigidly secure in place. Nail heads of exposed nailing shall be countersunk. All work shall be left clean, free from warp, twist, open joints and other defects
- 18. Interior miscellaneous finish carpentry and woodwork to be "C" select of white pine, oak,
- or yellow poplar.
- 19. Interior doors to be clear birch, stain grade.
- a joint between any two surfaces not of the same material. Caulking compound shall be silicone equal to Thiokol sealant by Toch Brothers.
- 21. Contractor to do all flashing required whether specifically shown or not. Tape and apply taping compound in 3 coats to all joints of all sheetrock.

20. Caulk at all doors and window frames, joints and other surfaces which require the closing of

STEEL NOTES

1- All Structural Steel Shall Conform With Aisc Specifications For Structural Steel For Buildings, And Shall Be Based On Astm-A36 With Minimum Yield Point Of 36,000psi.

- 2- All Connection Material Shall Conform To ASTM Requirements:
- A) High Strength Bolts : A325. B) Welding Electrodes: Aws-a5.1, E70 Series.
- C) Bolts Shall Be 3/4" Diameter. D) Open Holes Shall Be 13/16" Diameter, Unless Otherwise Indicated.

3- All Welding Shall Be Done By Licensed Welders And Shall Be Inspected By Approved Welding Agency.

- 4- Provisions Shall Be Made For Connections Of Other Trades Prior To Fabrication.
- 5- All Steel Members Shall Have Shop Coat Of Primer.
- 6- Loose Lintels Shall Have 6" Bearing Each End.

MOOD NOTES

- 1- All Exterior Mood Framing Members Shall Be Structural Grade With Min. Fiber Stress Strength Of 1400, And Shall Be Pressure Treated For Exterior Exposure.
- 2- Contractor To Provide All Steel Connections Required For Fastening Members To Others.
- 3- Contractor To Refer To "simpson-strong Tie" Manual For Post Plates, Joist / Beam Hangers As Well As Hold Downs And Post Caps Etc...

SCOPE OF WORK:

PROVIDE 2 STORY ADDITION AND RENOVATION TO EXISTING ONE AND HALF STORY STRUCTURE. MORK TO INCLUDE NEW INGROUND POOL UNDER SEPARATE PERMIT. PROVIDE FOR NEW DRIVEWAY, DECK AND GAZEBO. REMOVE EXISTING TREES UNDER SEPARATE PERMIT.

SEPARATE APPLICATIONS

- PLUMBING PERMIT
- ELECTRICAL PERMIT
- TREE REMOVAL
- SEPTIC DESIGN

Ground Subject To Damage From: | Winter | Ice Shield Mind Design Snow Design Underlayment Flood Load Special Wind Born Design Required Temp. Meathering Depth Speed Topographic region Debris (psf) Category Index zone winds 15*00* 36119C03 or 30 | 115 Mph No No Yes 3'-6" to Heavy less 2007

Hazards Freezing Annual Temp 52.2º F

7.19.2 7.09.2 Coord. 6.17.2 6 | Client/PB 6.7.21 5 Client 6.2.21 4 | Planning Bd 5.21.2 3 : Planning Bd 5.10.2 2 Planning Bd 4.14.2 Planning Bd 3.10.2 REV. DATE OWNER:

CHRISTOPHER KALIAN

MR. & MRS.




955 CENTRAL PARK AVENUI

YONKERS, NEW YORK

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FAX: 914 668 1831



KEY PLAN

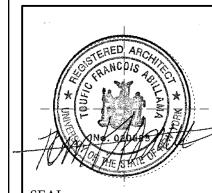PROPOSED ONE FAMILY **DWELLING EXPANSION**

SBL: 101.01/1/13 ZONE: R-1A COVER

99 BYRAM RIDGE RD., ARMONK, N.Y

SHEET/MAP /NOTES

Project ID / DATE : 2048/ 10.15.2020

Drawn By: KM Checked By: TFA JULY 19.2021



The Christophor Kalian Residence



9	ARB	7.19.21
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5	Client	6.2.21
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3	Planning Bd	5 .1 <i>0</i> .21
2	Planning Bd	4.14.21
1	Planning Bd	3.10.21
NO.	REV.	DATE


OWNER:

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SBL: 101.01/1/13 ZONE: R-1A


3D RENDERINGS

Project ID / DATE : 2048/ 10.15.2020

C.02

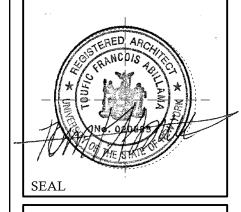

97 BYRAM RIDGE ROAD

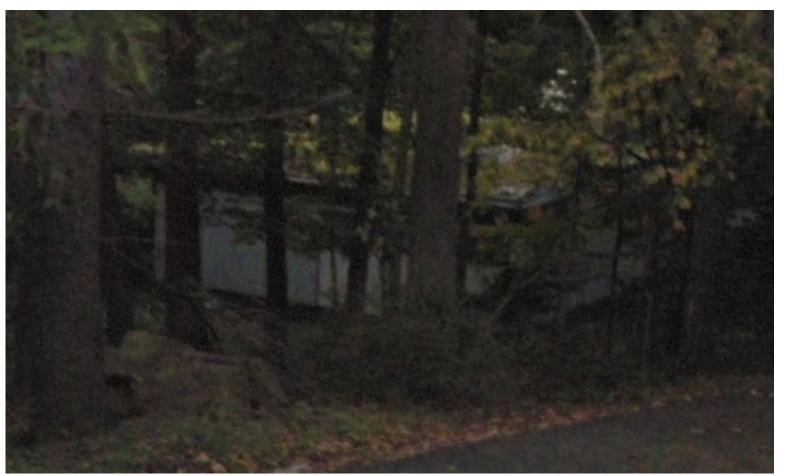


99 BYRAM RIDGE ROAD




99 BYRAM RIDGE ROAD - ADJOINING PROPERTIES



101 BYRAM RIDGE ROAD

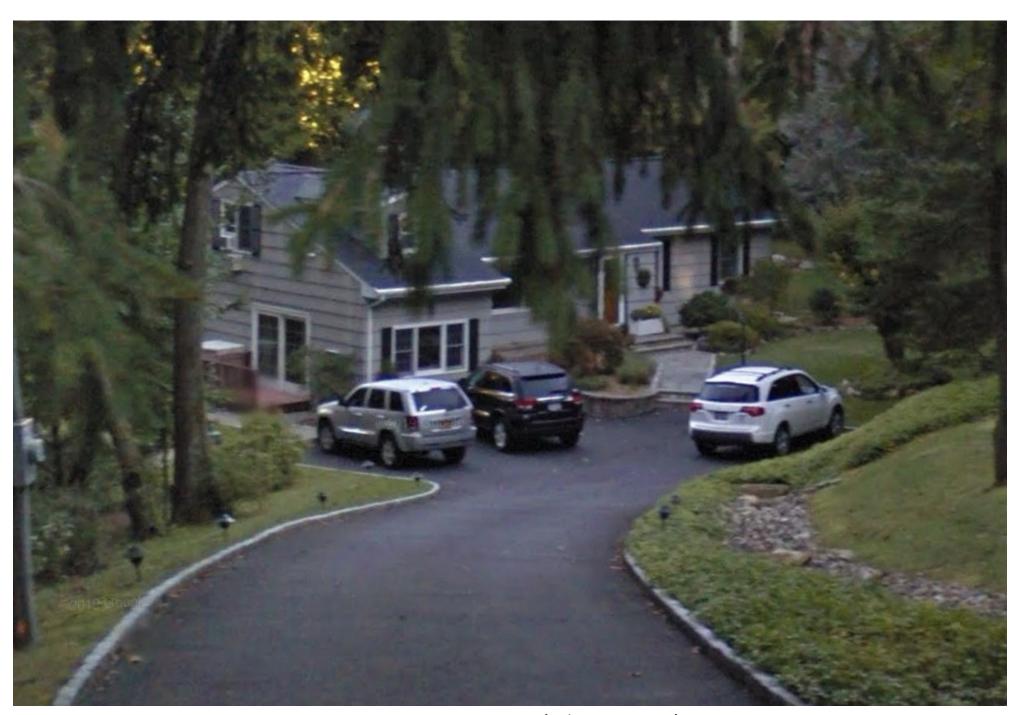

101 BYRAM RIDGE ROAD (close up)

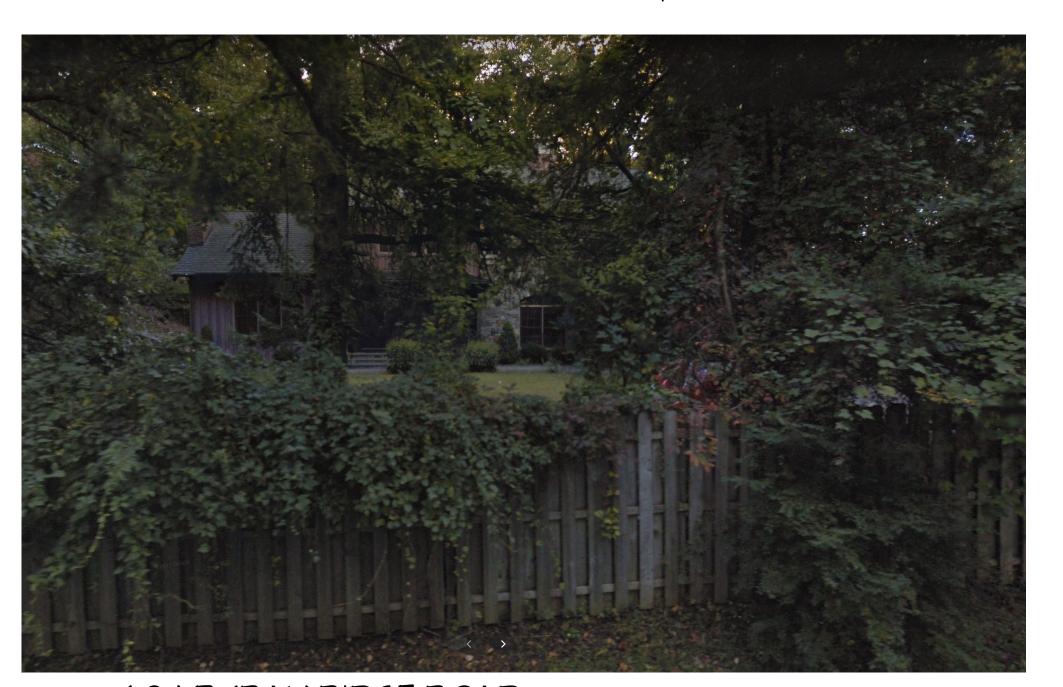

104 BYRAM RIDGE ROAD

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9	ARB	7.19.21
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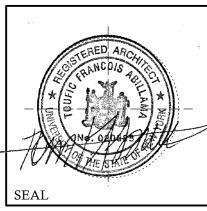
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AERIAL VIEW \$

STREETSCAPE

SBL: 101.01/1/13 ZONE: R-1A

Project ID / DATE : 2048/ 10.15.2020
Sheet Scale:



7.19.2 7.09.2 6 Client/PB 6.7.21 5 Client 4 Planning Bd 5.21.2 3 Planning Bd 5.10.2 2 Planning Bd 4.14.2 Planning Bd 3.10.21

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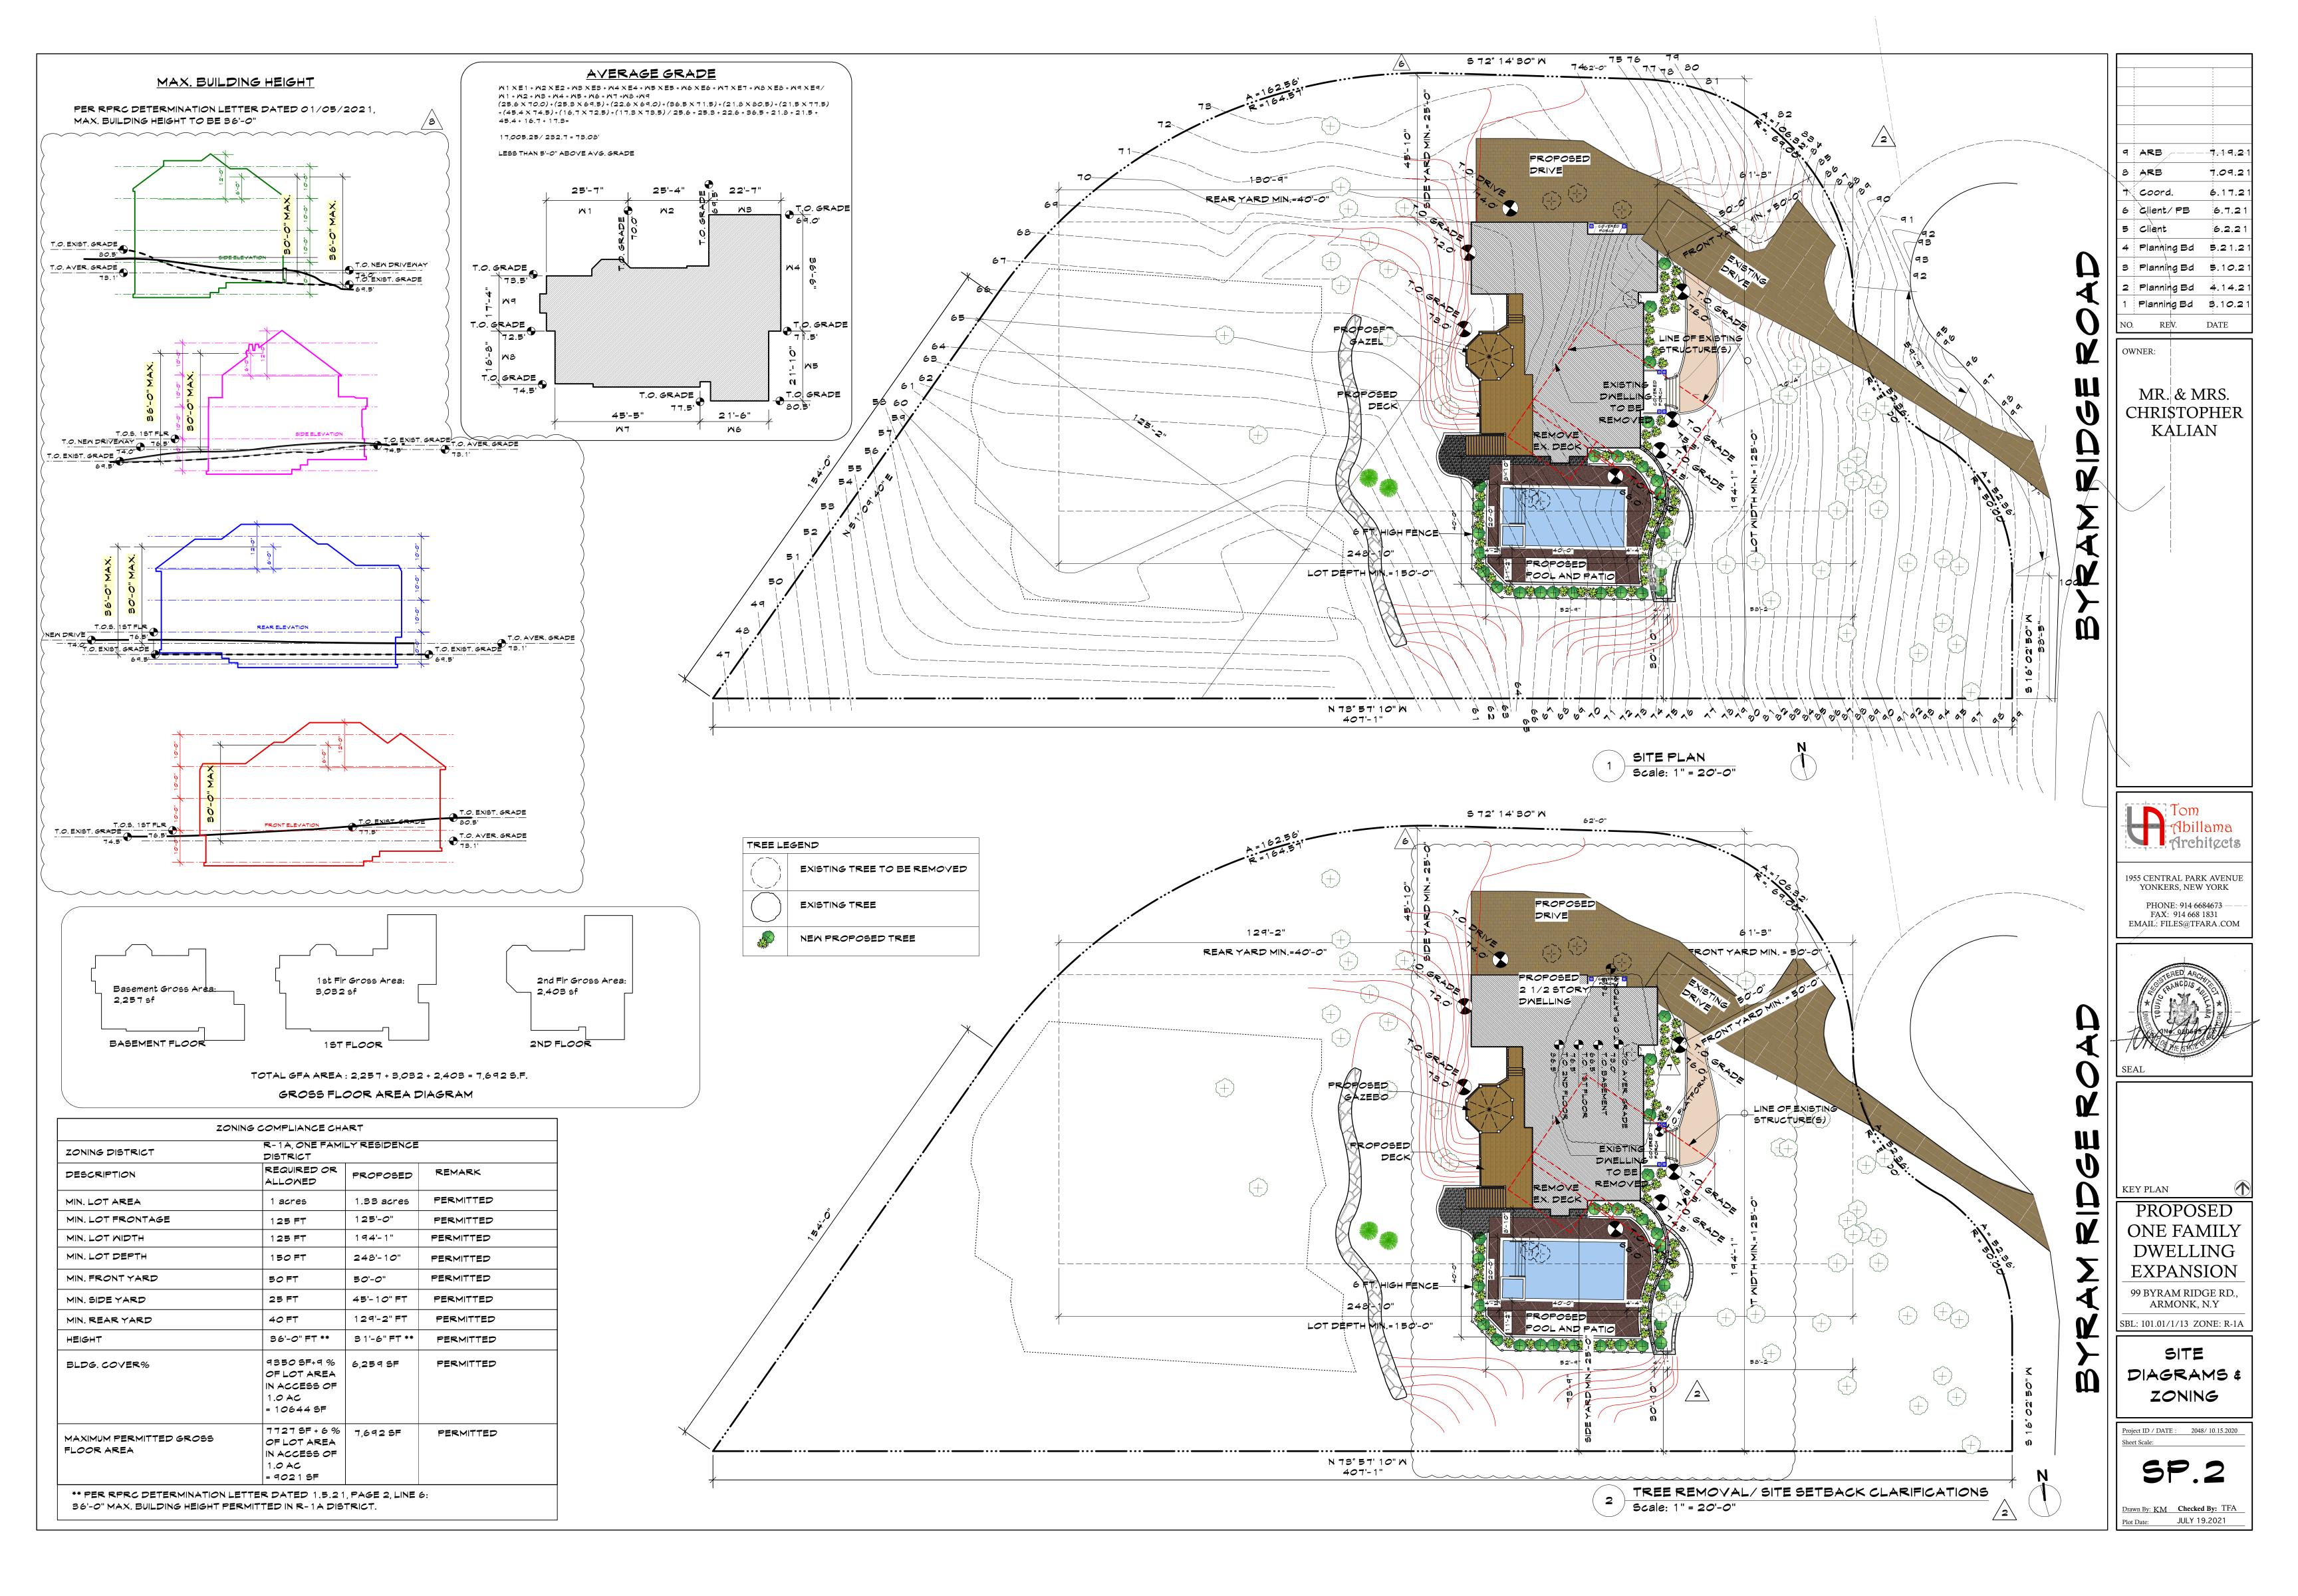



PROPOSED ONE FAMILY **DWELLING EXPANSION** 99 BYRAM RIDGE RD., ARMONK, N.Y


SITE PLAN

Project ID / DATE : 2048/ 10.15.2020
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9 ARB 7.19.21
8 ARB 7.09.21
7 Coord. 6.17.21
6 Client/PB 6.7.21
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4 Planning Bd 5.21.21
3 Planning Bd 5.10.21
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1 Planning Bd 3.10.21

OWNER:


NO. REV.

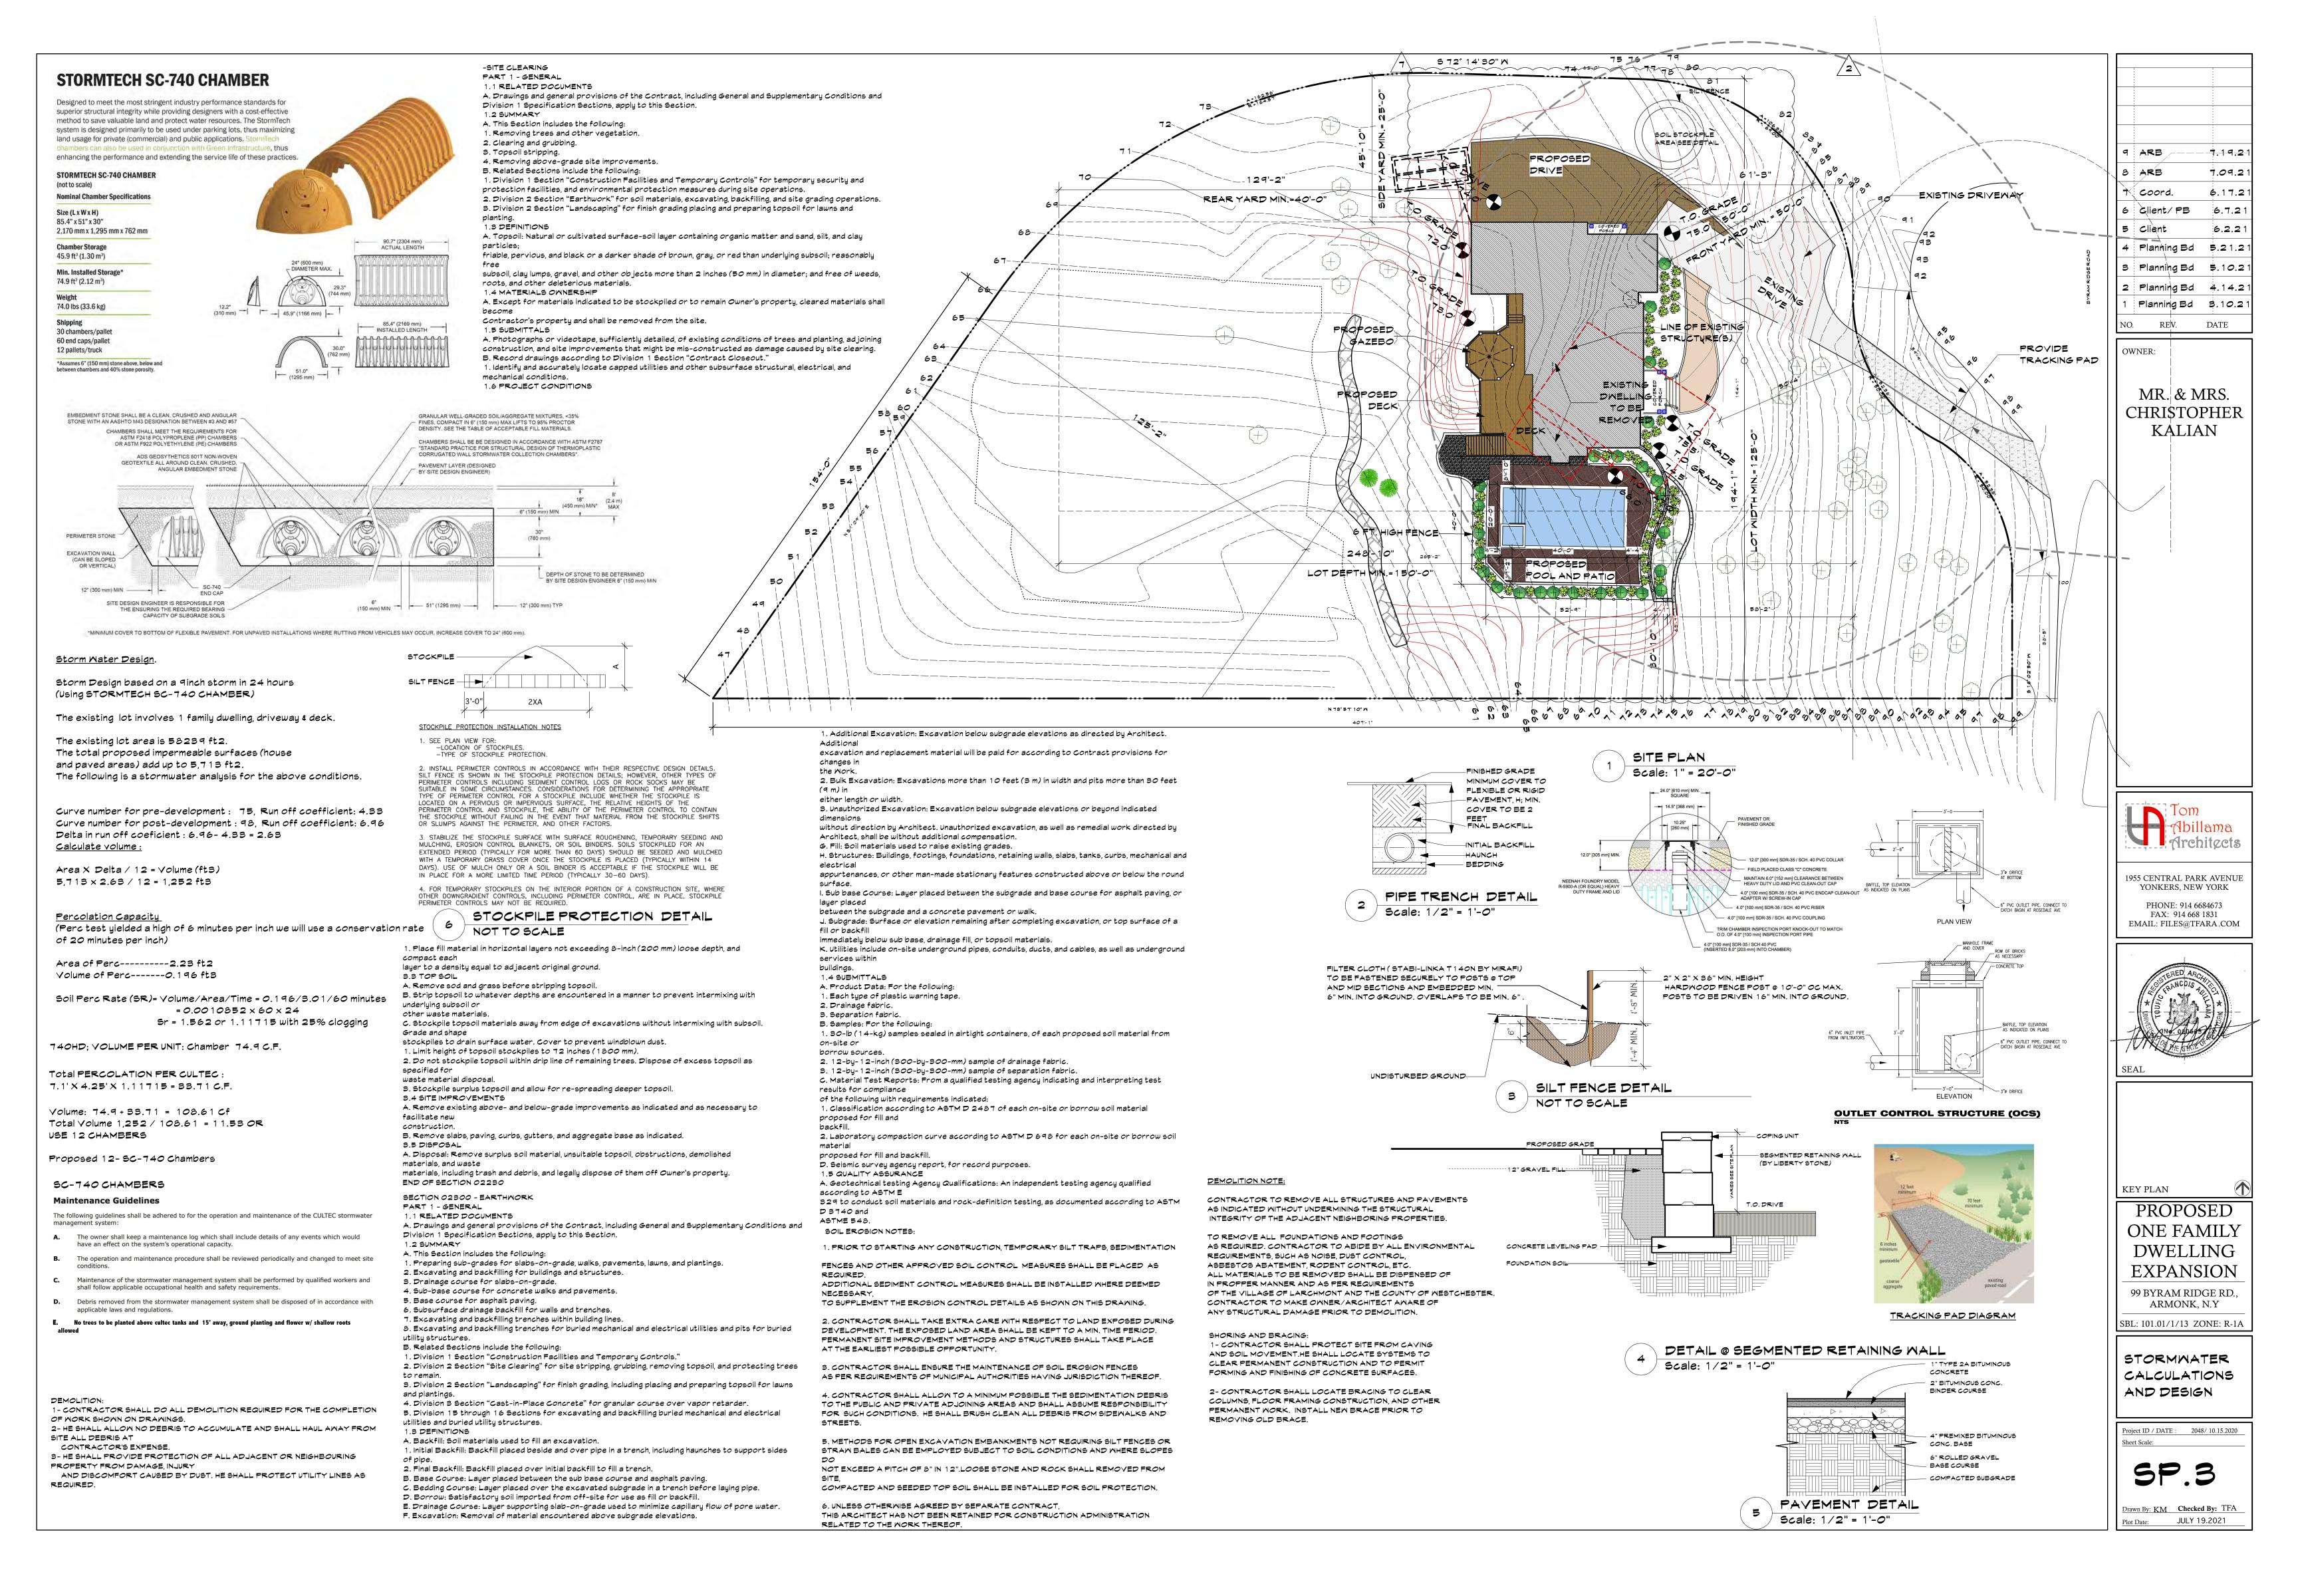MR. & MRS. CHRISTOPHER KALIAN

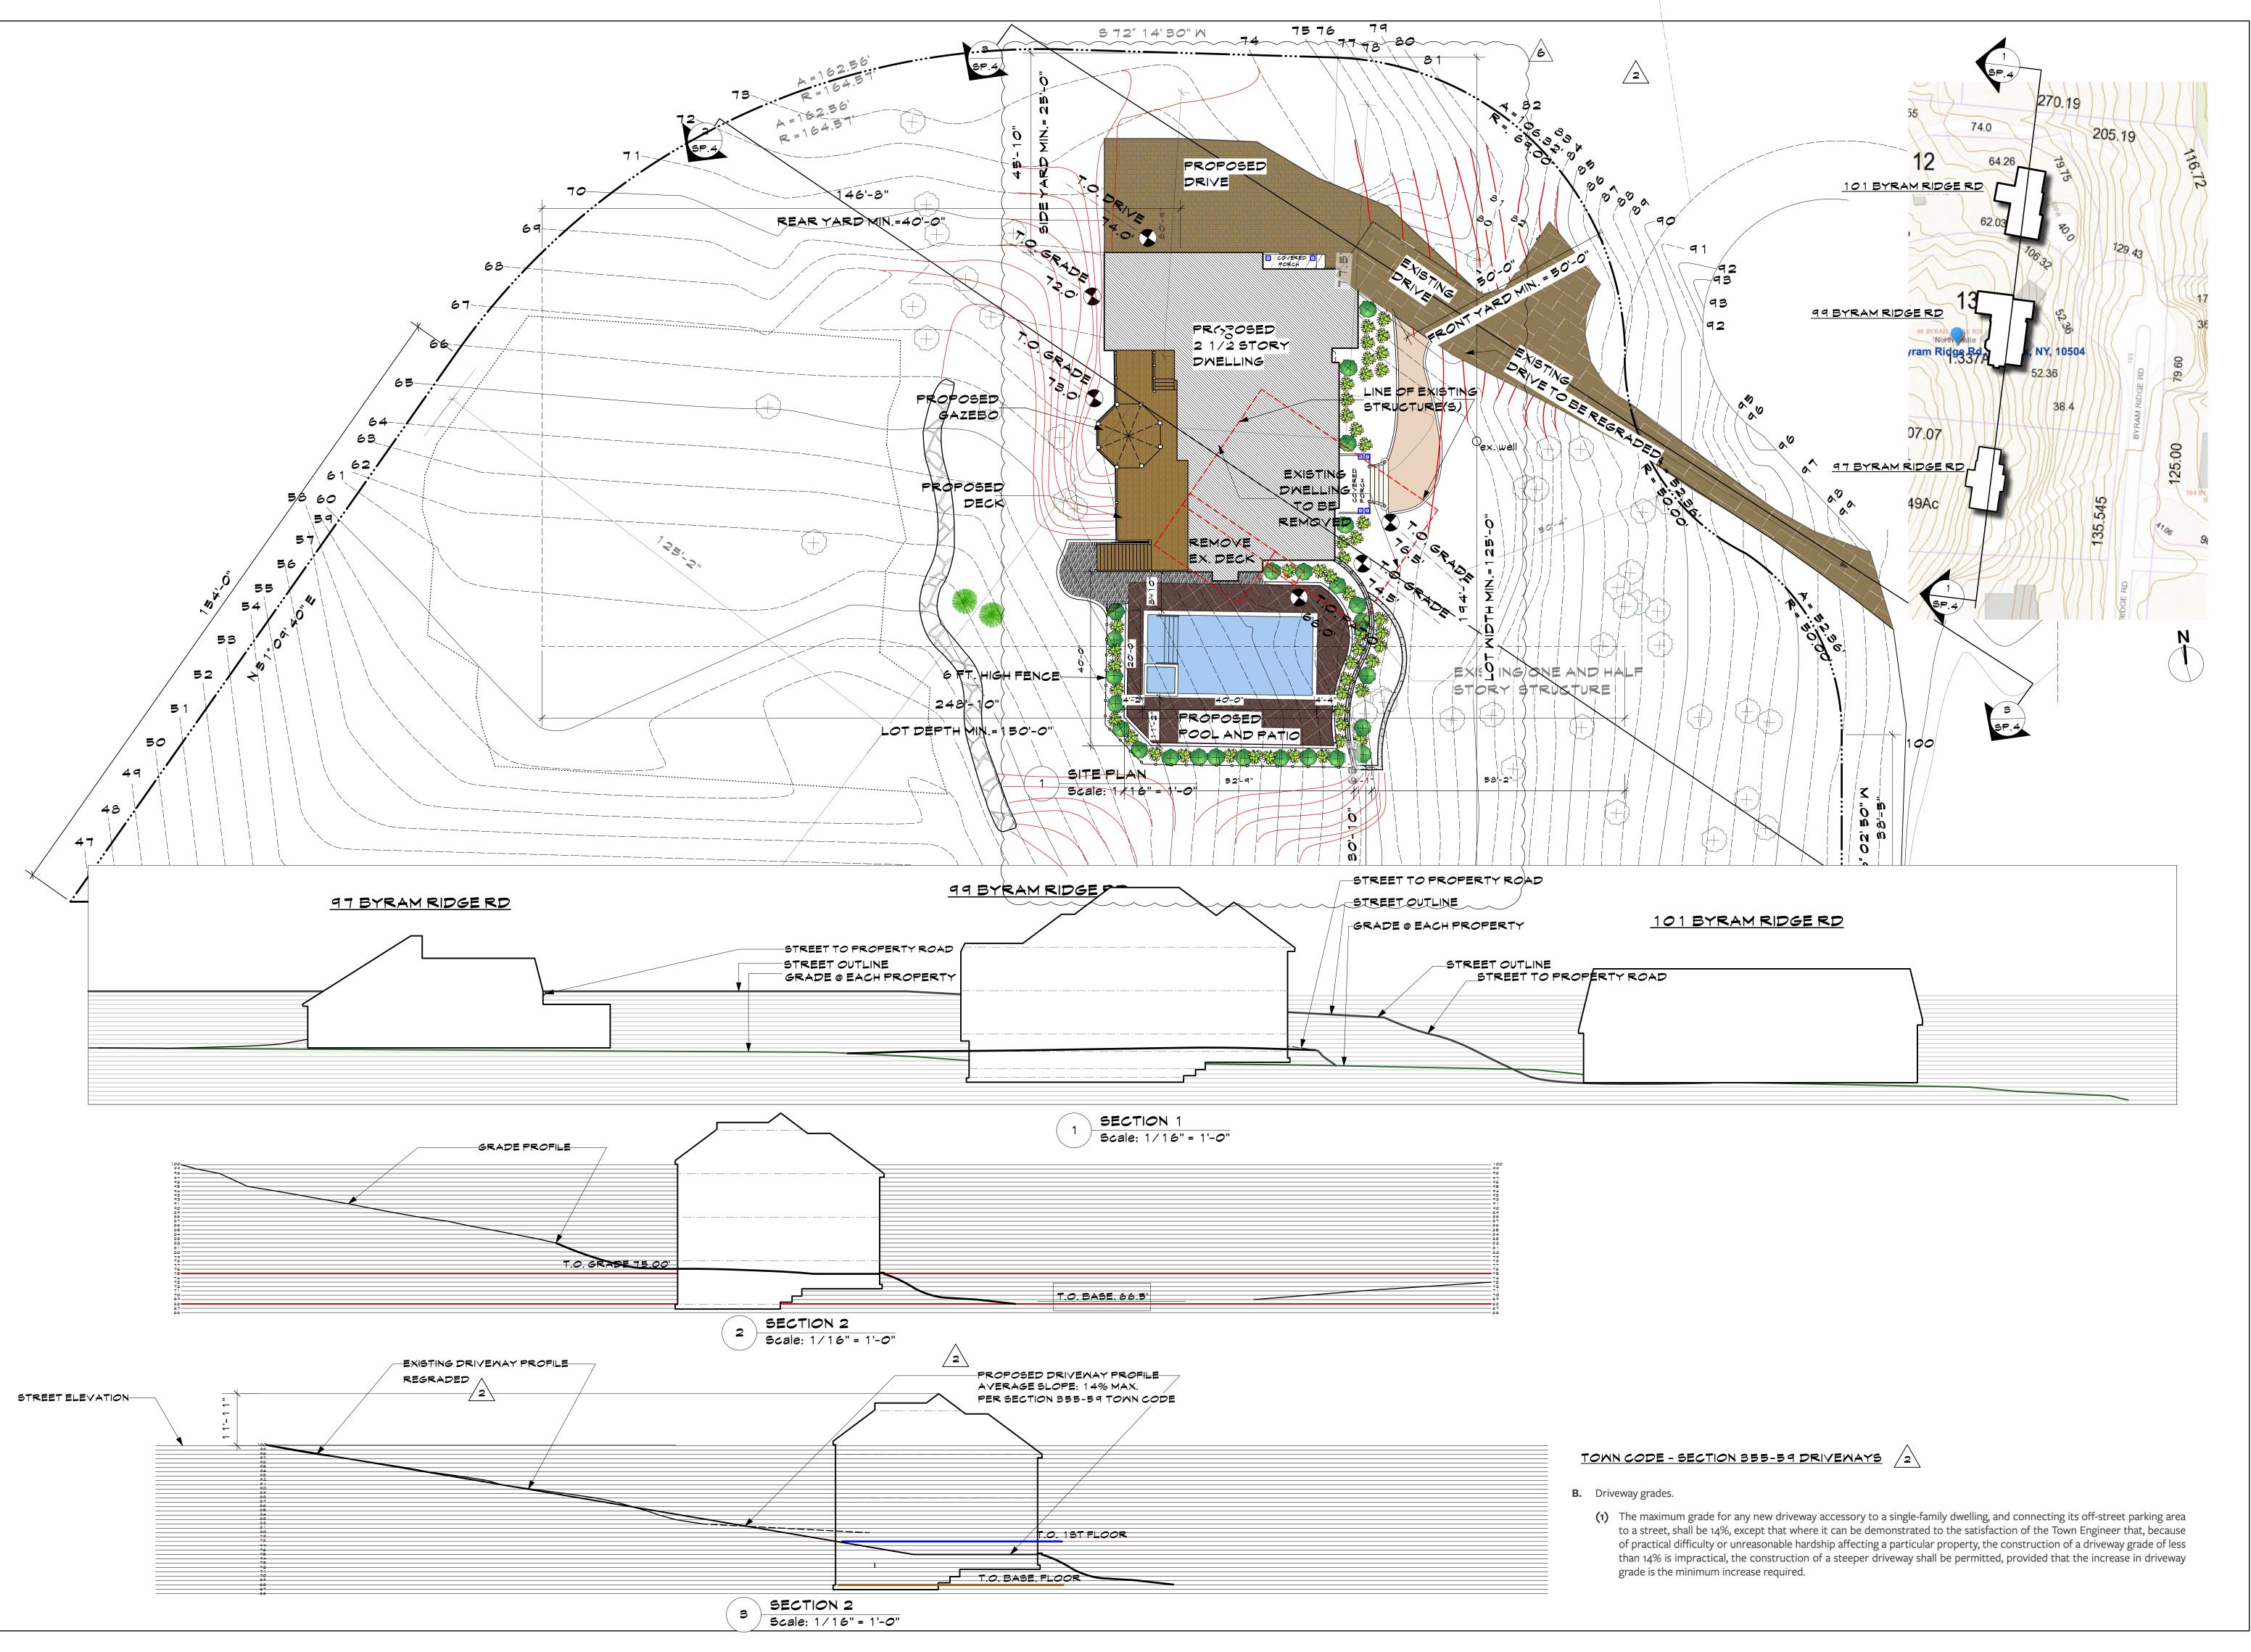Tom Abillama Architects

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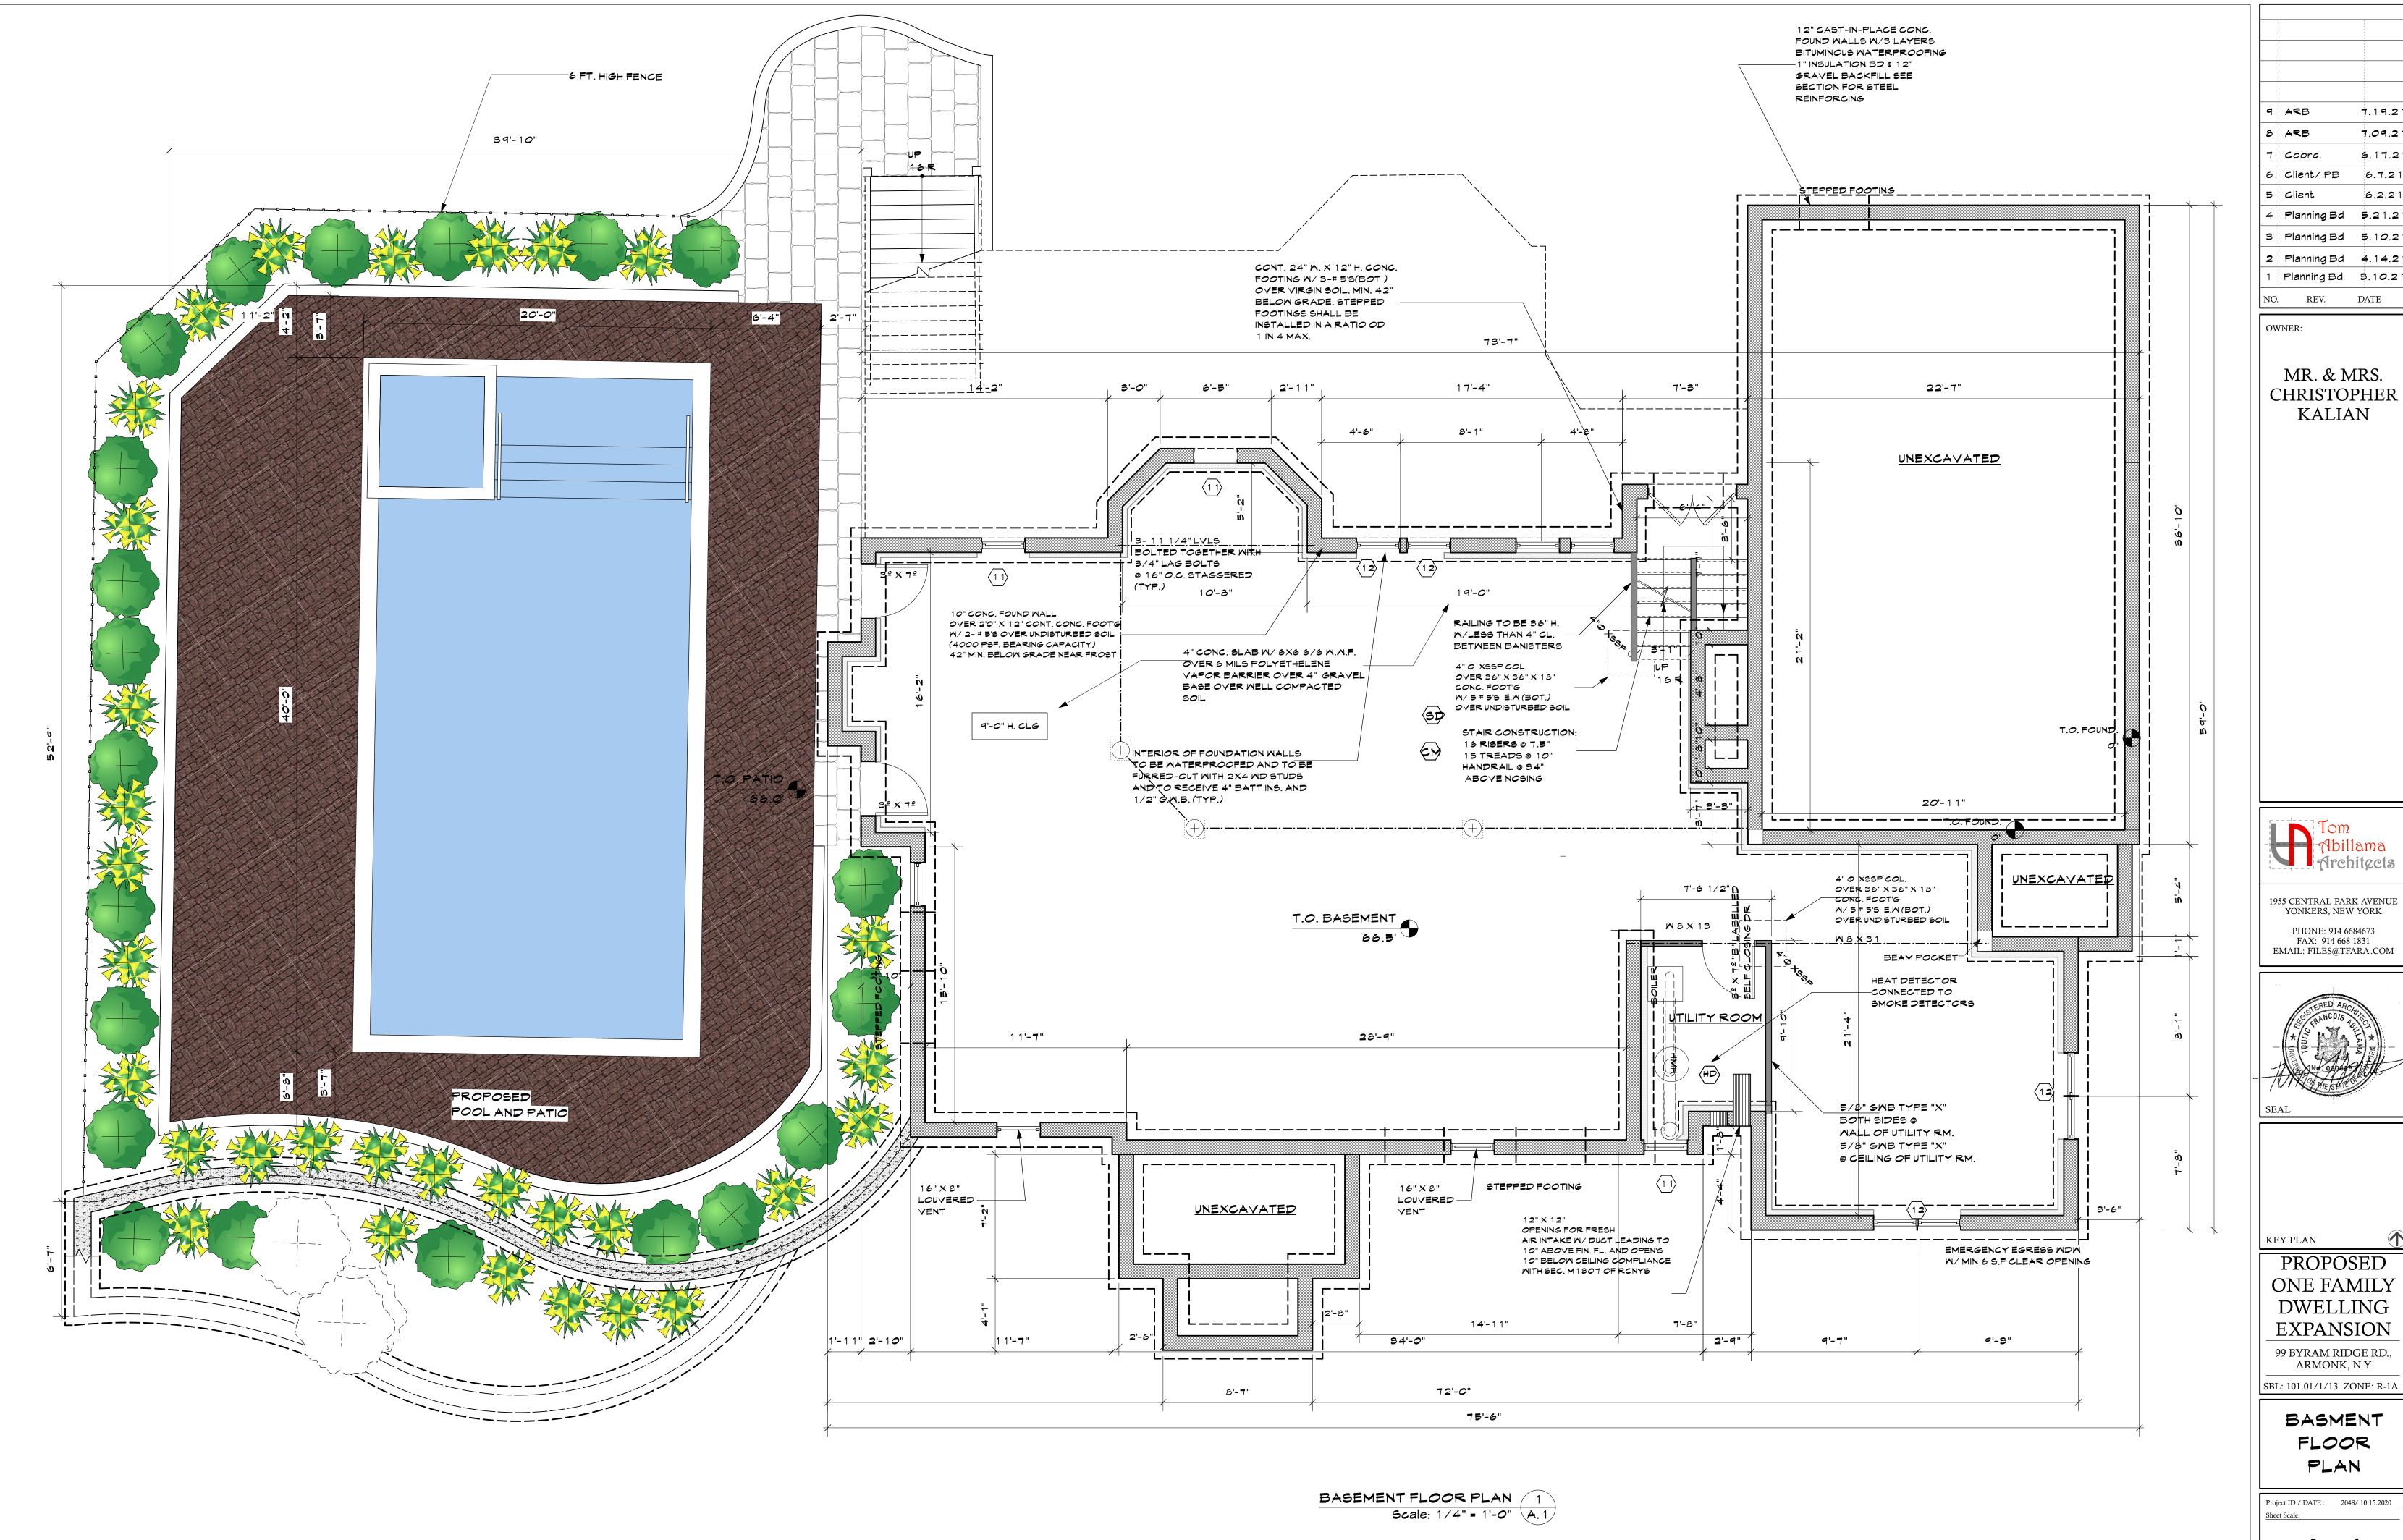
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SITE GRADING

Project ID / DATE : 2048/ 10.15.2020

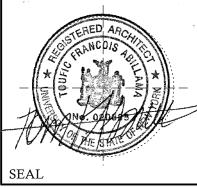Sheet Scale:

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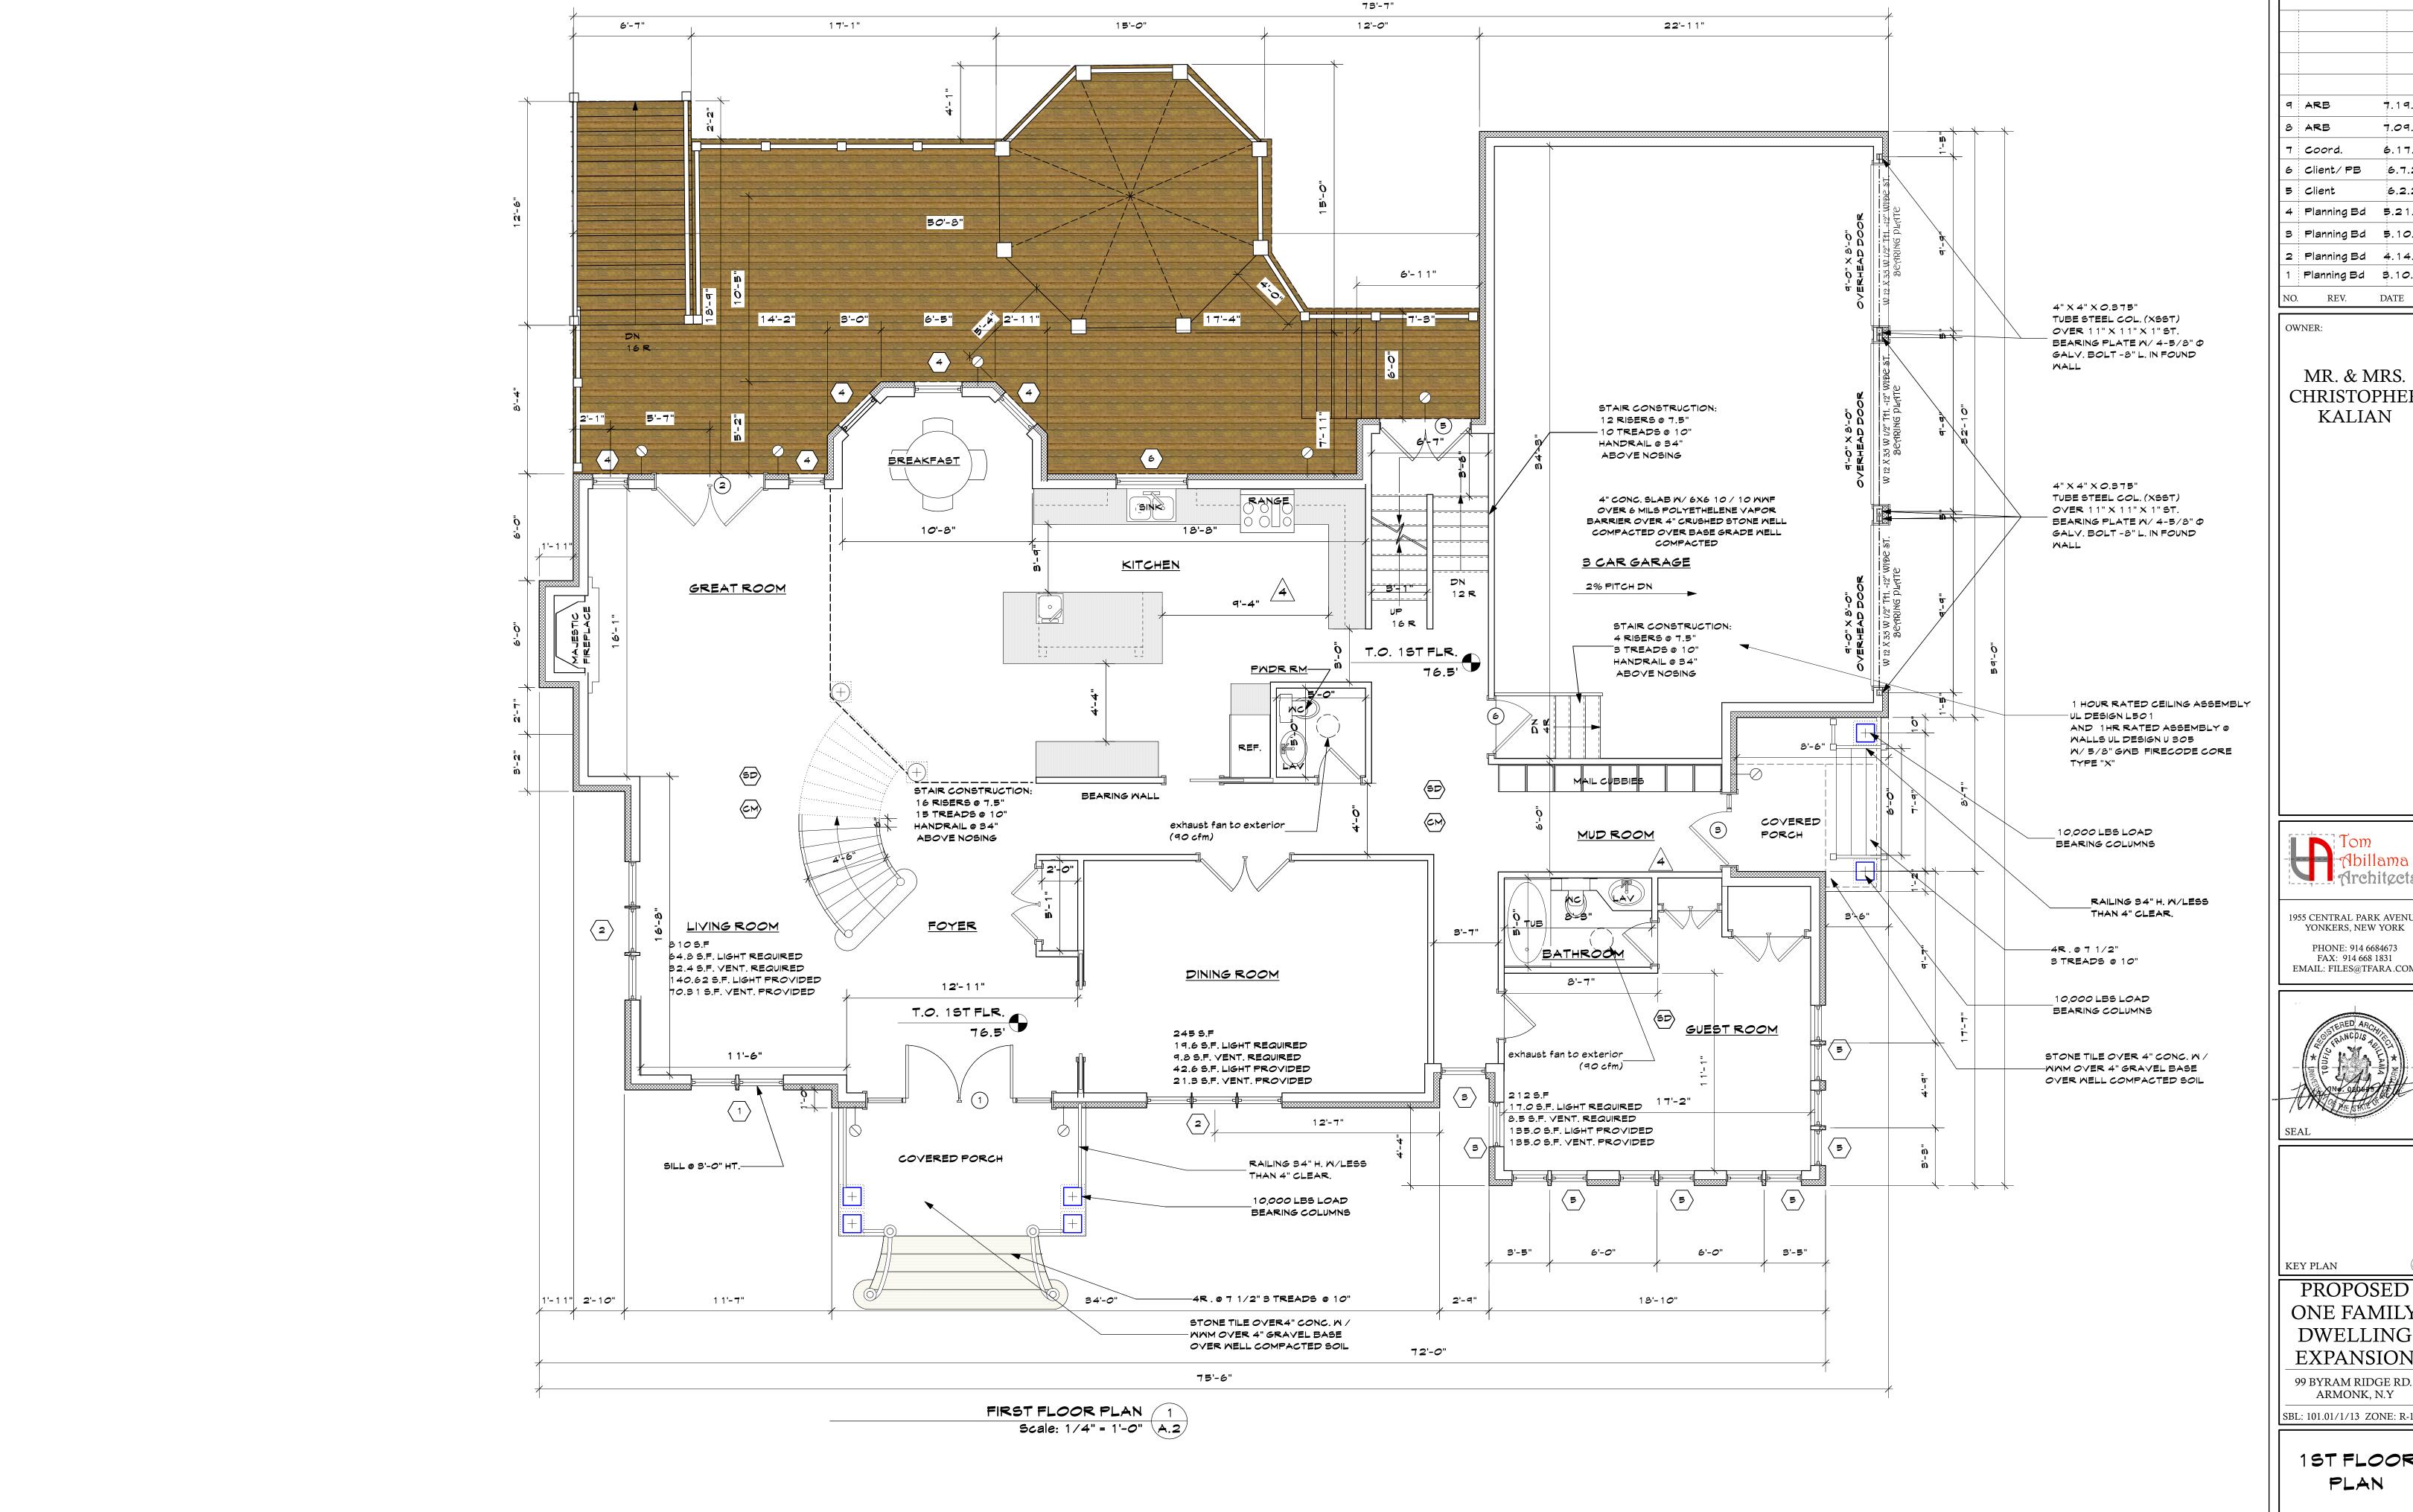


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ONE FAMILY **DWELLING EXPANSION** 99 BYRAM RIDGE RD.,

Project ID / DATE : 2048/ 10.15.2020

Drawn By: KM Checked By: TFA JULY 19.2021



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OWNER:

MR. & MRS. CHRISTOPHER KALIAN

Tom
Abillama
Architects

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KEY PLAN


PROPOSED ONE FAMILY **DWELLING EXPANSION** 99 BYRAM RIDGE RD., ARMONK, N.Y

SBL: 101.01/1/13 ZONE: R-1A

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1ST FLOOR PLAN

Project ID / DATE : 2048/ 10.15.2020

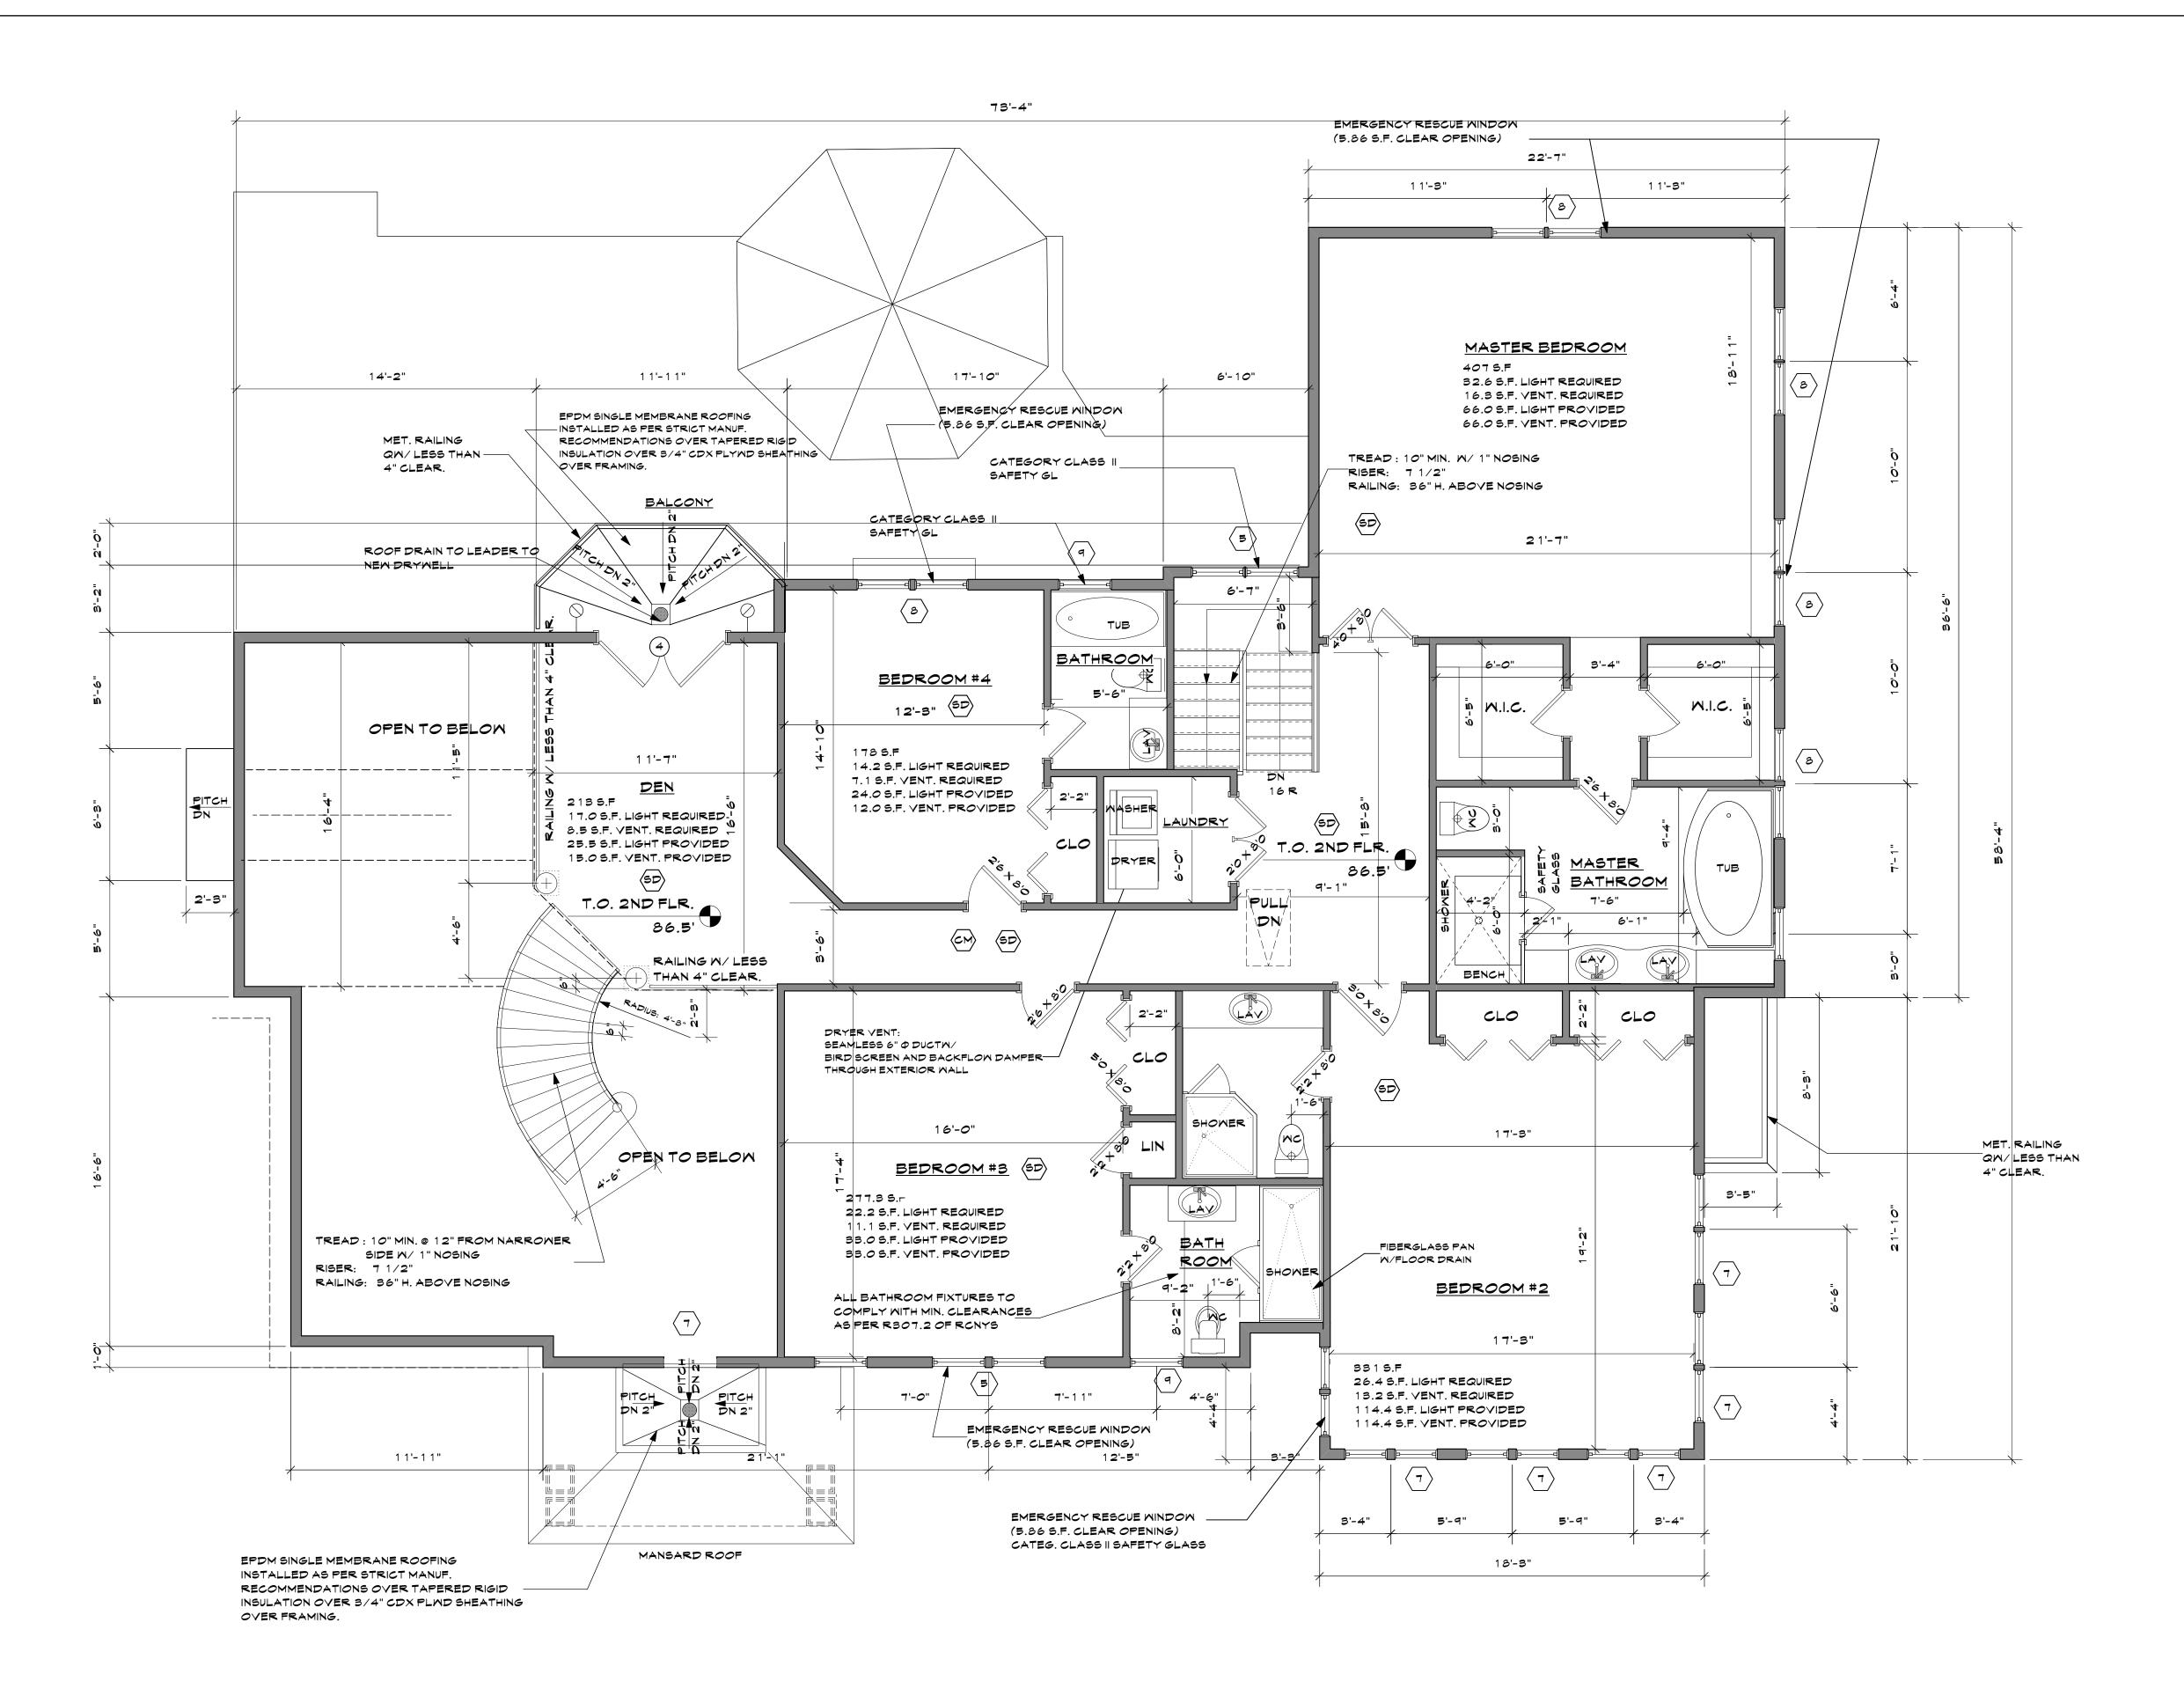

SECOND FLOOR PLAN 1

Scale: 1/4" = 1'-0" A.3

9 ARB 7.19.27
8 ARB 7.09.27
7 Coord. 6.17.27
6 Client/PB 6.7.21
5 Client 6.2.21
4 Planning Bd 5.21.27
3 Planning Bd 5.10.27
2 Planning Bd 4.14.27
1 Planning Bd 3.10.21
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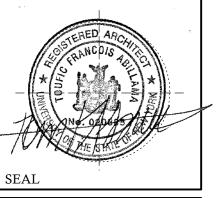
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KEY PLAN

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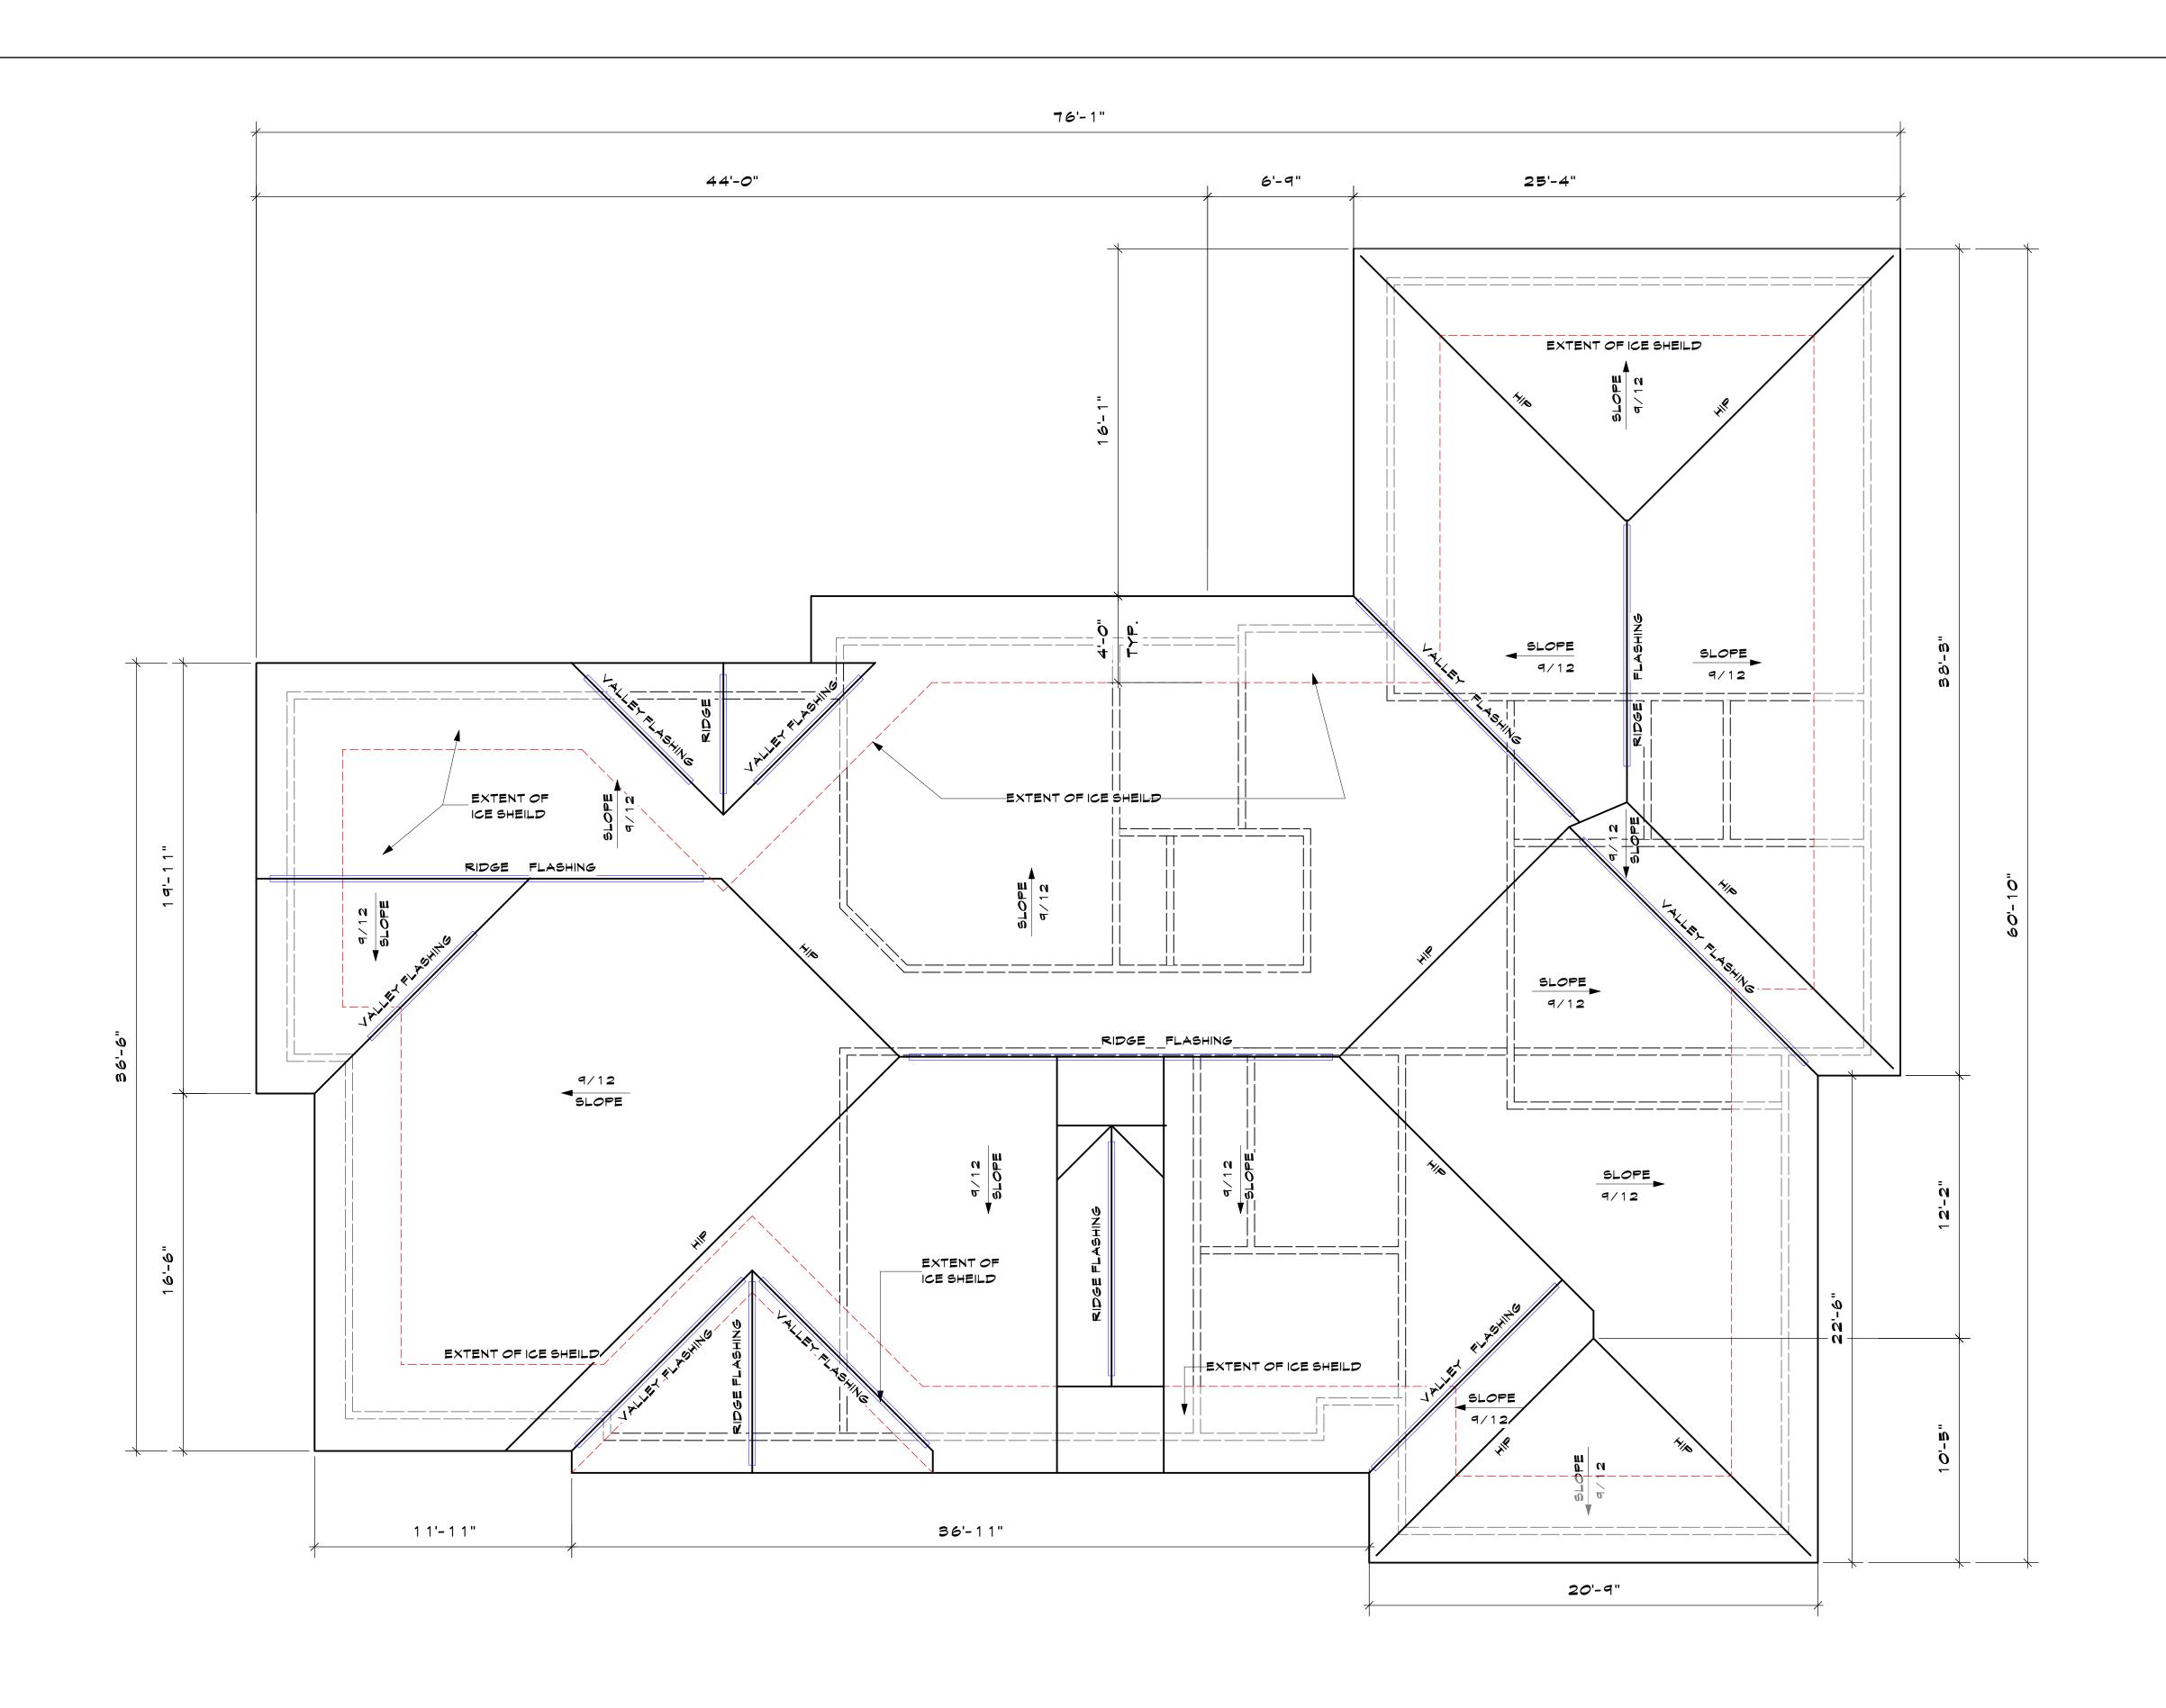
2ND FLOOR PLAN

SBL: 101.01/1/13 ZONE: R-1A

Project ID / DATE : 2048/ 10.15.2020

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KEY PLAN

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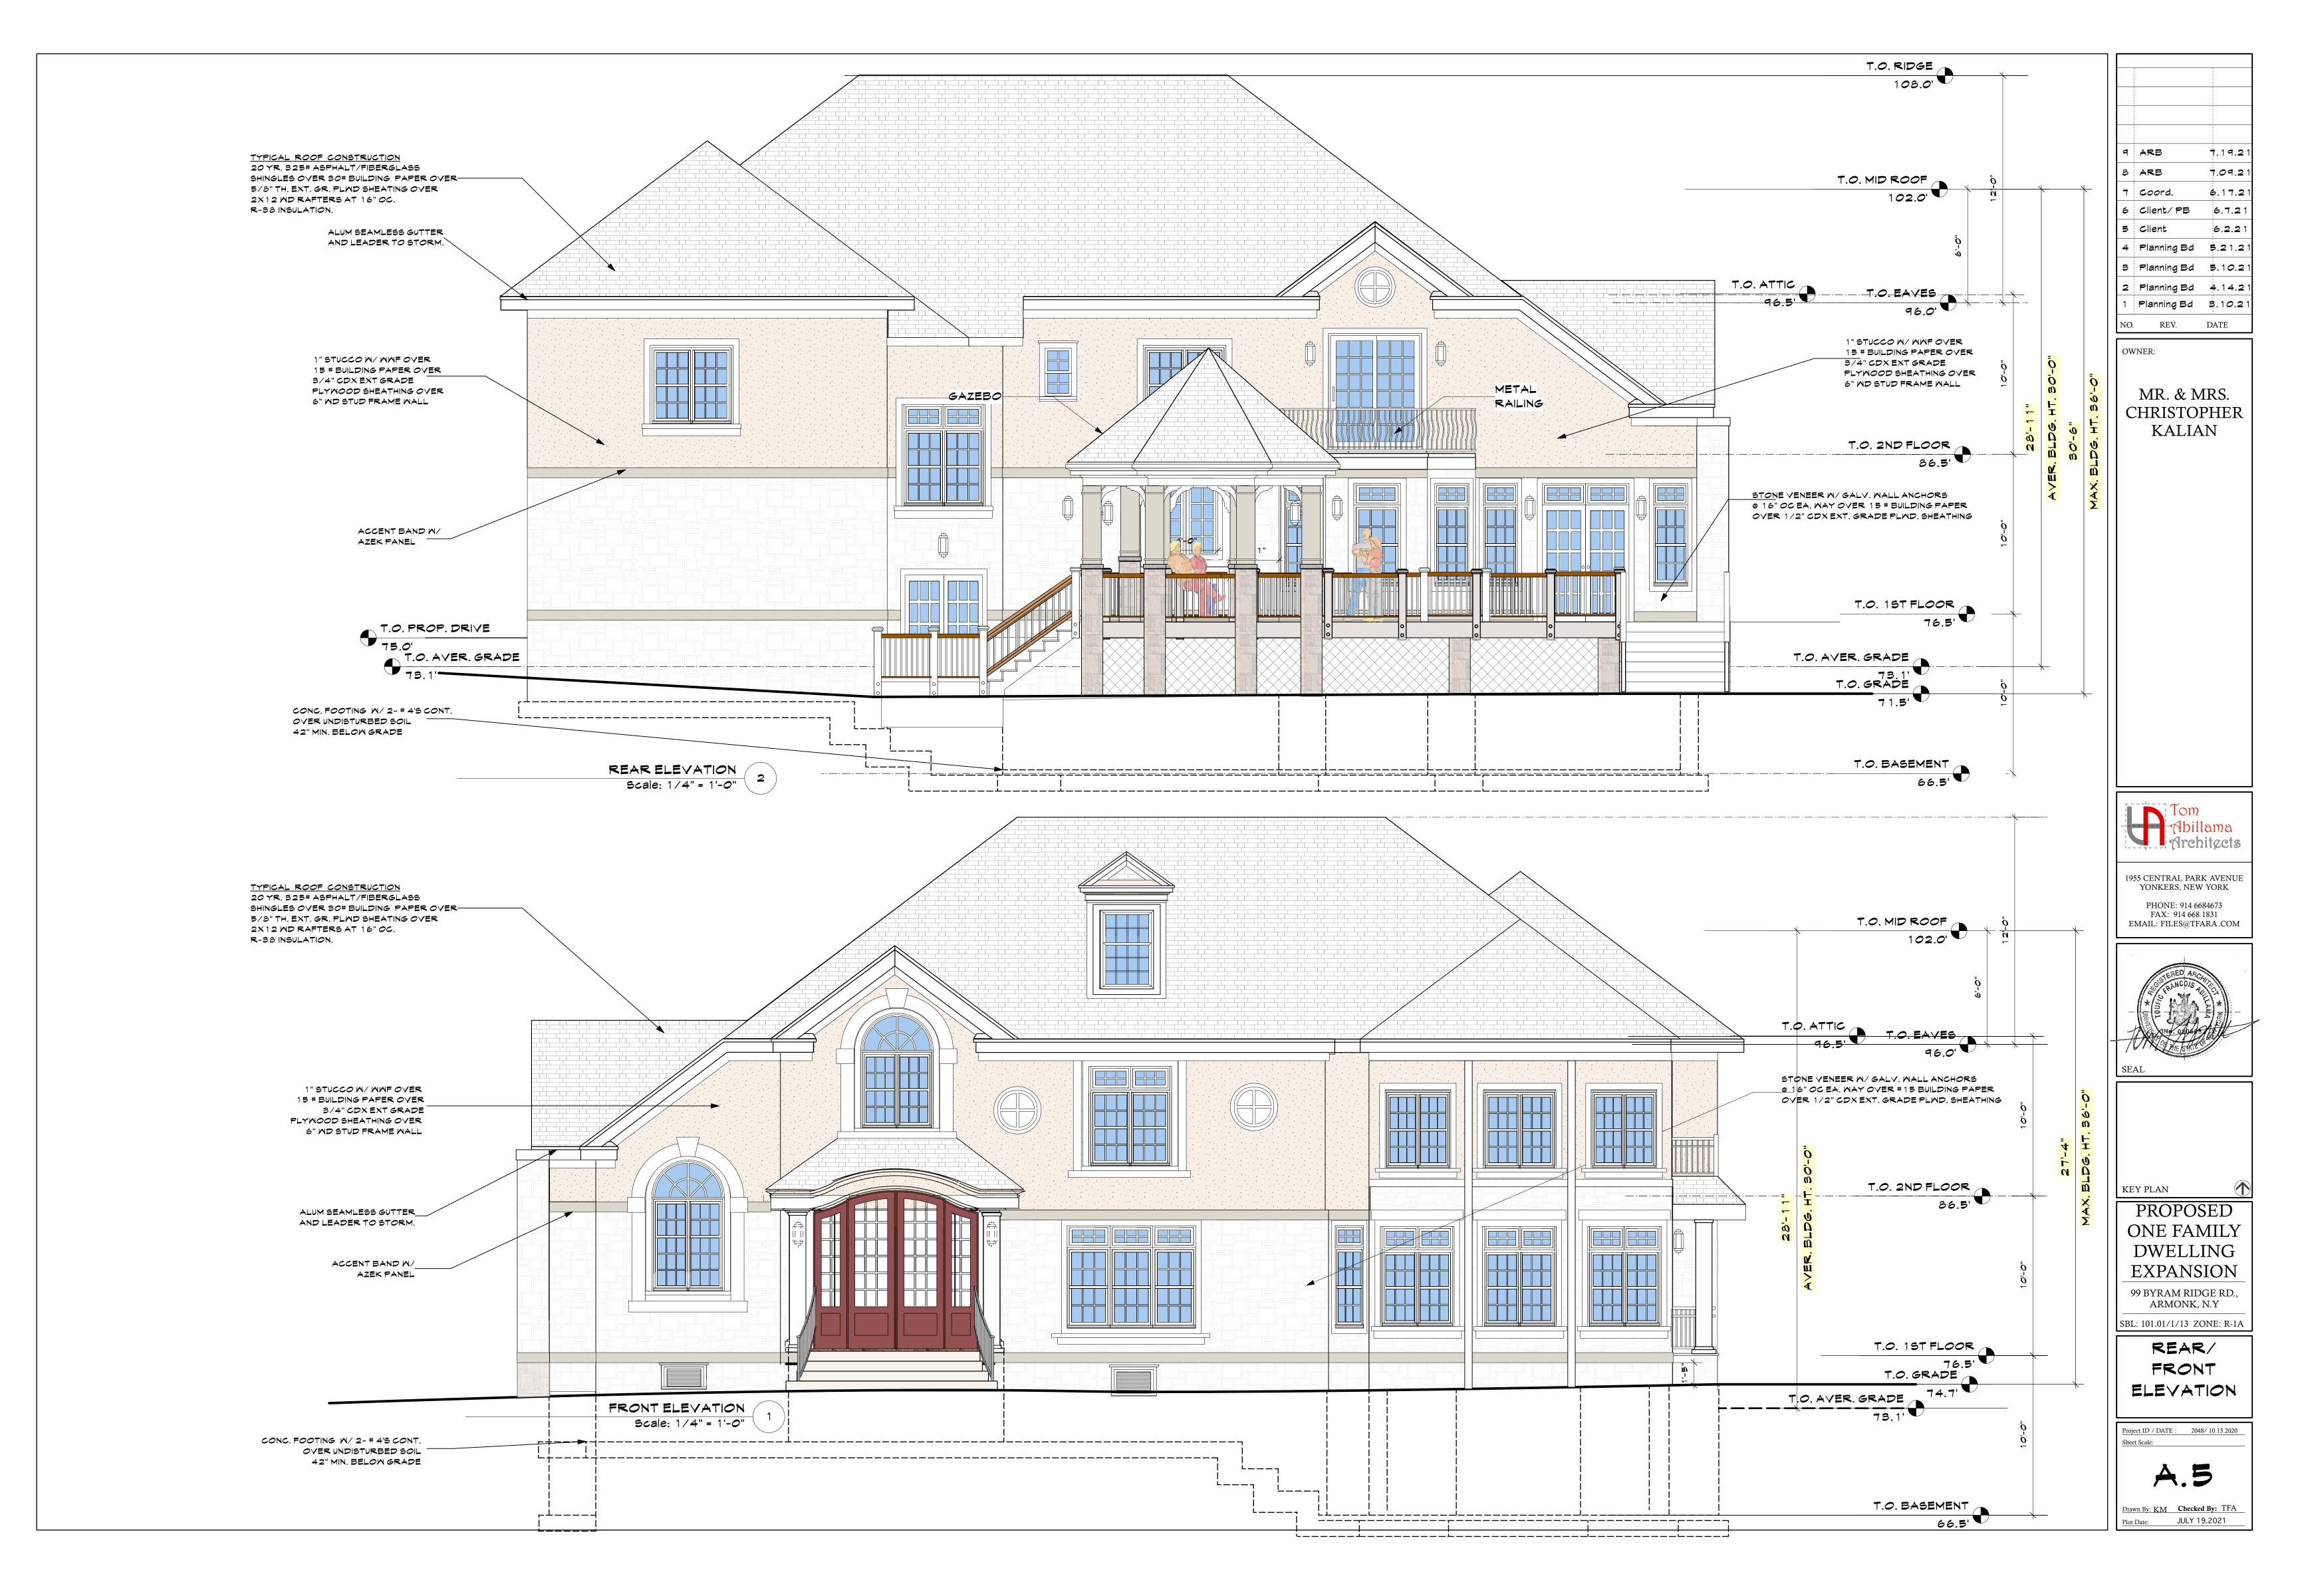
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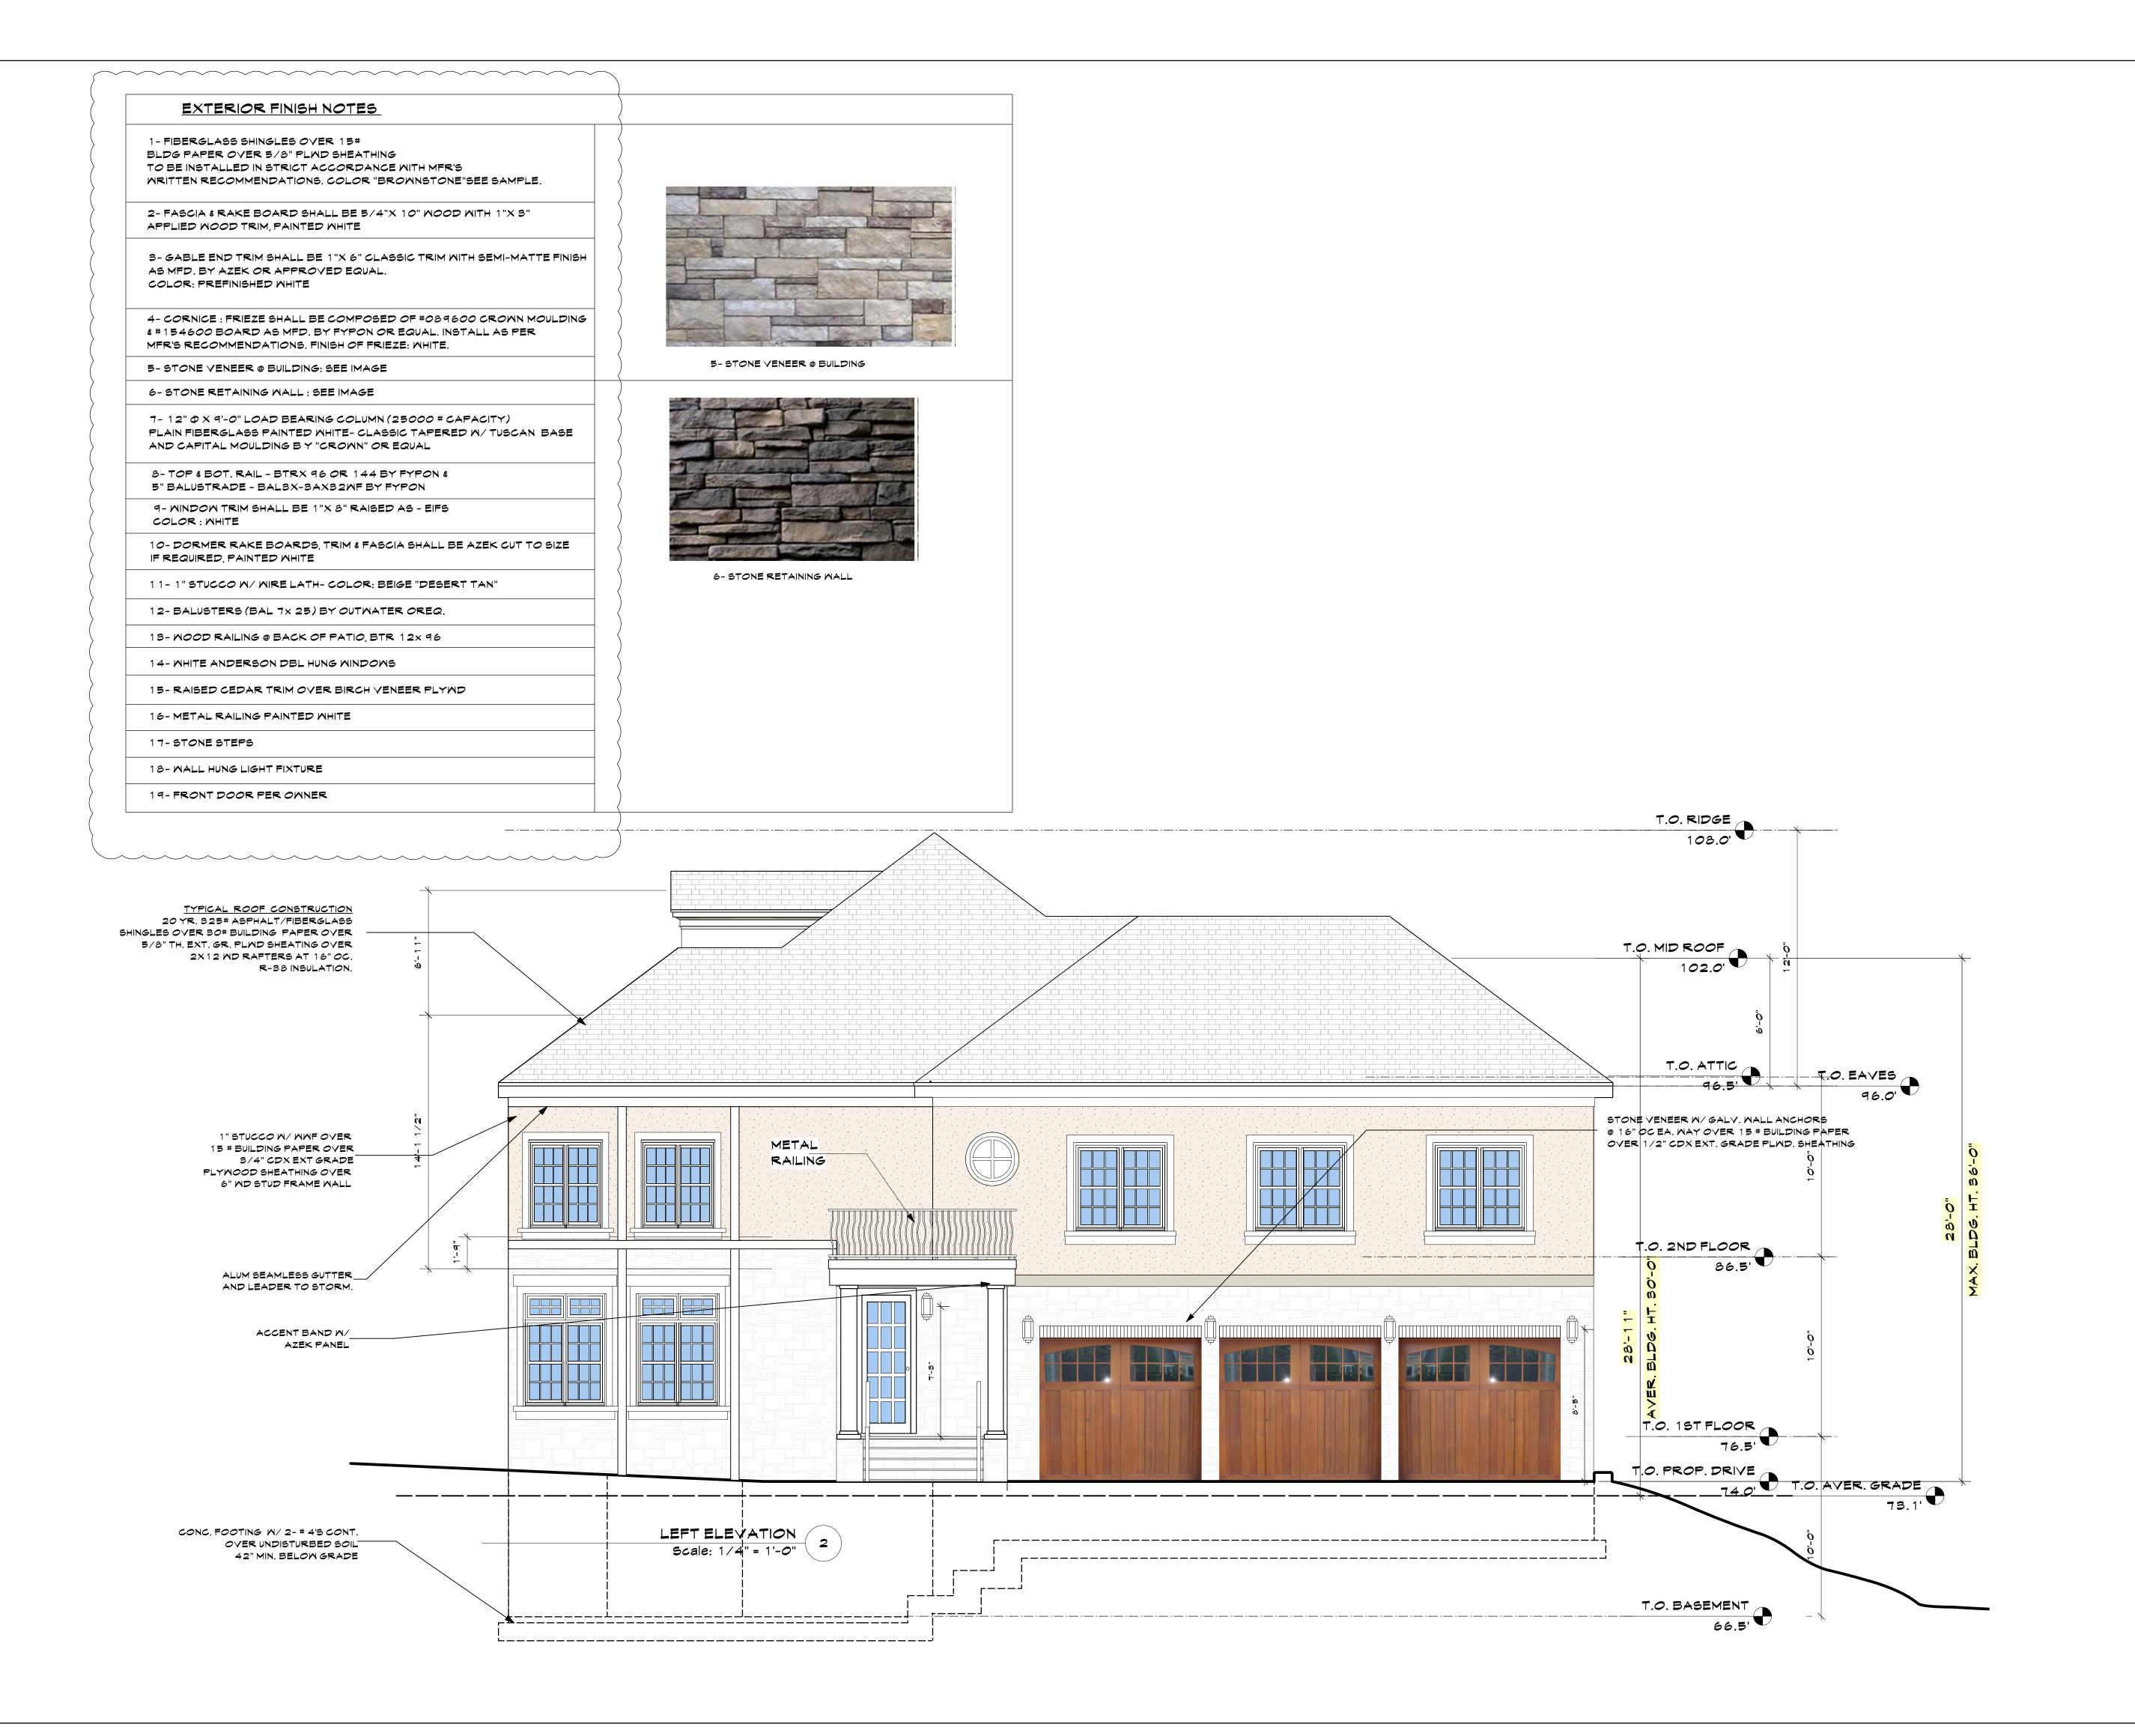
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ROOF PLAN

Project ID / DATE : 2048/ 10.15.2020

A 4





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OWNER:

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Tom
Abillama
Architects

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KEY PLAN

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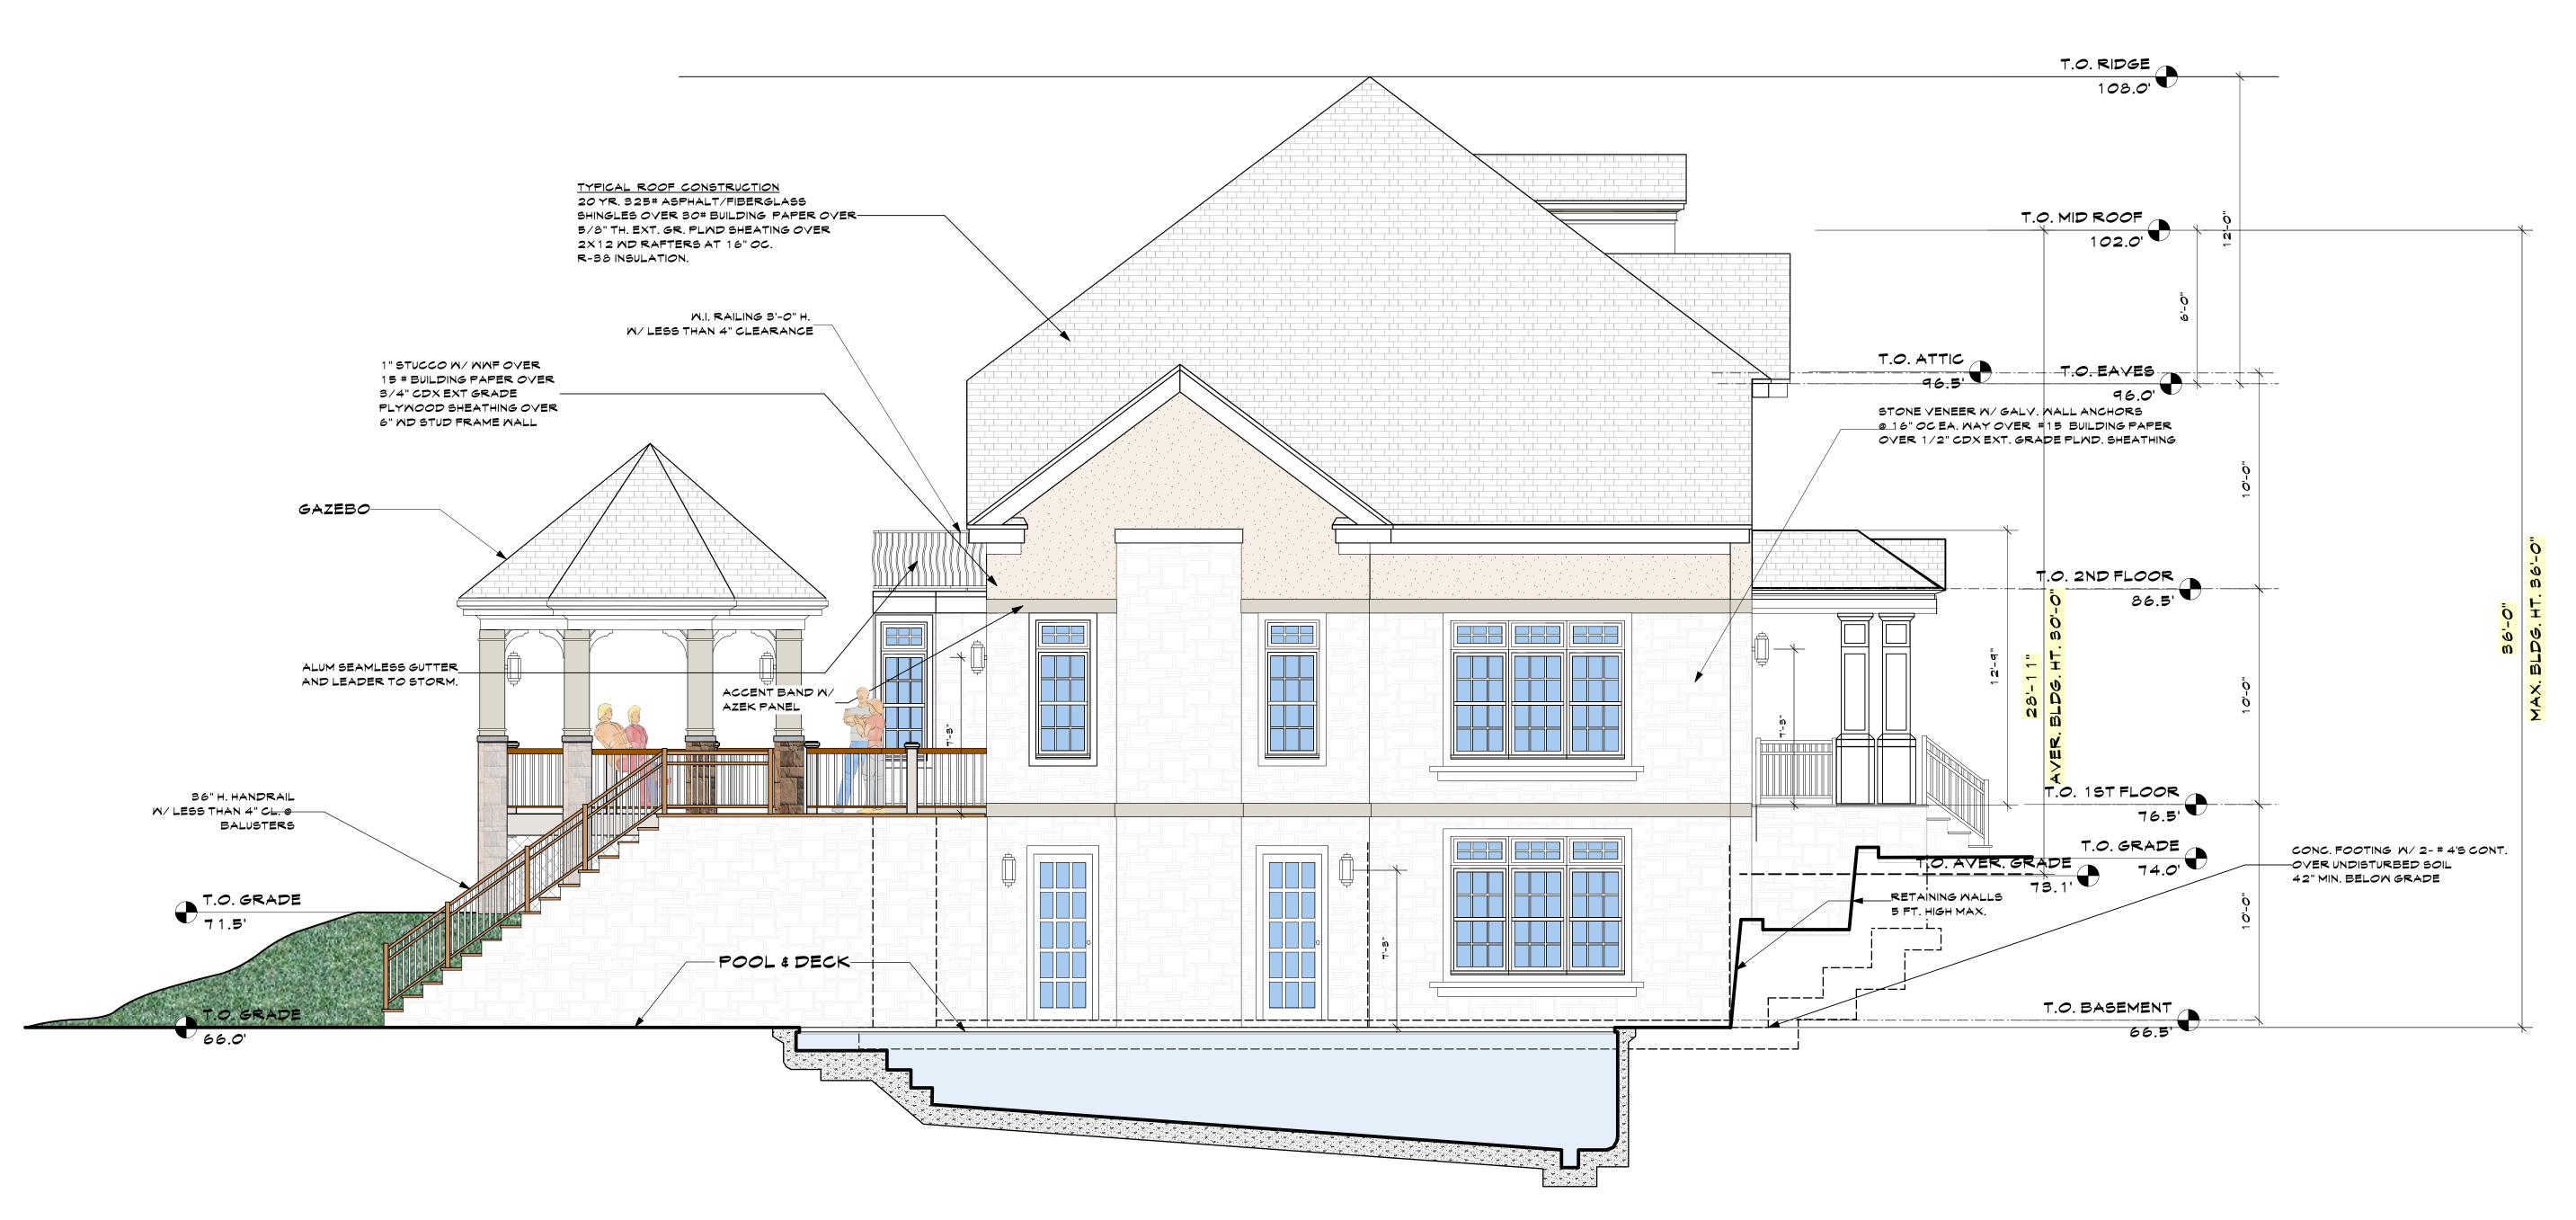
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SBL: 101.01/1/13 ZONE: R-1A

RIGHT SIDE ELEVATION

Project ID / DATE : 2048/ 10.15.2020

A.E



RIGHT SIDE ELEVATION
Scale: 1/4" = 1'-0"

9 ARB 7.19.21
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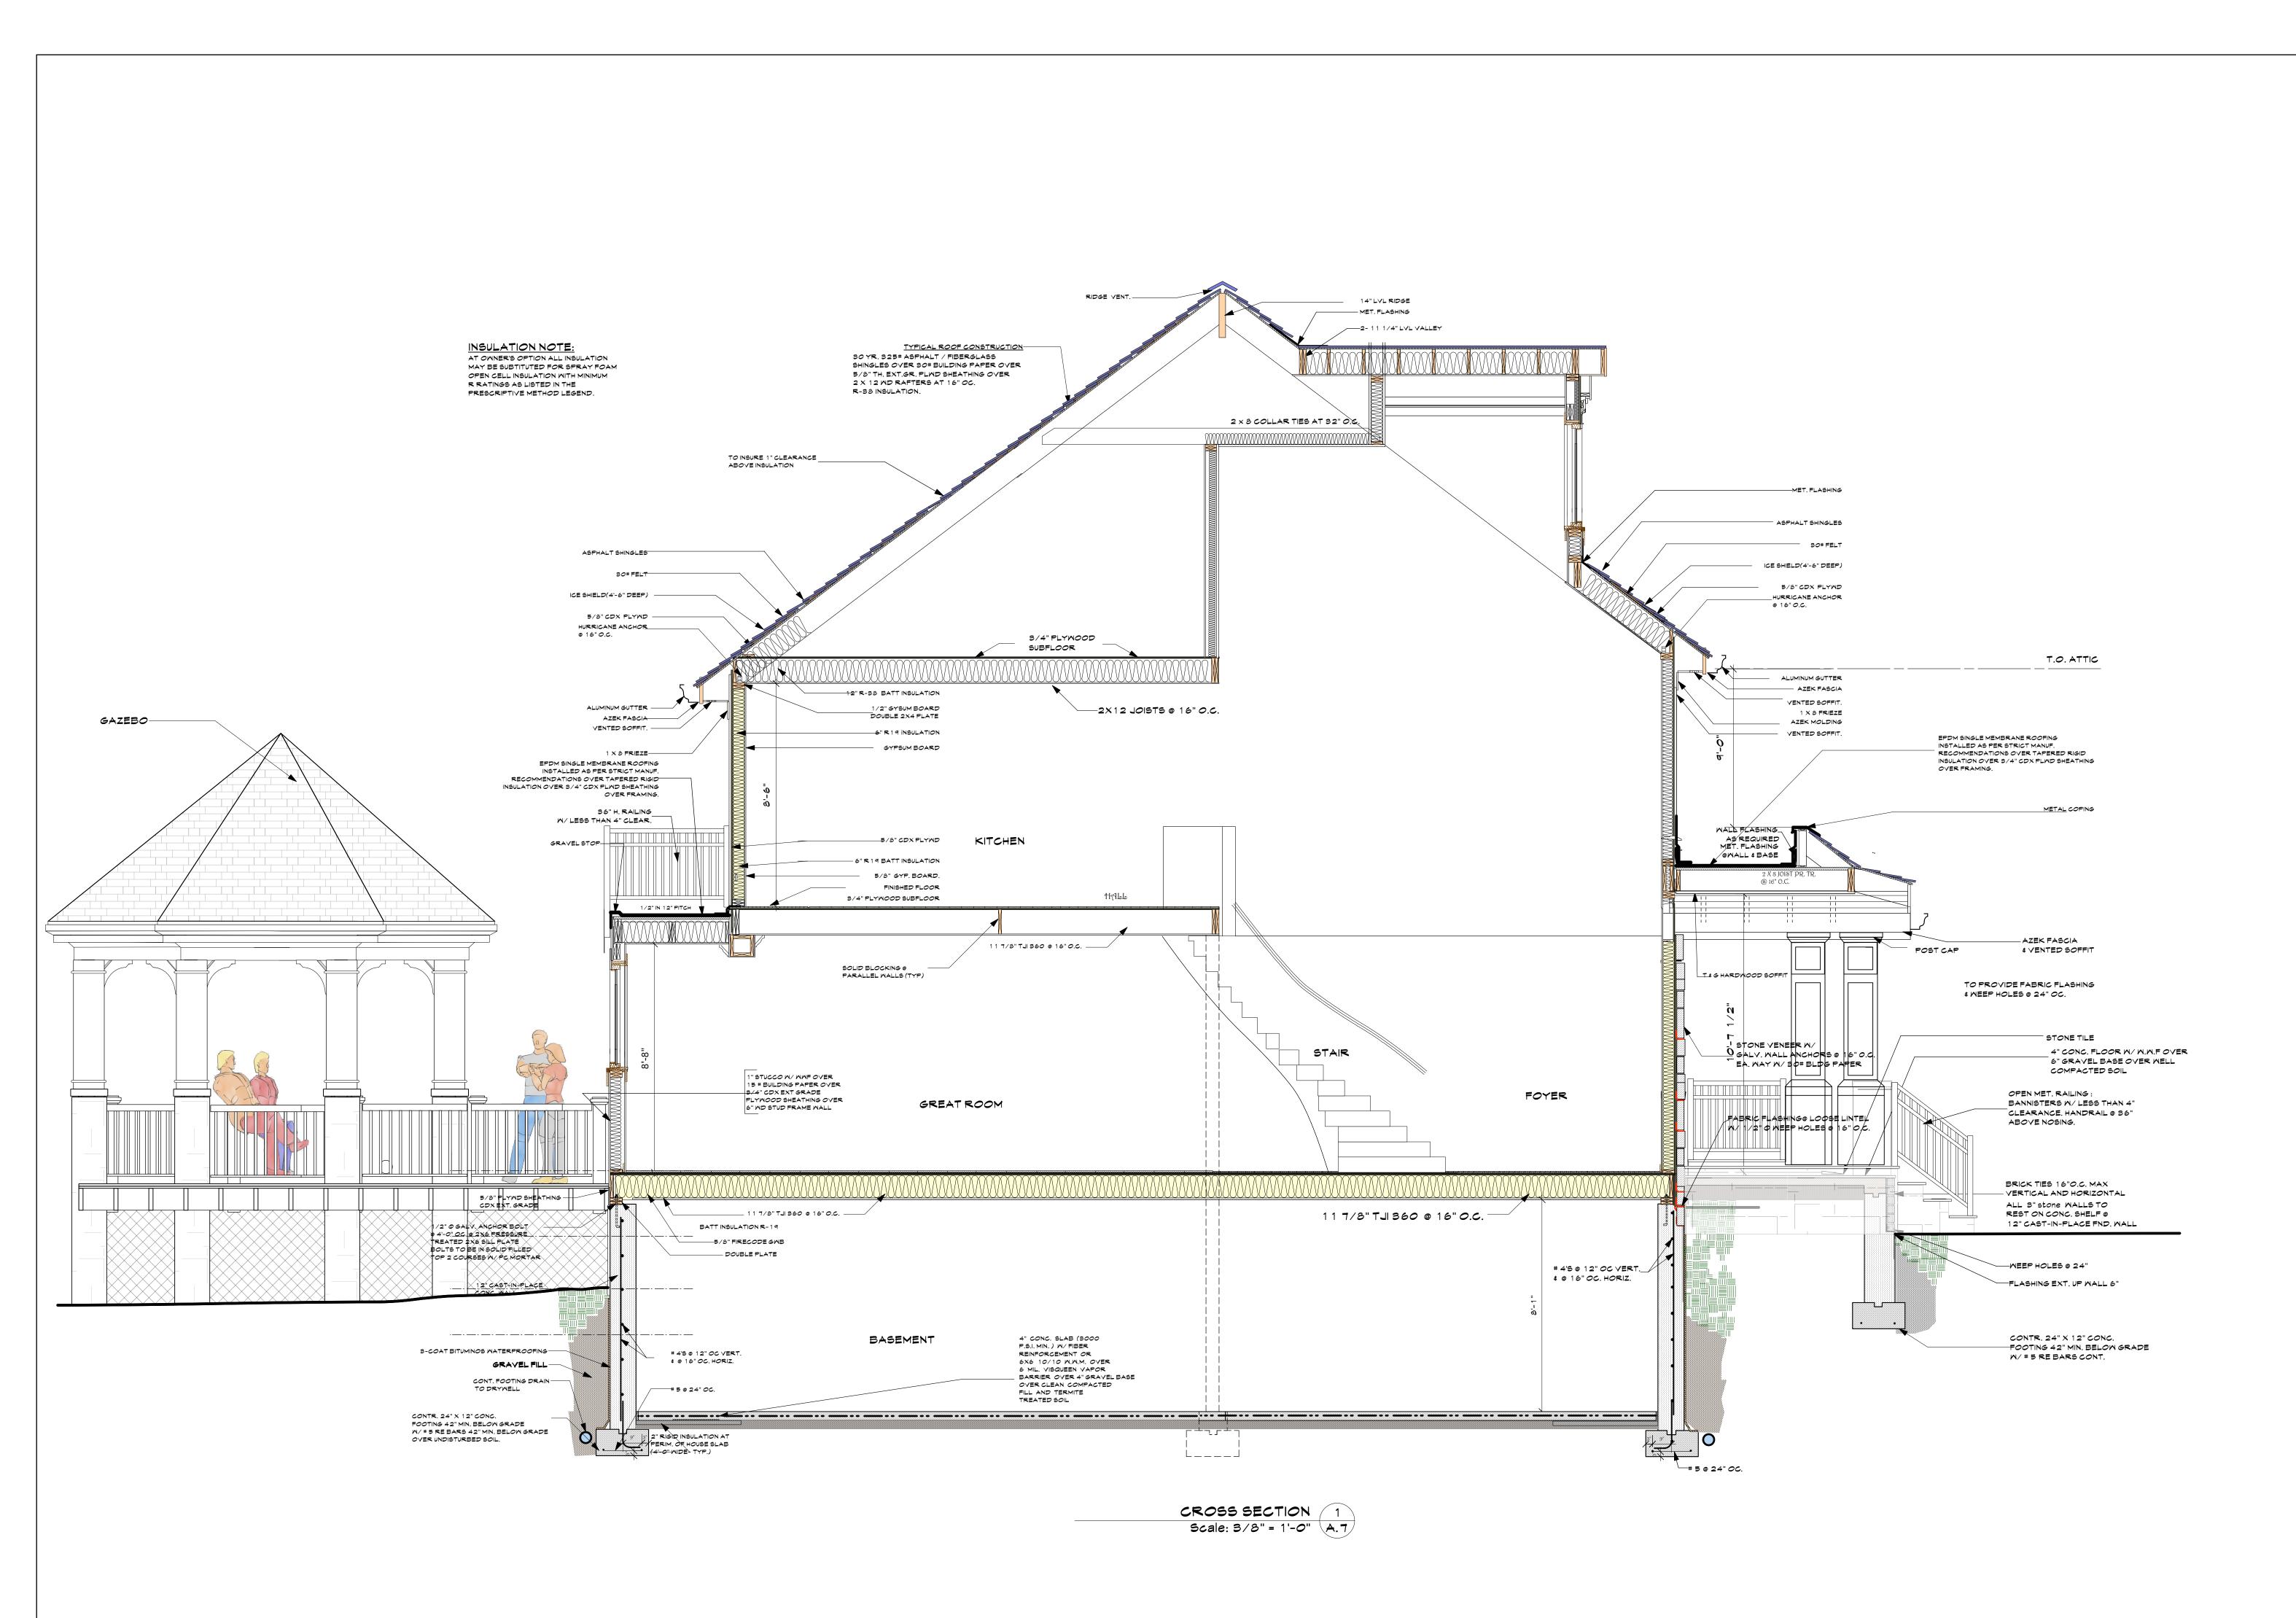
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SBL: 101.01/1/13 ZONE: R-1A

LEFT SIDE ELEVATION

Project ID / DATE : 2048/ 10.15.2020





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OWNER:

MR. & MRS. CHRISTOPHER KALIAN

NO. REV. DATE



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KEY PLAN

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99 BYRAM RIDGE RD.,
ARMONK, N.Y


CROSS SECTION


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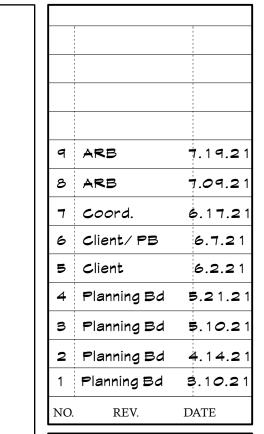
Project ID / DATE : 2048/ 10.15.2020

Sheet Scale:





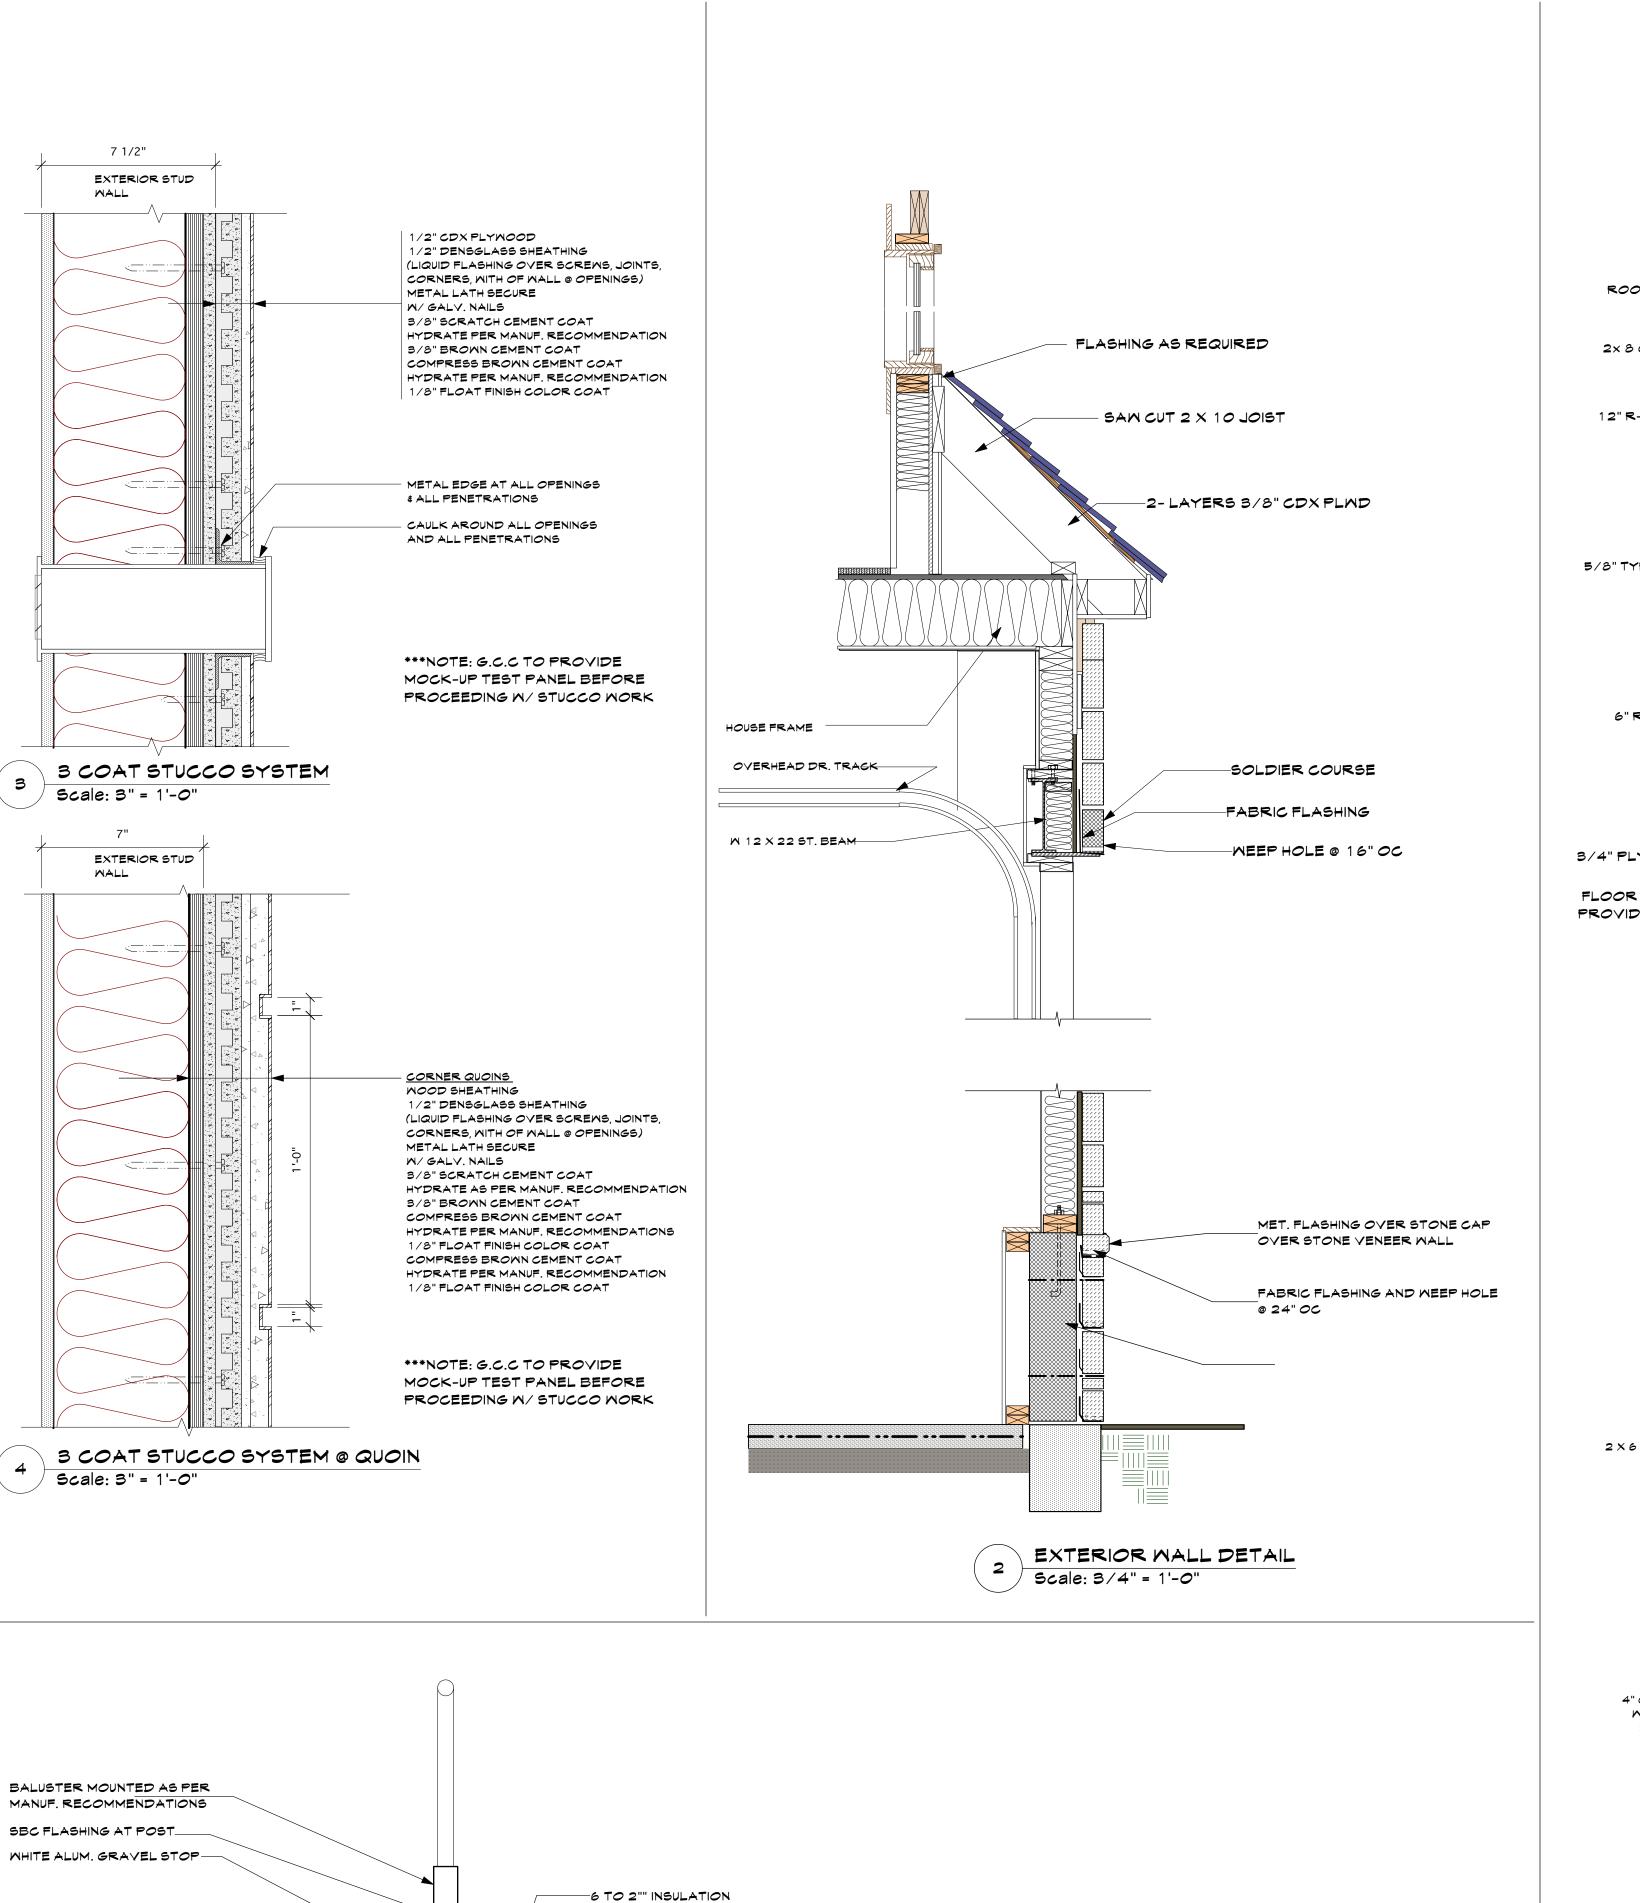

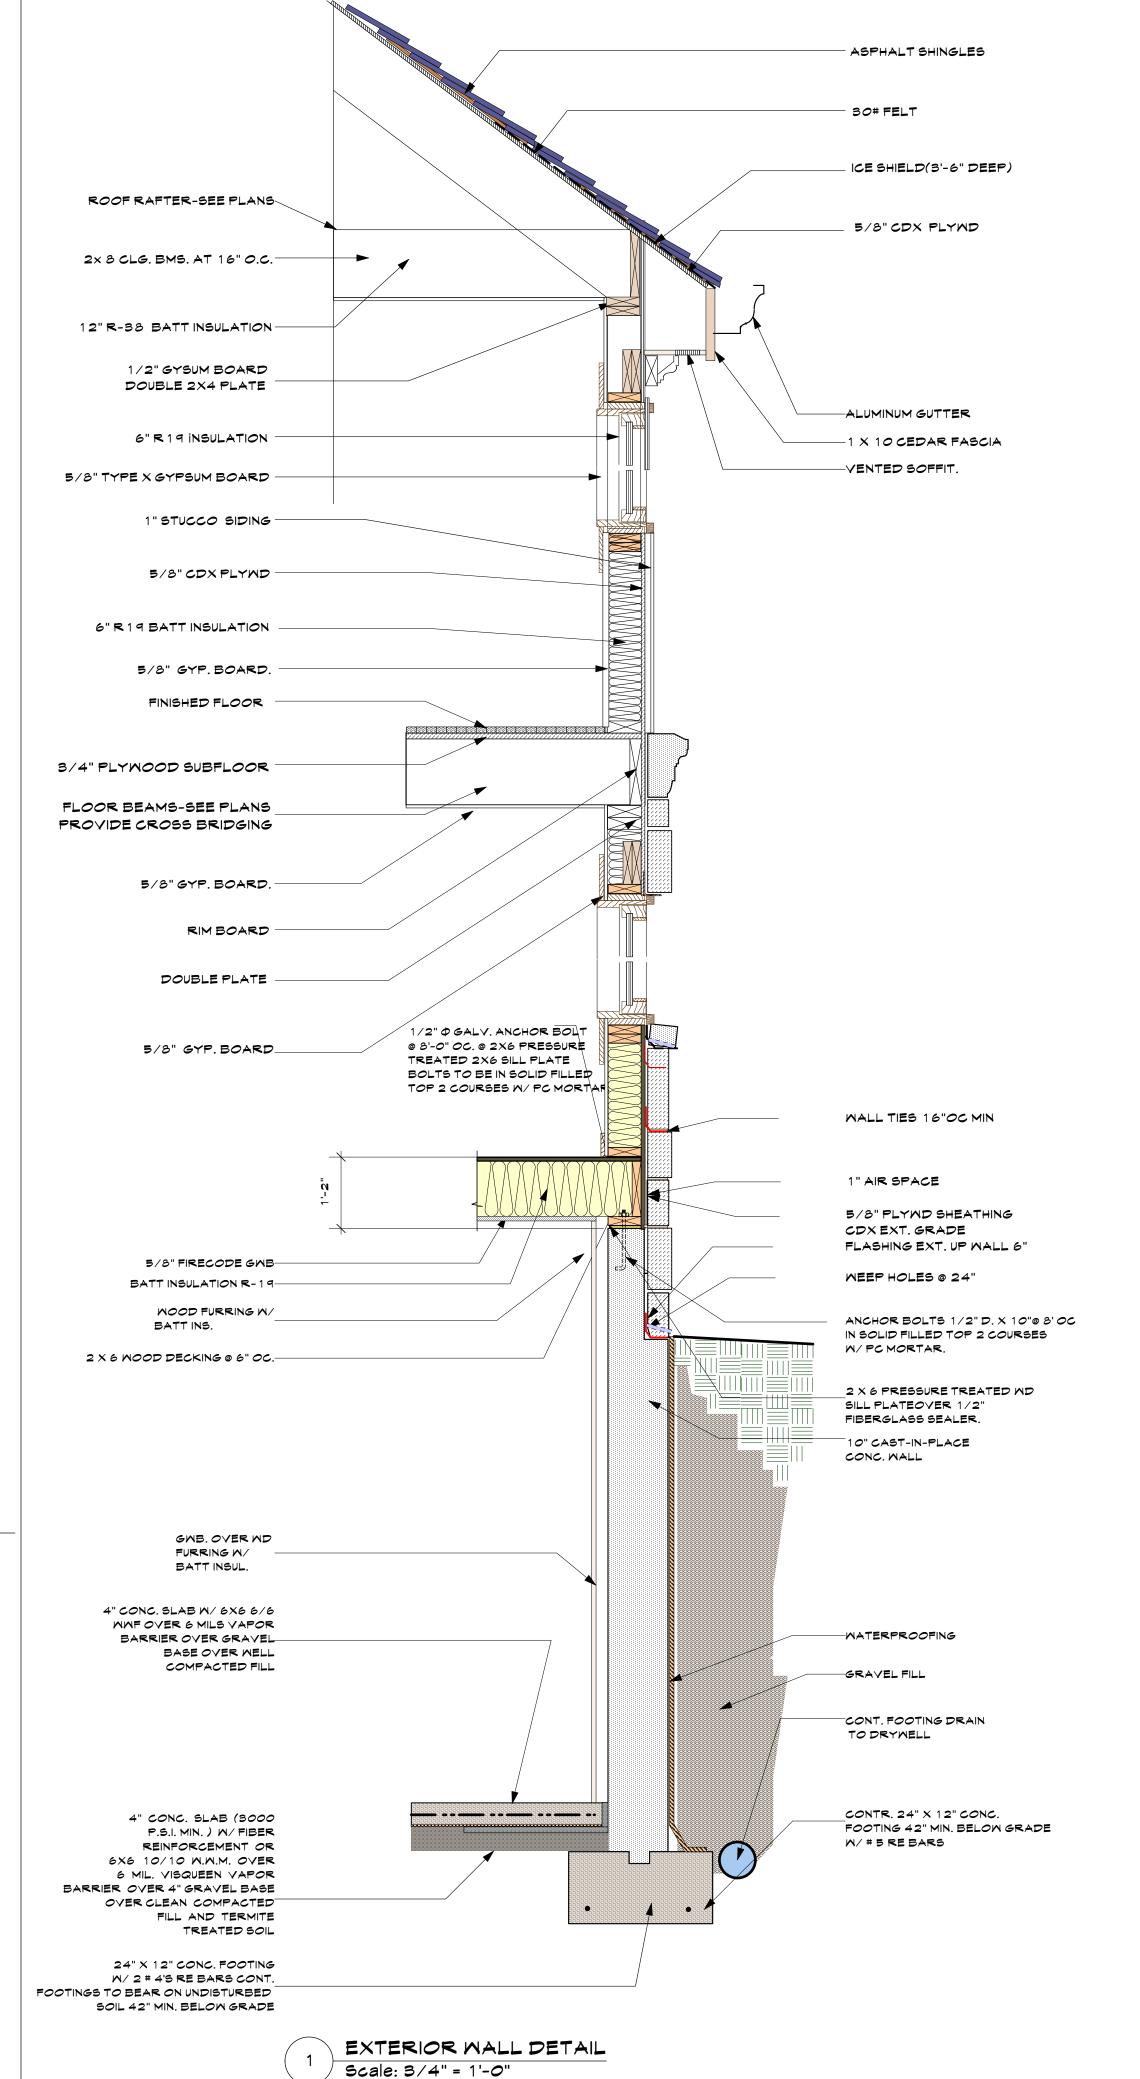

OWNER:

MR. & MRS. CHRISTOPHER KALIAN



1955 CENTRAL PARK AVENUE YONKERS, NEW YORK PHONE: 914 6684673 FAX: 914 668 1831 EMAIL: FILES@TFARA.COM



KEY PLAN

PROPOSED ONE FAMILY

ONE FAMILY
DWELLING
EXPANSION

99 BYRAM RIDGE RD.,

ARMONK, N.Y

SBL: 101.01/1/13 ZONE: R-1A

EXTERIOR

WALL DETAILS

Project ID / DATE : 2048/ 10.15.2020

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