BIBBO ASSOCIATES, L.L.P.

Consulting Engineers

Timothy S. Allen, P.E. Nicholas Gaboury, P.E. Matthew J. Gironda, P.E.

October 25, 2021

North Castle Planning Board 17 Bedford Road Armonk, NY 10504

Attn: Christopher Carthy, Chairman

RE: Subdivision & Site Plan Approval Bedford EMP Ownership, LLC - Robert Morse 50 East Middle Patent Road North Castle (T)

Dear Chairman and Members of the Board:

On behalf of the applicant identified above, please find enclosed the following:

In connection with the Application for Preliminary Subdivision Approval – Application # 2021-028:

- EX-1 Existing Conditions Plan, last revised 10-25-21.
- PP-1 Preliminary Subdivision Plat, last revised 10-25-21
- Exhibit 1 11x17 Lot Dimension Figure, dated 10-25-21.
- Exhibit 2 11x 17 Contiguous Buildable Area Figure, dated 10-25-21.

In connection with Site Plan Application – Tax ID # 103.01-1-18.1 – Application # 2021-031:

- Site Plan Set (4 sheets), dated 10-25-21.
- Tree Removal Plan, Prepared by Benedek & Ticehurst, dated 10-25-21.
- Landscape Plan, Prepared by Benedek & Ticehurst, dated 10-25-21.
- Exhibit 1A 11x17 Gross Land Coverage Calculation Figure
- Gross Land Coverage Calculation Worksheet, dated 10-25-21.
- Lot 2 Architectural Plans (14 Sheets), dated 10-25-21.
- Lot 2 Floor Area Calculation Worksheet, dated 10-25-21

In connection with Site Plan Application - Tax ID # 103.01-1-18.2 - Application # 2021-030:

- Site Plan Set (4 sheets), dated 10-25-21.
- Tree Removal Plan, Prepared by Benedek & Ticehurst, dated 10-25-21.
- Landscape Plan, Prepared by Benedek & Ticehurst, dated 10-25-21.
- Exhibit 2A 11x17 Gross Land Coverage Calculation Figure
- Gross Land Coverage Calculation Worksheet, dated 10-25-21
- Architectural Plans (7 Sheets), dated 10-25-21
- Floor Area Calculation Worksheet, dated 10-25-21

Site Design • Environmental

NCPB-Carthy Morse-Preliminary Subdivision Application October 25, 2021 Page **2** of **2**

Per our recent discussions with the Town Tax Assessor, the enclosed documents have been revised to reflect the new Tax Identification Numbers assigned to each proposed lot for public hearing notification purposes. With the exception of the revised tax identification numbers, there has not been any changes to the project plans since our previous October 12, 2021 submission

We respectfully request that this matter be placed on your next available agenda for consideration. Should you have any questions or need any additional information, please feel free to contact our office.

Sincerely,

Matthew J. Gironda, P.E.


Partner


MJG/rh Enclosures


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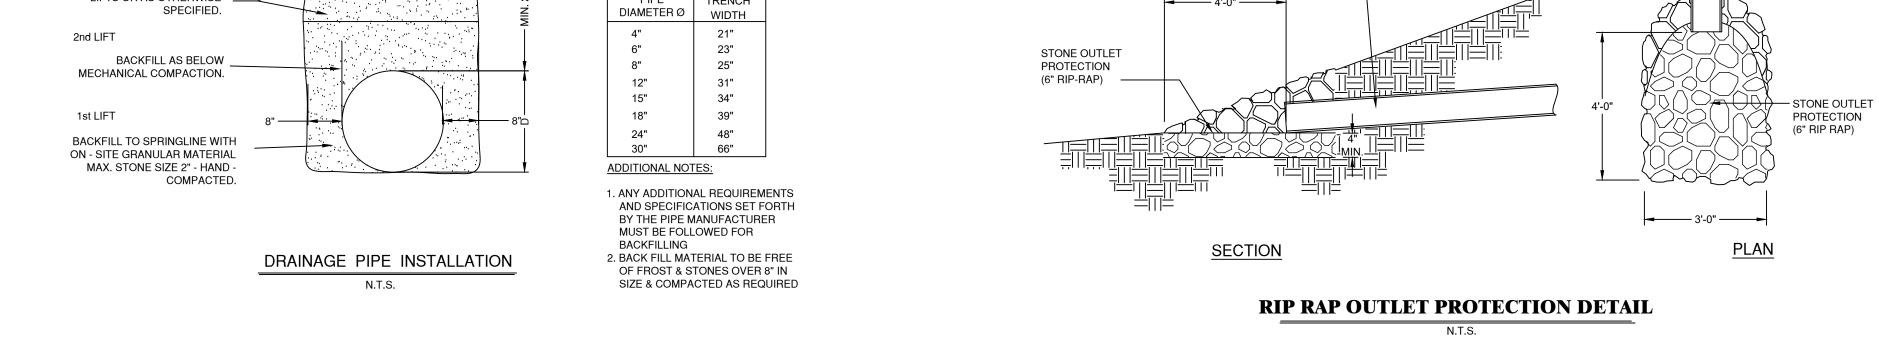
C. Intinarelli (enclosures) e-mail G. Ticehurst (enclosures) e-mail


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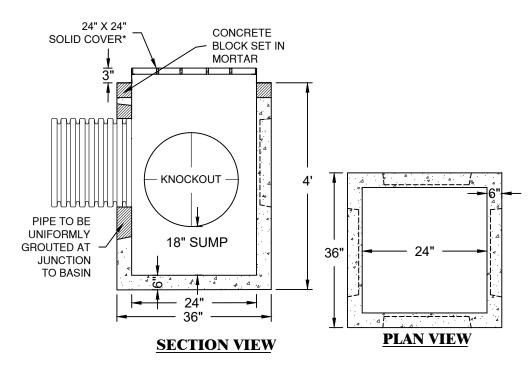


NAT. GAS/ELEC/TEL. UTILITIES TRENCH N.T.S.

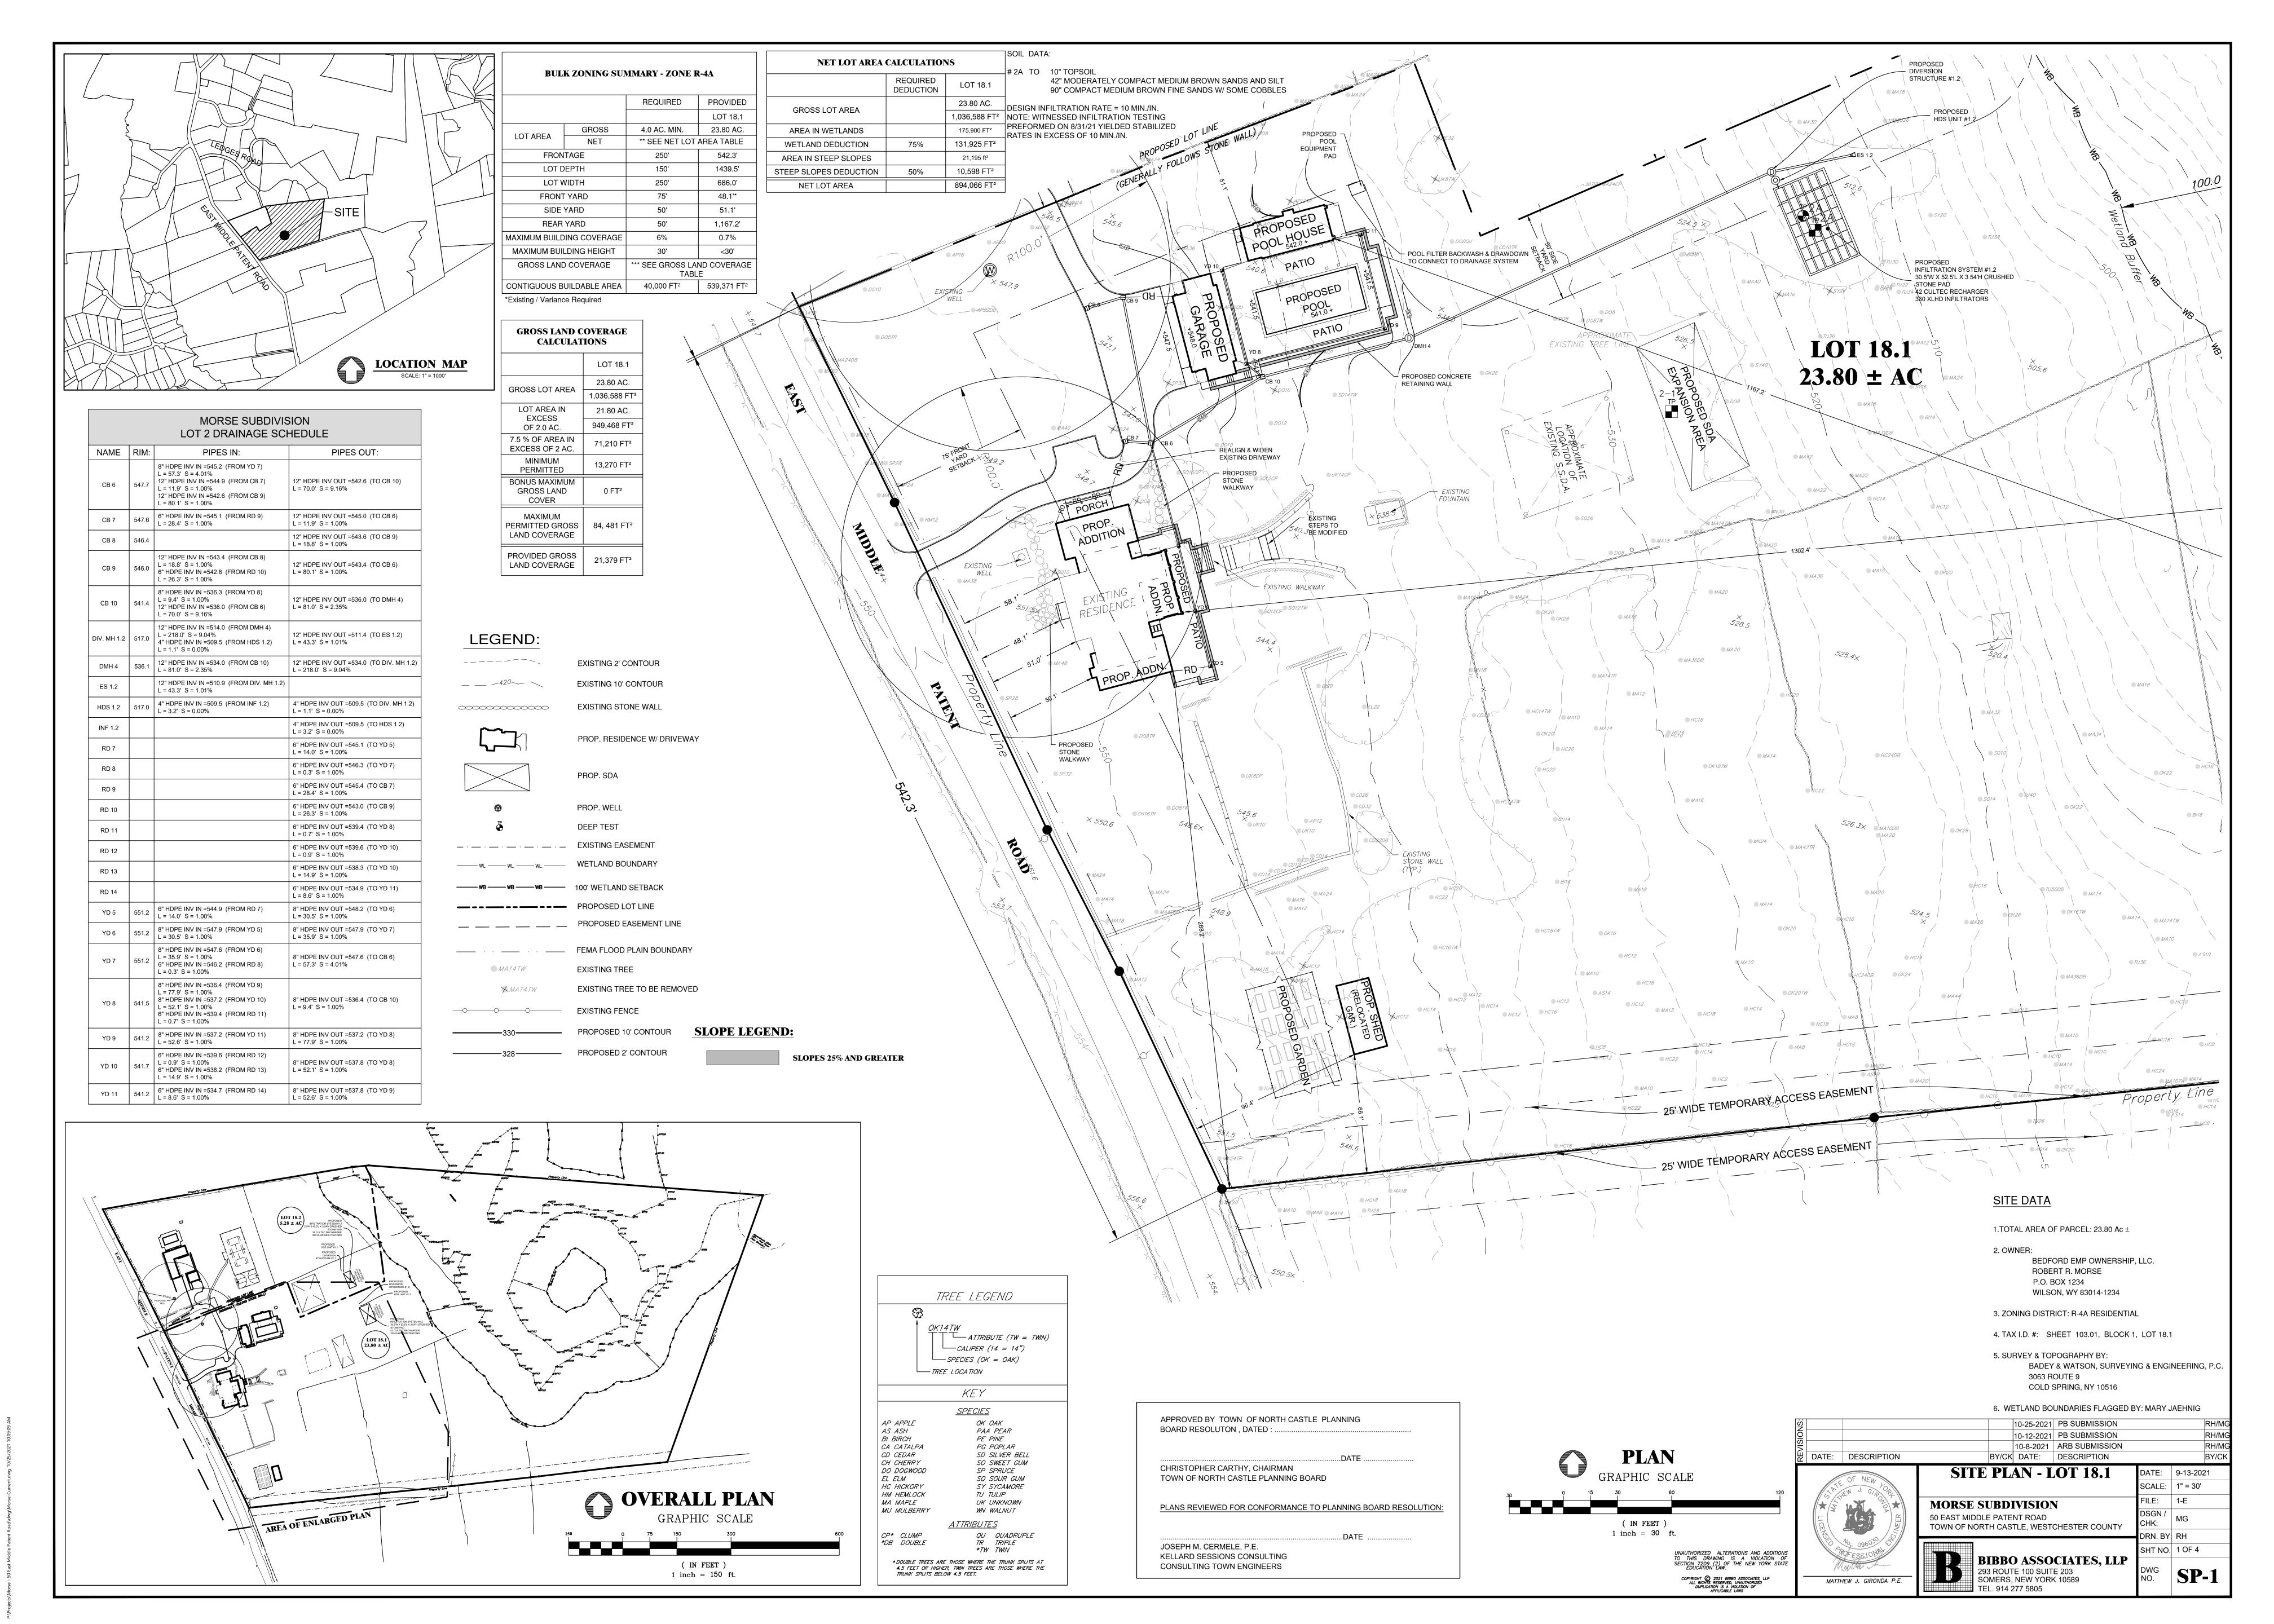─ ELEC. CABLE(DIRECT BURIAL)

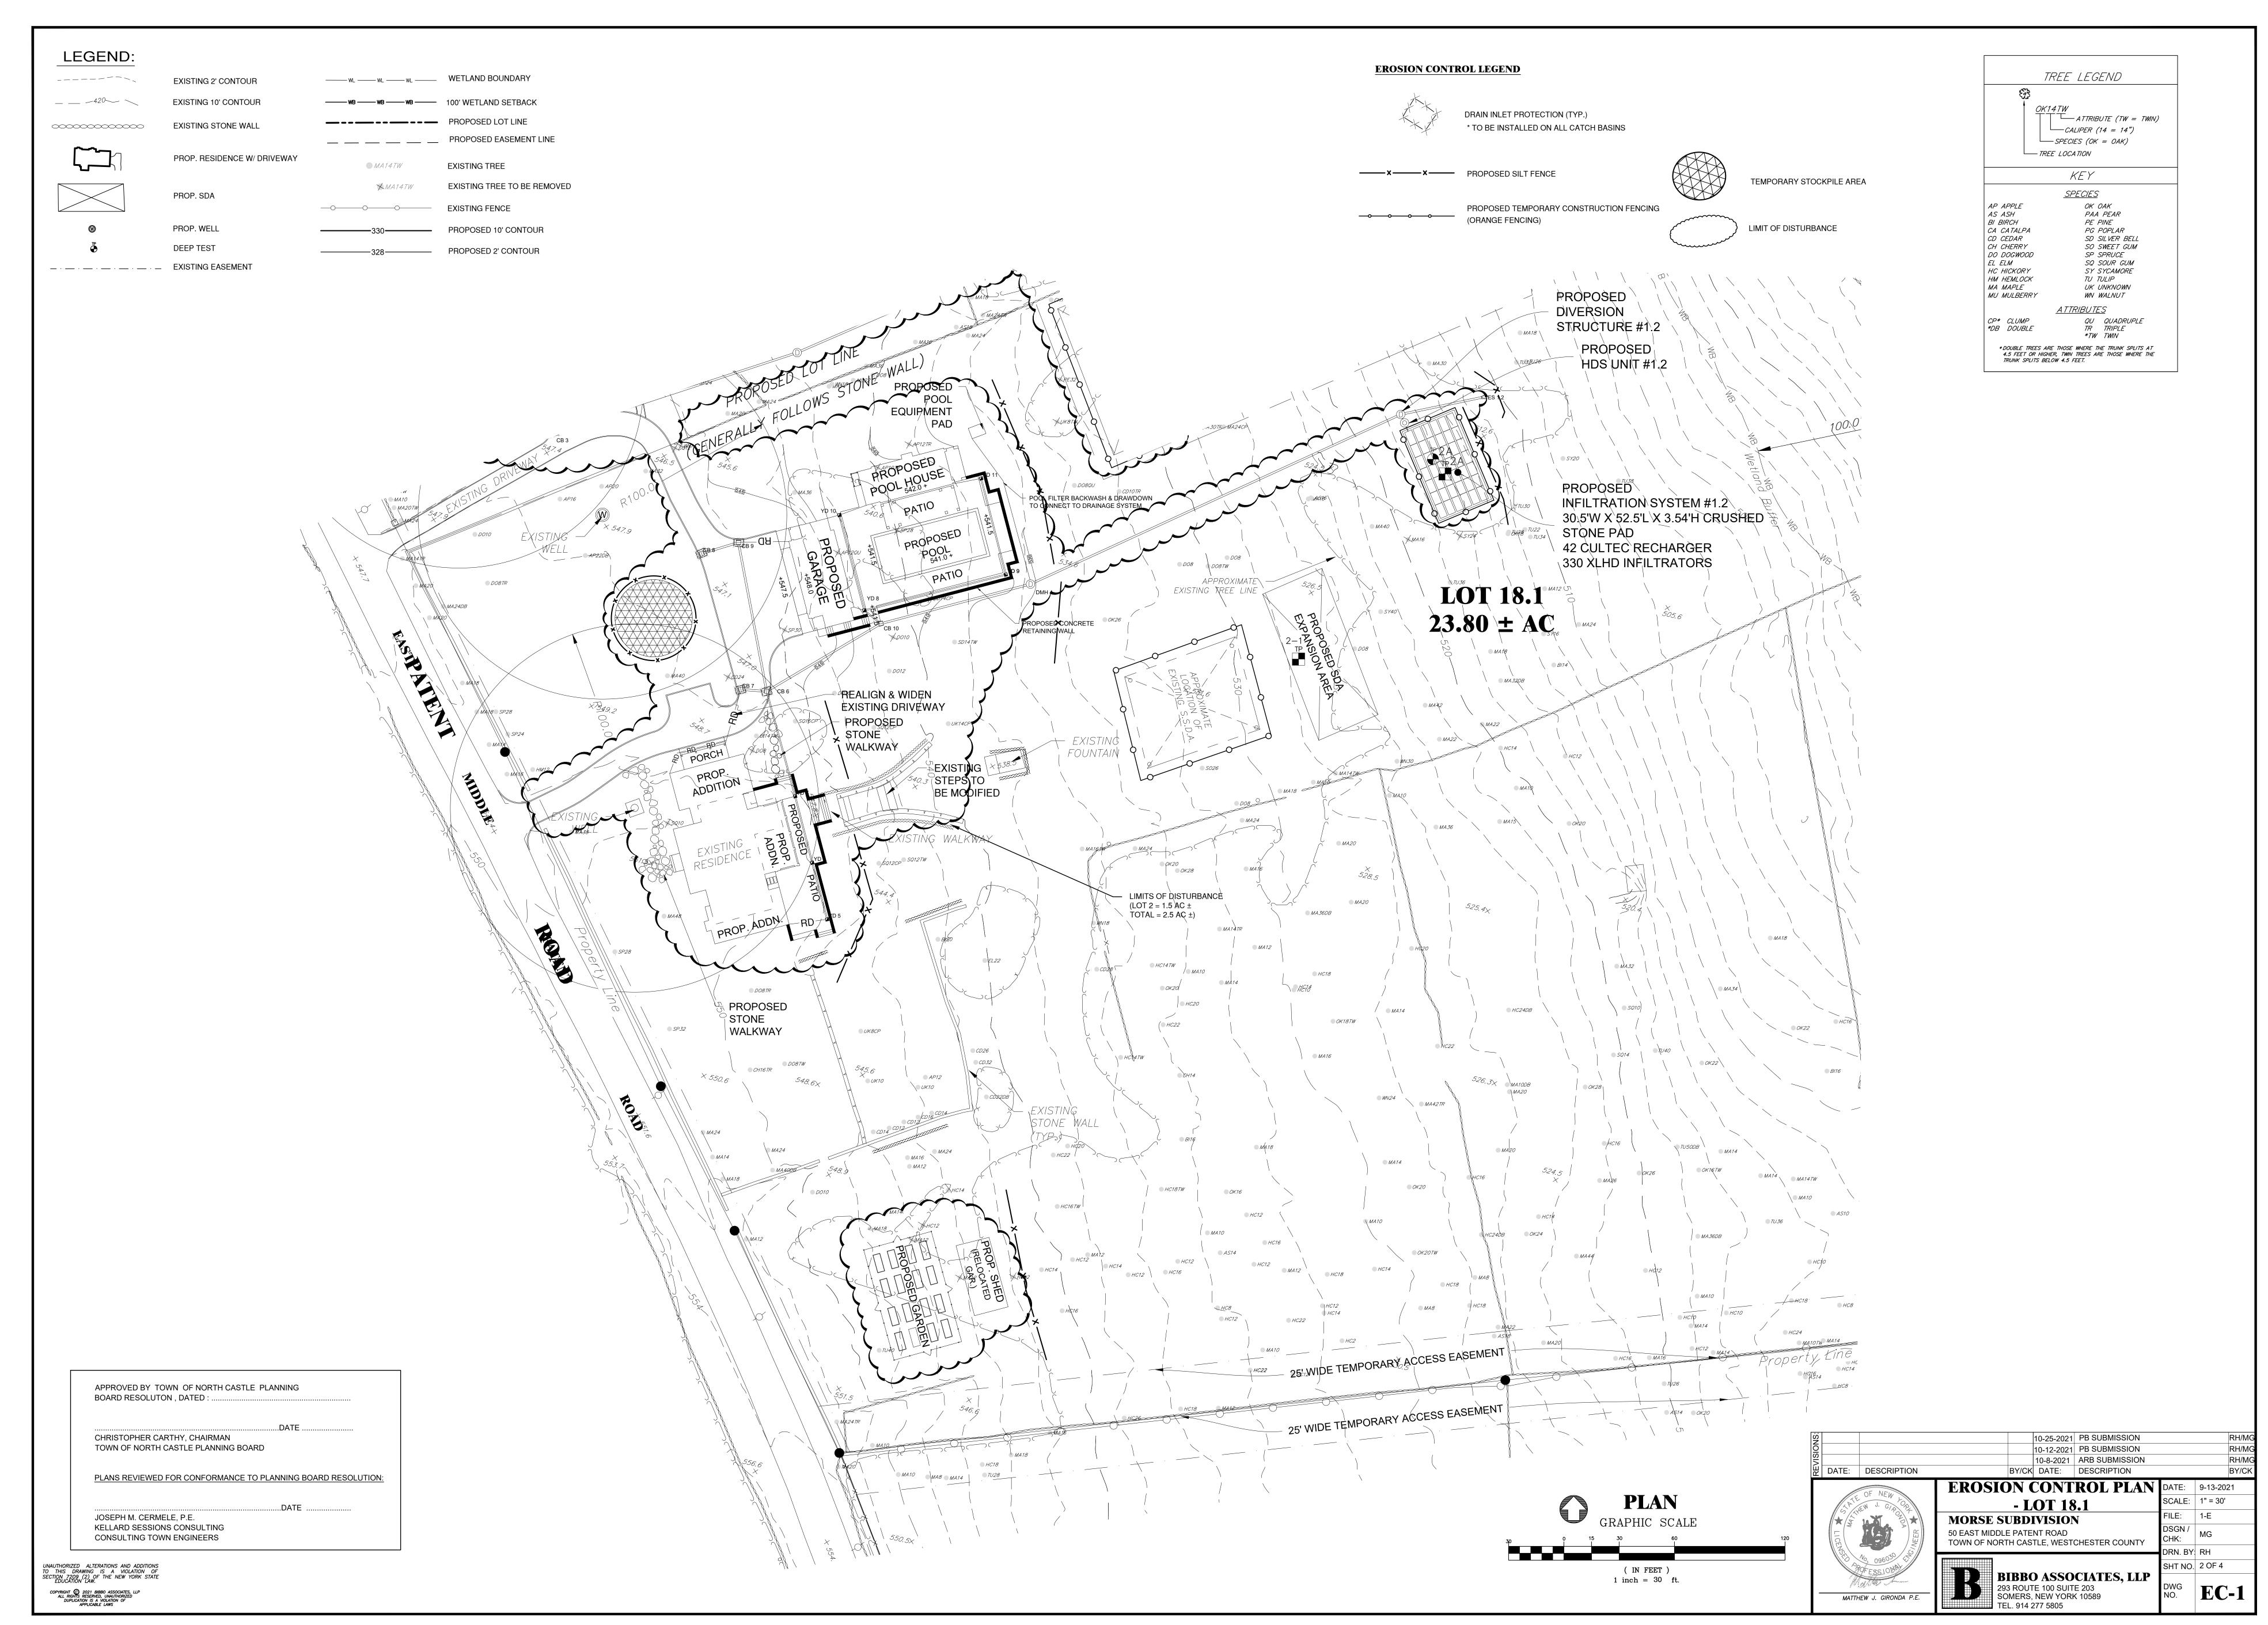
- CATV(DIRECT BURIAL)

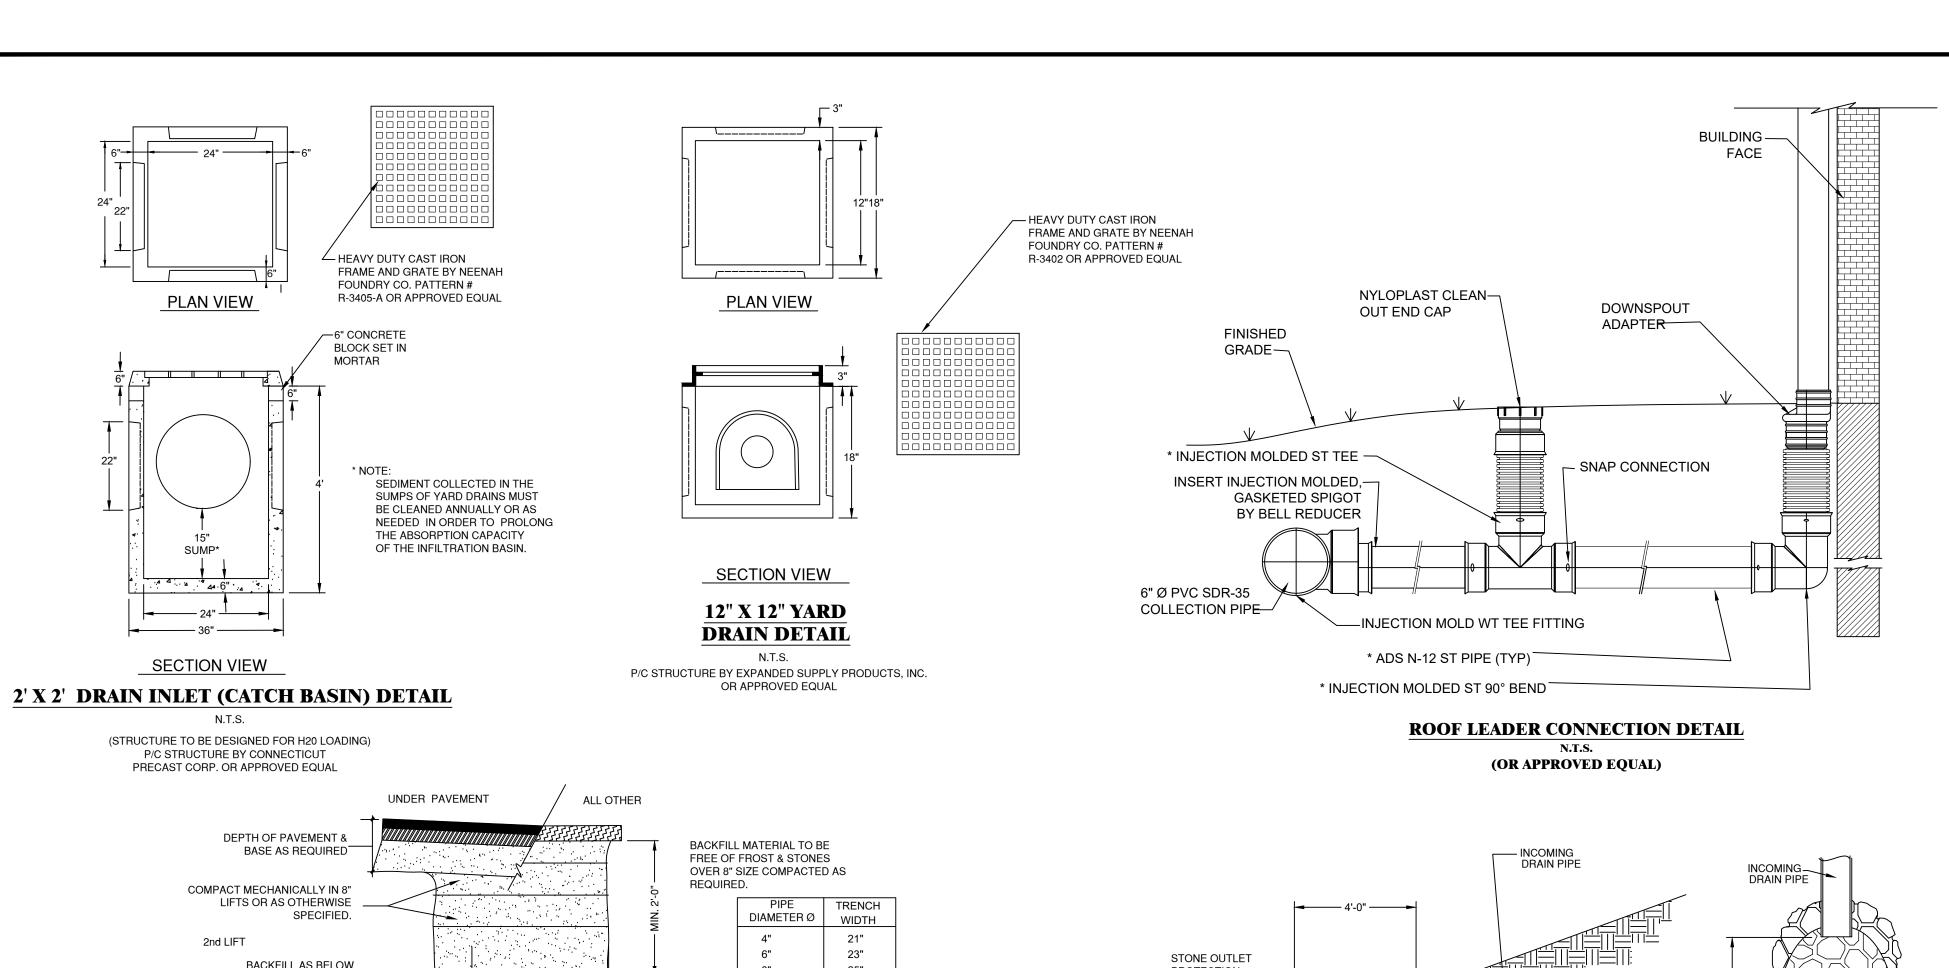- 4" PVC TEL. CONDUIT

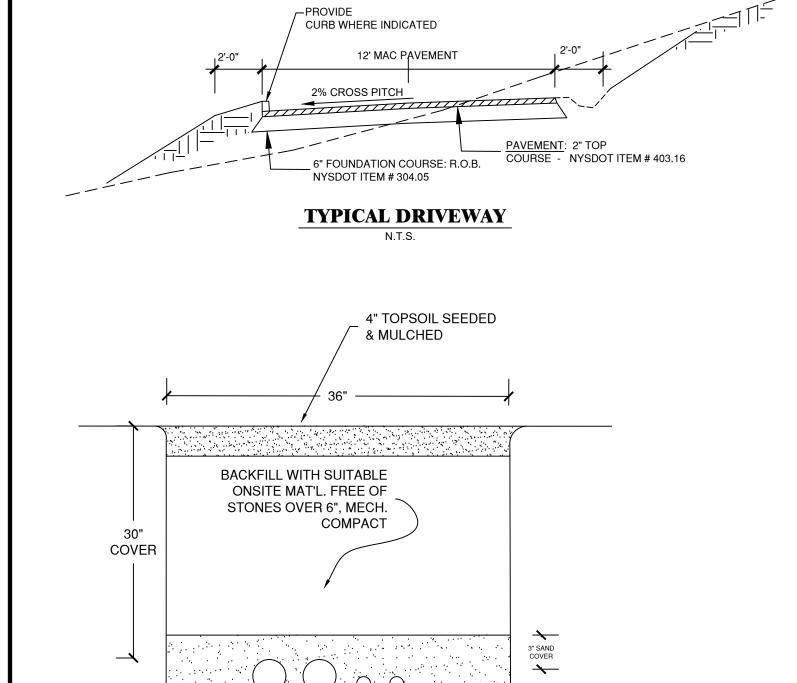

YARD DRAIN DETAIL N.T.S. RESIDENTIAL DRAIN AS MANUFACTURED BY CONNECTICUT PRECAST CO.


DIVERSION STRUCTURE CHART				
DIVERSION STRUCTURE #1.2				
	RIM:	517.00		
PRIMARY OUTLET (TO INF.)	INV.:	509.50		
(10 1111 .)	DIA.:	4"		
BYPASS OUTLET (SECONDARY)	INV.:	511.35		
,	DIA.:	15"		

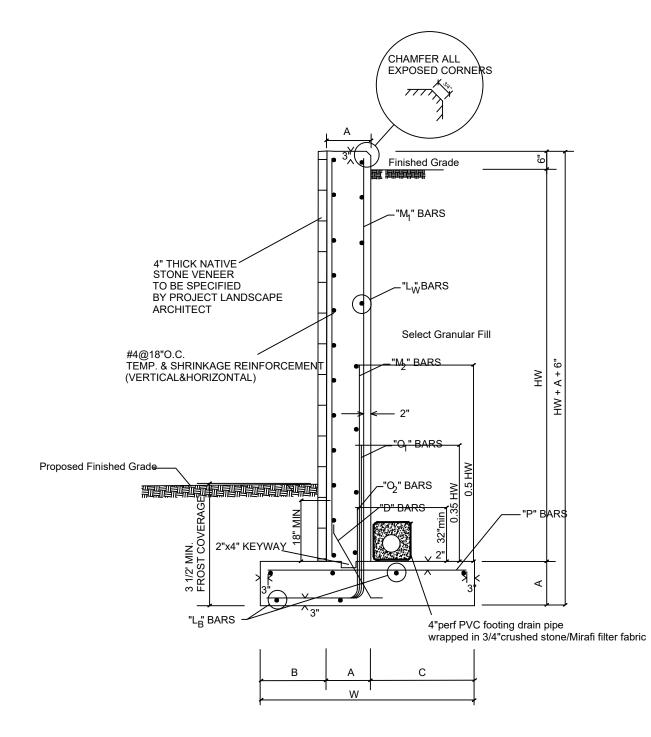

	RETAINING WALL SCHEDULE											
HW	Α	В	С	W	"01" BARS	"02" BARS	"M1" BARS	"M2" BARS	"D" BARS	"L _B BARS	"L _W BARS	"P " BARS
0' to 10'	12"	15"	3'-5"	5'-8"		-	#5@12"o.c.		#4@12"o.d	. 5-#5	#5@12"o.c	#5@12"0
10' to 12'	14"	18"	4'-1"	6'-9"	#6@18"o.d	. #6@18"o.c	#4@18"o.c.	#4@18"o.c.	#4@9"o.c.	6-#6	#6@12"o.c.	#5@9"o.d
12' to 15'	16"	23"	5'-1"	8'-4"	#7@18"o.c	. #7@18"o.c	#6@18"o.c.	#6@18"o.c.	#4@9"o.c.	6-#7	#7@15"o.c.	#6@9"o.c

DETAIL - REINFORCED CONCRETE RETAINING WALL

N.T.S.

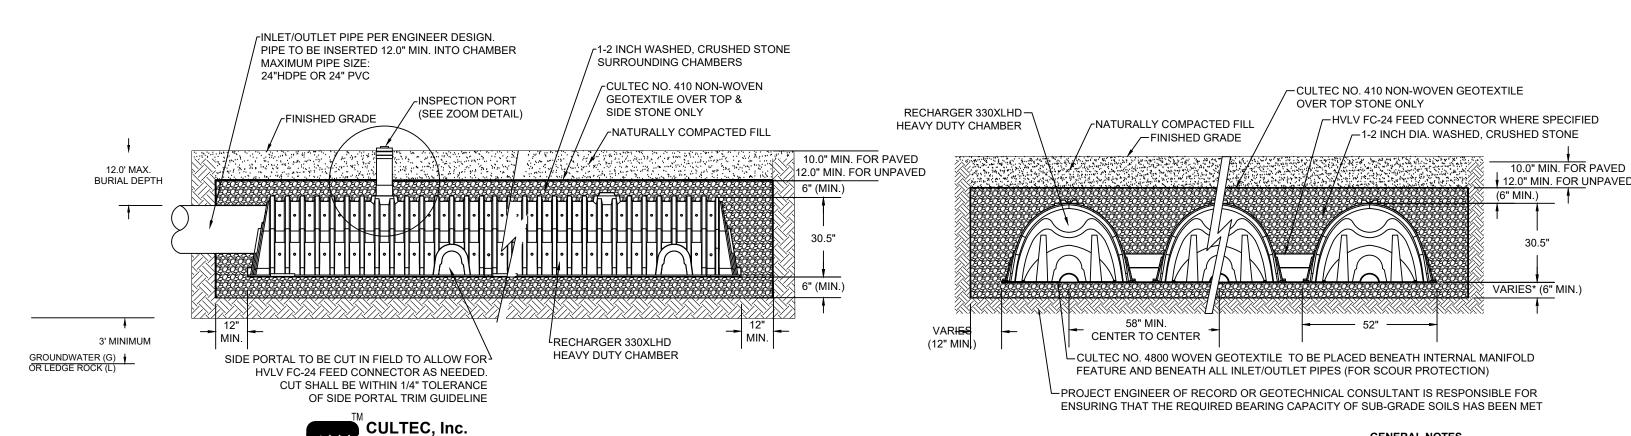

CULTEC RECHARGER 330XLHD


RECHARGER 330XL HD BY CULTEC, INC. OF BROOKFIELD, CT. REFER TO CULTEC, INC.'S CURRENT RECOMMENDED INSTALLATION GUIDELINES. THE CHAMBER WILL BE DESIGNED TO WITHSTAND TRAFFIC LOADS WHEN INSTALLED ACCORDING TO CULTEC'S RECOMMENDED INSTALLATION INSTRUCTIONS

ALL RECHARGER 330XL HD HEAVY DUTY UNITS ARE MARKED WITH A COLOR STRIPE FORMED INTO THE PART ALONG THE LENGTH OF THE CHAMBER. ALL RECHARGER 330XL HD CHAMBERS MUST BE INSTALLED IN ACCORDANCE WITH ALL APPLICABLE LOCAL, STATE AND FEDERAL REGULATIONS

Portland, ME 04102

Tel: +1 (207) 756-6200

hydro-int.com

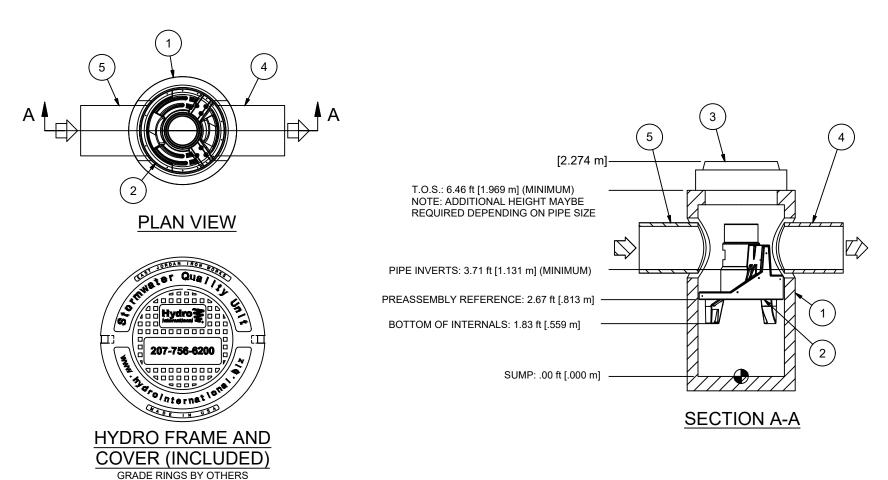

PRODUCT SPECIFICATION:

1. PEAK HYDRAULIC FLOW: 18.0 cfs (510 l/s) 2. MIN SEDIMENT STORAGE CAPACITY: 0.7 cu. yd. (0.5 cu. m.) 3. OIL STORAGE CAPACITY: 191 gal. (723 liters) 4. MAXIMUM INLET/OUTLET PIPE DIAMETERS: 24 in. (600 mm)

Subsurface Stormwater Management Systems

O. Box 280

CULTEC Brookfield, CT 06804

878 Federal Road

www.cultec.com

5. THE TREATMENT SYSTEM SHALL USE AN INDUCED VORTEX TO SEPARATE POLLUTANTS FROM STORMWATER RUNOFF. 6. FOR MORE PRODUCT INFORMATION INCLUDING REGULATORY ACCEPTANCES, PLEASE VISIT

6. Larger sediment storage capacity may be provided with a deeper sump depth.

GENERAL NOTES: General Arrangement drawings only. Contact Hydro International for site specific drawings.
 The diameter of the inlet and outlet pipes may be no more than 24".
 Multiple inlet pipes possible (refer to project plan). 4. Inlet/outlet pipe angle can vary to align with drainage network (refer to project plan.s) 5. Peak flow rate and minimum height limited by available cover and pipe diameter.

Fax: +1 (207) 756-6212 TEM QTY SIZE (in) SIZE (mm) DESCRIPTION

1200 I.D. PRECAST MANHOLE INTERNAL COMPONENTS (PRE-INSTALLED) 750 FRAME AND COVER (ROUND) 1 | 30 | 750 | FRAME AND COVER (ROUN 1 | 24 (MAX) | 600 (MAX) | OUTLET PIPE (BY OTHERS)

5 1 24 (MAX) 600 (MAX) INLET PIPE (BY OTHERS)

HYDRODYNAMIC SEPARATOR DETAIL HYDRO INTERNATIONAL - FIRST DEFENSE MODEL FD-4HC (INFILTRATION BASIN 2.4 S)

NOTES:

1. THE CONTRACTOR SHALL VERIFY THE EXISTING SOIL, TOPOGRAPHIC CONDITIONS, SUBSEQUENT RETAINING WALL HEIGHTS AND SOIL CONDITIONS PRIOR TO STARTING THE WORK. ANY INCONSISTENCIES SHALL BE REPORTED TO THE DESIGN ENGINEER TO DETERMINE IF FIELD CHANGES ARE REQUIRED.

2. REINFORCEMENT SHALL BE ASTM GRADE 60, DEFORMED BILLET-STEEL REBAR FOR CONCRETE REINFORCEMENT COMPLIANCE WITH ASTM A615.

3. ALL POURED IN PLACE CONCRETE SHALL HAVE A 3000 PSI COMPRESSIVE STRENGTH AT

4. WHERE THE RETAINING WALL SHALL BE CONSTRUCTED ON A SLOPE, SUFFICIENT LEVEL SHELVING SHALL BE PROVIDED FOR FOOTING CONSTRUCTION. BOTTOM OF FOOTING SHALL BE CONSTRUCTED AS SHOWN ON THE RETAINING WALL CROSS SECTION.

5. BACKFILL MATERIAL SHALL BE GRANULAR SOILS FREE OF LARGE STONES, ORGANIC MATERIAL AND HIGH PERCENTAGES OF SILT / CLAY.

6. RETAINING WALL DESIGN IS BASED ON A 2.0 TON/SF SOIL BEARING CAPACITY. THE CONTRACTOR SHALL FIELD VERIFY SOIL CONDITIONS AND BEARING CAPACITIES OF IN-SITU SOIL. IF SOIL TESTING REVEALS INADEQUATE SOIL BEARING CAPACITIES, THE DESIGN ENGINEER SHALL BE NOTIFIED TO CONFIRM WALL DESIGN PARAMETERS PRIOR TO CONSTRUCTION.

THE RETAINING WALL DESIGN IS BASED ON A "B" CLASS "GRANULAR SOILS, MIX GRAIN SIZES" BACKFILL SOIL CONDITION. ANY ALTERATION FROM THESE SOILS, SUCH AS HIGH GROUNDWATER, HIGH PERCENTAGES OF FINES, SILTS AND CLAYS WILL CONSTITUTE DESIGN CHANGES.

8. ALL REBAR LAP SPLICES SHALL BE A MINIMUM OF 32" IN LENGTH.

9. EXPANSION JOINTS WILL BE PROVIDED AS SHOWN ON THE ELEVATION VIEWS.

10. CHAMFER ALL EXPOSED CORNERS $\frac{3}{4}$ "

SHOP DRAWINGS OF ALL CIVIL COMPONENTS SHOULD BE PROVIDED TO OUR OFFICE FOR THE REVIEW AND APPROVAL PRIOR TO PRODUCTION / PURCHASING 10-25-2021 PB SUBMISSION 10-12-2021 PB SUBMISSION 10-8-2021 ARB SUBMISSION BY/CK DATE: DESCRIPTION DATE: DESCRIPTION BY/C **DETAILS - LOT 18.1** DATE: 9-13-2021 SCALE: 1" = 30' FILE: 1-E **MORSE SUBDIVISION**

CALL BEFORE YOU DIG 1-800-962-7962

UNDER THE NY STATE LAW PROTECTING UNDERGROUND FACILITIES, THE FOLLOWING RULES AND REGULATIONS ARE IN EFFECT FOR ALL EXCAVATORS:

* THEY MUST CALL FOR A UTILITY STAKE-OUT (2) TWO FULL WORKING DAYS PRIOR TO AN EXCAVATION. * THEY MUST CONFIRM PRECISE LOCATIONS OF UNDERGROUND FACILITIES.

* THEY MUST PRESERVE STAKES AND MARKINGS UNTIL NO LONGER NEEDED AT SITE. * THEY MUST CONTACT NON-UFPO MEMBER UTILITY OWNERS FOR STAKE-OUTS.

UNAUTHORIZED ALTERATIONS AND ADDITIONS TO THIS DRAWING IS A VIOLATION OF SECTION 7209 (2) OF THE NEW YORK STATE EDUCATION LAW.

MATTHEW J. GIRONDA P.E.

50 EAST MIDDLE PATENT ROAD TOWN OF NORTH CASTLE, WESTCHESTER COUNTY BIBBO ASSOCIATES, LLP 293 ROUTE 100 SUITE 203 SOMERS, NEW YORK 10589

TEL. 914 277 5805

SHT NO. 3 OF 4 **D-1**

EROSION CONTROL PROGRAM

BELOW AND SHOWN ON THIS DRAWING. REQUIRED PROCEDURES


PURPOSE

ALL CONSTRUCTION ACTIVITIES INVOLVING THE REMOVAL OR DEPOSITION OF SOILS ARE TO BE PROVIDED WITH APPROPRIATE PROTECTIVE MEASURES TO INHIBIT EROSION AND TO CONTAIN SEDIMENT DEPOSITION WITHIN THE AREA UNDER DEVELOPMENT. THOSE METHODS DEEMED HIGHLY EFFECTIVE ARE DESCRIBED


- 1. PRIOR TO START OF SITE CONSTRUCTION: ALL CONSTRUCTION ENTRANCES TO SITE SHALL BE INSTALLED AND STABILIZED. ALL TEMPORARY SILTATION BASINS AND/OR OTHER APPROVED SEDIMENT CONTROL MEASURES SHALL BE IN PLACE WHERE MOST EFFECTIVE. 2. ALL TEMPORARY EROSION AND SEDIMENT CONTROLS SHALL REMAIN IN PLACE, MAINTAINED REGULARLY IN PROPER FUNCTIONING CONDITION, UNTIL ALL AREAS EXPOSED DURING SITE CONSTRUCTION HAVE BEEN SUITABLY STABILIZED WITH PAVEMENT, PERMANENT STRUCTURES AND/OR FINAL VEGETATION COVER.
- CONSTRUCTION GUIDELINE: A. WHEREVER FEASIBLE, NATURAL VEGETATION SHALL BE RETAINED AND PROTECTED (BY
- FLAGGING OR OTHER EFFECTIVE MEANS) B. ONLY THE SMALLEST PRACTICAL AREA OF LAND SHALL BE EXPOSED AT ANY ONE TIME DURING CONSTRUCTION.
- C. SITE CONSTRUCTION ACTIVITIES SHALL START WHENEVER POSSIBLE AT THE NEAREST POINT UPSTREAM OF THESE SILT TRAPS AND PROCEED TO ACTIVITIES FURTHER UPSTREAM.
- D. WHEN LAND IS EXPOSED DURING DEVELOPMENT, THE PERIOD OF EXPOSURE SHALL BE KEPT TO A MINIMUM, INSTALLING PERMANENT AND FINAL VEGETATION, PAVING, STRUCTURES, ETC., AT
- THE EARLIEST POSSIBLE OPPORTUNITY. E. CONSTRUCTION EQUIPMENT SHALL NOT UNNECESSARILY CROSS LIVE STREAMS EXCEPT BY MEANS OF BRIDGES, CULVERTS OR OTHER APPROVED MEANS.
- F. SEDIMENT CONTROL MEASURES INSTALLED IN LIVE STREAMS SHOULD GENERALLY BE MADE OF STONE AND MUST BE SPECIFICALLY DESIGNED, TAKING INTO ACCOUNT THE SIZE OF DRAINAGE BASIN ANTICIPATED STREAM FLOWS AND STREAM VELOCITIES.
- G. NO CONSTRUCTION ACTIVITIES WITHIN OR NEAR LIVE STREAMS (CREATION OF PONDS, REALIGNMENT OF STREAM CHANNELS, INSTALLATION OF LARGE CULVERTS, ETC.) SHALL BEGIN UNTIL APPROPRIATE MEASURES FOR TEMPORARILY DIVERTING STREAM FLOW PAST THE WORK SECTION AND REQUIRED DOWNSTREAM SEDIMENT CONTROLS ARE IN PLACE. IN GENERAL THESE SEDIMENT CONTROLS ARE TO BE REMOVED ONLY WHEN ALL CONSTRUCTION ACTIVITY UPSTREAM HAS BEEN SATISFACTORILY COMPLETED AND THE STREAM FLOWS CLEAR.
- H. NOTES ON SITE STABILIZATION: 1. ALL TOPSOIL TO BE STRIPPED FROM THE AREA BEING DEVELOPED, SHALL BE STOCKPILED NOT LESS THAN 50 FEET FROM ANY BODY OF SURFACE WATER AND SHALL BE IMMEDIATELY
- SEEDED TO MANHATTAN RYE GRASS. 2. ON ALL EMBANKMENT FILL SLOPES, TOPSOIL SHALL BE STRIPPED AT LEAST FIVE (5) FEET WIDER THAN REQUIRED FOR THE EMBANKMENT TOE OF SLOPE. A PROTECTIVE BERM OF TOPSOIL SHALL BE LEFT IN THIS AREA, RUNNING PARALLEL TO THE CONTOURS FOR THE PURPOSE OF RESTRICTING DRAINAGE RUNOFF. THE TOPSOIL BERM SHALL BE SEEDED AS
- REQUIRED FOR STOCKPILES. 3. IN ADDITION TO THE ABOVE, FURTHER EROSION AND SILTATION CONTROL MEASURES INCLUDING, BUT NOT LIMITED TO SLIT TRENCH SILT TRAPS, STAKED HAYBALES OR BRUSH CHECK DAMS, SHALL ALSO BE EMPLOYED WHERE NECESSARY FOR SUPPLEMENTARY EROSION CONTROL MEASURES.
- 4. ALL CUT SLOPES AND EMBANKMENTS FILLS ARE TO BE IMMEDIATELY LAID BACK AND STABILIZED AS FOLLOWS: A. GRADED TO FINISHED SLOPES
- SCARIFIED TOPSOILED WITH NOT LESS THAN FOUR (4) INCHES OF SUITABLE TOPSOIL MATERIAL. D. SEEDED WITH FOLLOWING GRASS MIXTURE (BY WEIGHT) OR APPROVED EQUAL: 45% KENTUCKY BLUE GRASS 45 % CREEPING RED FESCUE

10 % PERENNIAL RYE GRASS SEED SHALL BE APPLIED AT THE RATE OF NOT LESS THAN TWO (2)POUNDS PER 1000 SQUARE

MULCHED WITH NOT LESS THAN ONE (1) INCH AND NOT MORE THAN THREE (3) INCHES OF STRAW AT TWO (2) TONS/ACRE AND ANCHORED IN A SUITABLE MANNER. WHERE SLOPES EXCEED 1:3, SUITABLY ANCHORED NETTING SUCH AS TENEX N030 OR APPROVED EQUAL SHALL BE UTILIZED.

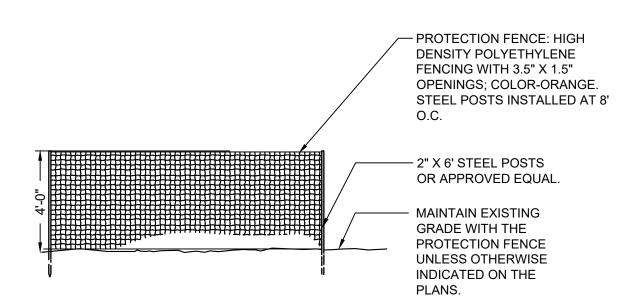

CONSTRUCTION FENCE DETAIL

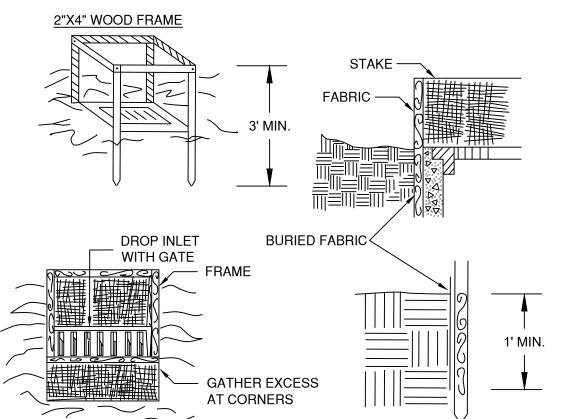

CONSTRUCTION SPECIFICATIONS

1. FILTER FABRIC SHALL HAVE AN EOS OF 40-85. BURLAP MAY BE USED FOR SHORT TERM APPLICATIONS.

2. CUT FABRIC FROM A CONTINUOUS ROLL TO ELIMINATE JOINTS. IF JOINTS ARE NEEDED THEY WILL BE OVERLAPPED TO THE NEXT STAKE.


3. STAKE MATERIALS WILL BE STANDARD 2" x 4" WOOD OR EQUIVALENT. METAL WITH A MINIMUM LENGTH OF 3 FEET.

4. SPACE STAKES EVENLY AROUND INLET 3 FEET APART AND DRIVE A


MINIMUM 18 INCHES DEEP. SPANS GREATER THAN 3 FEET MAY BE BRIDGED WITH THE USE OF WIRE MESH BEHIND THE FILTER FABRIC FOR SUPPORT. 5. FABRIC SHALL BE EMBEDDED 1 FOOT MINIMUM BELOW GROUND AND

BACKFILLED. IT SHALL BE SECURELY FASTENED TO THE STAKES AND FRAME. 6. A 2" x 4" WOOD FRAME SHALL BE COMPLETED AROUND THE CREST OF THE FABRIC FOR OVER FLOW STABILITY.

MAXIMUM DRAINAGE AREA 1 ACRE FILTER FABRIC DROP INLET PROTECTION

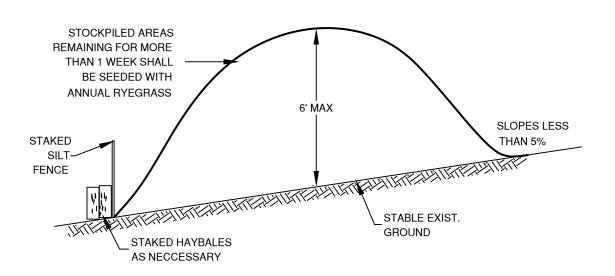


TYPICAL SOIL STOCKPILE DETAIL N.T.S.

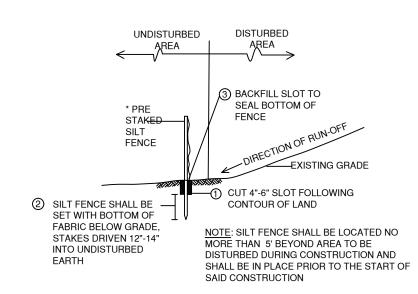

TYPICAL SILT FENCE INSTALLATION


N.T.S.

* USE "KONTROL FENCE " AS MANUFACTURED BY NKOLON (OR APPROVED EQUAL)

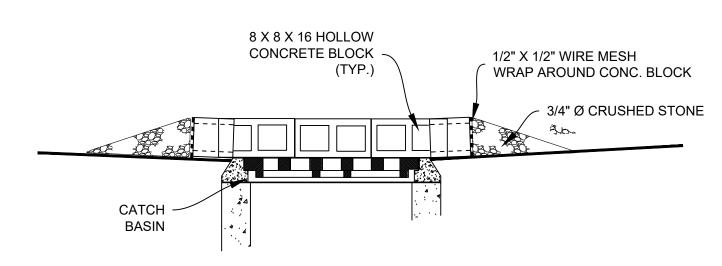

STONE & CONCRETE BLOCK **INLET PROTECTION AT CATCH BASIN**

(TO BE INSTALLED ON ROADS AFTER INSTALLATION OF ITEM #4)

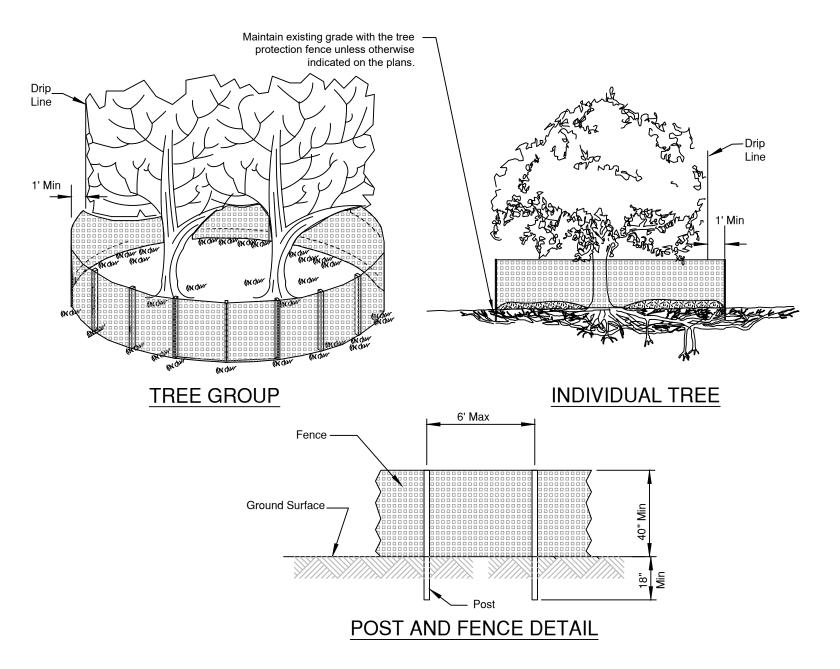

<u>FREE PROTECTION NOTES:</u> THE FENCE SHALL BE LOCATED A MINIMUM OF 1 FOOT OUTSIDE THE DRIP LINE OF THE TREE TO BE


- 2. FENCE POSTS SHALL BE EITHER STANDARD STEEL OR 2" X 6' WOOD POSTS OR APPROVED EQUAL.
- 3. THE FENCE MAY BE EITHER 40" HIGH SNOW FENCE, 40" PLASTIC WEB FENCING OR APPROVED EQUAL.
- 4. NO PRUNING SHALL BE PERFORMED EXCEPT BY APPROVED ARBORIST.


SAVED AND IN NO CASE CLOSER THAN 5 FEET TO THE TRUNK OF ANY TREE.

5. NO EQUIPMENT SHALL OPERATE INSIDE THE PROTECTIVE FENCING INCLUDING DURING FENCE INSTALLATION AND REMOVAL.

EXISTING TREE PROTECTION

- TREE PROTECTION SHALL BE INSTALLED PRIOR TO ANY CONSTRUCTION ACTIVITY. - TREE PROTECTION TO BE INSTTALLED IN COORDINATION WITH THE OWNER AND GROUNDS STAFF

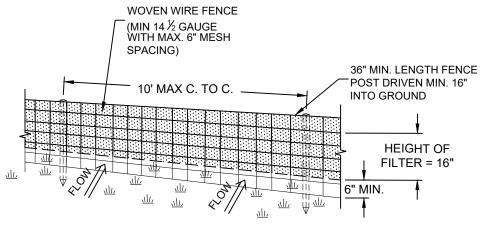

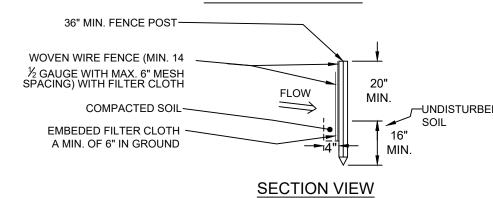

CONSTRUCTION SPECIFICATIONS: 1. WOVEN WIRE FENCE TO BE FASTENED SECURELY TO FENCE POSTS WITH WIRE TIES OR STAPLES. POSTS SHALL BE STEEL WITHER "T" OR "U" TYPE OR HARDWOOD 2. FILTER CLOTH TO BE FASTENED SECURELY TO WOVEN WIRE FENCE WITH TIES

SILT FENCE DETAIL


SPACED EVERY 24" AT TOP AND MID SECTION. FENCE SHALL BE WOVEN WIRE, 6" MAXIMUM MESH OPENING 3. WHEN TWO SECTIONS OF FILTER CLOTH ADJOIN EACH OTHER THEY SHALL BE OVER-LAPPED BY SIX INCHES AND FOLDED. FILTER CLOTH SHALL BE EITHER FILTER X,

MIRAFI 100X. STABILINKA T140N. OR APPROVED EQUIVALENT. 4. PREFABRICATED UNITS SHALL BE GEOFAB, ENVIROFENCE, OR APPROVED EQUIVALENT. 5. MAINTENANCE SHALL BE PERFORMED AS NEEDED AND MATERIAL REMOVED WHEN "BULGES" DEVELOP IN THE SILT FENCE.

CALL BEFORE YOU DIG 1-800-962-7962 UNDER THE NY STATE LAW PROTECTING UNDERGROUND FACILITIES, THE FOLLOWING RULES AND REGULATIONS ARE IN EFFECT FOR ALL EXCAVATORS:

* THEY MUST CALL FOR A UTILITY STAKE-OUT (2) TWO FULL WORKING DAYS PRIOR TO AN EXCAVATION. $^{\star}\,$ THEY MUST CONFIRM PRECISE LOCATIONS OF UNDERGROUND FACILITIES. * THEY MUST PRESERVE STAKES AND MARKINGS UNTIL NO LONGER NEEDED AT SITE. * THEY MUST CONTACT NON-UFPO MEMBER UTILITY OWNERS FOR STAKE-OUTS.

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SOMERS, NEW YORK 10589

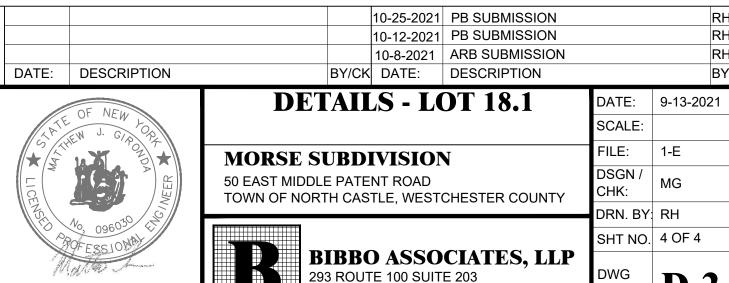TEL. 914 277 5805


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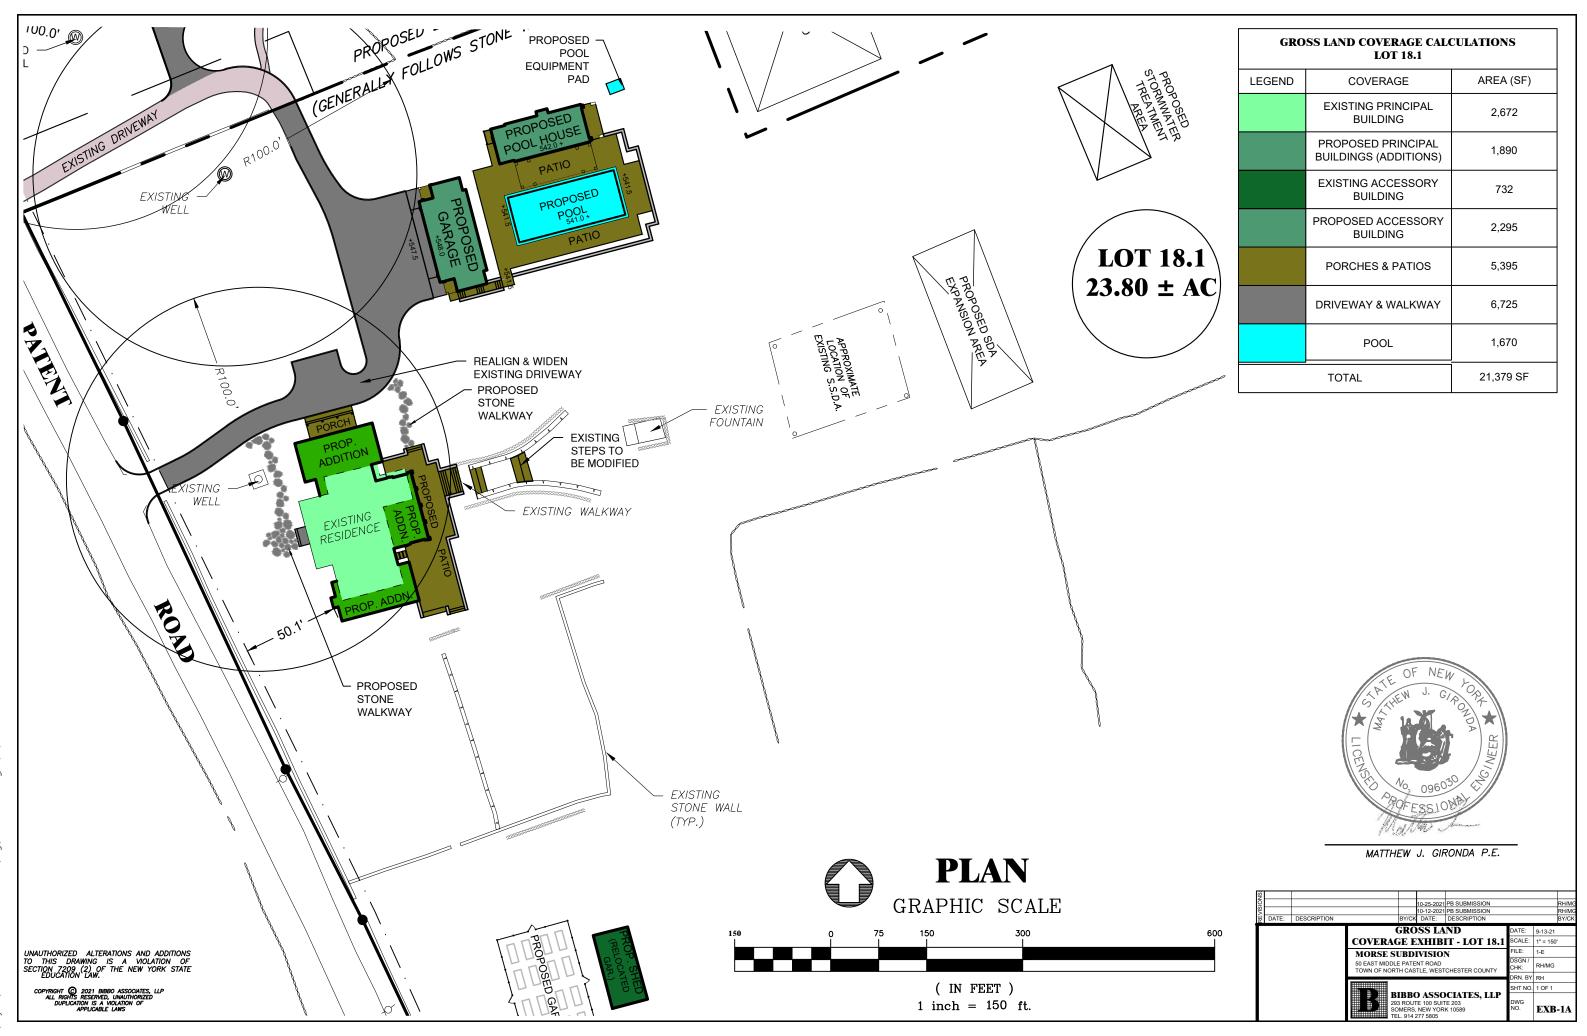
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SHOP DRAWINGS OF ALL CIVIL COMPONENTS SHOULD BE PROVIDED TO OUR OFFICE

FOR THE REVIEW AND APPROVAL PRIOR TO PRODUCTION / PURCHASING





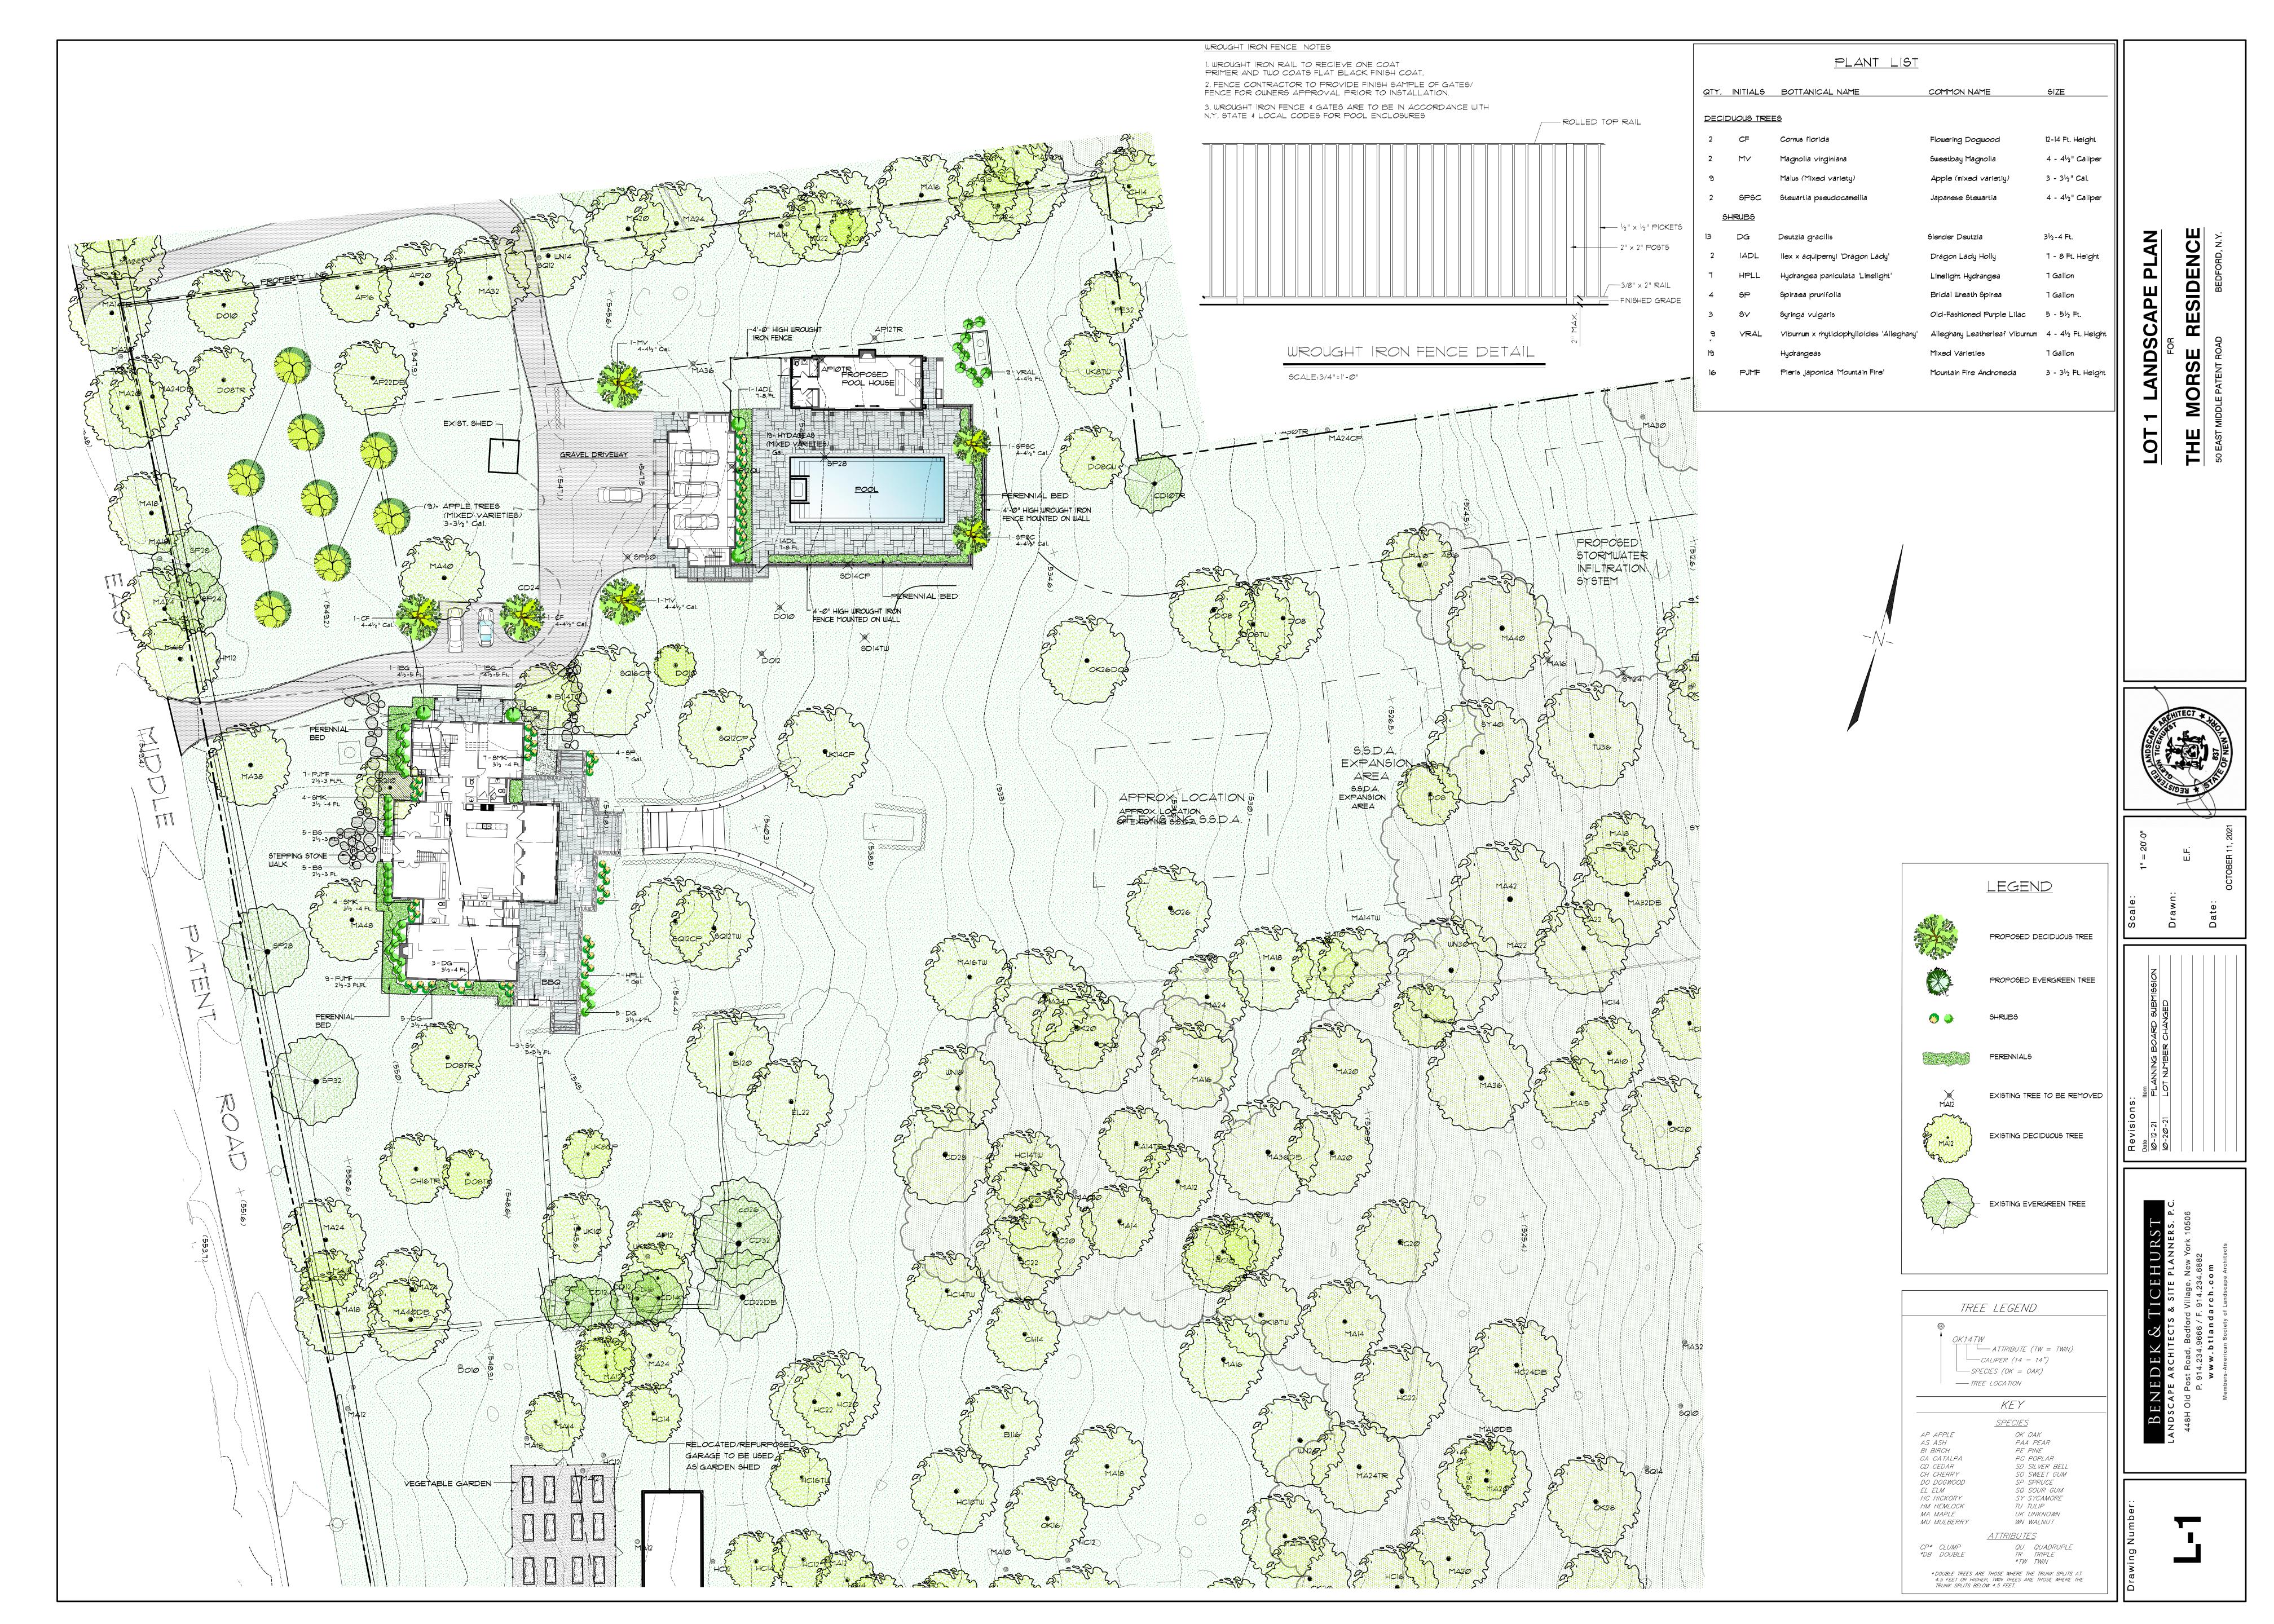

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TOWN OF NORTH CASTLE


WESTCHESTER COUNTY 17 Bedford Road Armonk, New York 10504-1898

PLANNING DEPARTMENT Adam R. Kaufman, AICP Director of Planning


Telephone: (914) 273-3542 Fax: (914) 273-3554 www.northcastleny.com


GROSS LAND COVERAGE CALCULATIONS WORKSHEET

Арр	plication Name or Identifying Title: Morse - 50 East Middle Patent Road	Date: 9/13/21
Tax	Map Designation or Proposed Lot No.: 103.01-1-18 - Proposed Lot 18.1	REV. 10/12/21
		REV. 10/25/21
Gro	ess Lot Coverage	
1.	Total lot Area (Net Lot Area for Lots Created After 12/13/06):	23.80 ac.
2.	Maximum permitted gross land coverage (per Section 355-26.C(1)(a)):	84,481sq. ft.
3.	BONUS maximum gross land cover (per Section 355-26.C(1)(b)):	
	Distance principal home is beyond minimum front yard setback x 10 =	0
4.	TOTAL Maximum Permitted gross land coverage = Sum of lines 2 and 3	84,375 sq. ft.
5.	Amount of lot area covered by principal building:	
	<u>2,672</u> existing + <u>1,890</u> proposed =	4,562 sq. ft.
6.	Amount of lot area covered by accessory buildings: 732 existing + 2.295 proposed =	3,027 sq. ft.
7.	Amount of lot area covered by decks: existing + proposed =	
8.	Amount of lot area covered by porches: existing + proposed =	5,395 sq. ft.
9.	Amount of lot area covered by driveway, parking areas and walkways: existing + 6,725 proposed =	6,725 sq. ft.
10.	Amount of lot area covered by terraces: existing + proposed =	
11.	Amount of lot area covered by tennis court, pool and mechanical equip: existing + proposed =	1,670 sq. ft.
12.	Amount of lot area covered by all other structures: existing + proposed =	
13.	Proposed gross land coverage: Total of Lines $5 - 12 = 0$	21,379 sq. ft.
does	ne 13 is less than or equal to Line 4, your proposal complies with the Town's maximum groject may proceed to the Residential Project Review Committee for review. If Line 13 is not comply with the Town's regulations. 10-2 10-2	
	096030	

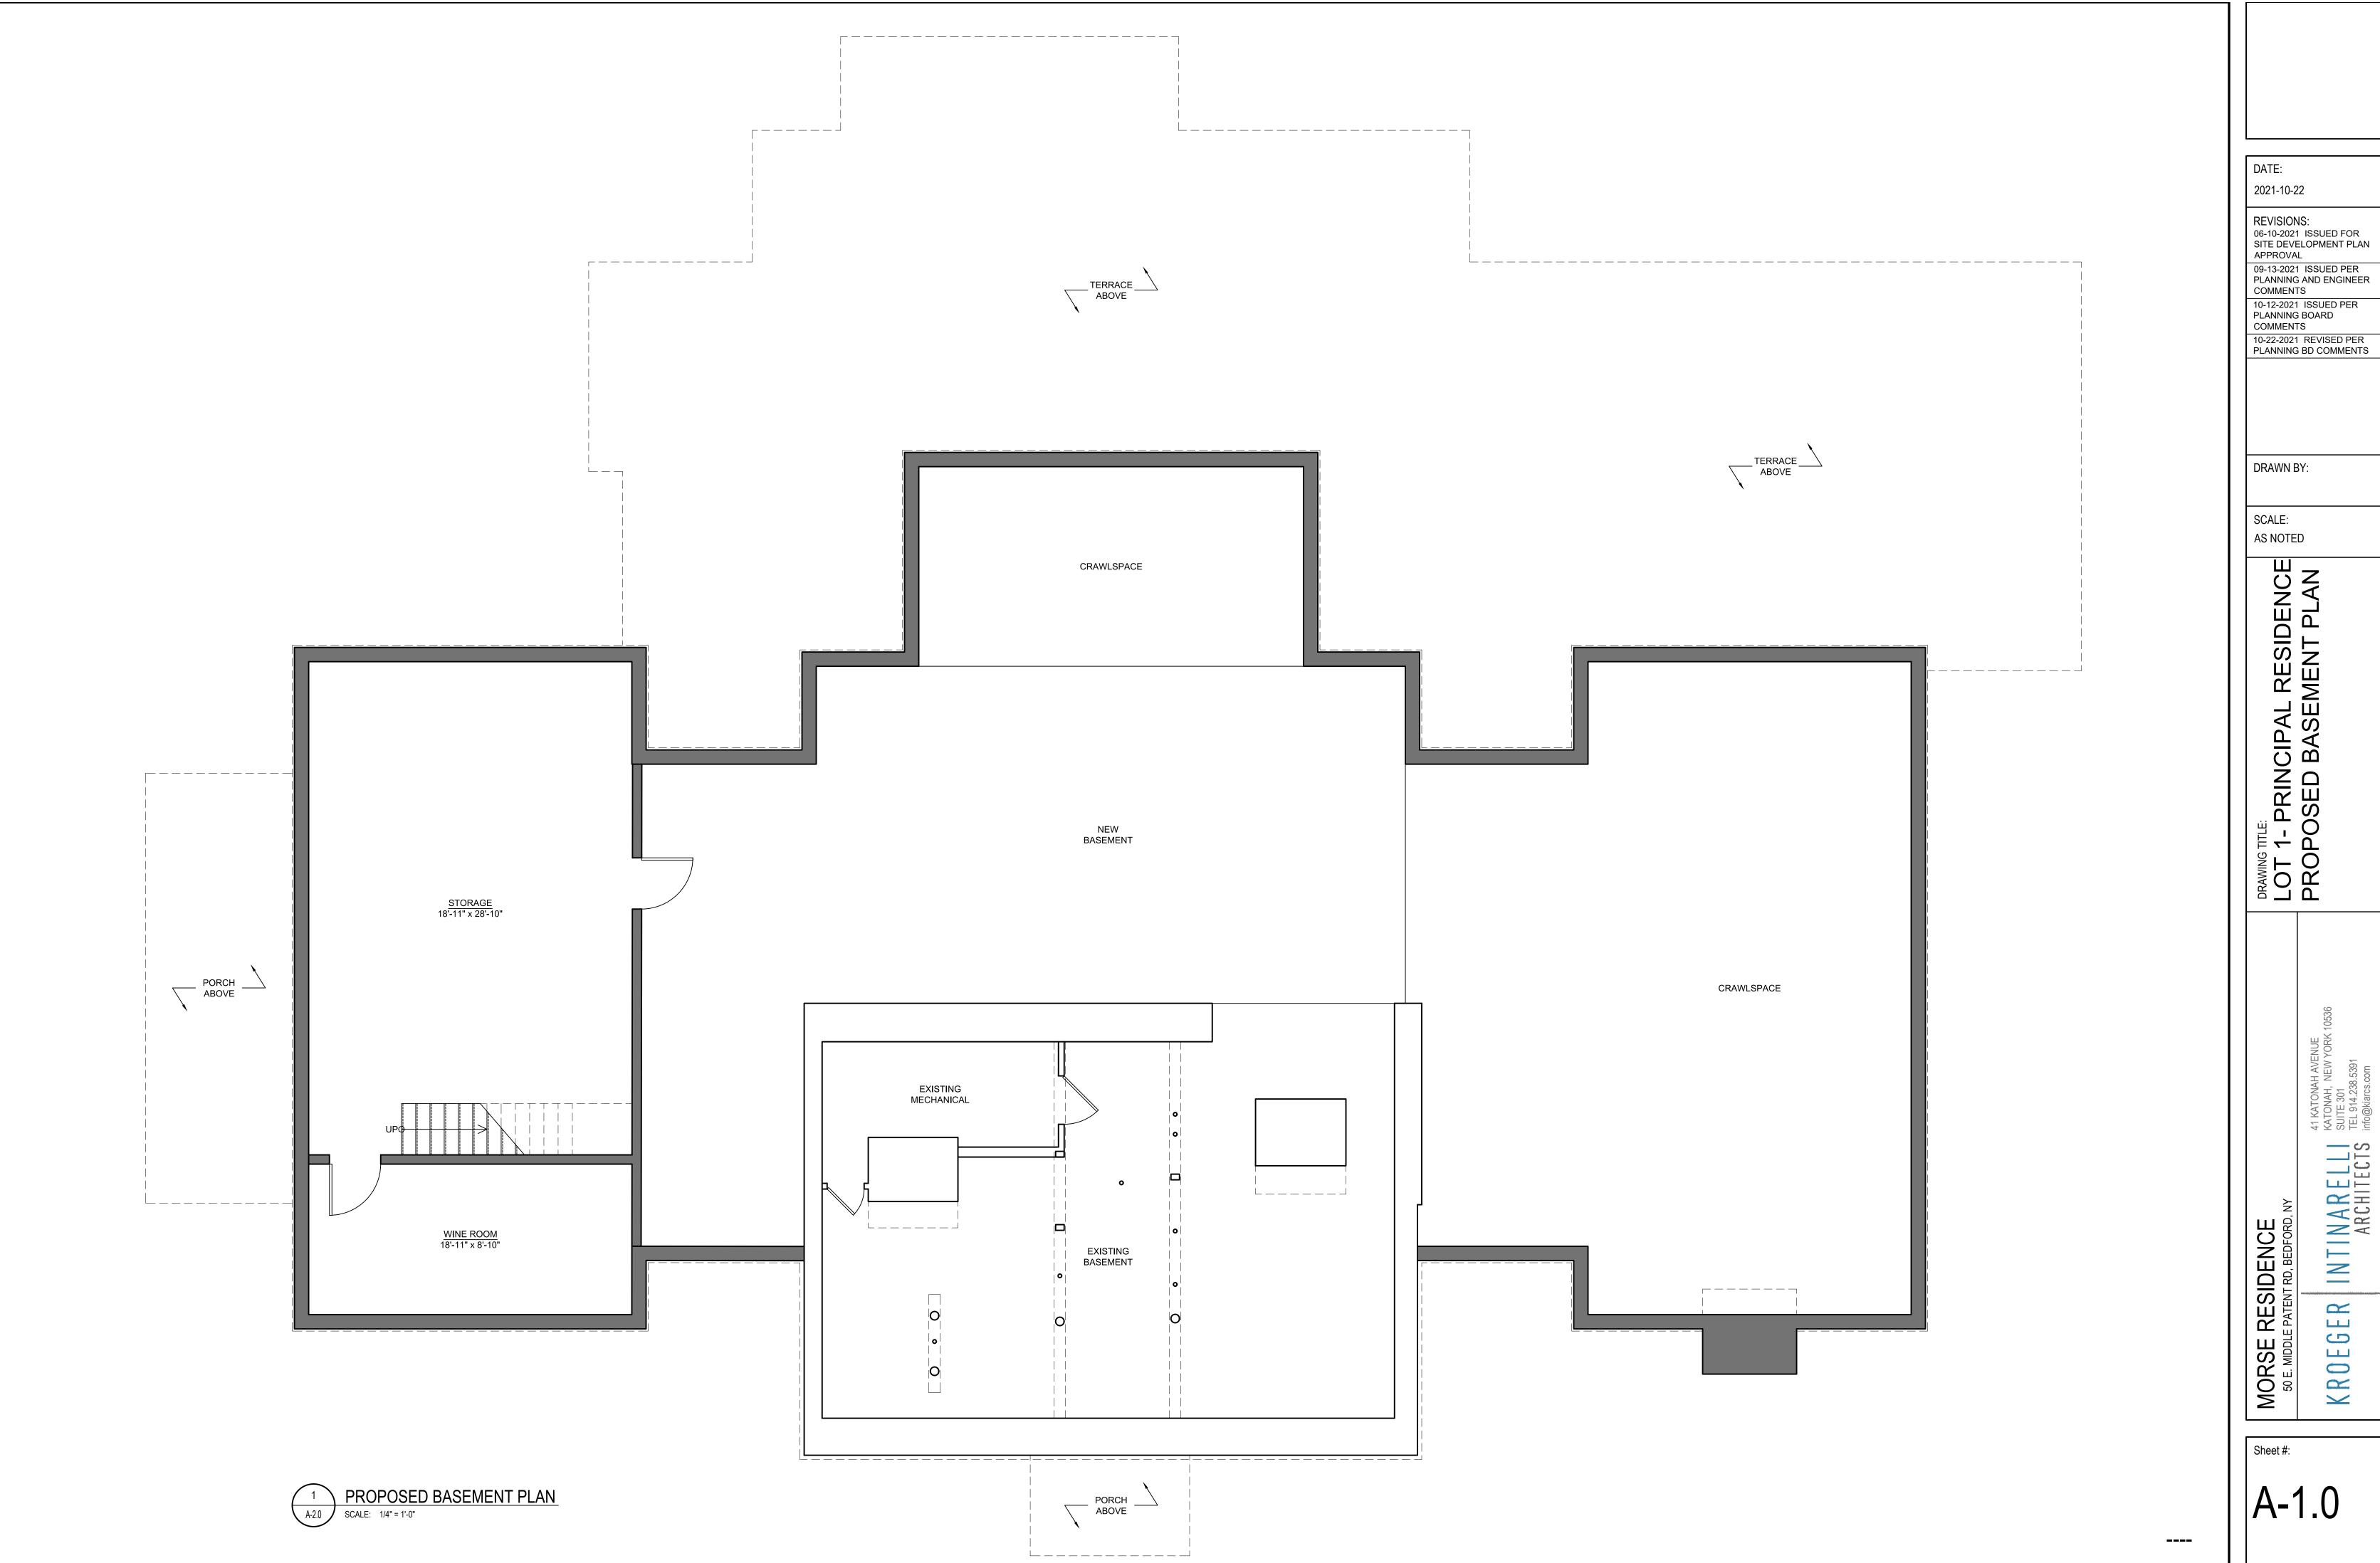

09-13-2021 ISSUED PER PLANNING AND ENGINEER

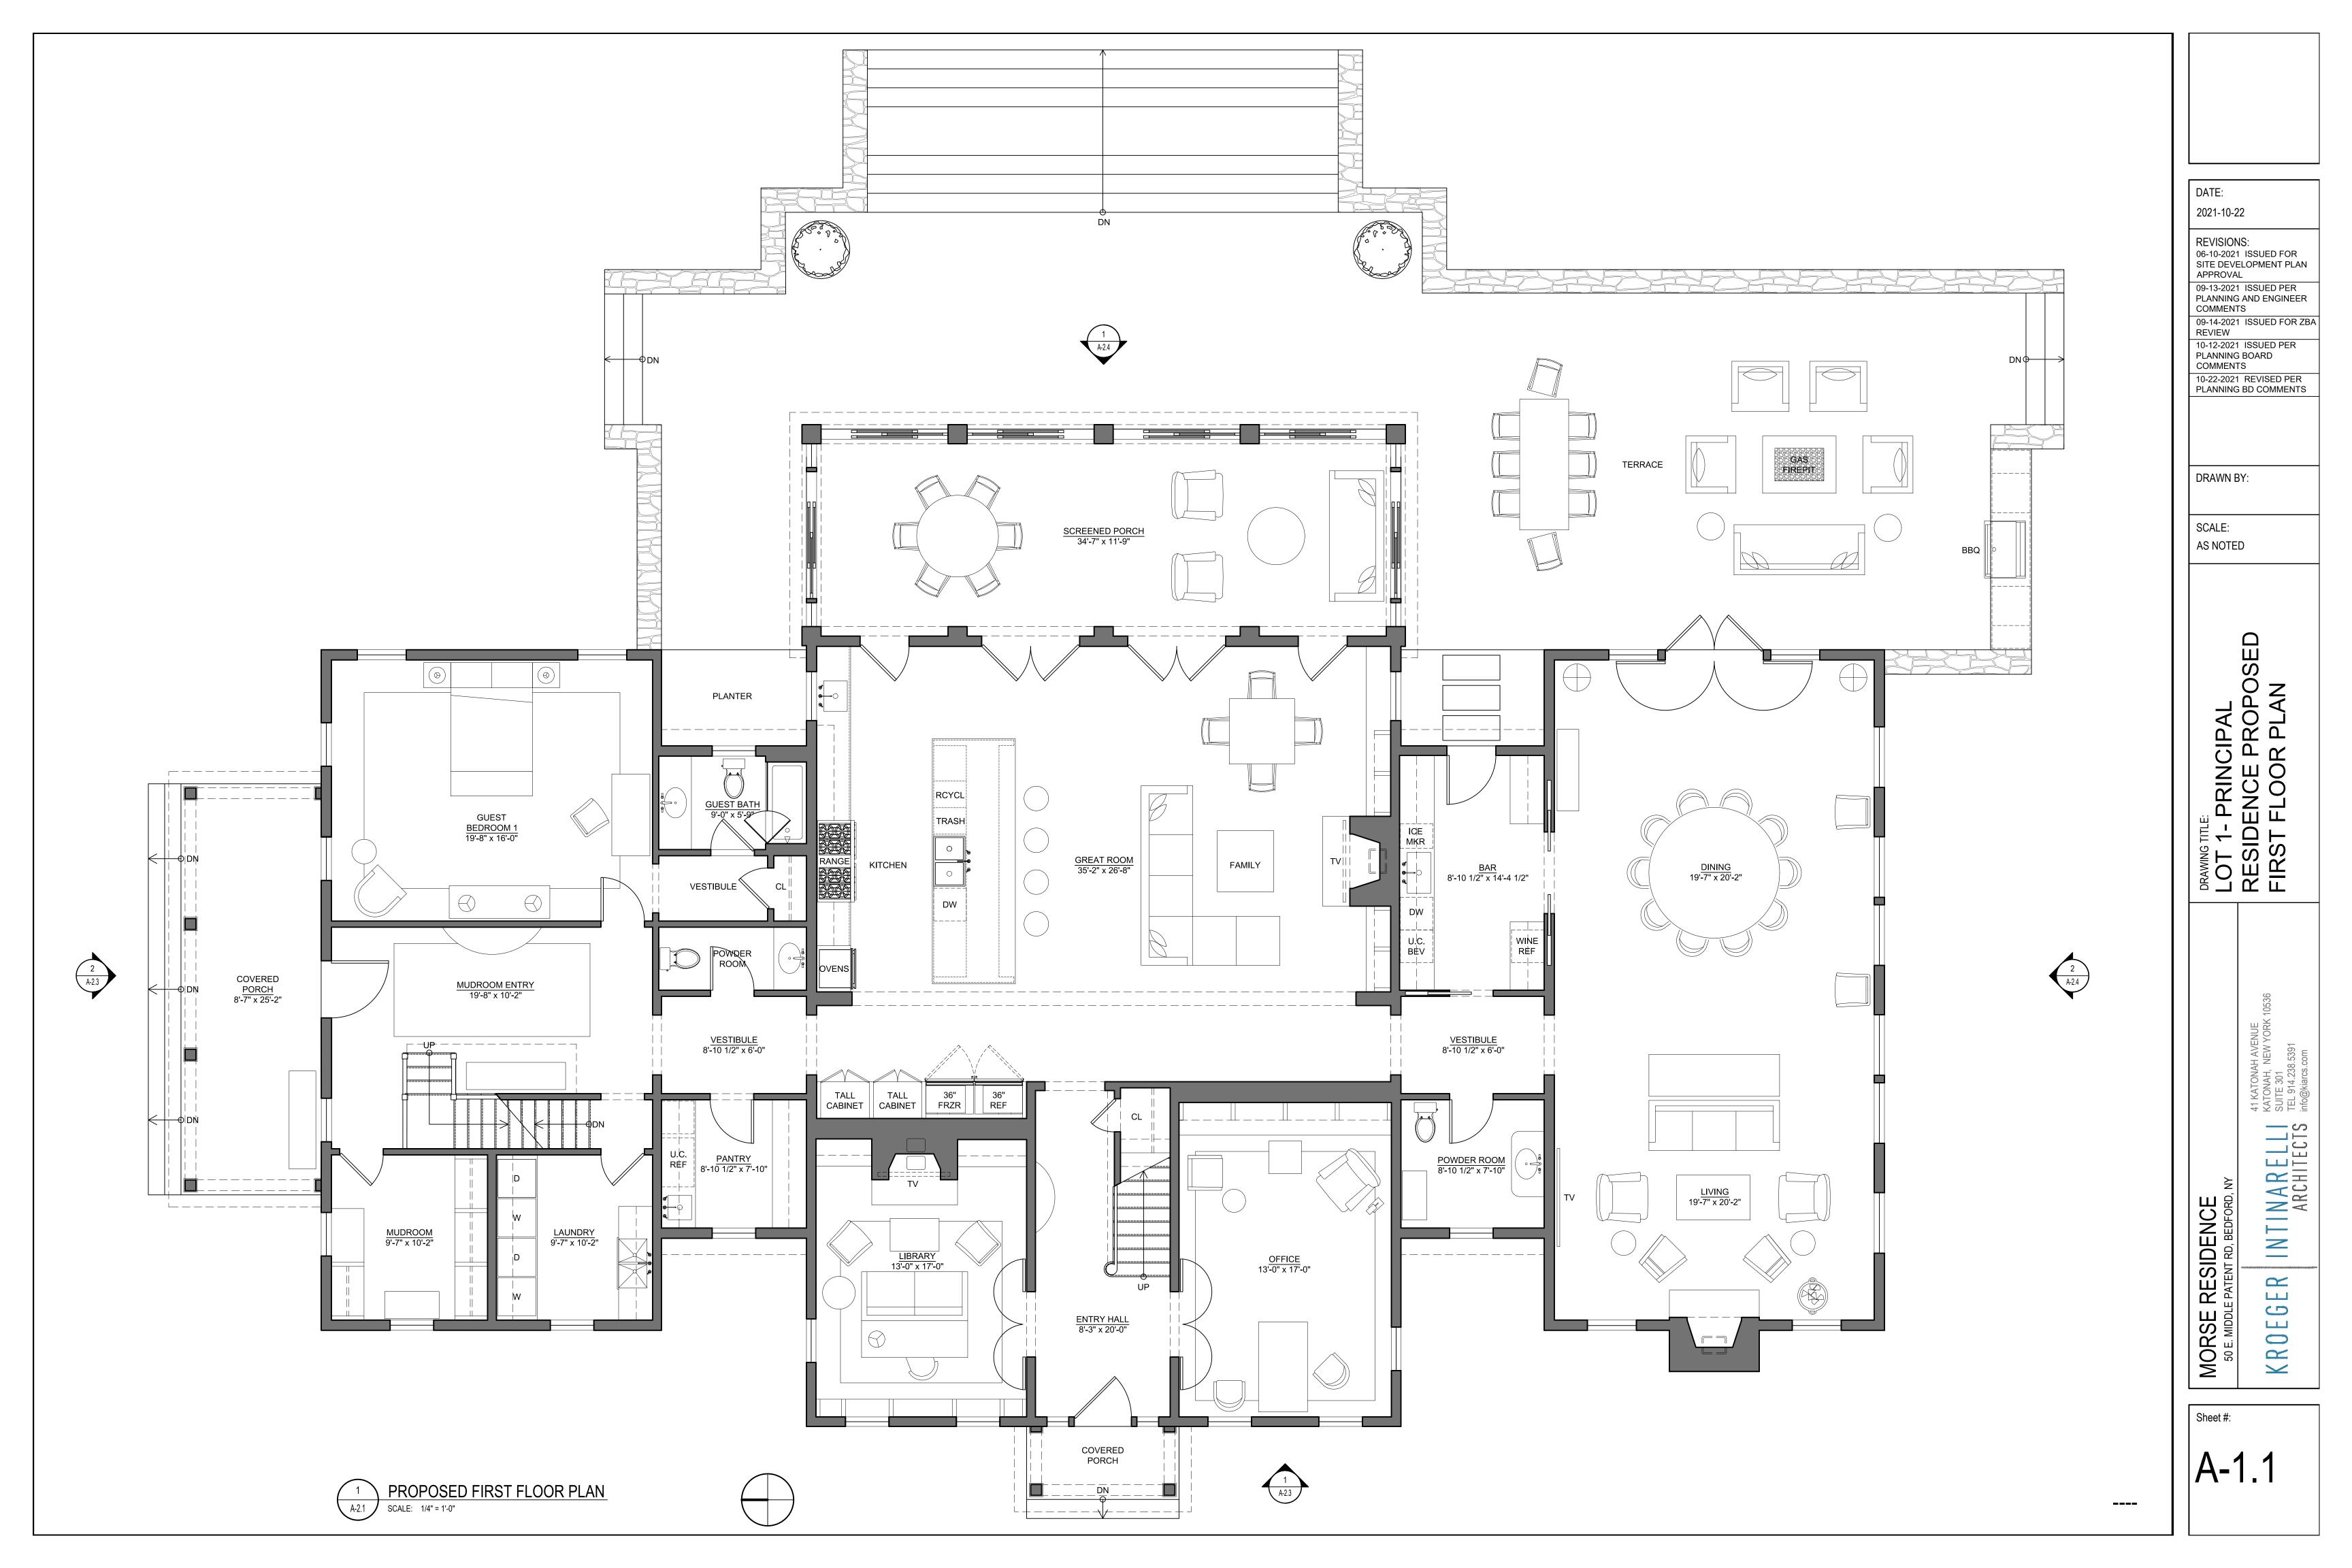

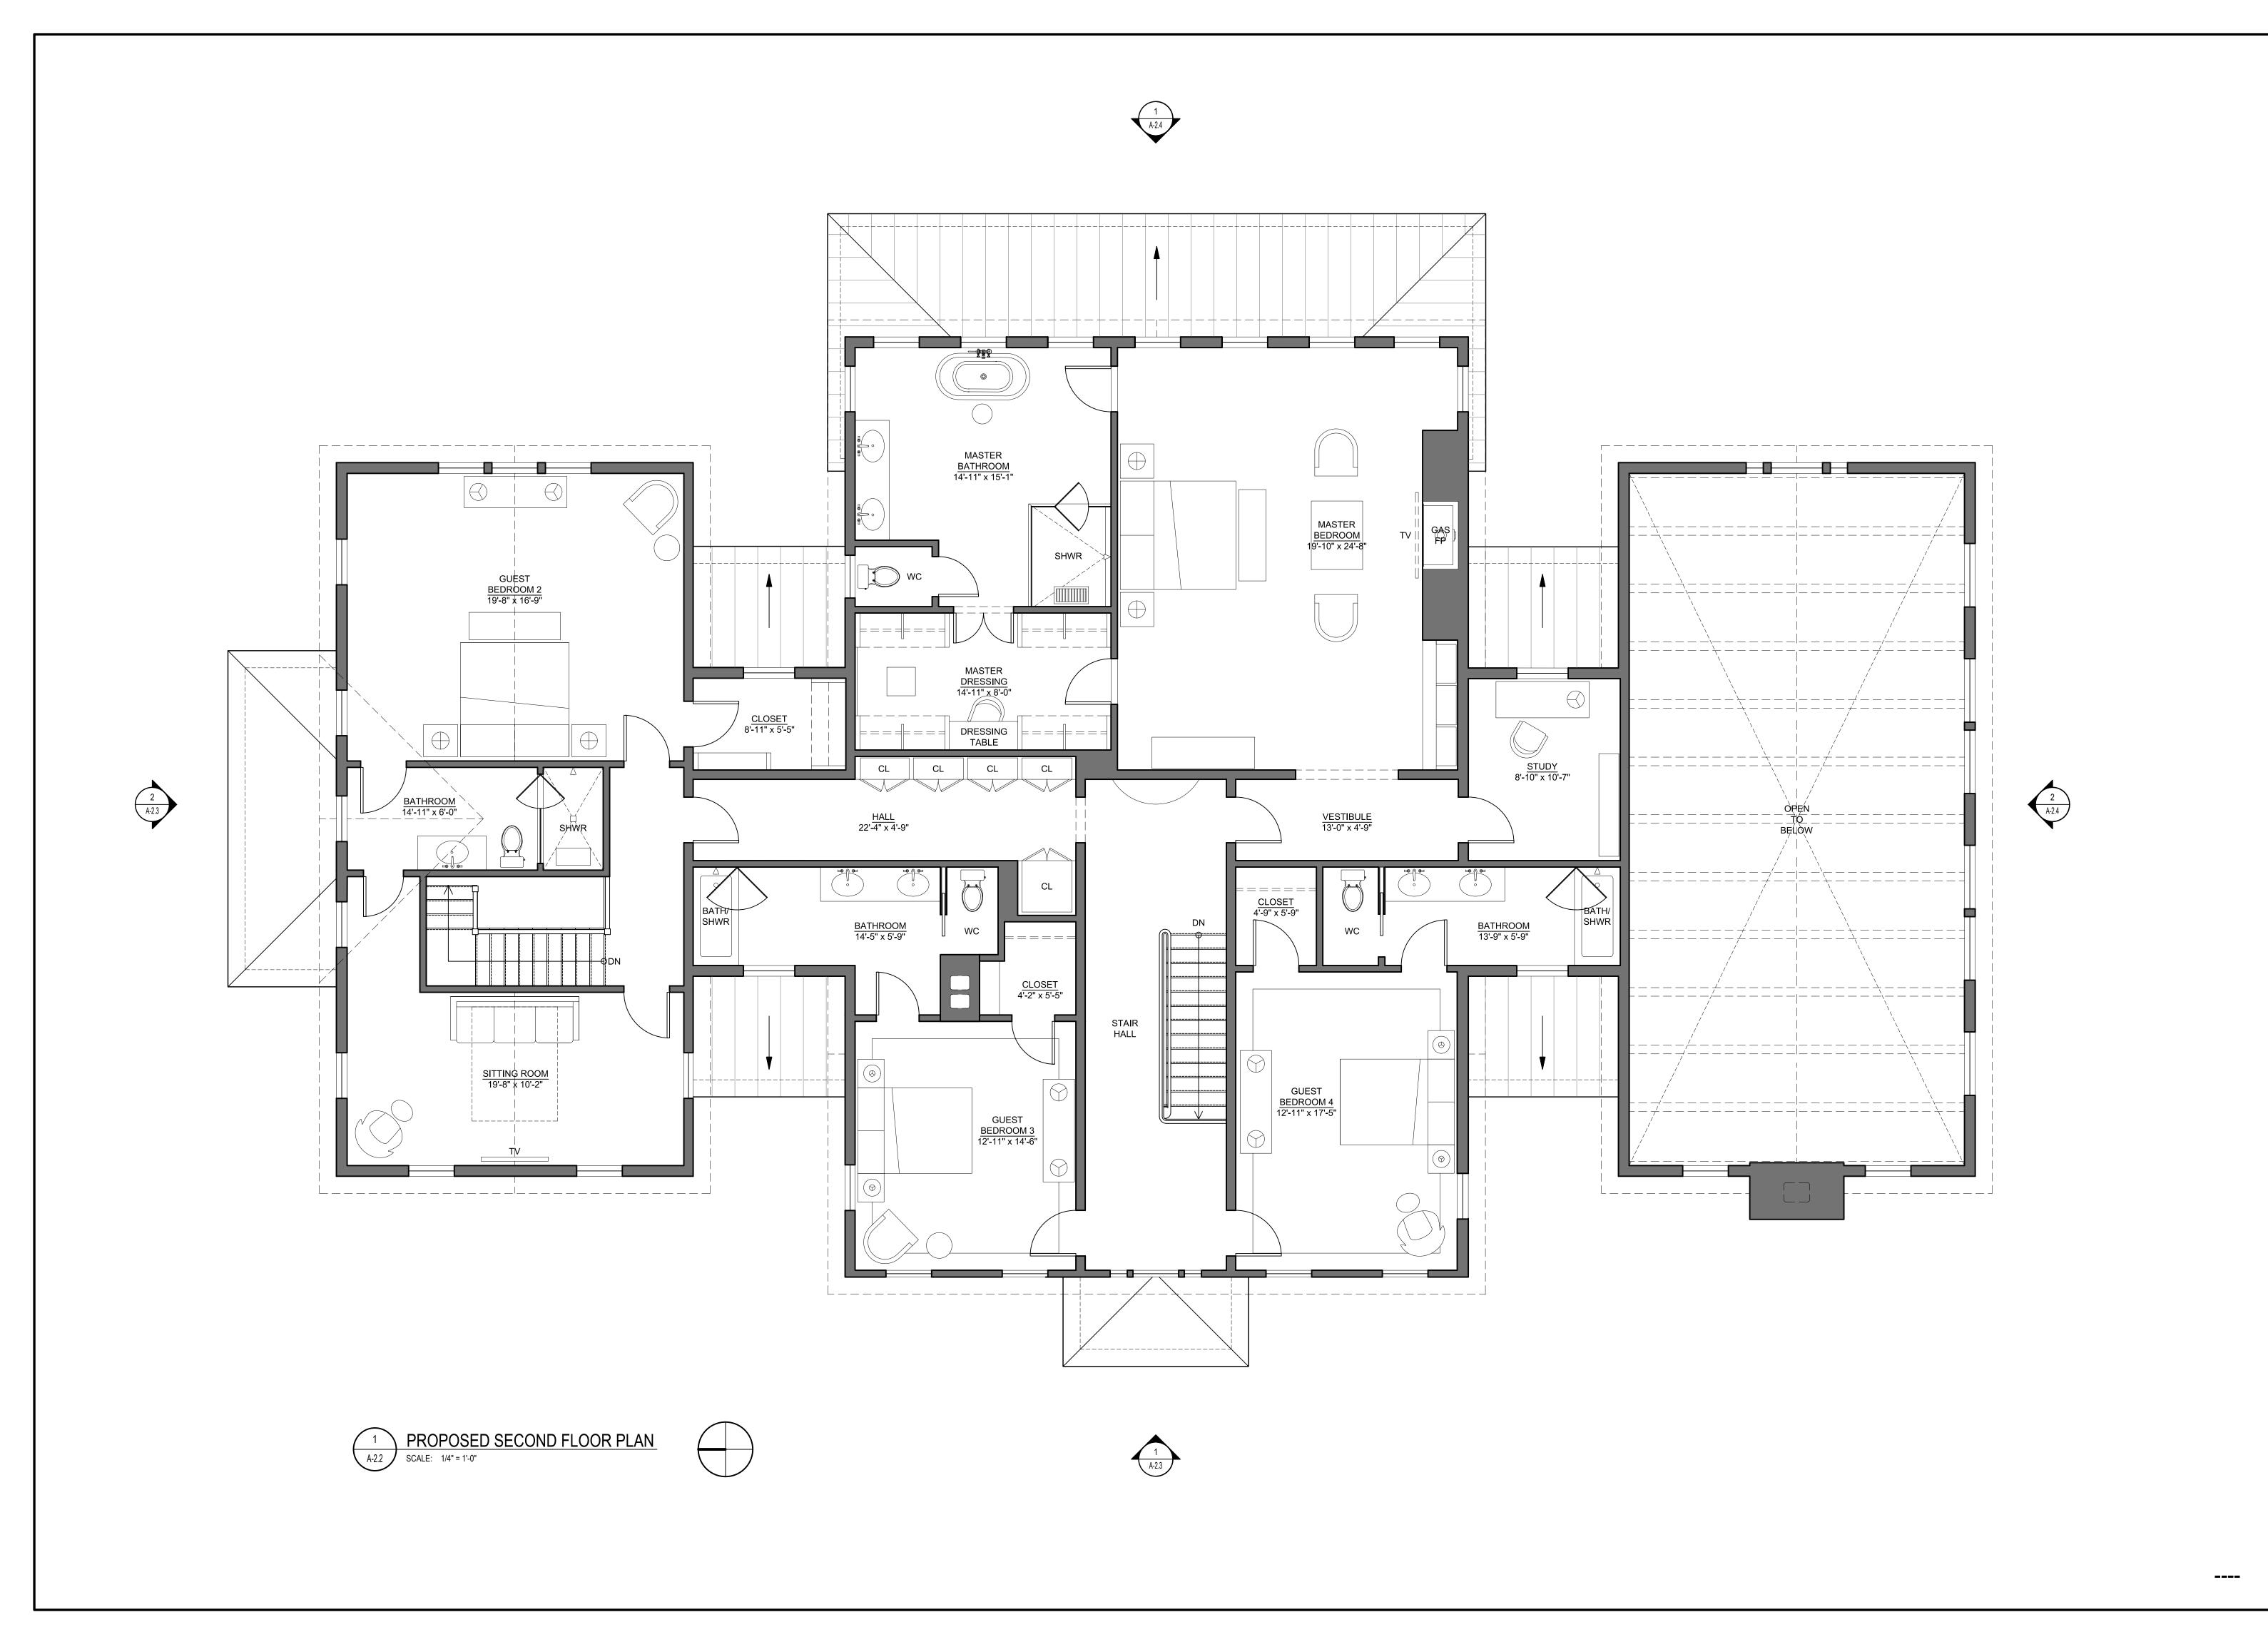

DATE: 2021-10-22

REVISIONS: 06-10-2021 ISSUED FOR SITE DEVELOPMENT PLAN

APPROVAL 09-13-2021 ISSUED PER PLANNING AND ENGINEER COMMENTS 09-14-2021 ISSUED FOR ZBA

REVIEW 10-12-2021 ISSUED PER PLANNING BOARD COMMENTS

10-22-2021 REVISED PER PLANNING BD COMMENTS

DRAWN BY:

SCALE: AS NOTED

PRINCIPAL RESIDENCE SED SECOND FLOOR


INTINARELLI ARCHITECTS

MORSE RESIDENCE 50 E. MIDDLE PATENT RD. BEDFORD KROEGI

Sheet #:





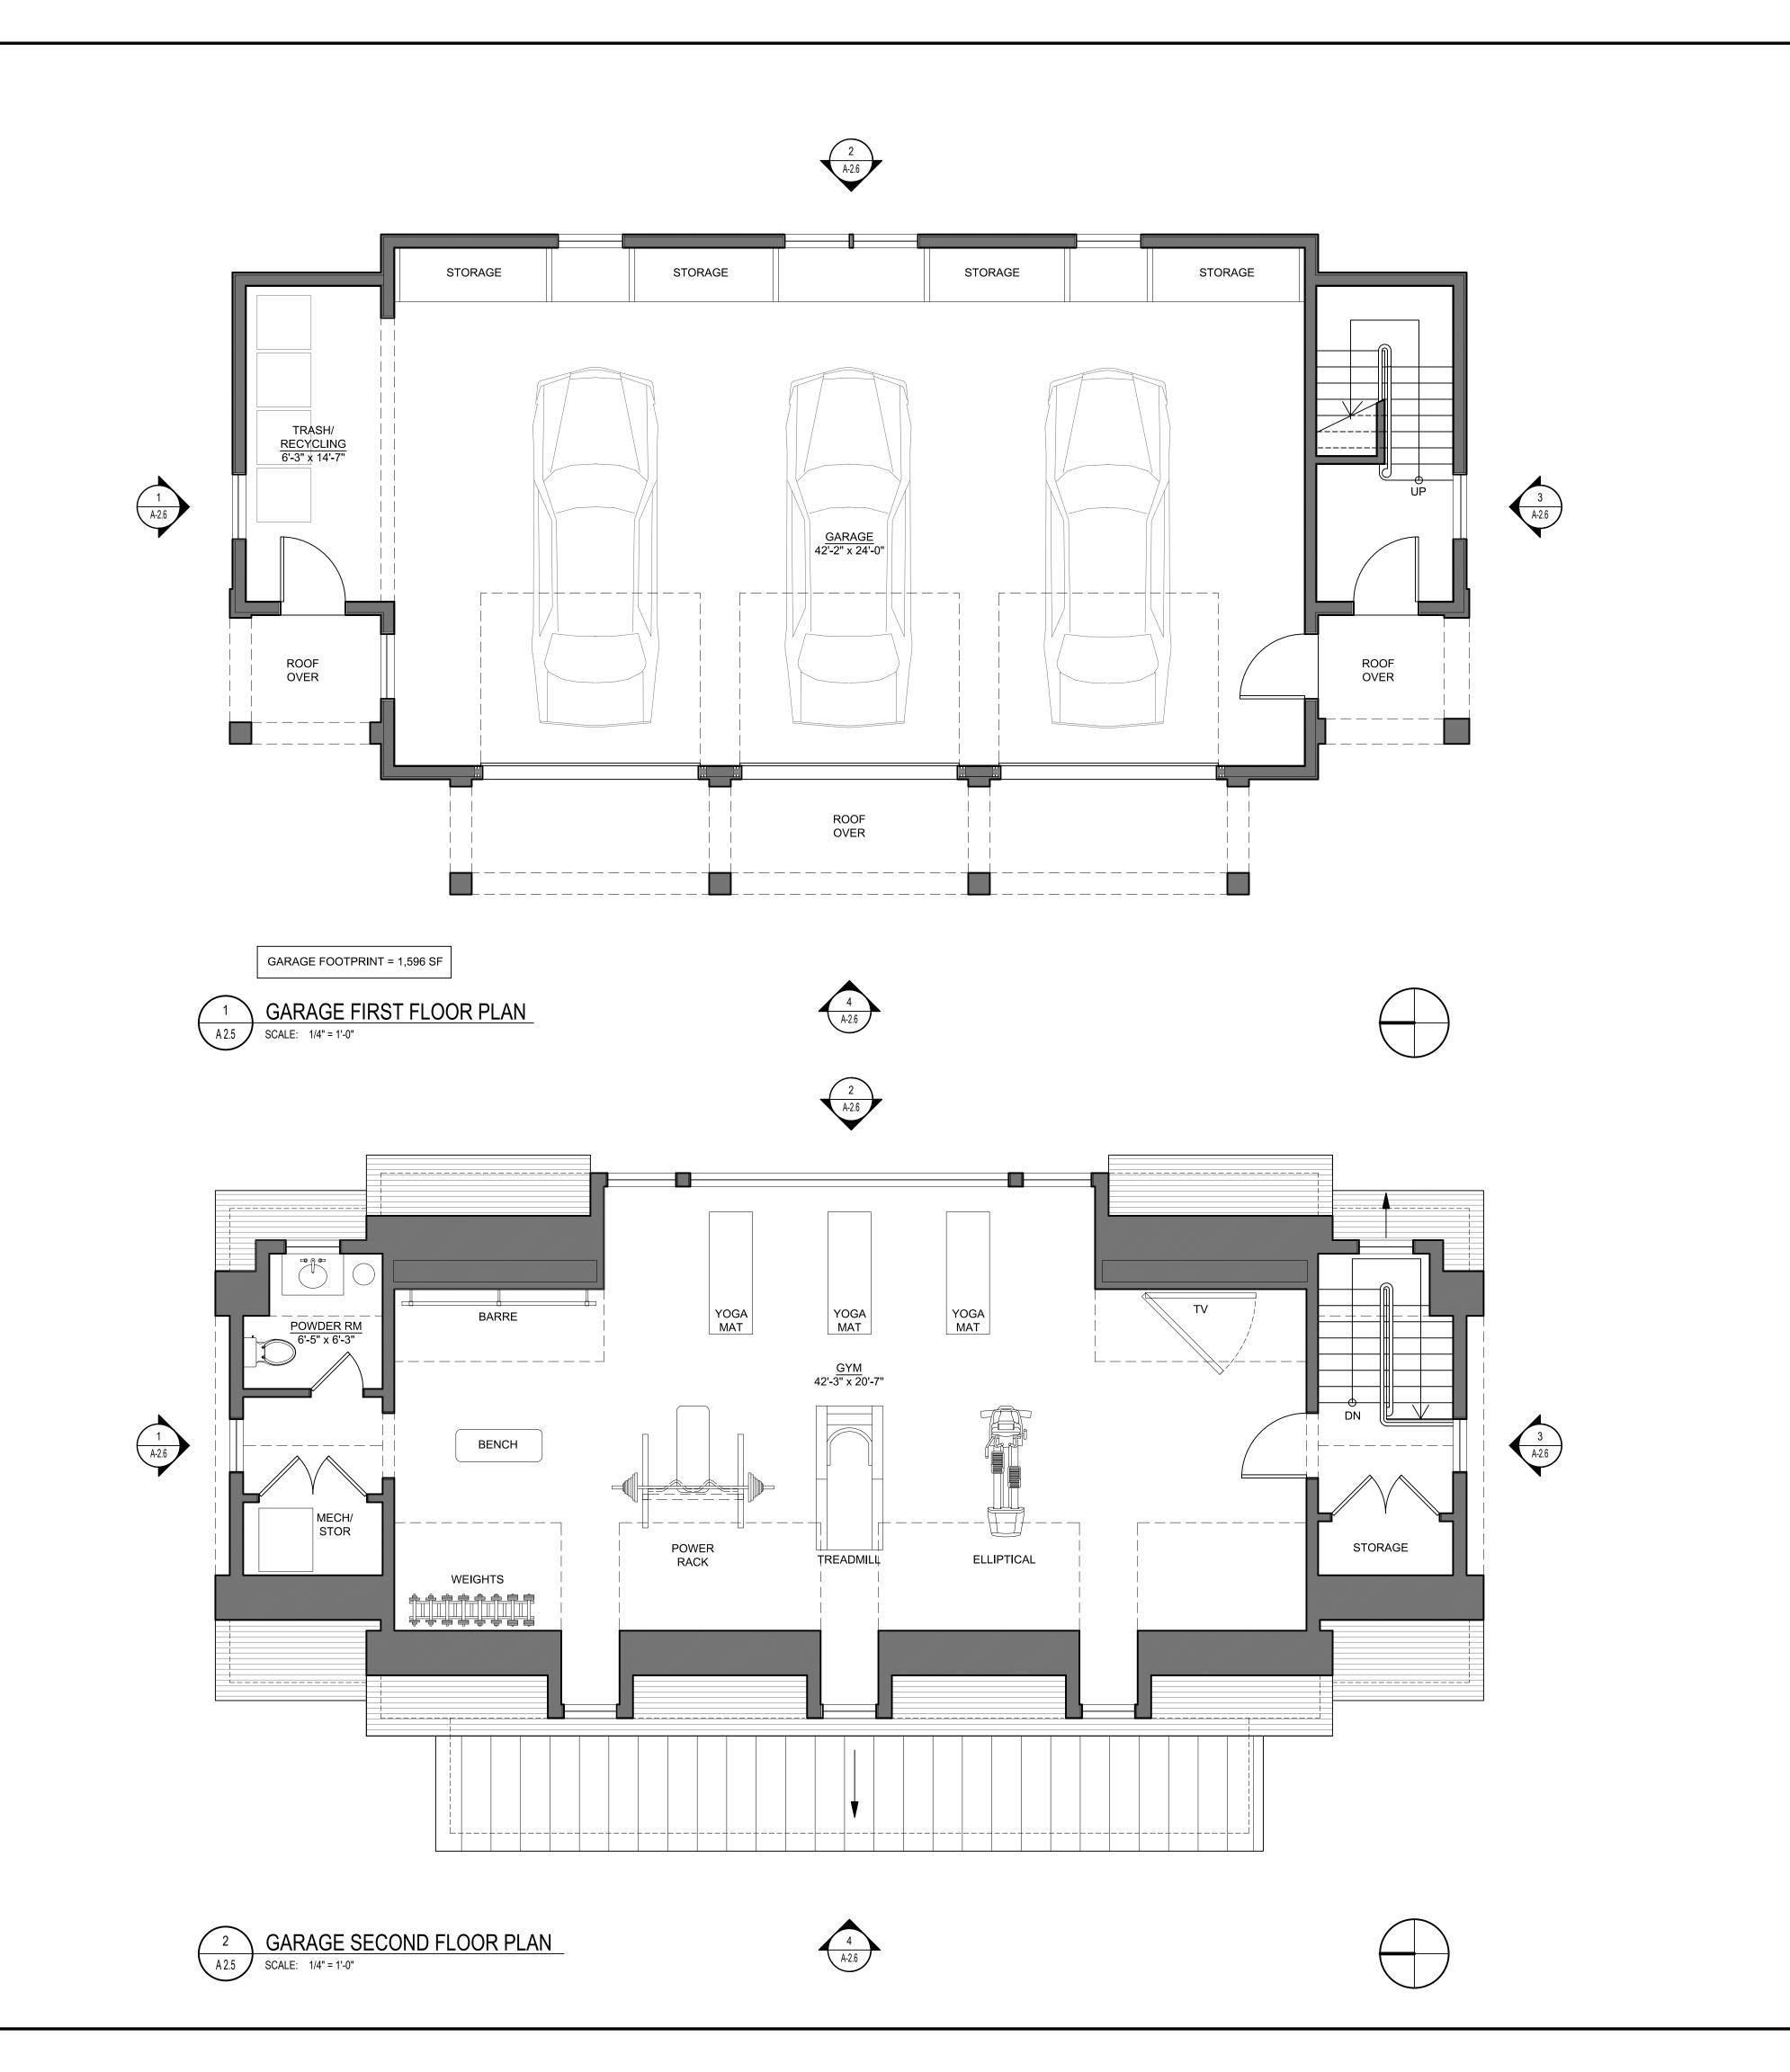

DATE:
2021-10-22

REVISIONS:
06-10-2021 ISSUED FOR
SITE DEVELOPMENT PLAN
APPROVAL

09-13-2021 ISSUED PER
PLANNING AND ENGINEER
COMMENTS

10-12-2021 ISSUED PER
PLANNING BOARD
COMMENTS

10-22-2021 REVISED PER
PLANNING BD COMMENTS

DRAWN BY:

SCALE: AS NOTED

SAWING TITLE:
OT 1- PROPOSED GARAGE
GYM FLOOR PLANS

41 KATONAH AVENUE KATONAH, NEW YORK 10536 SUITE 301 TEL 914.238.5391

FENT RD, BEDFORD, NY


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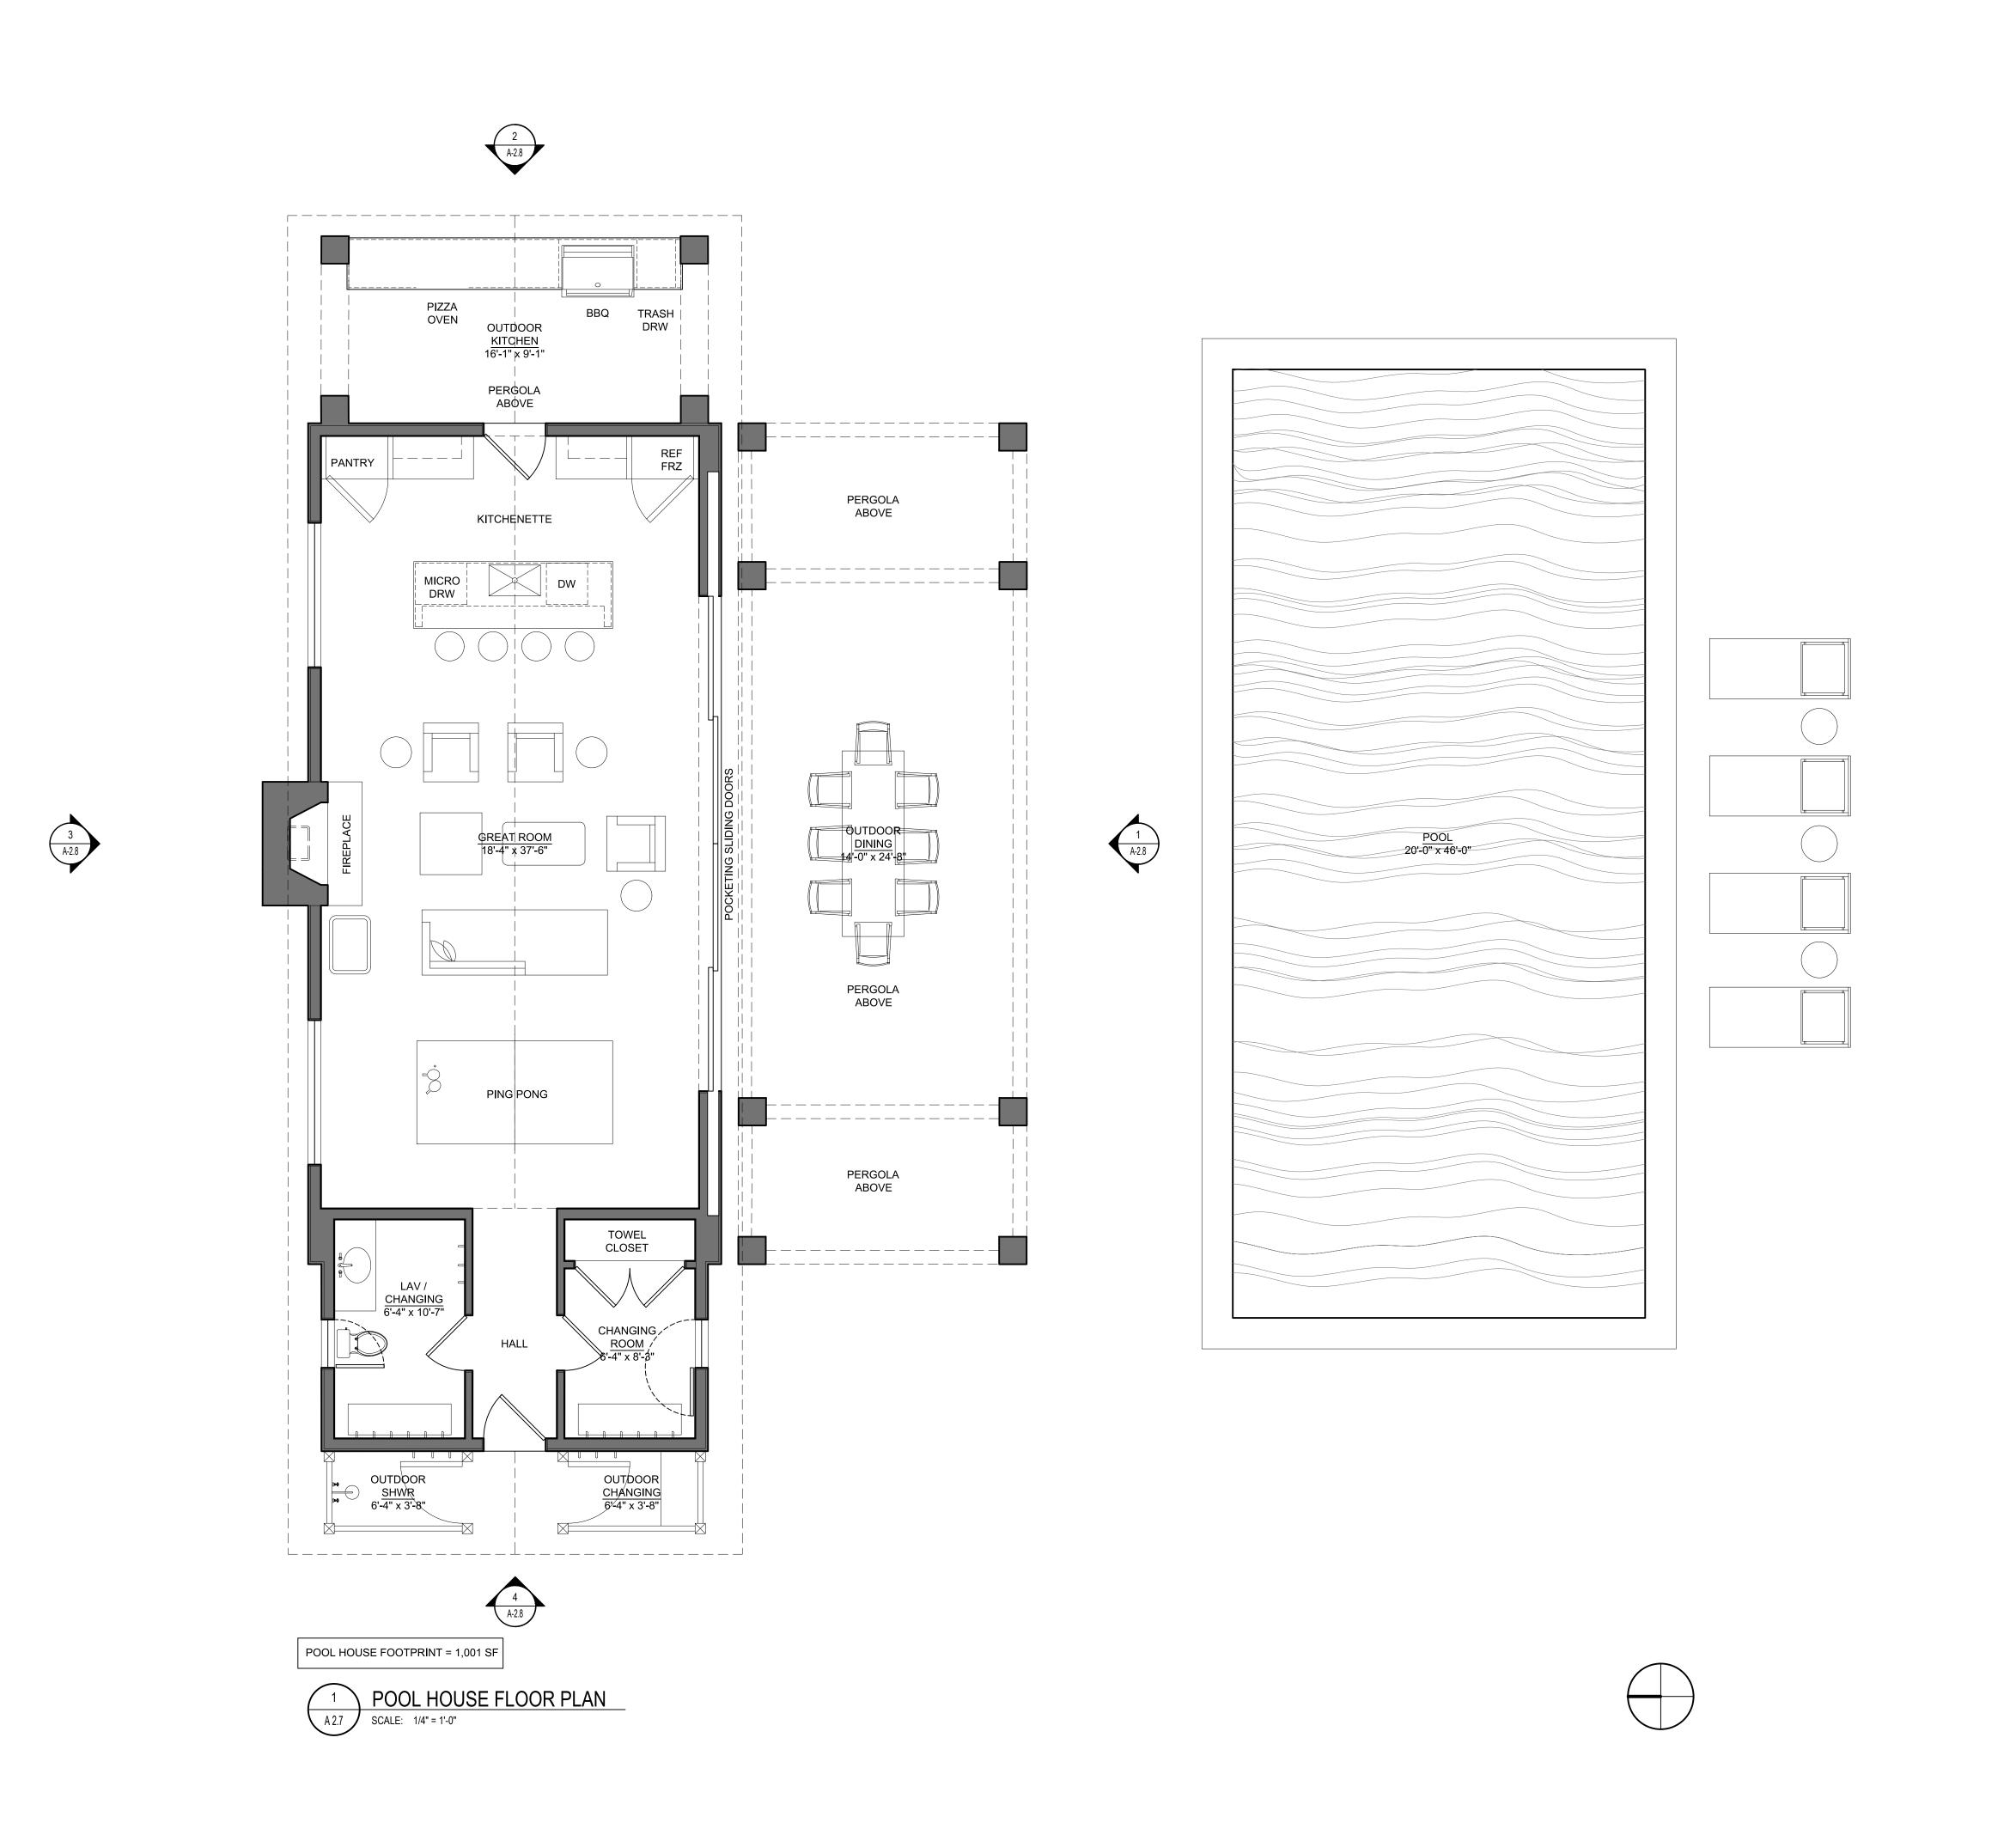
ARCHITECTS

MORSE RESIDENCE 50 E. MIDDLE PATENT RD, BEDFORD, K R O E G E R INTINA

Sheet #:

A-1.5




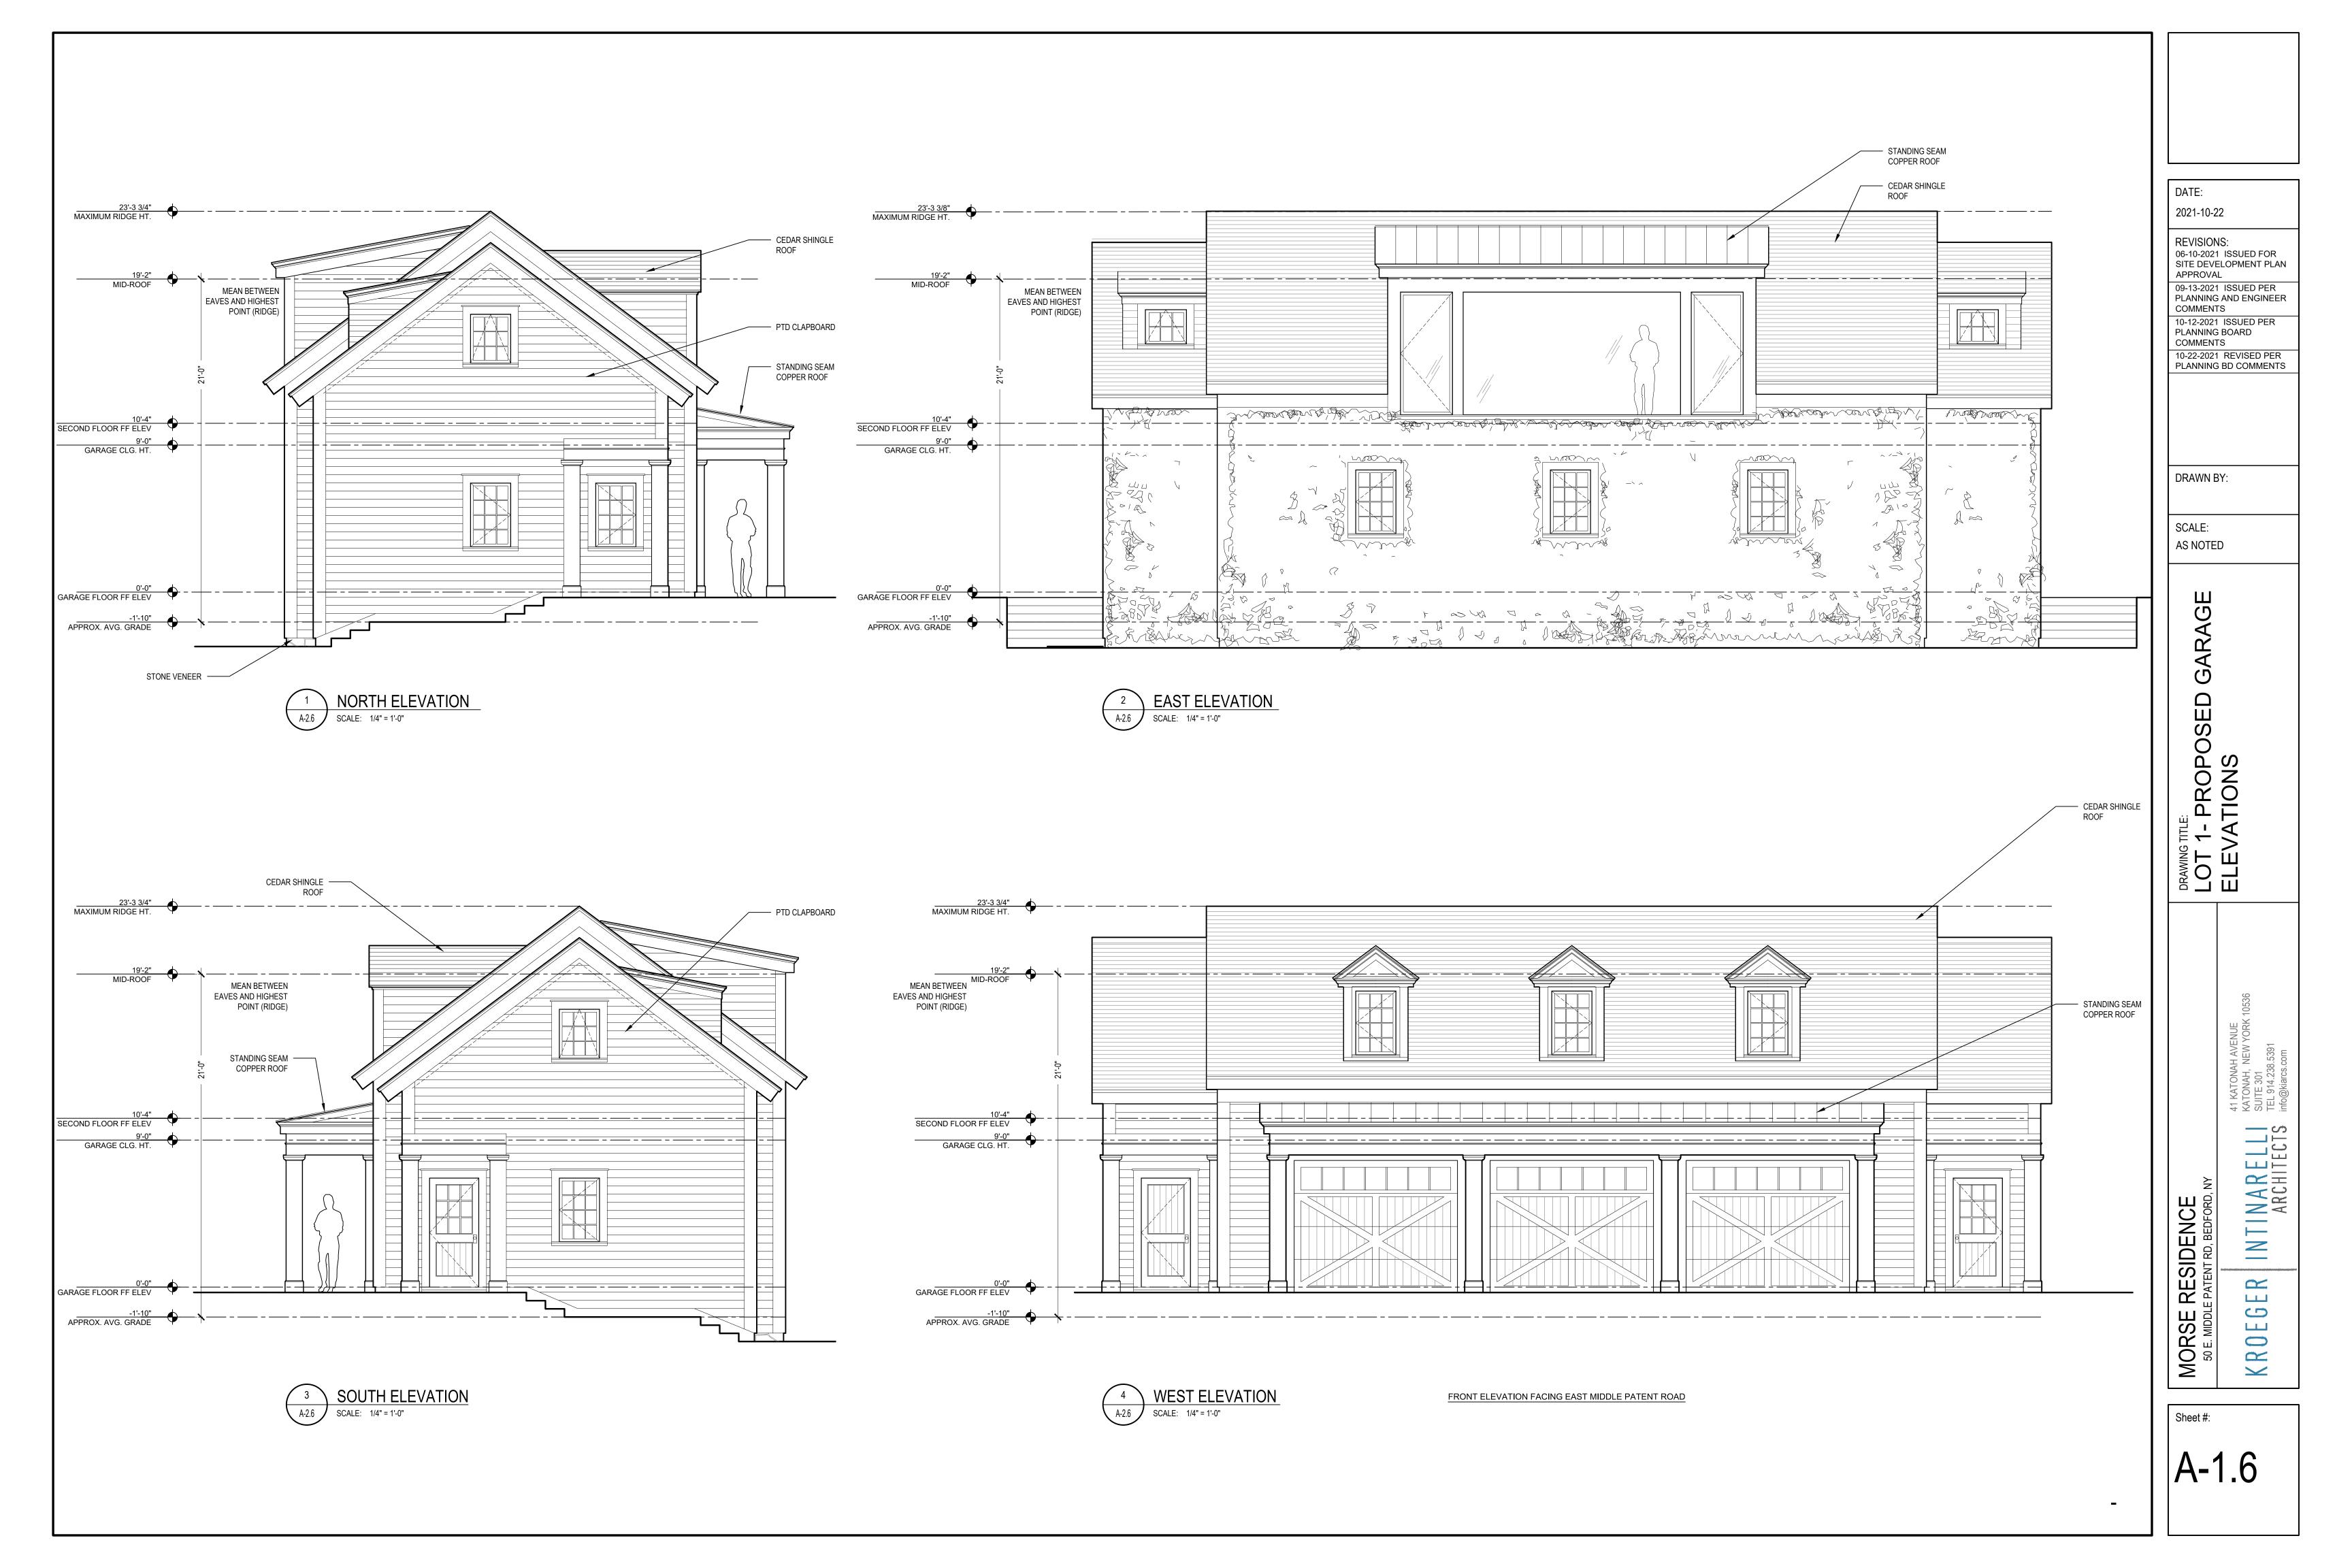


DATE: 2021-10-22 REVISIONS: 06-10-2021 ISSUED FOR SITE DEVELOPMENT PLAN APPROVAL 09-13-2021 ISSUED PER PLANNING AND ENGINEER COMMENTS 10-12-2021 ISSUED PER PLANNING BOARD COMMENTS 10-22-2021 REVISED PER PLANNING BD COMMENTS DRAWN BY: SCALE: AS NOTED HOU POOL PROPOSED I DRAWING TITLE: LOT 1- F FLOOR INTINARELLI ARCHITECTS MORSE RESIDENCE 50 E. MIDDLE PATENT RD, BEDFORD,

Sheet #:

A-1.7

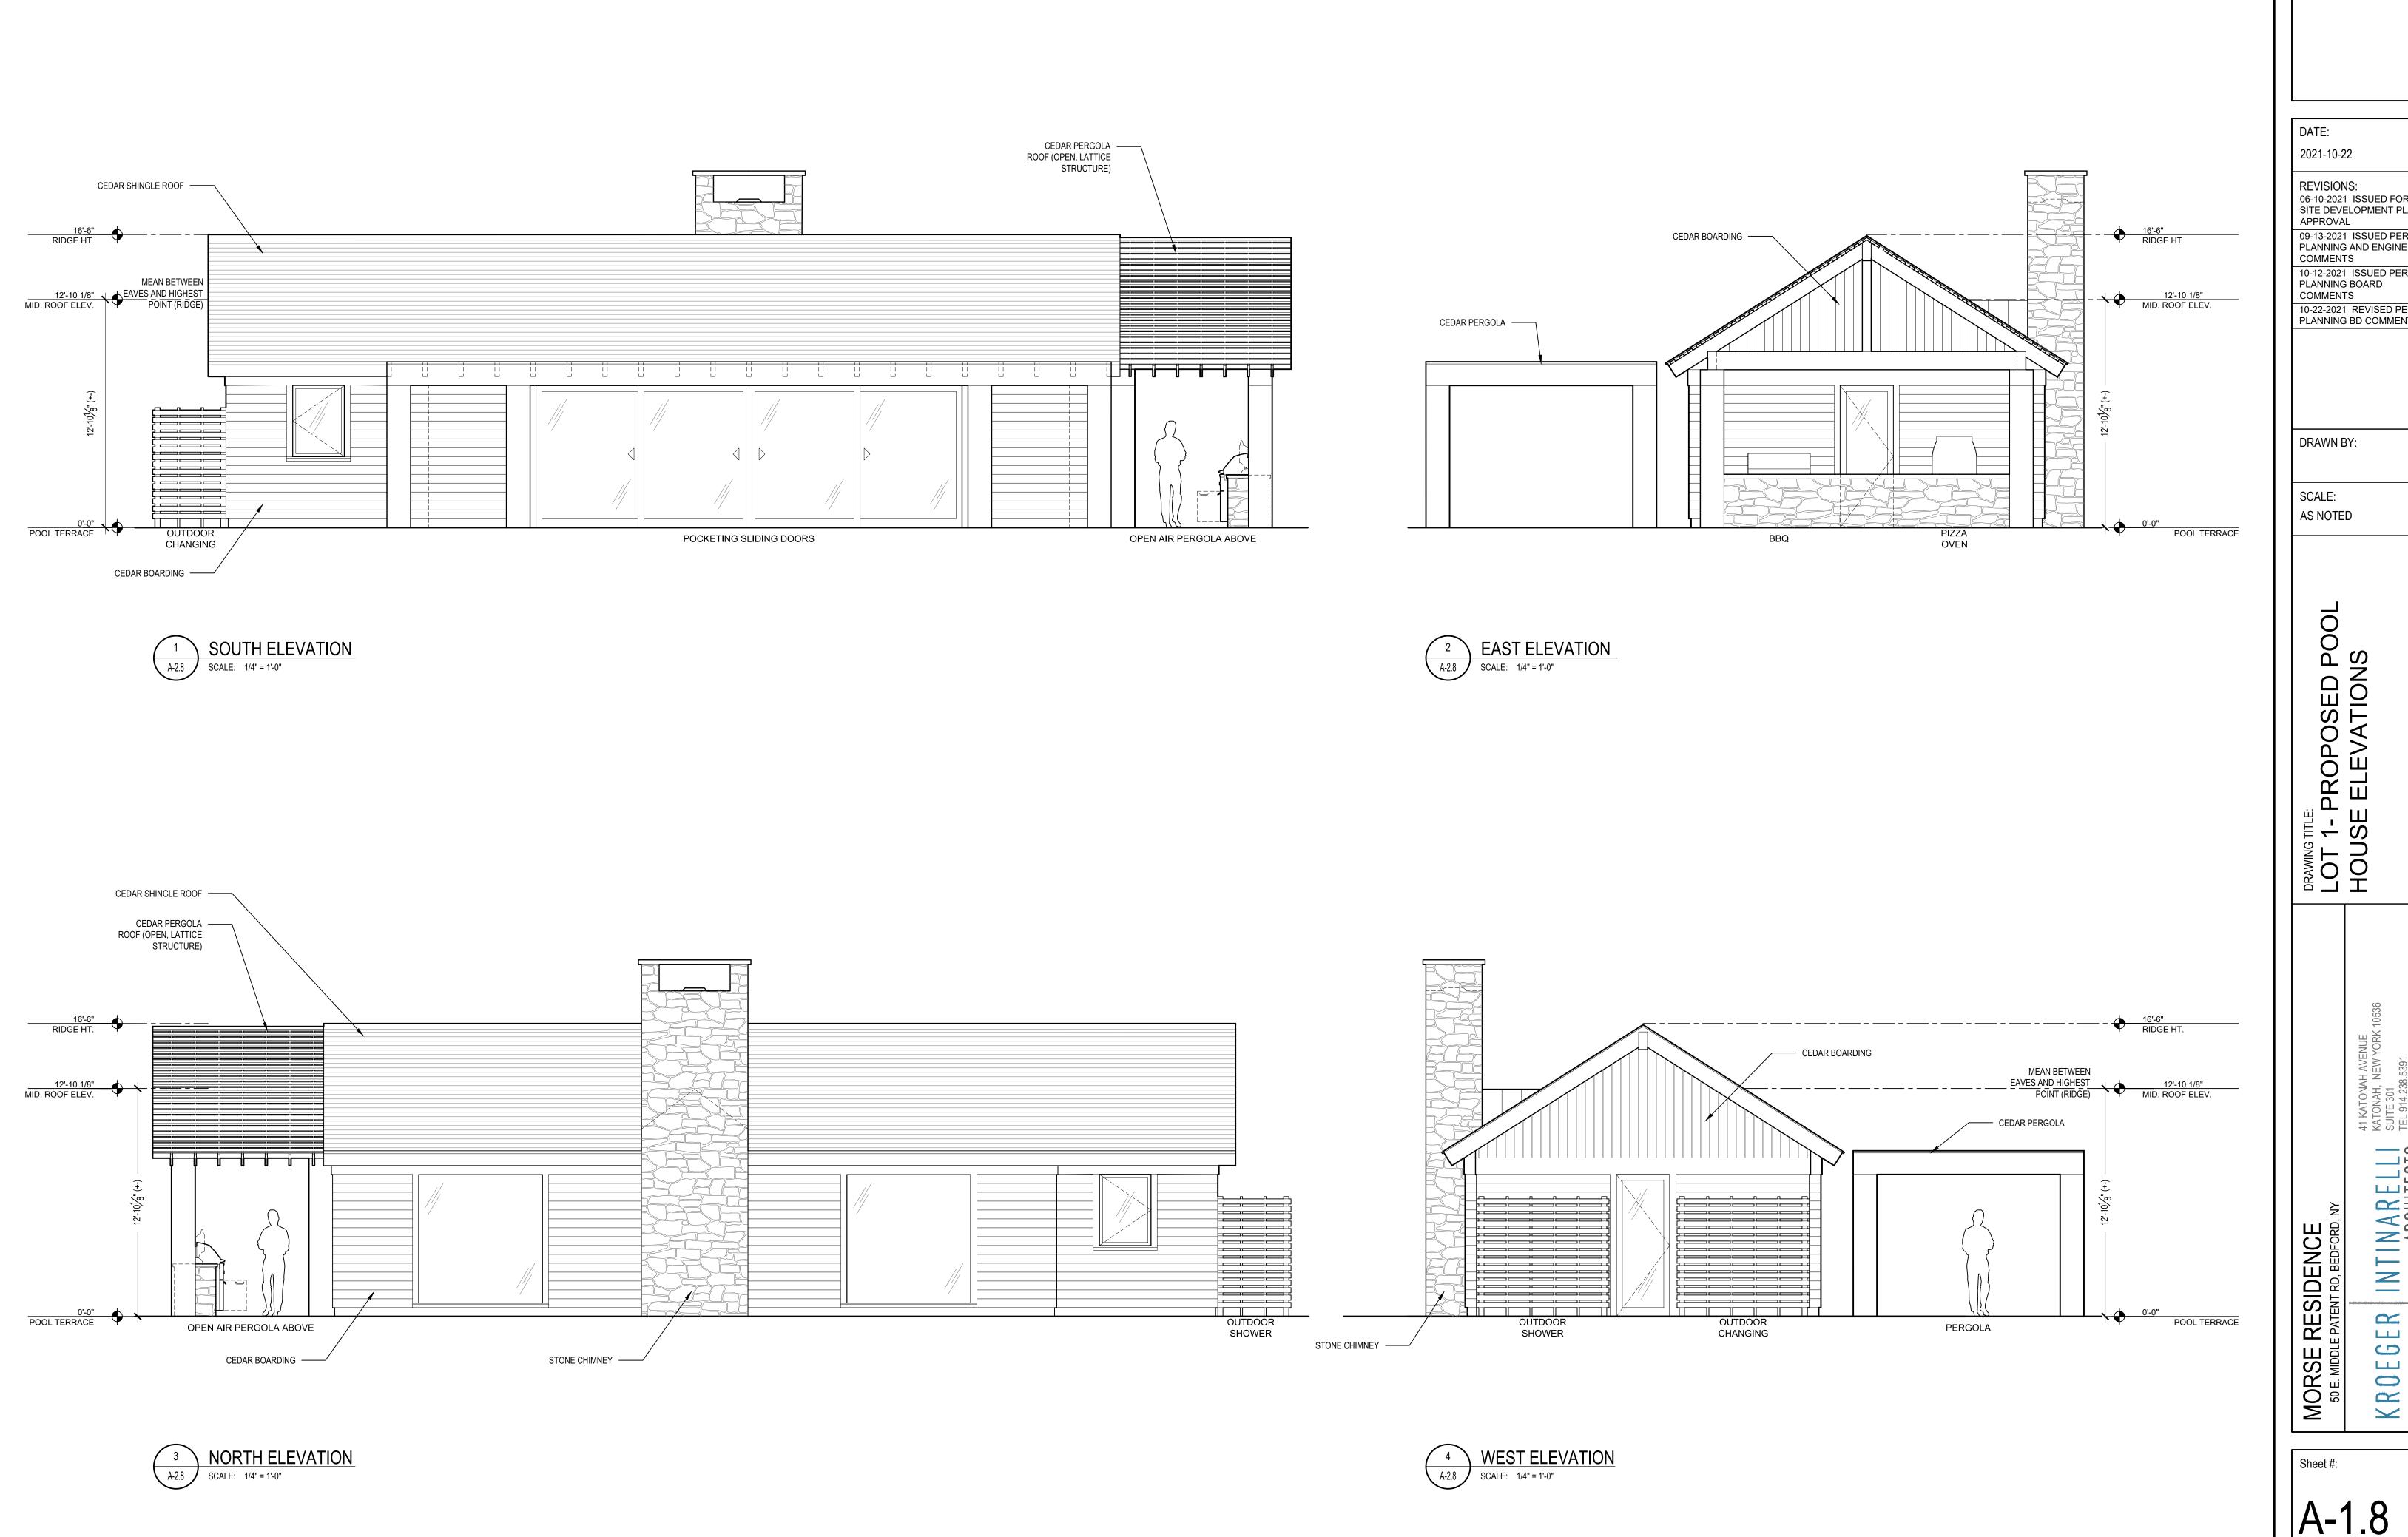



REVISIONS: 06-10-2021 ISSUED FOR SITE DEVELOPMENT PLAN 09-13-2021 ISSUED PER PLANNING AND ENGINEER 10-12-2021 ISSUED PER PLANNING BOARD 10-22-2021 REVISED PER PLANNING BD COMMENTS - PROPOSED POOL E ELEVATIONS DRAWING TITLE:
LOT 1- P
HOUSE INTINARELLI ARCHITECTS

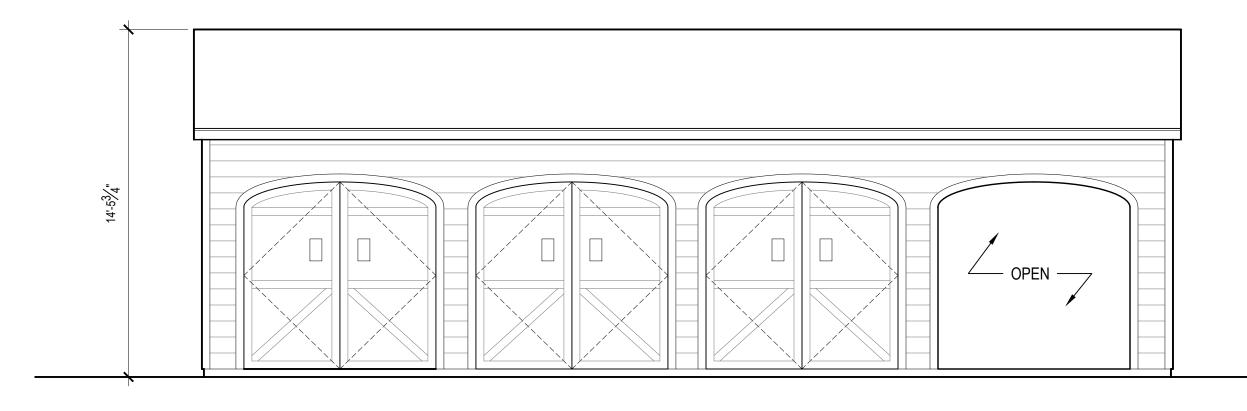



1 WEST (FRONT) ELEVATION
SCALE: 1/4" = 1'-0"

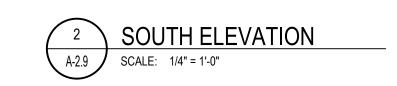

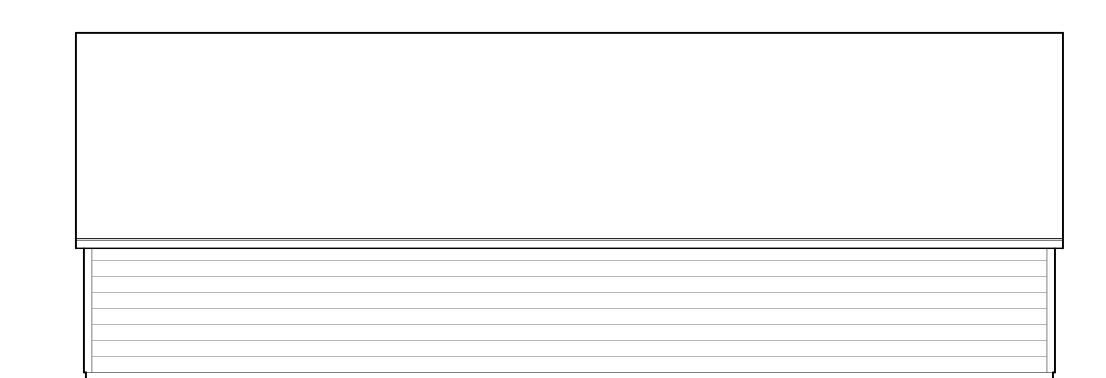



3 EAST ELEVATION
A-2.9 SCALE: 1/4" = 1'-0"

A-2.9 NORTH ELEVATION
SCALE: 1/4" = 1'-0"

DATE:

2021-10-12

REVISIONS: 10-12-2021 REVISED PER PLANNING BD COMMENTS

DRAWN BY:

SCALE: AS NOTED

SHED LOT 2 - RELOCATED S
ELEVATIONS


| N T | N A R E L L | SUITE 301

ARCHITECTS info@kiarcs.com

MORSE RESIDENCE 50 E. MIDDLE PATENT RD, BEDFORD, KROEGER

Sheet #:

A-1.9

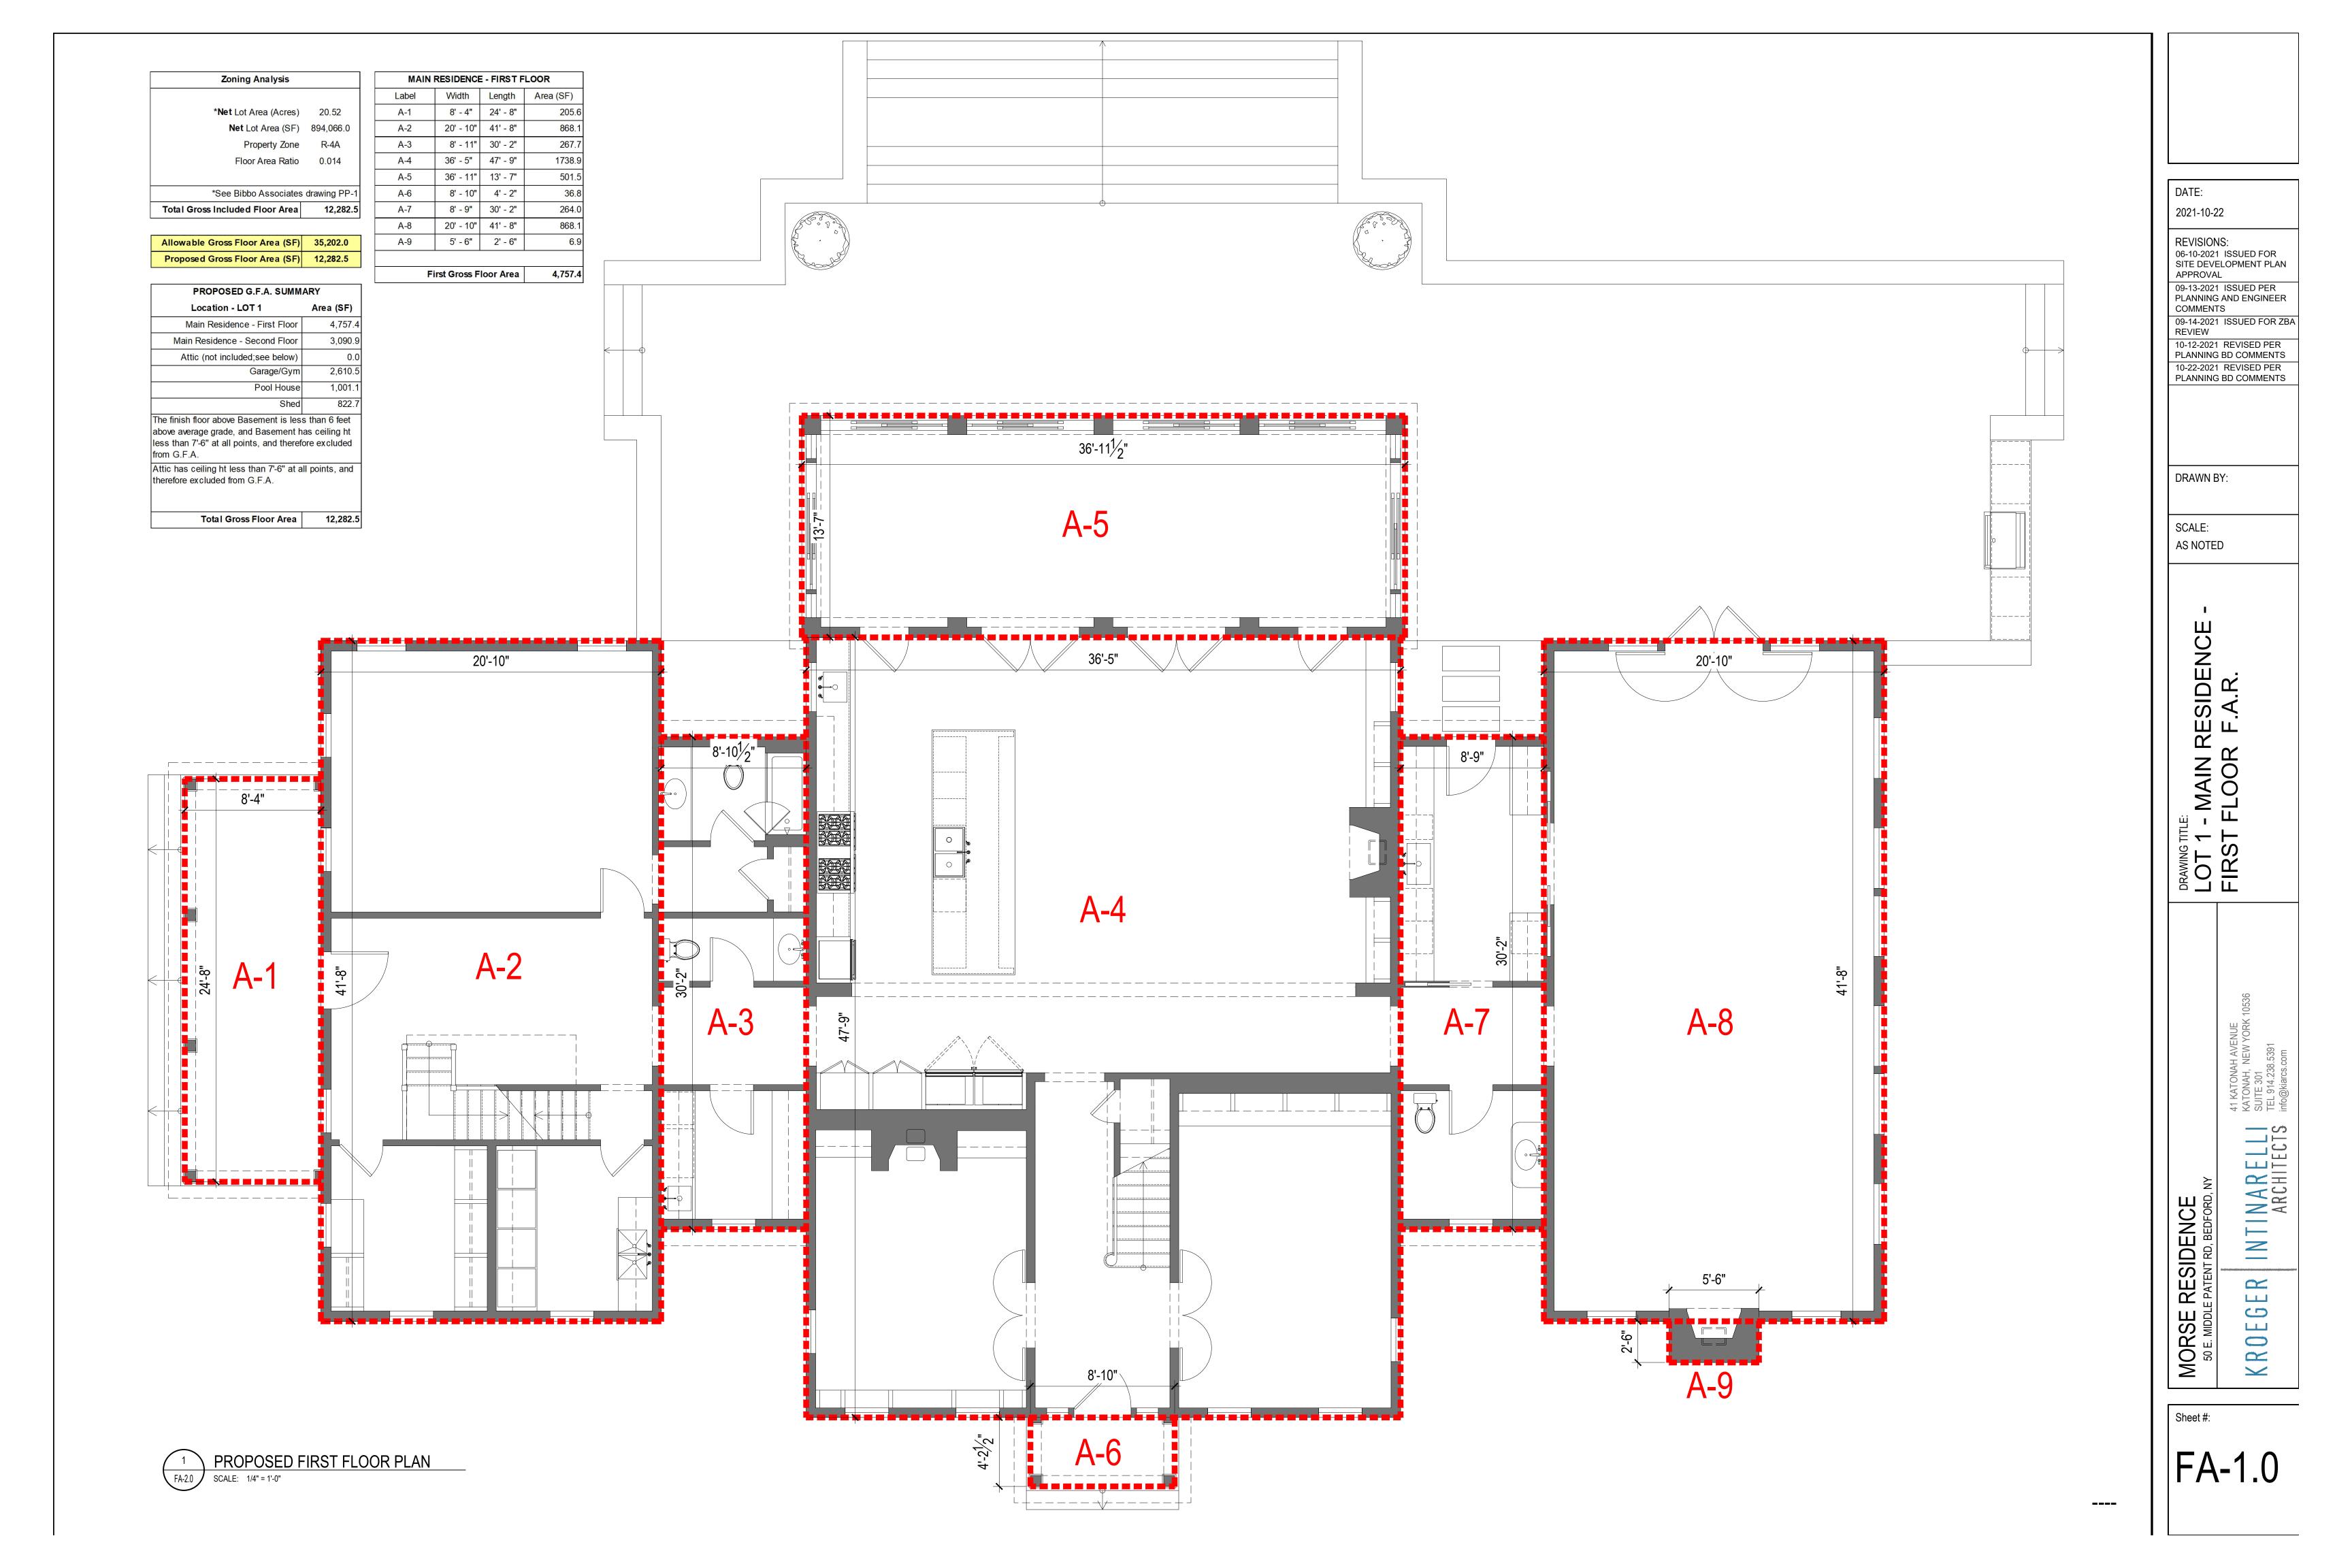

Zoning Analysis	
*Net Lot Area (Acres)	20.52
Net Lot Area (SF)	894,066.0
Property Zone	R-4A
Floor Area Ratio	0.014
*See Bibbo Associates	drawing PP-1

Label	Width	Length	Area (SF)
A-10	20' - 10"	41' - 8"	868.1
A-11	8' - 11"	18' - 1"	160.1
A-12	36' - 5"	54' - 11"	1998.4
A-13	9' - 5"	18' - 1"	169.9
(STAIR A)	10' - 5"	6' - 5"	-66.1
(STAIR B)	3' - 8"	10' - 9"	-39.4
		•	

Second Gross Floor Area


3,090.9

MAIN RESIDENCE - SECOND FLOOR

Allowable Gross Floor Area (SF) 35,202.0 Proposed Gross Floor Area (SF) 12,282.5

Total Gross Included Floor Area 12,282.5

PROPOSED G.F.A. SUMM	
Location - LOT 1	Area (SF)
Main Residence - First Floor	4,757.
Main Residence - Second Floor	3,090.
Attic (not included;see below)	0.
Garage/Gym	2,610.
Pool House	1,001.
Shed	822.
The finish floor above Basement is less above average grade, and Basement h less than 7'-6" at all points, and thereform G.F.A.	as ceiling ht
Attic has ceiling ht less than 7'-6" at a therefore excluded from G.F.A.	ll points, and
Total Gross Floor Area	12.282

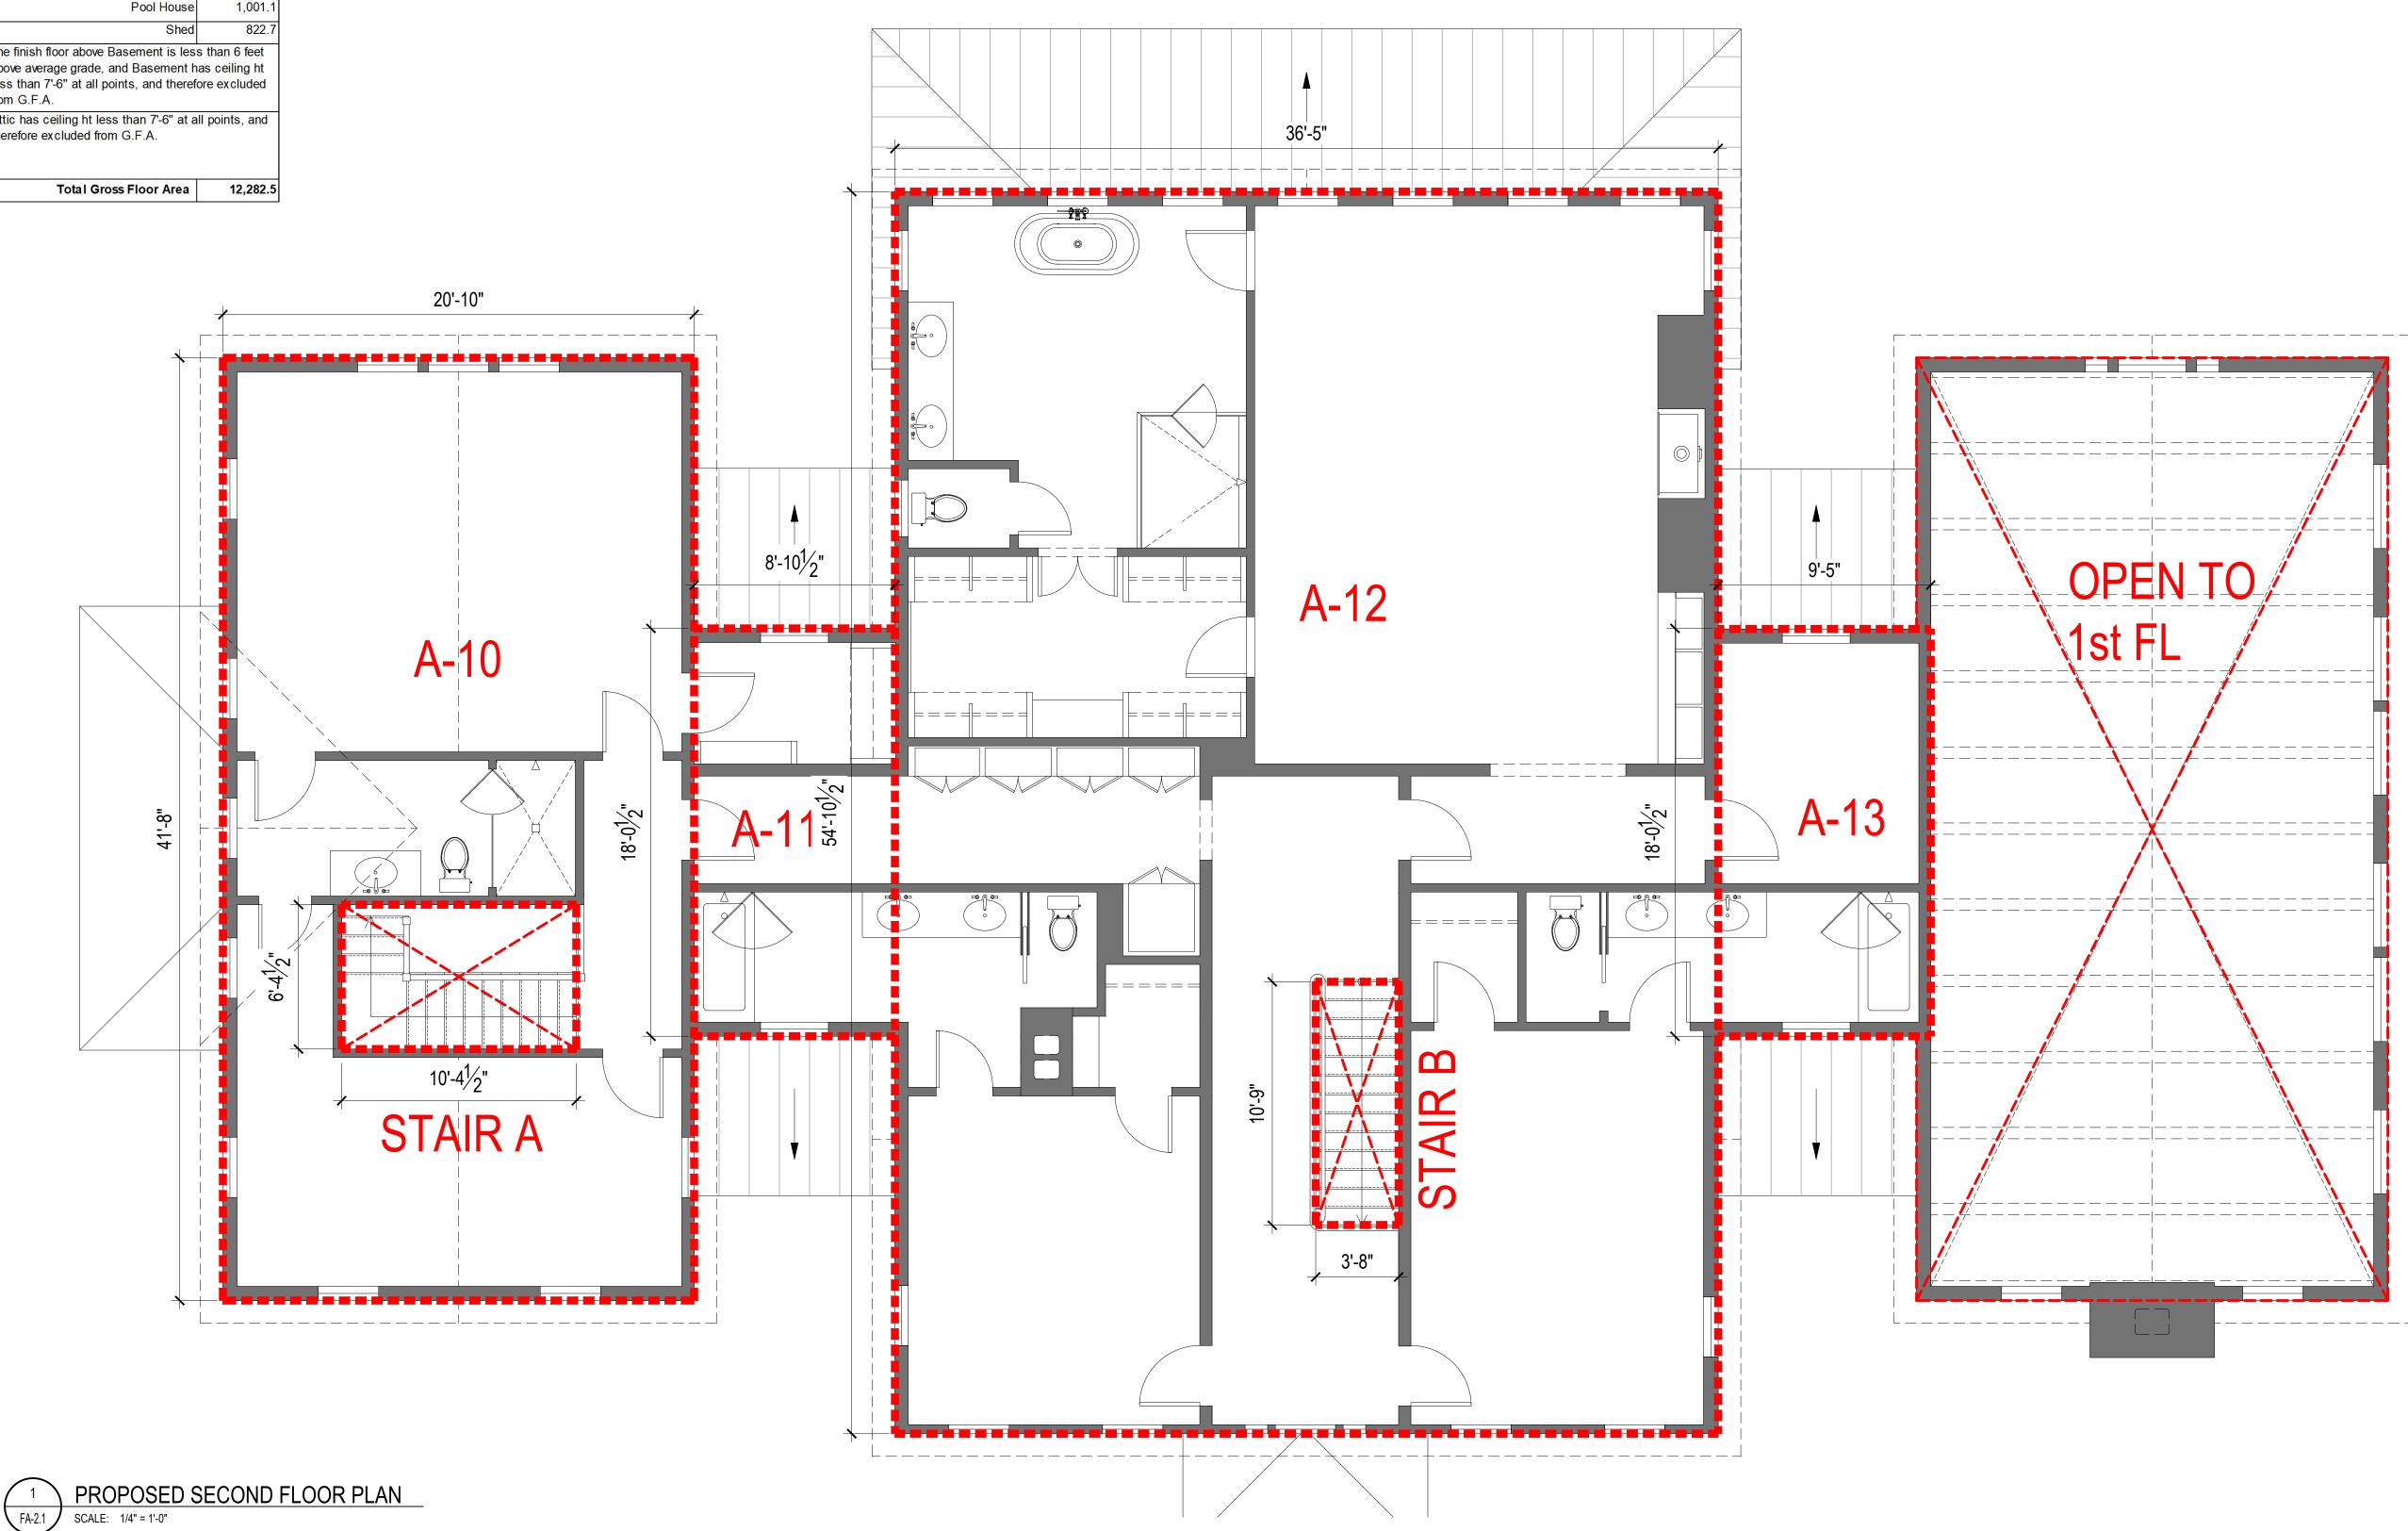

DATE:

2021-10-22

REVISIONS: 06-10-2021 ISSUED FOR SITE DEVELOPMENT PLAN

APPROVAL 09-13-2021 ISSUED PER PLANNING AND ENGINEER COMMENTS

09-14-2021 ISSUED FOR ZBA REVIEW 10-12-2021 REVISED PER

PLANNING BD COMMENTS 10-22-2021 REVISED PER PLANNING BD COMMENTS

SCALE:

DRAWN BY:

AS NOTED

MAIN RESIDENCE D FLOOR F.A.R. DRAWING TITLE:
LOT 1 SECON

INTINARELLI ARCHITECTS

MORSE RESIDENCE 50 E. MIDDLE PATENT RD, BEDFORD,

Sheet #:

FA-1.1

Zoning Analysis			
*Net Lot Area (Acres)	20.52		
Net Lot Area (SF)	894,066.0		
Property Zone	R-4A		
Floor Area Ratio	0.014		

*See Bibbo Associates drawing PP-1

Total Gross Included Floor Area 12,282.5

Allowable Gross Floor Area (SF) 35,202.0

Proposed Gross Floor Area (SF) 12,282.5


PROPOSED G.F.A. SUMMARY			
Location - LOT 1	Area (SF)		
Main Residence - First Floor	4,757.4		
Main Residence - Second Floor	3,090.9		
Attic (not included;see below)	0.0		
Garage/Gym	2,610.5		
Pool House	1,001.1		
Shed	822.7		

The finish floor above Basement is less than 6 feet above average grade, and Basement has ceiling ht less than 7'-6" at all points, and therefore excluded from G.F.A.

Attic has ceiling ht less than 7'-6" at all points, and therefore excluded from G.F.A.


Total Gross Floor Area 12,282.5

GARAGE/GYM				
Width	Length	Area (SF		
7' - 0"	21' - 10"	152		
43' - 5"	25' - 3"	1096		
6' - 11"	21' - 10"	150		
37' - 0"	5' - 4"	197		
5' - 0"	4' - 0"	20		
7' - 0"	12' - 6"	87		
24' - 0"	4' - 9"	114		
43' - 6"	17' - 1"	742		
4' - 0"	3' - 5"	(
4' - 0"	3' - 5"	(
4' - 0"	3' - 5"	(
6' - 11"	8' - 8"	29		
ge Gross F	loor Area	2,610		
	Width 7' - 0" 43' - 5" 6' - 11" 37' - 0" 5' - 0" 7' - 0" 24' - 0" 4' - 0" 4' - 0" 4' - 0" 6' - 11"	Width Length 7' - 0" 21' - 10" 43' - 5" 25' - 3" 6' - 11" 21' - 10" 37' - 0" 5' - 4" 5' - 0" 4' - 0" 7' - 0" 12' - 6" 24' - 0" 4' - 9" 43' - 6" 17' - 1" 4' - 0" 3' - 5" 4' - 0" 3' - 5" 4' - 0" 3' - 5"		

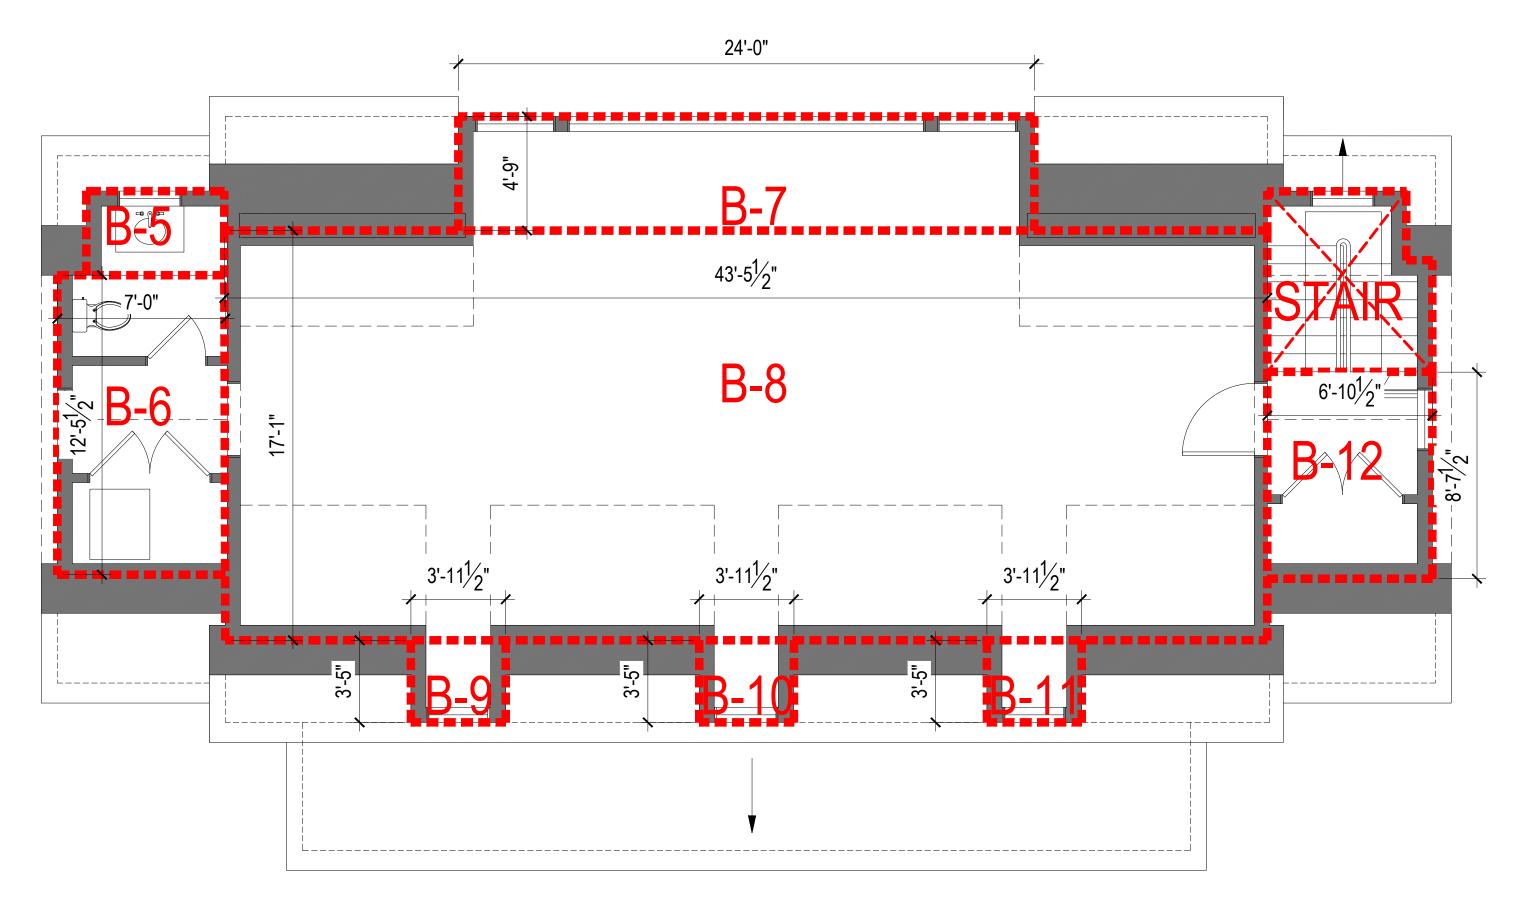

GARAGE SECOND FLOOR PLAN

SCALE: 1/4" = 1'-0"

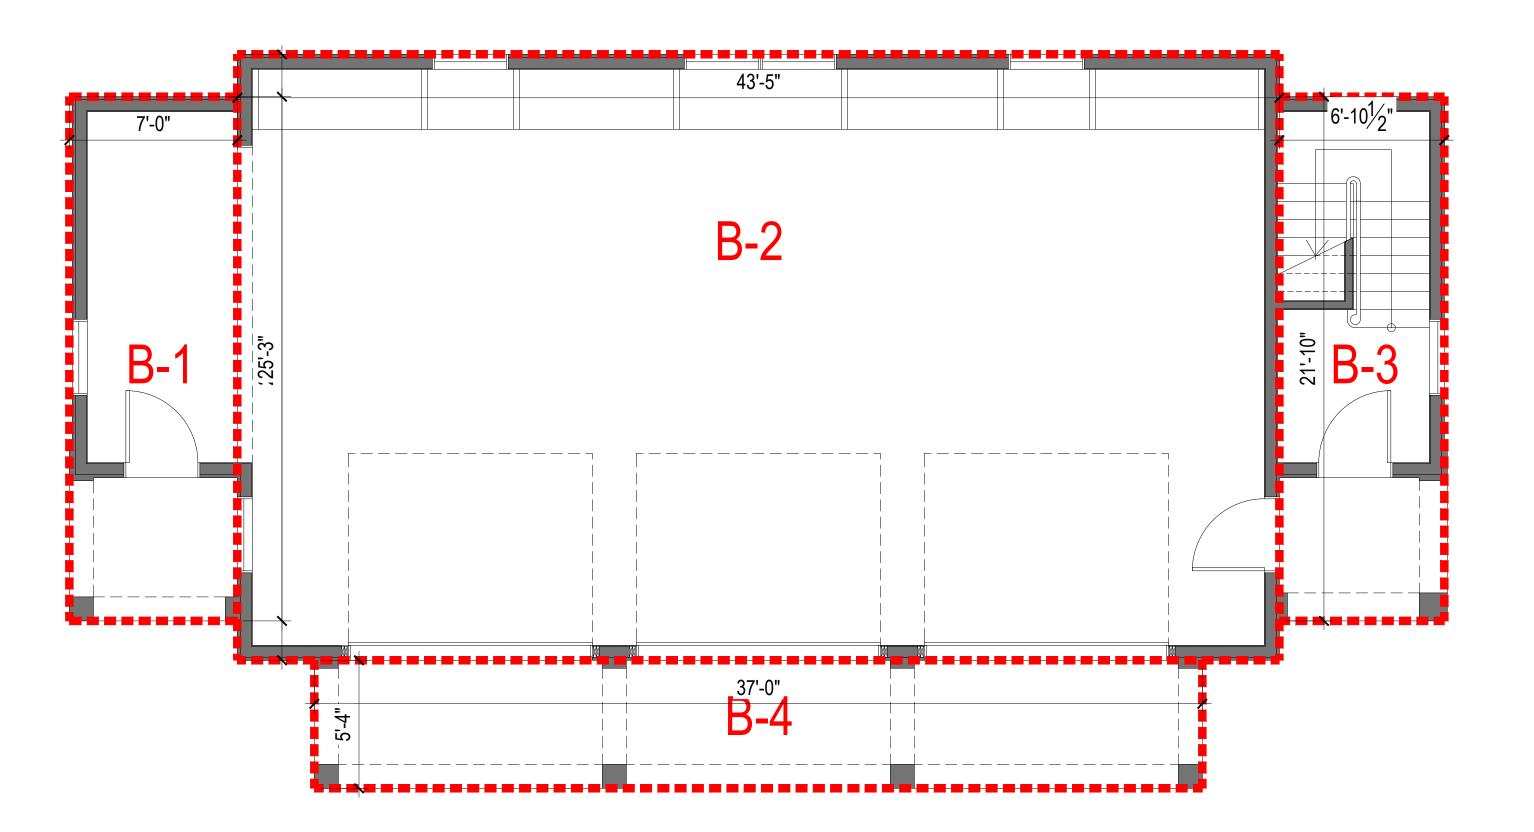



DATE: 2021-10-22

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REVIEW

10-12-2021 REVISED PER
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10-22-2021 REVISED PER
PLANNING BD COMMENTS

DRAWN BY:

SCALE: AS NOTED

-

LOT 1 - GARAGE/GYM F./

41 KATONAH AVENUE KATONAH, NEW YORK 10536 SUITE 301

SIDENCE
ENT RD, BEDFORD, NY
INTINARELLI
ARCHITECTS

MORSE RESIDENCE 50 E. MIDDLE PATENT RD, BEDFORD,

Sheet #:

FA-1.2

*Net Lot Area (Acres) 20.52
Net Lot Area (SF) 894,066.0
Property Zone R-4A
Floor Area Ratio 0.014

*See Bibbo Associates drawing PP-1

Total Gross Included Floor Area 12,282.5

Total Gross Included Floor Area 12,282

Allowable Gross Floor Area (SF) 35,202.0

Proposed Gross Floor Area (SF) 12,282.5

PROPOSED G.F.A. SUMMARY			
Location - LOT 1	Area (SF)		
Main Residence - First Floor	4,757.4		
Main Residence - Second Floor	3,090.9		
Attic (not included;see below)	0.0		
Garage/Gym	2,610.5		
Pool House	1,001.1		
Shed	822.7		
The finish floor above Basement is less than 6 feet			

above average grade, and Basement has ceiling ht less than 7'-6" at all points, and therefore excluded from G.F.A.

Attic has ceiling ht less than 7'-6" at all points, and therefore excluded from G.F.A.

Total Gross Floor Area 12,282.5

POOL HOUSE					
Label	Width	Length	Area (SF		
C-1(OMITTED)					
C-2	20' - 1"	40' - 10"	81		
C-3	18' - 9"	9' - 1"	17		
C-4	2' - 3"	6' - 0"	1		


Pool House Gross Floor Area

 SHED


 Label
 Width
 Length
 Area (SF)

 D-1
 20' - 4"
 40' - 6"
 822.7

 Shed Gross Floor Area
 822.7

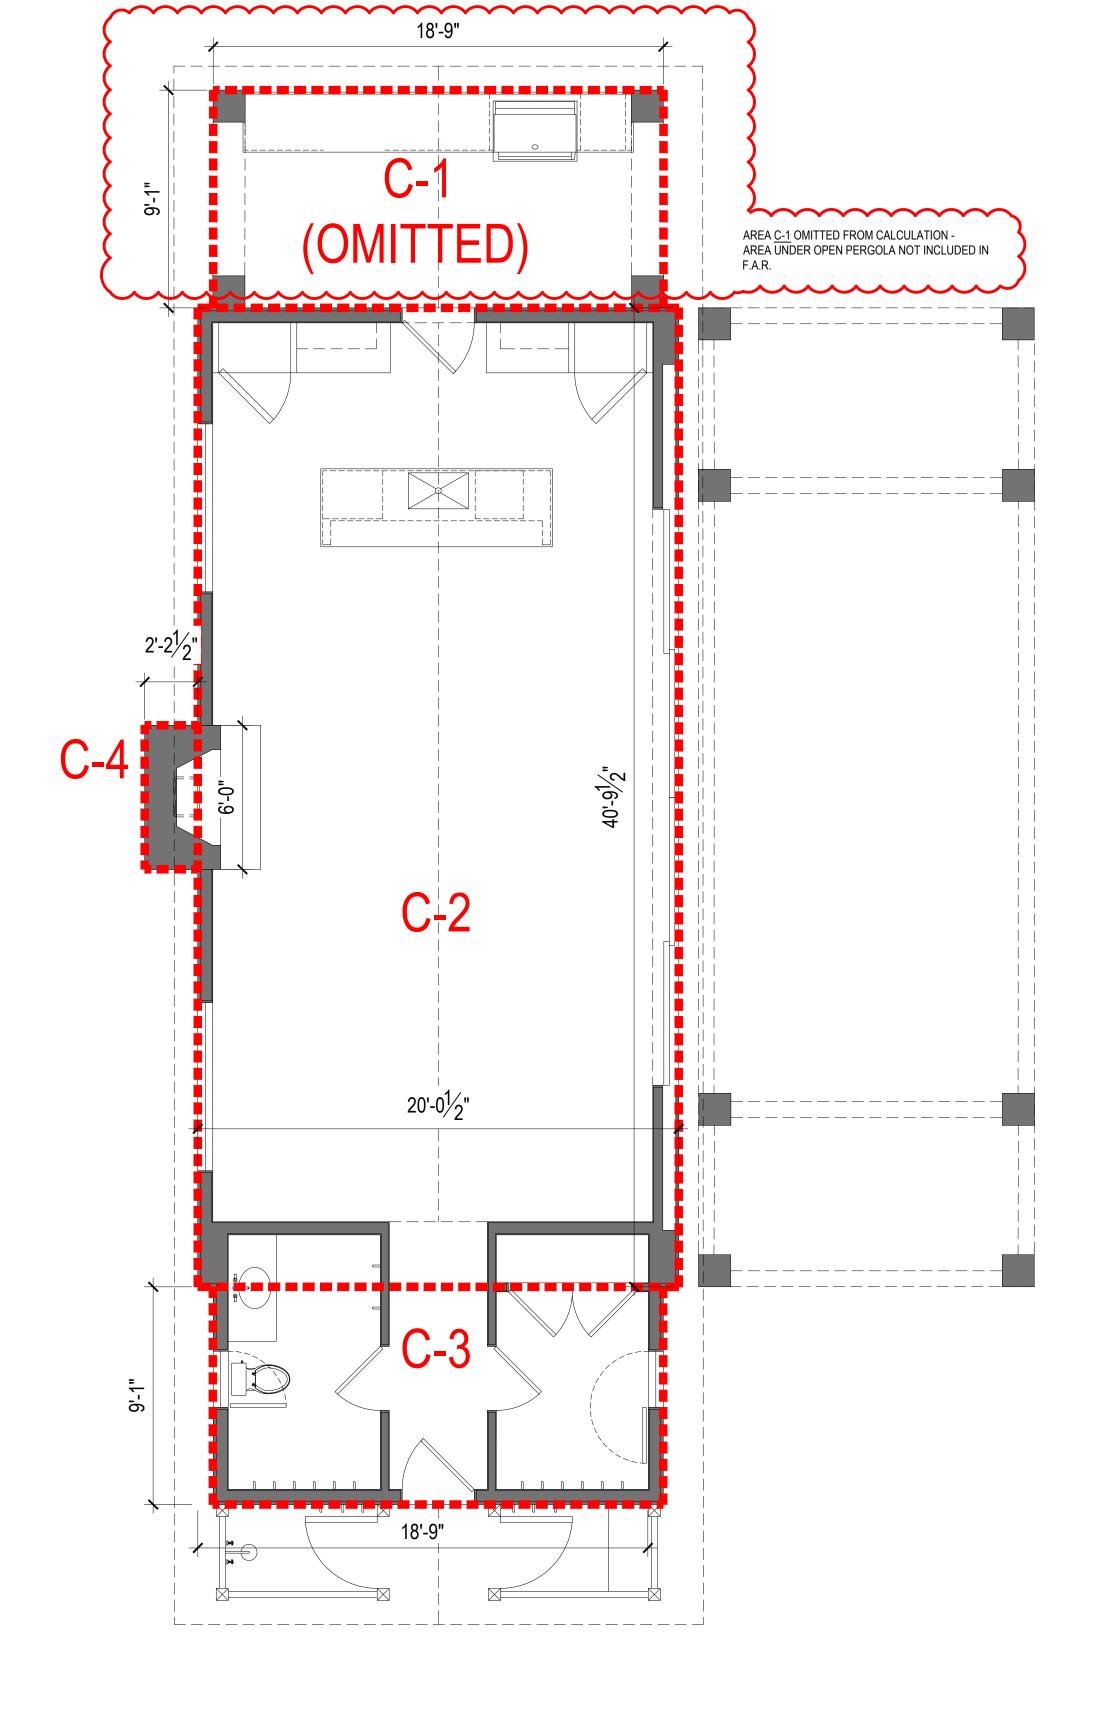



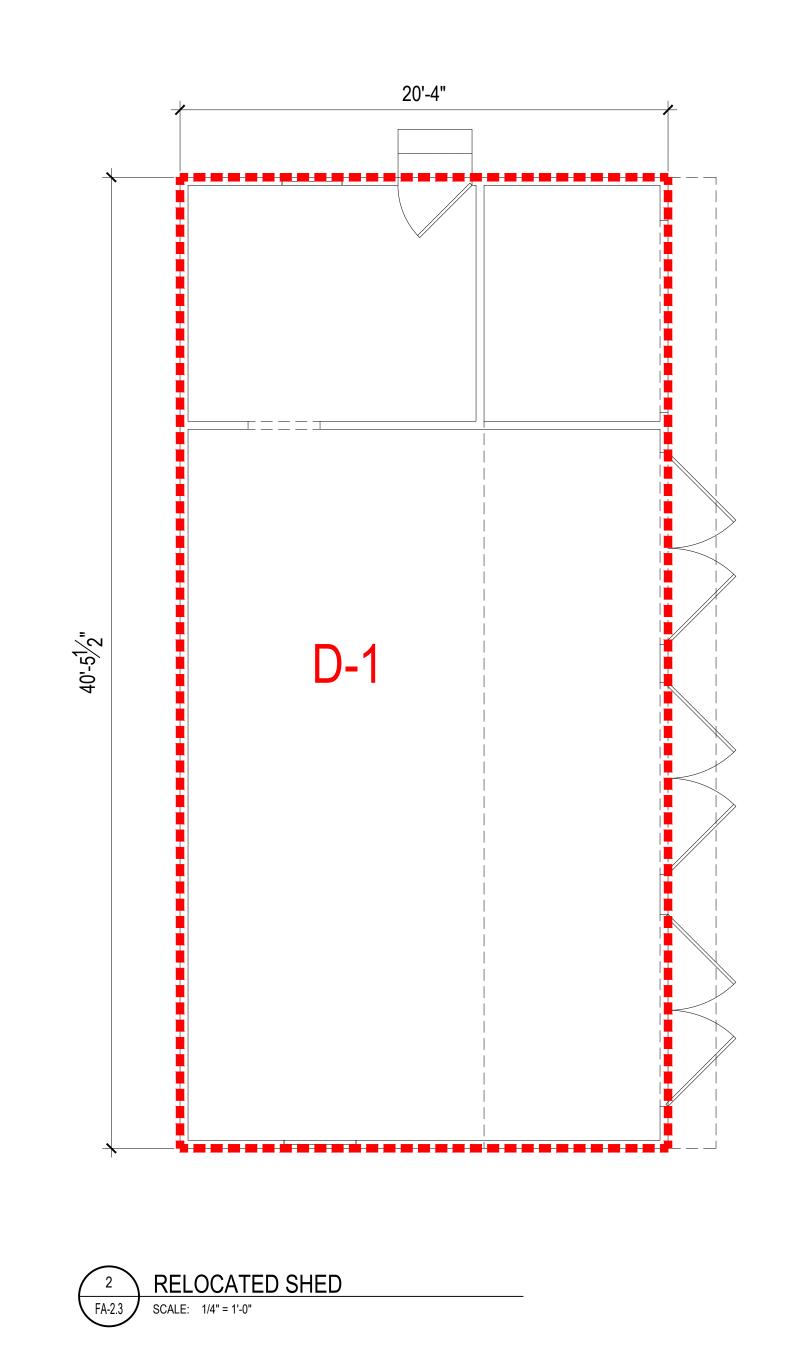

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PLANNING BD COMMENTS

10-22-2021 REVISED PER
PLANNING BD COMMENTS

DRAWN BY:

SCALE: AS NOTED

& SHED

DRAWING TITLE:
LOT 1 - POOL HOUSE
F.A.R.

41 KATONAH AVENUE
KATONAH, NEW YORK 10536
SUITE 301
TEL 914.238.5391

SIDENCE

ENT RD, BEDFORD, NY

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ARCHITECTS

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MORSE RESIDENCE 50 E. MIDDLE PATENT RD, BEDFORD, K R N F G F R IN T I N A

Sheet #:

FA-1.3



TOWN OF NORTH CASTLE

WESTCHESTER COUNTY 17 Bedford Road Armonk, New York 10504-1898

PLANNING DEPARTMENT Adam R. Kaufman, AICP Director of Planning

Telephone: (914) 273-3542 Fax: (914) 273-3554 www.northcastleny.com

FLOOR AREA CALCULATIONS WORKSHEET

Applica	tion Name or Identifying Title: Morse - Proposed Lot 2	Date:9/13/2021
Tax Ma	p Designation or Proposed Lot No.: Section: 103.01 Block: 1 Lot: 18	
Floor A	<u>rea</u>	
1.	Total Lot Area (Net Lot Area for Lots Created After 12/13/06):	20.49 Acres (892,661 SF)
2.	Maximum permitted floor area (per Section 355-26.B(4)):	34,616 SF
3.	Amount of floor area contained within first floor: 2,655 existing + 1,860 proposed =	4,515 SF
4.	Amount of floor area contained within second floor: 1,611 existing + 1,479.9 proposed =	3,090.9 SF
5.	Amount of floor area contained within garage: existing +1,479.9 proposed =	1,479.9
6.	Amount of floor area contained within porches capable of being enclosed:	242.4 SF
7.	Amount of floor area contained within basement (if applicable – see definition): existing + proposed =	0 SF
8.	Amount of floor area contained within attic (if applicable – see definition): existing + proposed =	0 SF
9.	Amount of floor area contained within all accessory buildings: existing + proposed =	1,994 SF
10.	Proposed floor area: Total of Lines $3-9=$	12,452.8 SF
and the	10 is less than or equal to Line 2, your proposal complies with the Town's max project may proceed to the Residential Project Review Committee for review. If Li oposal does not comply with the Town's max gulations. INTIMARIAN COMPLETE TOWN OF STATE OF	imum floor area regulations ne 10 is greater than Line 2 9/13/2021 Date