■ WETLAND BUFFER AREAS OF DISTURBANCE & IMPROVEMENTS

WETLAND TYPE	BUFFER AREA	LIMIT OF DISTURBANCE	IMPROVEMENTS WITHIN BUFFER	
POND	WETLAND	TOTAL DISTURBANCE	EA OF PROPOSED PLANTINGS	
WETLAND	BUFFER AREA	OUTSIDE WETLAND BUFFER: 360 SF	WITHIN WETLAND BUFFER:	
23,375 SF	37,363 SF		9,458 SF	
		PROPOSED 2.5 STORY HOUSE & POOL	AREA OF IMPROVEMENTS VIA SEED MIXES,	
DRAINAGE	WETLAND	DISTURBANCE WITHIN WETLAND BUFFER	ERNMX-104 FOR FIRST GROWING SEASON	
DITCH WETLAND	BUFFER AREA	8,791 SF THEN SUPPLANT WITH ERNMX-128		
2,964 SF	42,543 SF		20,000 SF	
		LIMIT OF DISTURBANCE AREA OF 42 TREES		
WATER COURSE	WETLAND	REMOVED WITHIN WETLAND BUFFER	AREA OF INVASIVE REMOVALS VIA PULL & DIG,	
WETLAND	BUFFER AREA	11,881 SF	RESEED AFFECTED AREAS WITH ERNMX-129	
6,165 SF	56,671 SF	PPD WALKWAY TO DOCK	CONSERVATION SHADE MIX	
		160 SF	13,000 SF	
32,504 SF	136,577 SF	DISTURBANCE WITHIN BUFFER: 20,832 SF	42,458 SF (41,664 REQUIRED FOR 2:1)	

■ WETLAND BUFFER IMPROVEMENT PLANT SCHEDULE

QTY	BOTANICAL NAME	COMMON NAME	SIZE	COMMENTS
EES				
23	Amelanchier canadensis	Serviceberry	8-10'	Multi-Stem
19	Cercis canadensis	Eastern Redbud	8-10'	
IRUBS				
3	Aronia melanocarpa	Black Chokeberry	3 Gallon	
30	Buxus 'Winter Gem'	Winter Gem Boxwood	24-30"	
3	Cephalanthus occidentalis	Button Bush	3 Gallon	
65	Clethra alnıfolia	Sweet Pepperbush	5 Gallon	
3	Lindera benzoin	Spice Bush	3 Gallon	
3	Viburnum dentatum	Arrowood Viburnum	3 Gallon	
ASSES	T-	To an		
12	Sporobolus heterolepis	Prairie Dropseed	2 Gallon	
15	Carex pennyslvanica	Pennsylvania Sedge	2 Gallon	
42	Schizachyrium scoparium	Little Bluestem	2 Gallon	
ED MIX				
60 LBs	20,000 SF of ERNMX-104 by Ernst Seeds	Quick Conservation Control Mix	3 LBs per 1,0005	
10 LBs	20,000 SF of ERNMX-128 by Ernst Seeds	Seasonally Flooded Wildlife Food Mix	.5 LBs per 1,000S	
29 LBs	13,000 SF of ERNMX-129 by Ernst Seeds	Conservation Shade Mix	3 LBs per 1,000Sf	

☐ PLANT IMAGES







Amelanchier canadensis

Cercis canadensis

Lindera benzoin





Viburnum dentatum





Schizachyrium scoparium

Carex pennsylvanica



Buxus 'Winter Gem'





Sporobolus heterolepis

TO SCALE WHEN PLOTTED ON 24x36 PROGRESS SET NOT FOR CONSTRUCTION

178 elizabeth st pearl river, ny 10965 p 845.365.4595 | f 914.361.4473 yostdesign.com

4

SURVEYOR:

TOWN OF NORTH CASTLE

PLANNING DEPARTMENT

DATE: APRIL 23, 2020 DRAWN BY: AVM JOB NO: 042420 SCALE: 1"=30' FILENAME: 2023_0130 4 Ledgewood


REVISIONS: 8/26/2020 9/30/2020 11/11/2020 9/13/2021 10/20/2021 6/22/2022 10/20/2022 1/30/2023 4/10/2023




MITIGATION/ **PLANTING**

PLAN

SHEET NO.

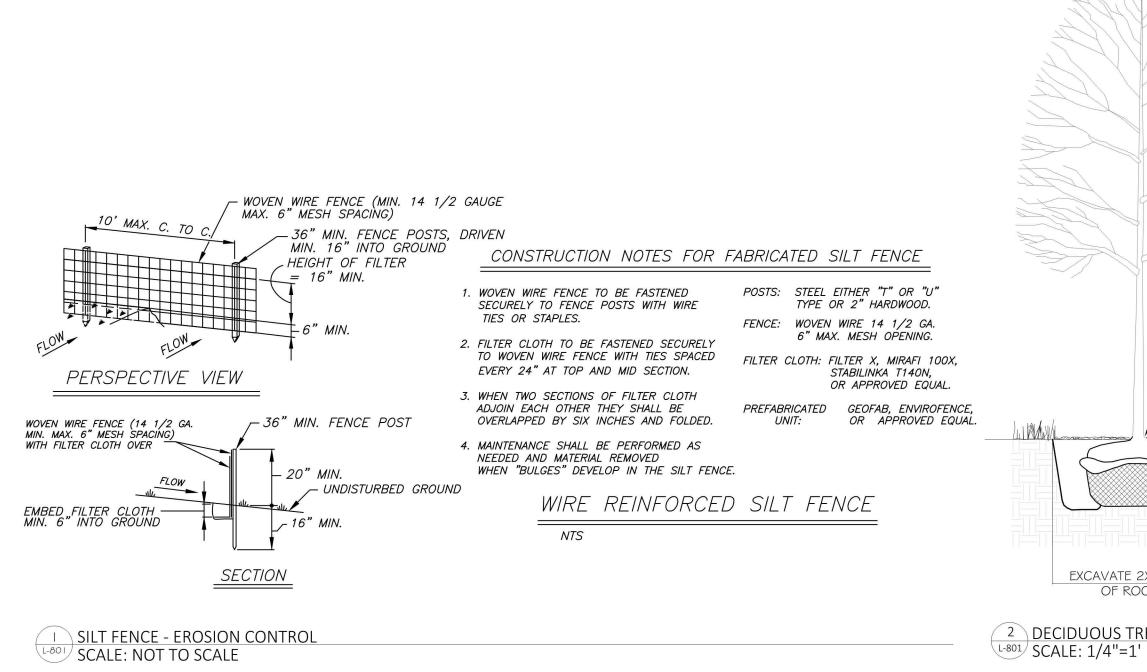

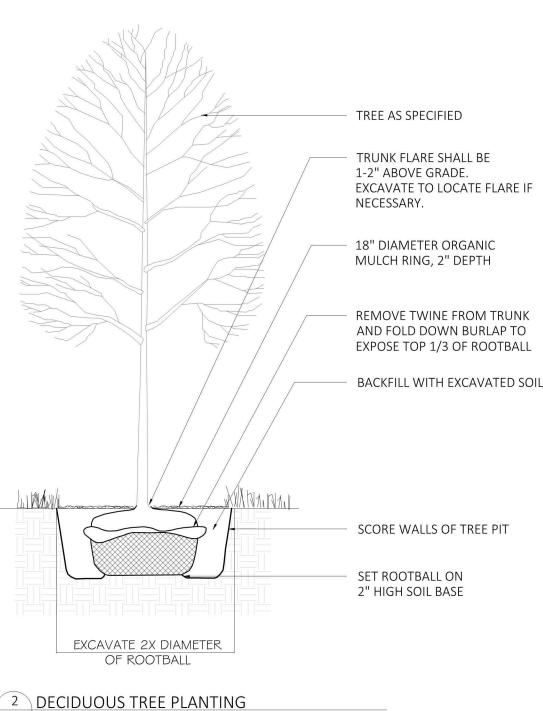

SHRUB, AS SPECIFIED SET PLANT PLUMB IN 1. SET TREE PLUMB. **EXCAVATED HOLE** 2. DO NOT STAKE UNLESS DIRECTED TO DO SO BY LANDSCAPE ARCHITECT 3. REMOVE COMPLETELY ANY NON-BIODEGRADABLE MATERIALS BINDING THE

ROOTBALL. 4. REMOVE WIRE BASKET COMPLETELY IF ROOTBALL WILL BARE. OTHERWISE, CLIP AND PEEL BACK WIRE BASKET AT LEAST ONE THIRD OF THE WAY FROM

NOTES:

THE TOP OF THE ROOTBALL. 5. SATURATE SOIL WITHIN SIX (6) HOURS OF PLANTING AND WATER AS

6. DO NOT ADD ANY SOIL AMENDMENTS OTHER THAN COMPOST UNLESS DIRECTED TO BY LANDSCAPE ARCHITECT.

NECESSARY UNTIL IRRIGATION IS INSTALLED.

7. DO NOT ADD ANY SOIL OR MULCH AGAINST TRUNK OF TREE. IF ROOT FLARE IS NOT EXPOSED, REMOVE SOIL AND EXPOSE.

- 2" DEEP ORGANIC MULCH RING BACKFILL WITH TOPSOIL

NOTES: 1. FOR B & B PLANT MATERIAL, REMOVE ALL TWINE AND ROLL BACK BURLAP FROM TOP 1/2 OF BALL. IF ANY MATERIALS USED TO BIND THE ROOTBALL ARE NON-BIODEGRADEABLE, REMOVE COMPLETELY INCLUDING WIRE BASKET.

2. FOR CONTAINER GROWN PLANT MATERIAL, REMOVE CONTAINER. TO HELP PREVEN LOOSENING OF SOIL AND SCARIFY BALL TO HELP PREVENT GIRDLING

3. SATURATE SOIL WITHIN SIX (6) HOURS OF PLANTING, AND WATER AS NECESSARY

3 SHRUB PLANTING L-801 SCALE: 1/2"=1'

> POSITION ROOT CROWN AT FINISHED GRADE 2" MULCH REMOVE CONTAINER AND GENTLY LOOSEN ROOTS ROTOTILL 2" TOPSOIL AND 2" OF COMPOST INTO NATIVE SOIL UNLESS LANDSCAPE ARCHITECT SPECIFIES **OTHERWISE**

4 GROUNDCOVER PLANTING L-801 SCALE:1/2"=1'

UNTIL IRRIGATION INSTALLED. 4. NO MULCH OR SOIL SHOULD BE PLACED AGAINST THE PLANT'S TRUNK.

SEE PLANTING DETAIL 11 (DECIDUOUS TREE PLANTING) NOTES FOR COMPLETE PLANTING INSTRUCTIONS. TREE AS SPECIFIED EXISTING TREE TO BE PROCTECTED ORANGE PLASTIC BARRIER FENCE WITH STEEL -3" MOUNDED SAUCER POSTS INSTALLED AT 8' O.C. −3" MULCH LAYER, NOTES: DO NOT PLACE IN CONTACT WITH THE TREE 1. ORANGE BARRIER FENCING SHALL BE USED TO PROTECT ALL EXISTING TREES AND ROOT ZONES. -FINISH GRADE BALL DEPTH 2. FENCING SHALL CREATE A ZONE OF PROTECTION WITH A MINIMUM RADIUS OF 1' FROM TREE TRUNK FOR EVERY 1" OF OF TRUNK DIAMETER (I.E. 12"DBH TREE=12' RADIUS ROOT ZONE PROTECTION) SCARIFY SIDES OF PLANT PIT 3. NO CONSTRUCTION MATERIALS OR DEBRIS SHALL BE PLANT BED MIX STORED INSIDE OF THE FENCING. LOW ORGANIC SOIL 4. THE FENCING SHALL BE INSTALLED PRIOR TO THE -COMPACTED SOIL MOUND COMMENCEMENT OF CONSTRUCTION ACTIVITIES, AND SHALL BE REMOVED WHEN CONTRUCTION IS COMPLETE. -GRADED CRUSHER RUN WITH STONE DUST FILTER 5. THE OWNER SHALL BE INFORMED IMMEDIATELY OF — MAX DISTANCE 8' ——— ANY DAMAGE TO EXISTING TREES TO BE PRESERVED, -COMPACTED SUBGRADE INCLUDING BARK AND BRANCH DAMAGE.

5 MULTISTEM TREE PLANTING L-801 SCALE: 1/2"=1'

6 TREE PROTECTION L-801 SCALE: 1/4"=1"

DATE: APRIL 23, 2020 DRAWN BY: AVM JOB NO: 042420 SCALE: VARIES FILENAME: 2023_0130 4 Ledgewood

178 elizabeth st

pearl river, ny 10965

p 845.365.4595 | f 914.361.4473

yostdesign.com

Blythe M Yost ASLA | Registered Landscape Architect

0

SURVEYOR:

REVISIONS: 8/26/2020 9/30/2020 11/11/2020 9/13/2021


4/10/2023




Blythe M Yost ASLA | Registered Landscape Architect

DETAILS SHEET

SHEET NO.

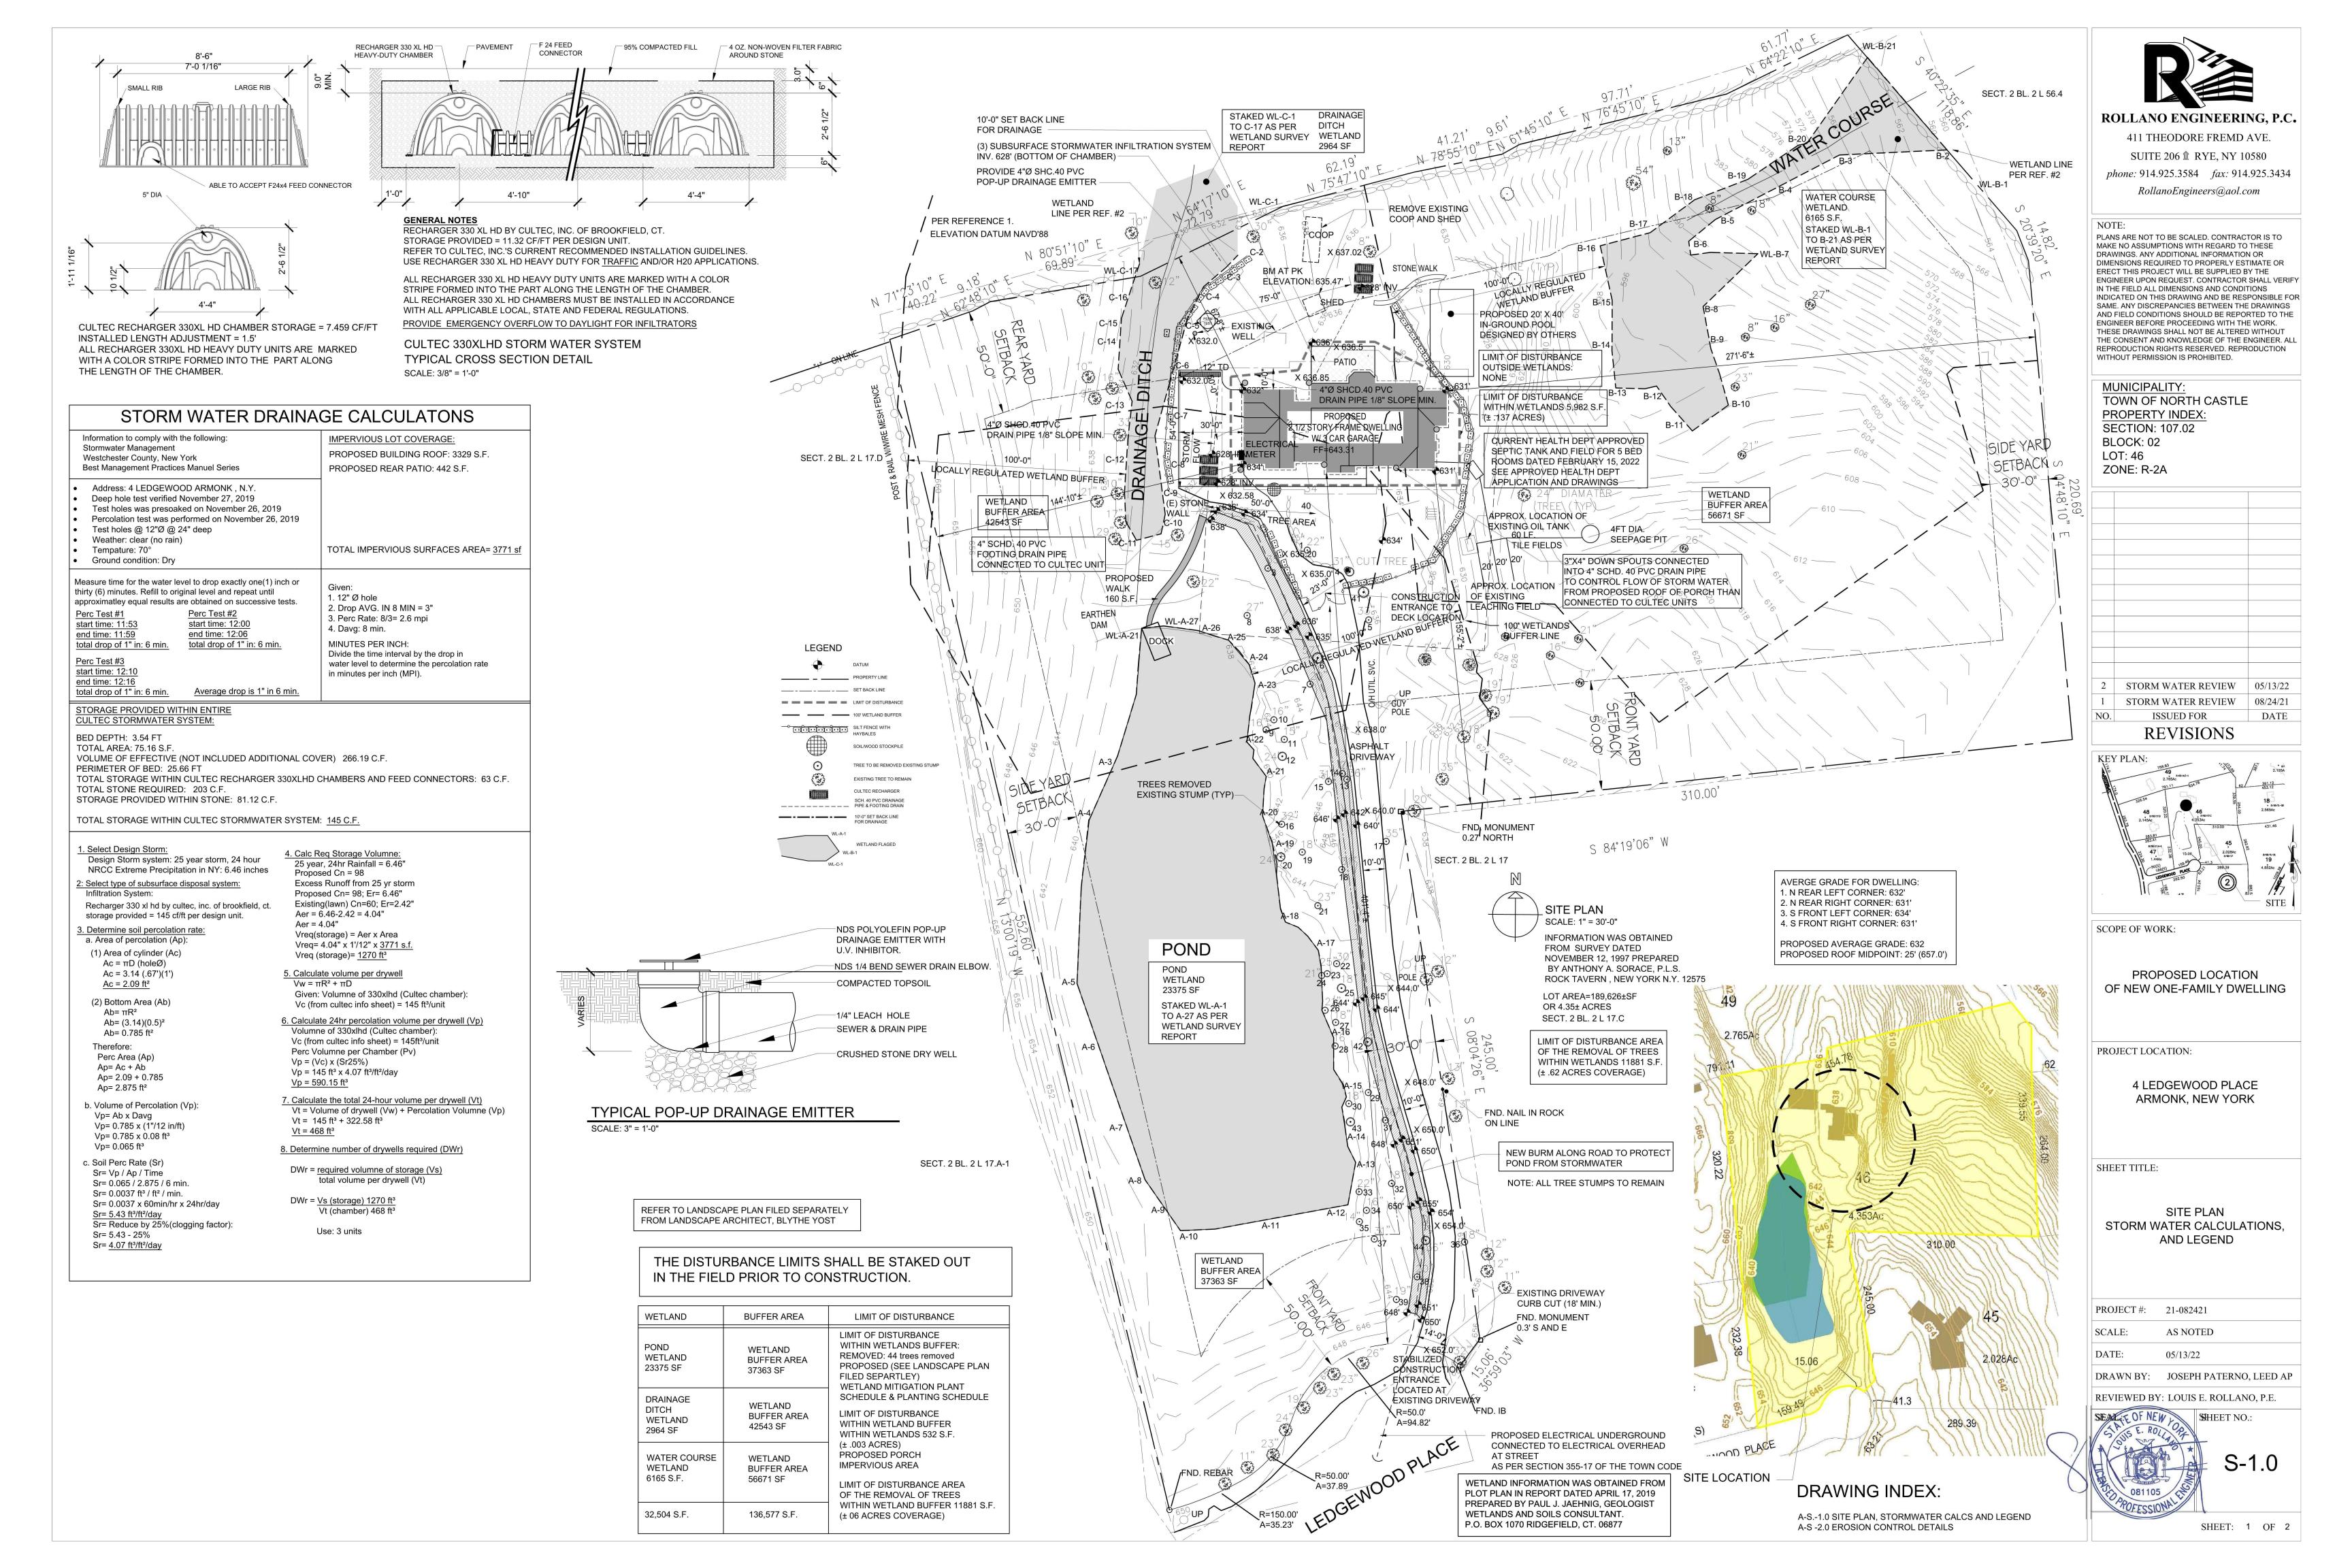

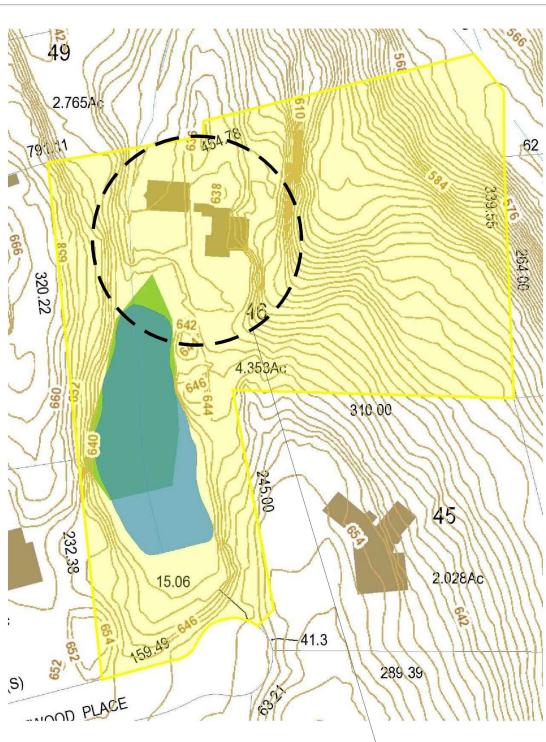

SITE LOCATION

1) AN INITIAL INSPECTION PRIOR TO THE PLAN APPROVAL

EROSION AND SEDIMENT CONTROL INSPECTIONS:

2) AN EROSION AND SEDIMENT CONTROL INPSECTION TO ENSURE THAT EROSION AND SEDIMENT CONTROL PRACTICES ARE IN ACCORD WITH THE APPROVED PLAN. 3) AN INSPECTION PRIOR TO BACKFILLING ANY UNDERGROUND DRAINAGE OR STORMWATER CONVEYANCE STRUCTURES.

4) A FINAL INSPECTION WHEN ALL WORK, INCLUDING CONSTRUCTION OF STORMWATER MANAGEMENT FACILITIES AND PERMANENT SOIL STABILIZATION, HAS BEEN COMPLETED.

CONSTRUCTION INSPECTION SCHEDULE:

1) PRE INSPECTION OF THE LAND AREA TO BE AFFECTIVE. 2) INSPECTION OF THE HAYBALES, SILT FENCE AND ETC. 3) FOOTING INSPECTION 4) STOCKPILE INSPECTION 5) FINAL GRADE & VEGETATION INSPECTION

SPECIFICATIONS:

CONDITIONS:

1. ALL WORK MUST BE PERFORMED IN ACCORDANCE W/ THE TOWN OF NORTH CASTLE BUILDING CODE, & THE NEW YORK STATE UFPBC AND ALL OTHER APPLICABLE ORDINANCES, REGULATIONS, AND STANDARDS REQUIRED. 2. ALL MANUFACTURED ITEMS SHALL BE INSTALLED OR APPLIED AS DIRECTED BY THE MANUFACTURERS RECOMMENDATIONS.

3. CONTRACTOR TO INCLUDE ALL MATERIALS, LABOR, INCIDENTALS AND SERVICES FOR

SATISFACTORYS COMPLETION OF THE WORK. 4. CONTRACTOR SHALL VERIFY ALL EXISTING CONDITIONS IN THE FIELD AND SHALL NOTIFY THE

ARCHITECT OF ANY DISCREPANCIES BEFORE STARTING THE WORK. 5. CONTRACTOR SHALL PERFORM ALL WORK REQUIRED FOR THE TOTAL COMPLETION OF THE PROJECT, WHETHER OR NOT INDICATED ON THE DRAWINGS. THE INTENTION OF THE DRAWINGS IS FOR A COMPLETE AND PROPER FUNCTIONING OF THE ENTIRE PROJECT.

INSURANCE:

1. CONTRACTOR, AND HIS SUBCONTRACTORS, SHALL MAINTAIN WORKMEN'S CONPENSATION INSURANCE AS WELL AS ADEQUATE LIABILITY INSURANCE DURING THE ENTIRE LENGTH OF THE JOB. 2. OWNER SHALL PROVIDE ADEQUATE PROPERTY INSURANCE ON VALUE OF THE CONSTRUCTION, INCLUDING FIRE & VANDALISM.

PERMITS & SURVEYS

1. CONTRACTOR SHALL FURNISH ALL PERMITS, LICENSES AND APPROVALS NECESSARY TO COMPLETE THE WORK. 2. BUILDING SHALL BE STAKED OUT BY A LICENSED SURVEYOR WHO SHALL FILE A FINAL SURVEY AT


THE COMPLETION OF WORK. 3. CONTRACTOR SHALL PROVIDE TEH OWNER WITH A CERTIFICATE OF OCCUPANCY UPON COMPLETION OF WORK.

SITE MAINTENANCE:

1. JOB SITE TO BE KEPT CLEAN AT ALL TIMES, TRASH TO BE REMOVED FROM THE SITE WEEKLY OR STORED IN APPROVED DUMPSTER UNTIL FULL THAN THAN CARTED AWAY FROM THE SITE. 2. CARE SHALL BE TAKEN TO PROTECT THE TREES ON THE PROPERTY FROM THE METHODS AND MANNERS OF CONSTRUCTION. TRAFFICKING AND STORAGE OF MATERIALS. RETURN THOSE AREAS DAMAGED BY SUCH TO THEIR ORIGINAL CONDITION.

EXCAVATION:

1. STOCKPILE ALL EXCAVATED SOIL FOR FUTURE REUSE AS FILL MATERIAL OR REMOVE AND DISPOSE OF AS REQUIRED.

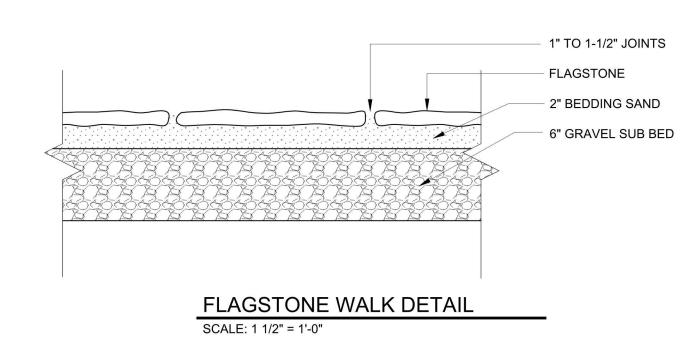

EROSION CONTROL NOTES:

1. CONTRACTOR SHALL BE RESPONSIBLE FOR COMPLIANCE WITH ALL SEDIMENT AND EROSION CONTROL PRACTICES. THE SEDIMENT AND EROSION CONTROL PRACTICES ARE TO BE INSTALLED PRIOR TO ANY MAJOR SOIL DISTURBANCES, AND MAINTAINED UNTIL PERMANENT PROTECTION IS ESTABLISHED.

2. TIMELY MAINTENANCE OF SEDIMENT CONTROL STRUCTURES IS THE RESPONSIBILITY OF THE CONTRACTOR. ALL STRUCTURES SHALL BE MAINTAINED IN GOOD WORKING ORDER AT ALL TIMES. THE SEDIMENT LEVEL IN ALL SEDIMENT TRAPS SHALL BE CLOSELY MONITORED AND SEDIMENT REMOVED PROMPTLY WHEN MAXIMUM LEVELS ARE REACHED OR AS ORDERED BY THE ENGINEER. ALL SEDIMENT CONTROL STRUCTURES SHALL BE INSPECTED ON A REGULAR BASIS, AND AFTER EACH HEAVY RAIN TO INSURE PROPER OPERATION AS DESIGNED. AN INSPECTION SCHEDULE SHALL BE SET FORTH PRIOR TO THE START OF CONSTRUCTION

3. THE LOCATIONS AND THE INSTALLATION TIMES OF THE SEDIMENT CAPTURING STANDARDS SHALL BE AS ORDERED BY THE ENGINEER, AND IN ACCORDANCE WITH THE STANDARDS SET FORTH IN THIS MANUAL.

4. ALL TOPSOIL NOT TO BE USED FOR FINAL GRADING SHALL REMOVED FROM THE SITE IMMEDIATELY AND PLACED IN A STABILIZED STOCKPILE OR FILL AREA. ALL TOPSOIL REQUIRED FOR FINAL GRADING AND STORED ON SITE SHALL BE LIMED, FERTILIZED, TEMPORARILY SEEDED AND MULCHED WITH 14 DAYS.

5. ANY DISTURBED AREAS THAT WILL BE LEFT EXPOSED MORE THAN 21 DAYS AND NOT SUBJECT TO CONSTRUCTION TRAFFIC, SHALL IMMEDIATELY RECEIVE TEMPORARY SEEDING. MULCH SHALL BE USED IF THE SEASON PREVENTS THE ESTABLISHMENT OF A TEMPORARY COVER. DISTURBED AREAS SHALL BE LIMED AND FERTILIZED PRIOR TO TEMPORARY SEEDING.

6. ALL DISTURBED AREAS WITHIN 500 FEET OF AN INHABITED DWELLING SHALL BE WETTED AS NECESSARY TO PROVIDE DUST CONTROL.

7. THE CONTRACTOR SHALL KEEP THE ROADWAYS WITHIN THE PROJECT CLEAR OF SOIL AND DEBRIS AND IS RESPONSIBLE FOR ANY STREET CLEANING NECESSARY DURING THE COURSE OF

8. SEDIMENT AND EROSION CONTROL STRUCTURES SHALL BE REMOVED AND THE AREA STABILIZED WHEN THE DRAINAGE AREA HAS BEEN PROPERLY STABILIZED BY PERMANENT MEASURES.

9. ALL SEDIMENT AND EROSION CONTROL MEASURES SHALL BE INSTALLED IN ACCORDANCE WITH CURRENT EDITION OF "WESTCHESTER COUNTY BEST MANAGEMENT PRACTICES MANUAL FOR EROSION AND SEDIMENT CONTROL".

10. ALL DESIGNATED TREES SHALL BE PROTECTED DURING THE CONSTRUCTION PERIOD, EXCEPT THOS DESIGNATED TO BE REMOVED. TREE PROTECTION SHALL BE IN ACCORDANCE WITH THE WESTCHESTER COUNTY BEST MANAGEMENT PRACTICES MANUAL

STABILIZE ENTIRE PILE WITH

SLOPE OR LESS 1

MIN. SLOPE

INSTALLATION NOTES:

SCALE: 1/4" = 1'-0"

BERM

PROPOSED

2% TO 4% SLOPE

8" TO 12" BERM -

PROPOSED SUBGRADE

STRAWBALES OR SILTFENCE

N.T.S

2. MAXIMUM SLOPE OF STOCKPILE SHALL BE 1:2

SOIL STOCKPILE DETAIL

PERSPECTIVE

1. AREA CHOSEN FOR STOCKPILES OPERATIONS SHALL BE DRY AND STABLE.

4. SEE SPECIFICATIONS (THE MANUAL) FOR INSTALLATION OF SILTFENCE.

SECTION

N.T.S

DRIVEWAY BERM

3. UPON COMPLETION OF SOIL STOCKPILING, EACH PILE SHALL BE SURROUNDED

WITH EITHER SILT FENCING OR STRAWBALES, THEN STABILIZED WITH VEGETATION

ROADWAY

WEGETAITON OR COVER

(MIN. 14 GAUGE W/ MAX. 6" MESH 10' MAX. C. TO C. SPACING) 36" MIN. LENGTH FENCE POSTS DRIVEN MIN. 16" INTO GROUND. **HEIGHT OF FILTER** = 16" MIN. 36" MIN. FENCE POST WOVEN WIRE FENCE (MIN. 14 1/2 GAUGE W/ MAX. 6" MESH SPACING) WITH FILTER CLOTH UNDISTURBED GROUND COMPACTED SOIL ---EMBED FILTER CLOTH A MIN. OF 6" IN GROUND. SILT FENCE DETAIL SCALE: 1/4" = 1'-0" CONSTRUCTION SPECIFICATIONS 1. WOVEN WIRE FENCE TO BE FASTENED SECURELY TO FENCE POSTS WITH WIRE TIES OR STAPLES. POSTS SHALL BE STEEL EITHER "T" OR "U" TYPE OR HARDWOOD.

WOVEN WIRE FENCE


2. FILTER CLOTH TO BE TO BE FASTENED SECURELY TO WOVEN WIRE FENCE WITH TIES SPACED EVERY 24" AT TOP AND MID SECTION. FENCE SHALL BE WOVEN WIRE,

3. WHEN TWO SECTIONS OF FILTER CLOTH ADJOIN EACH OTHER THEY SHALL BE OVER-LAPPED BY SIX INCHES AND FOLDED. FILTER CLOTH SHALL BE EITHER FILTER X, MIRAFI 100X, STABILINKA T140N, OR APPROVED EQUIVALENT.

4. PREFABRICATED UNITS SHALL BE GEOFAB, ENVIROFENCE, OR APPROVED EQUIVALENT 5. MAINTENANCE SHALL BE PERFORMED AS NEEDED AND MATERIAL REMOVED WHEN

"BULGES" DEVELOP IN THE SILT FENCE. ADAPTED FROM DETAILS PROVIDED BY: USDA - NRCS, NEW YORK STATE DEPARTMENT OF TRANSPORTATION,

6" MAXIMUM MESH OPENING.

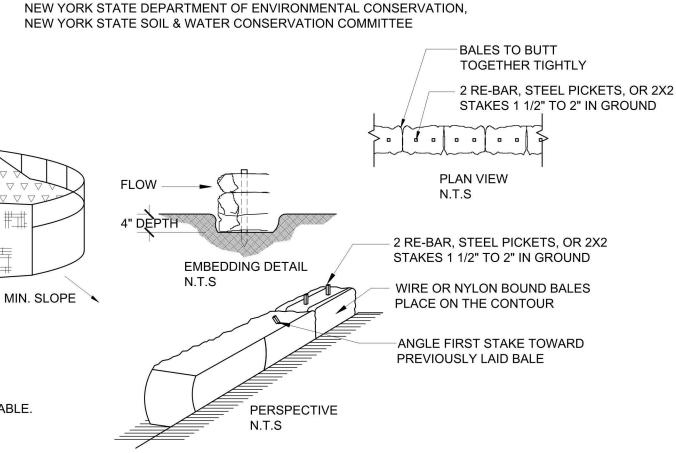

INSTALLATION NOTES:

PERSPECTIVE

SCALE: N.T.S.


INLET PROTECTION

1. BALES SHALL BE PLACE IN A ROW WITH ENDS TIGHTLY ABUTTING THE ADJACENT BALES.

2. EACH BALE SHALL BE EMBEDDED IN THE SOIL A MINIMUM OF 4". 3. BALES SHALL BE SECURELY ANCHORED IN PLACE BY STAKES OR RE-BAR DRIVEN THROUGH THE BALES. THE FIRST STAKE IN EACH BALE SHALL BE

ANGLED TOWARD PREVIOUSLY LAID BALE TO FORCE BALES TOGETHER. 4. BALES SHALL BE REMOVED WHEN THEY HAVE SERVED THEIR USEFULNESS SO AS NOT TO BLOCK OR IMPEDE STORM FLOW OR DRAINAGE.

SEDIMENT CONTROL NOTE: SEDIMENT CONTROL AT INDICATE PROPERTY LINES SHALL BE PERFORMEDOW DURING PROPERTY STATEMAIN AND GRADING, AND SHALL REMAIN LINE L'PROPER FINAL CURBING, DRAINAGE, AND GRADING IS COMPLEYED

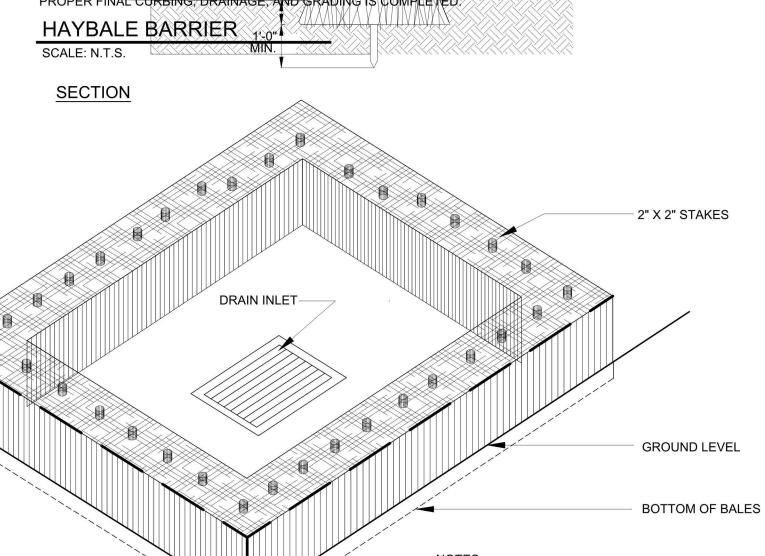

BALES.

1. ALL BALES ARE TO BE TIGHTLY BUTTED TOGETHER

3. PROVIDE FREQUENT INSPECTION AND MAINTENANCE.

REMOVE ACCUMULATED SEDIMENT AND REPLACE

CLOGGED BALES TO MAINTAIN EFFECTIVENESS OF

2. BALES SHALL BE EITHER STRAW OR HAY

INSTALLATION.

1. USE THIS DETAIL WHERE USE OF PROTECTIVE FENCING DOES NOT ALLOW FOR SUFFICIENT CONSTRUCTION MANEUVERING ROOM 2. REMOVE ALL CHOKERS, BOARDS, ROPES, FILL AND PLYWOOD IMMEDIATELY AFTER COMPLETION OF CONSTRUCTION. IF CONSTRUCTION TIME IS EXTENDED, DO NOT ALLOW THESE MATERIALS TO STRANGULATE TREE OR DAMAGE BARK. 3. IF LOWER LIMBS INTERFERE WITH WORK, TIE UP WITH HEAVY DUTY JUTE CORD. 4. TIE UP LIMBS IN WARM WEATHER IF POSSIBLE. 5. ADJUST HEIGHT OF PROTECTIVE BOARDS TO PREVENT ANTICIPATED DAMAGE BY EQUIPMENT. OUTLINE OF TREE CROWN (EDGE OF DRIPLINE) CORRESPONDS WITH ROOT SPREAD TRUNK PROTECTION BOARDS (2" THK) BENEATH BOARDS ARE 3-4 LAYERS OF BURLAP AROUND TRUNK TIE BOARDS SECURELY AT TOP, BOTTOM AND CENTER WITH HEAVY DUTY CORD, WIRE, OR CABLE CHOKERS. COVER PLYWOOD LAYER WITH (3'-6") FILL

> SPREAD (3/4") THICK (USED) PLYWOOD SHEETS OR EQUAL AT WITHOUT PERMISSION IS PROHIBITED. TREE BASE TO ABSORB OR SPREAD ANY VEHICULAR LOADS OVER ROOT AREA WITHIN DRIPLINE ZONE. MUNICIPALITY: TOWN OF NORTH CASTLE PROPERTY INDEX: **SECTION: 107.02** BLOCK: 02 LOT: 46

> > TO REMAIN


INSTALL FENCING AT

DRIPLINE OF EXISTING

TREE WHERE POSSIBLE

STORM WATER REVIEW STORM WATER REVIEW 08/24/21 **ISSUED FOR** DATE **EXISTING TREE** REVISIONS UNDISTURBED ALL CONSTRUCTION FENCING TO BE **INSTALLED PRIOR** TO START OF WORK

ZONE: R-2A

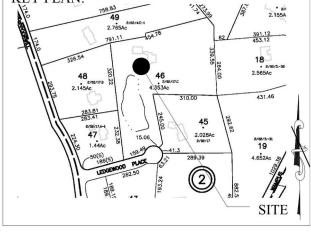

ROLLANO ENGINEERING, P.C.

411 THEODORE FREMD AVE.

SUITE 206 RYE, NY 10580

phone: 914.925.3584 fax: 914.925.3434

RollanoEngineers@aol.com

PLANS ARE NOT TO BE SCALED. CONTRACTOR IS TO

MAKE NO ASSUMPTIONS WITH REGARD TO THESE

DIMENSIONS REQUIRED TO PROPERLY ESTIMATE OR

ENGINEER UPON REQUEST. CONTRACTOR SHALL VERIFY

INDICATED ON THIS DRAWING AND BE RESPONSIBLE FOR

SAME, ANY DISCREPANCIES BETWEEN THE DRAWINGS

ENGINEER BEFORE PROCEEDING WITH THE WORK.

THESE DRAWINGS SHALL NOT BE ALTERED WITHOUT

AND FIELD CONDITIONS SHOULD BE REPORTED TO THE

THE CONSENT AND KNOWLEDGE OF THE ENGINEER. ALL REPRODUCTION RIGHTS RESERVED. REPRODUCTION

DRAWINGS. ANY ADDITIONAL INFORMATION OR

ERECT THIS PROJECT WILL BE SUPPLIED BY THE

IN THE FIELD ALL DIMENSIONS AND CONDITIONS

SCOPE OF WORK:

PROPOSED LOCATION OF NEW ONE-FAMILY DWELLING

PROJECT LOCATION:

4 LEDGEWOOD PLACE ARMONK, NEW YORK

SHEET TITLE:

EROSION CONTROL DETAILS


PROJECT #: 21-082421 AS NOTED SCALE: DATE: 05/13/22 DRAWN BY: JOSEPH PATERNO, LEED AP

REVIEWED BY: LOUIS E. ROLLANO, P.E. SHEET NO.:

SHEET: 2 OF 2

SCALE: N.T.S.

AREA HAS BEEN PROPERLY STABILIZED.

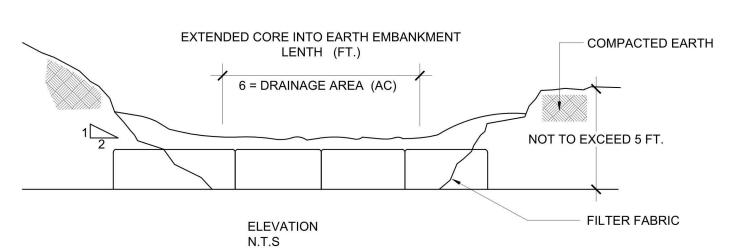

DRIP LINE

DRIP LINE

TYP TREE PROTECTION

(DURING CONSTRUCTION)

INSTALLATION NOTES:

TYP TREE PROTECTION

(DURING CONSTRUCTION)

(4) 2 X 4

4 STAKES

1. AREA UNDER EMBANKMENT SHALL BE CLEARED, GRUBBED, AND STRIPPED OF ANY VEGETATION AND ROOT MAT. THE POOL AREA SHALL BE CLEARED AS WELL.

2. THE FILL MATERIAL FOR THE EMBANKMENT SHALL BE FREE OF ROOTS OR OTHER WOODY VEGETATION AS WELL AS OVER SIZED STONES, ROCKS, ORGANIC MATERIAL AND OTHER QUESTIONABLE MATERIAL. THE EMBANKMENT SHALL BE COMPACTED BY TRAVERSING WITH EQUIPMENT WHILE IT IS BEING CONSTRUCTED.

3. THE STRUCTURE SHALL BE REMOVED AND TRAP RESTORED TO ITS ORIGINAL DIMENSIONS WHEN THE SEDIMENT HAS ACCUMULATED TO 1/2 THE DESIGN DEPTH OF THE TRAP. REMOVED SEDIMENT SHALL BE DEPOSITED IN A SUITABLE AREA AND IN SUCH A MANNER THAT IT WILL NOT ERODE.

4. THE STRUCTURE SHALL BE INSPECTED AFTER EACH RAIN REPAIRS MADE AS NEEDED.

6. THE STRUCTURE SHALL BE REMOVED AND THE AREA STABILIZED WHEN THE DRAINAGE

5. CONSTRUCTION OPERATIONS SHALL BE CARRIED OUT IN SUCH A MANNER THAT EROSION AND WATER POLLUTION IS MINIMIZED.

7. ALL CUT AND FILL SLOPES SHALL BE 1:2 OR FLATTER.

TEMPORARY SEDIMENT BASIN