# Architectural Review Board Minutes February 1, 2023

<b>Board Members</b>	Present	Excused	
Beata Buhl- Tatka	X		Review#, constituting page(s)
Susan Geffen			Resubmission?
Chris Tuzzo	X		Past submission dates:
Mel Orellana			Required to resubmit?
John Scarlato	X		•

Lori J. Zawacki, Secretary (273-3000)

Project Identification: 107.02-2-46

Zone R2A Sq. Footage

Owner: 4 Ledgewood Pl LLC

Location 4 Ledgewood Place, Armonk, NY 10504

Contractor

Sign Contractor

Structure Type

Architect

Project Delegate Joseph Guglielmo

Project Description: New One Family House

Board Action:
Approved as Submitted

Board Member Vote 3-0
AYE NAY ABSTAIN

BEATA TATKA X
SUSAN GEFFEN

X

X

Motioned by: Beata Buhl-Tatka

CHRIS TUZZO

MEL ORELLANA JOHN SCARLATO

Seconded by: Christopher Tuzzo

Remarks: This project was approved for design, size colors and materials per the site plan and erosion control plans submitted by Rollano Engineering P.C. and Planting Plan and Detail from Yost Design Landscape Architecture and floor plans by Joseph Guglielmo, Architect, consisting of 7 pages with material s and schedules on pages A6 and A7.

The Building Department will notify you regarding what is needed to obtain a Building Permit.

<u>A Building Permit is necessary before commencing construction!</u>

Public Comments: none



is \$20,000 or more.

### Town of North Castle Building Department

17 Bedford Road
Armonk, New York 10504-1898
Telephone: (914) 273-3000 ext. 44 Fax: (914) 273-3554
www.northcastleny.com

### **Residential Building Permit Application**

NOTE: TWO (2) SETS OF ALL REQUIRED DOCUMENTS MUST BE SUBMITTED WITH THIS APPLICATION

•
Section I- PROJECT ADDRESS: 4 LED GEWOOD PL DATE: JAH 4, 2023
Section II- CONTACT INFORMATION: (Please print clearly, All information must be current)
APPLICANT: 4 Ledgewood PI UC
ADDRESS: 200 SLIMMERFIELD ST SQUESCHE M 10583
PHONE: 914 703 2378 EMAIL: Janie Spectrupaintingnye.c
PROPERTY OWNER: RIND MONTEFORE
ADDRESS: 52 Wights Mul Rd Amone My 10504
PHONE: 0462616111 MOBILE: EMAIL: RINGE, Spectrumpountingry
Section III- DESCRIPTION OF WORK: (Any work conducted outside of the house requires approval from the RPRC unless the proposed action is minor in nature and complies with 355-26 C (3) of the Town of North Castle code.)  NEW SINGLE FAMILY DWELLING
Section IV- USE AND OCCUPANCY:
EXISTING/ CURRENT USE: SINGLE FAMLY  JAN 2 0 2023
PROPOSED RESIDENTIAL:  TOWN OF WORTH CASTLE
One Family Dwelling [ ] Two Family Dwelling [ ] Townhouse BUILP Detached Accessory Structure
Section V- PERMIT FEES: (\$100 app fee plus \$14 per \$1000, cost of construction.)
ESTIMATED COST OF CONSTRUCTION (Based on fair market value labor & material) \$ 850,000,00
AFFIDAVIT OF CONSTRUCTION COST: This affidavit must be completed by the Design Professional if the estimated cost

# Town of North Castle Building Department

do hereby affirm and certify as follows: (i) I am the architect engineer (circle one) licensed by the State of New York; (ii) I have reviewed the plans, drawings and specifications for this application and am fully familiar with the proposed construction; (iii) based on my experience, I estimate the total cost of construction including all labor, all materials, all professional fees and all associated costs to be approximately section and (iv) pursuant to Penal Law 210.45, I acknowledge that a false statement made knowingly is a Class A misdeprenance.  Date: JAN 4, 2022	
Digital C. The Company of the Compan	
Sign and Affix Seal Here	
/ Supplies must be current)	
Section VI- CONTACT INFORMATION: (Please print clearly, All information must be current)	
ARCHITECT/ ENG: JOSEPH GUGLIEUMO ARCHMECT	ŧ.
64 ROGERS DR NEW ROCHEUR, NY 10809	-0
011- C2011, 7157 MORILE: 4	
EMAIL: JGNYarch@GMAIL.COM	į
CONTRACTOR:	-
ADDAMOS.	
PHONE:	_
PLUMBER:	
	<b>-</b> 88
ADDRESS:	-
·	
ELECTRICIAN:	
ADDRESS:	
PHONE:MOBILE:EMAIL: `	77.7
Section VII- APPLICANT CERTIFICATION  I hereby certify that I have read the instructions & examined this application and know the same to be true & correct.  All provisions of laws & ordinances covering this type of work will be complied with whether specified herein or not. The provisions of laws are to give authority to violate or cancel the provisions of any other state or local law granting of a permit does not presume to give authority to violate or cancel the provisions of any other state or local law granting of a permit does not presume to give authority to violate or cancel the provisions of any other state or local law granting of a permit does not presume to give authority to violate or cancel the provisions of any other state or local law granting of a permit does not presume to give authority to violate or cancel the provisions of any other state or local law granting of a permit does not presume to give authority to violate or cancel the provisions of any other state or local law granting of a permit does not presume to give authority to violate or cancel the provisions of any other state or local law granting of a permit does not presume to give authority to violate or cancel the provisions of any other state or local law granting of a permit does not presume to give authority to violate or cancel the provisions of any other state or local law granting of a permit does not presume to give authority to violate or cancel the provisions of any other state or local law granting of a permit does not presume to give authority to violate or cancel the provisions of any other state or local law granting of a permit does not presume to give authority to violate or cancel the provisions of any other state or local law granting or law grant	he w
granting of a permit does not presume to give authors, regulating construction or land use or the performance of construction.  Date:	

## Town of North Castle Building Department

Section VIII- AFFIDAVIT OF OWNER AUTHORIZATION STATE OF NEW YORK } COUNTY OF WESTCHESTER } SS: The applicant 4 Ledgewood Pluc has proper submitted and said owner agrees to all terms and conditions place	O My consent from said o ed upon same.	commission Expires 1	er County
Owner's Name (PRINT) RINO MONTGON Cow.  Sworn to before me this 18 day of 101, 20	73 11	de a. m.	Cour
OFFICE USE ONLY - DO NOT W	RITE BELOW TH	HIS LINE	
Zone: Section: I		1	
Building Department Checklist:		*	
Does this permit require RPRC approval? [ ] Yes [ ]No		•	
[ ] GC License [ ] Work. Comp. [ ] Liability. Ins.	[ ] Disability	[ ] Two sets of	documents
[ ] Permit Fee Payment: [ ] Check #:			[] Cash
Name on check:			
Received By:	Application No.:	ir	
BUILDING INSPECT			
* 6*			* -71
Has all the conditions of the RPRC been met? [ ] Yes		3	
Is a Flood Development permit required? [ ] Yes [ ] No	)		
Reviewed By:	Date:		
Building Inspector Approval:		Date:	
Conditions:		€	
	2		· · · · · · · · · · · · · · · · · · ·


# 4 LEDGEWOOD PL. ID: 107.02-2-46 (North Castle )



December 4, 2022

Tax parcel data was provided by local municipality. This map is generated as a public service to Westchester County residents for general information and planning purposes only, and should not be relied upon as a sole informational source. The County of Westchester hereby disclaims any libelity from the use of this CIS mapping system by any person or entity. Tax parcel boundaries represent approximate property line location and should NOT be interpreted as or used in lieu of a survey or property boundary description. Property descriptions must be obtained from surveys or deeds. For more information please contact local municipality assessor's office.


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### JOSEPH GUGLIELMO ARCHITECT

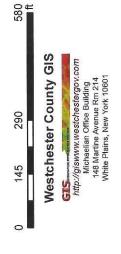64 ROGERS DRIVE NEW ROCHELLE, NY 10804 TEL. (914) 804-7157 JGNYarch@gmall.com




60 WHIPPOORWILL ROAD (ADJACENT LEFT)

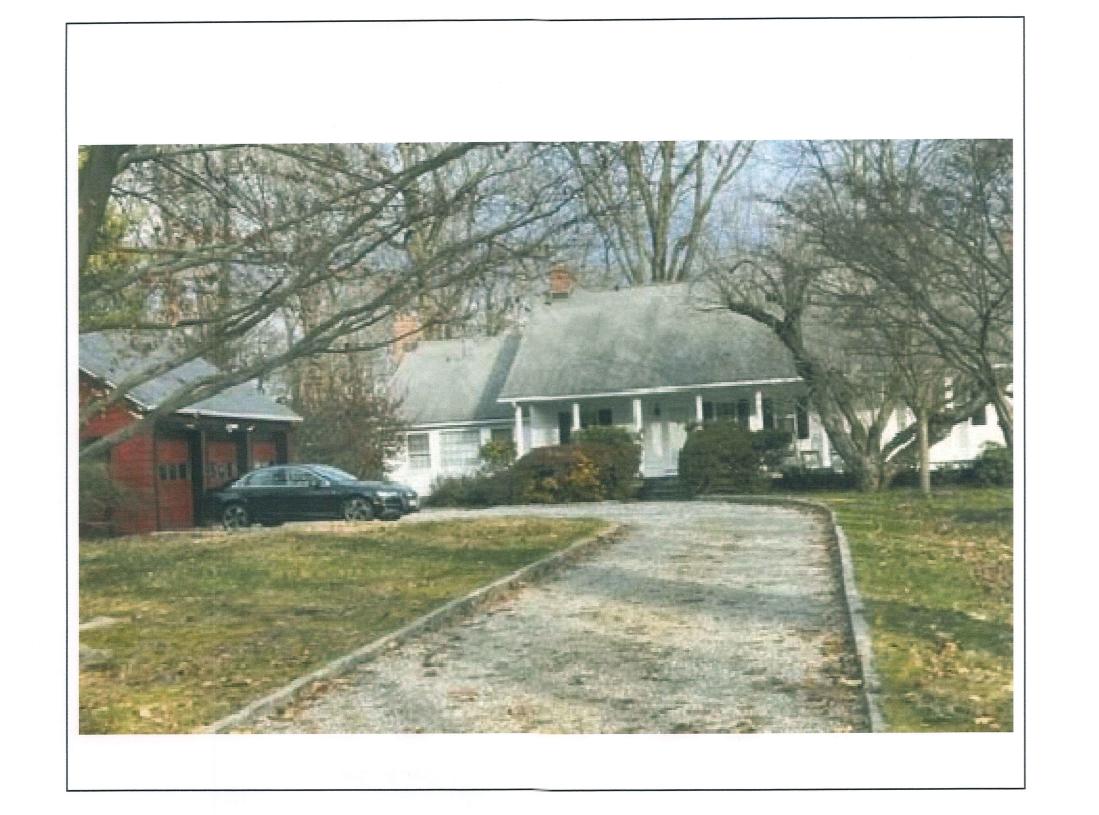


4 LEDGEWOOD PLACE (PROJECT SITE)



6 LEDGEWOOD PLACE (ADJACENT RIGHT)

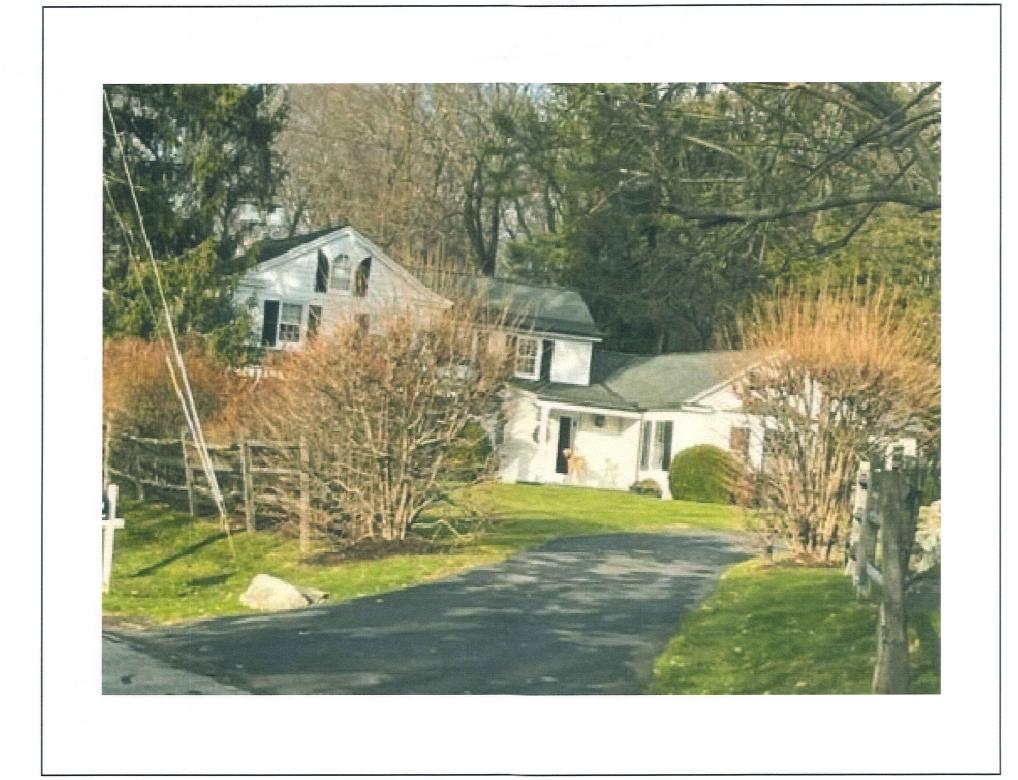


58 WHIPPOORWILL ROAD (ACROSS LEFT)

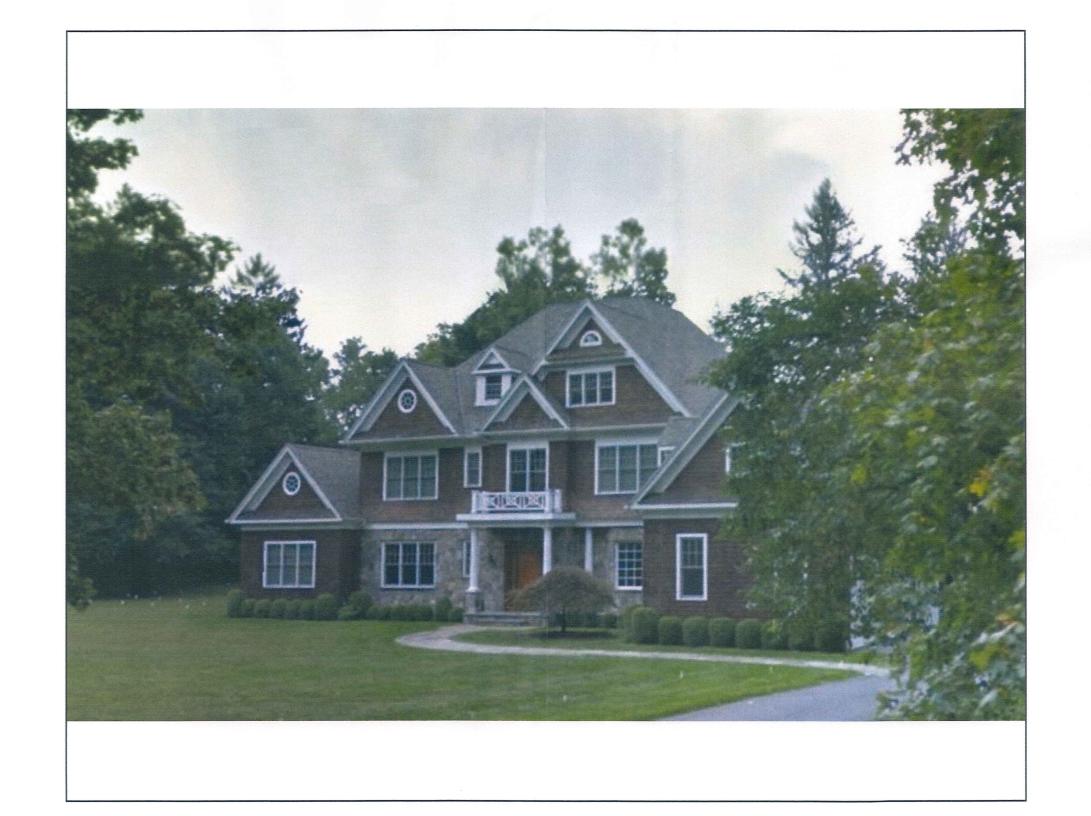


LEDGEWOOD PLACE (ACROSS)



3 LEDGEWOOD PLACE (ACROSS)

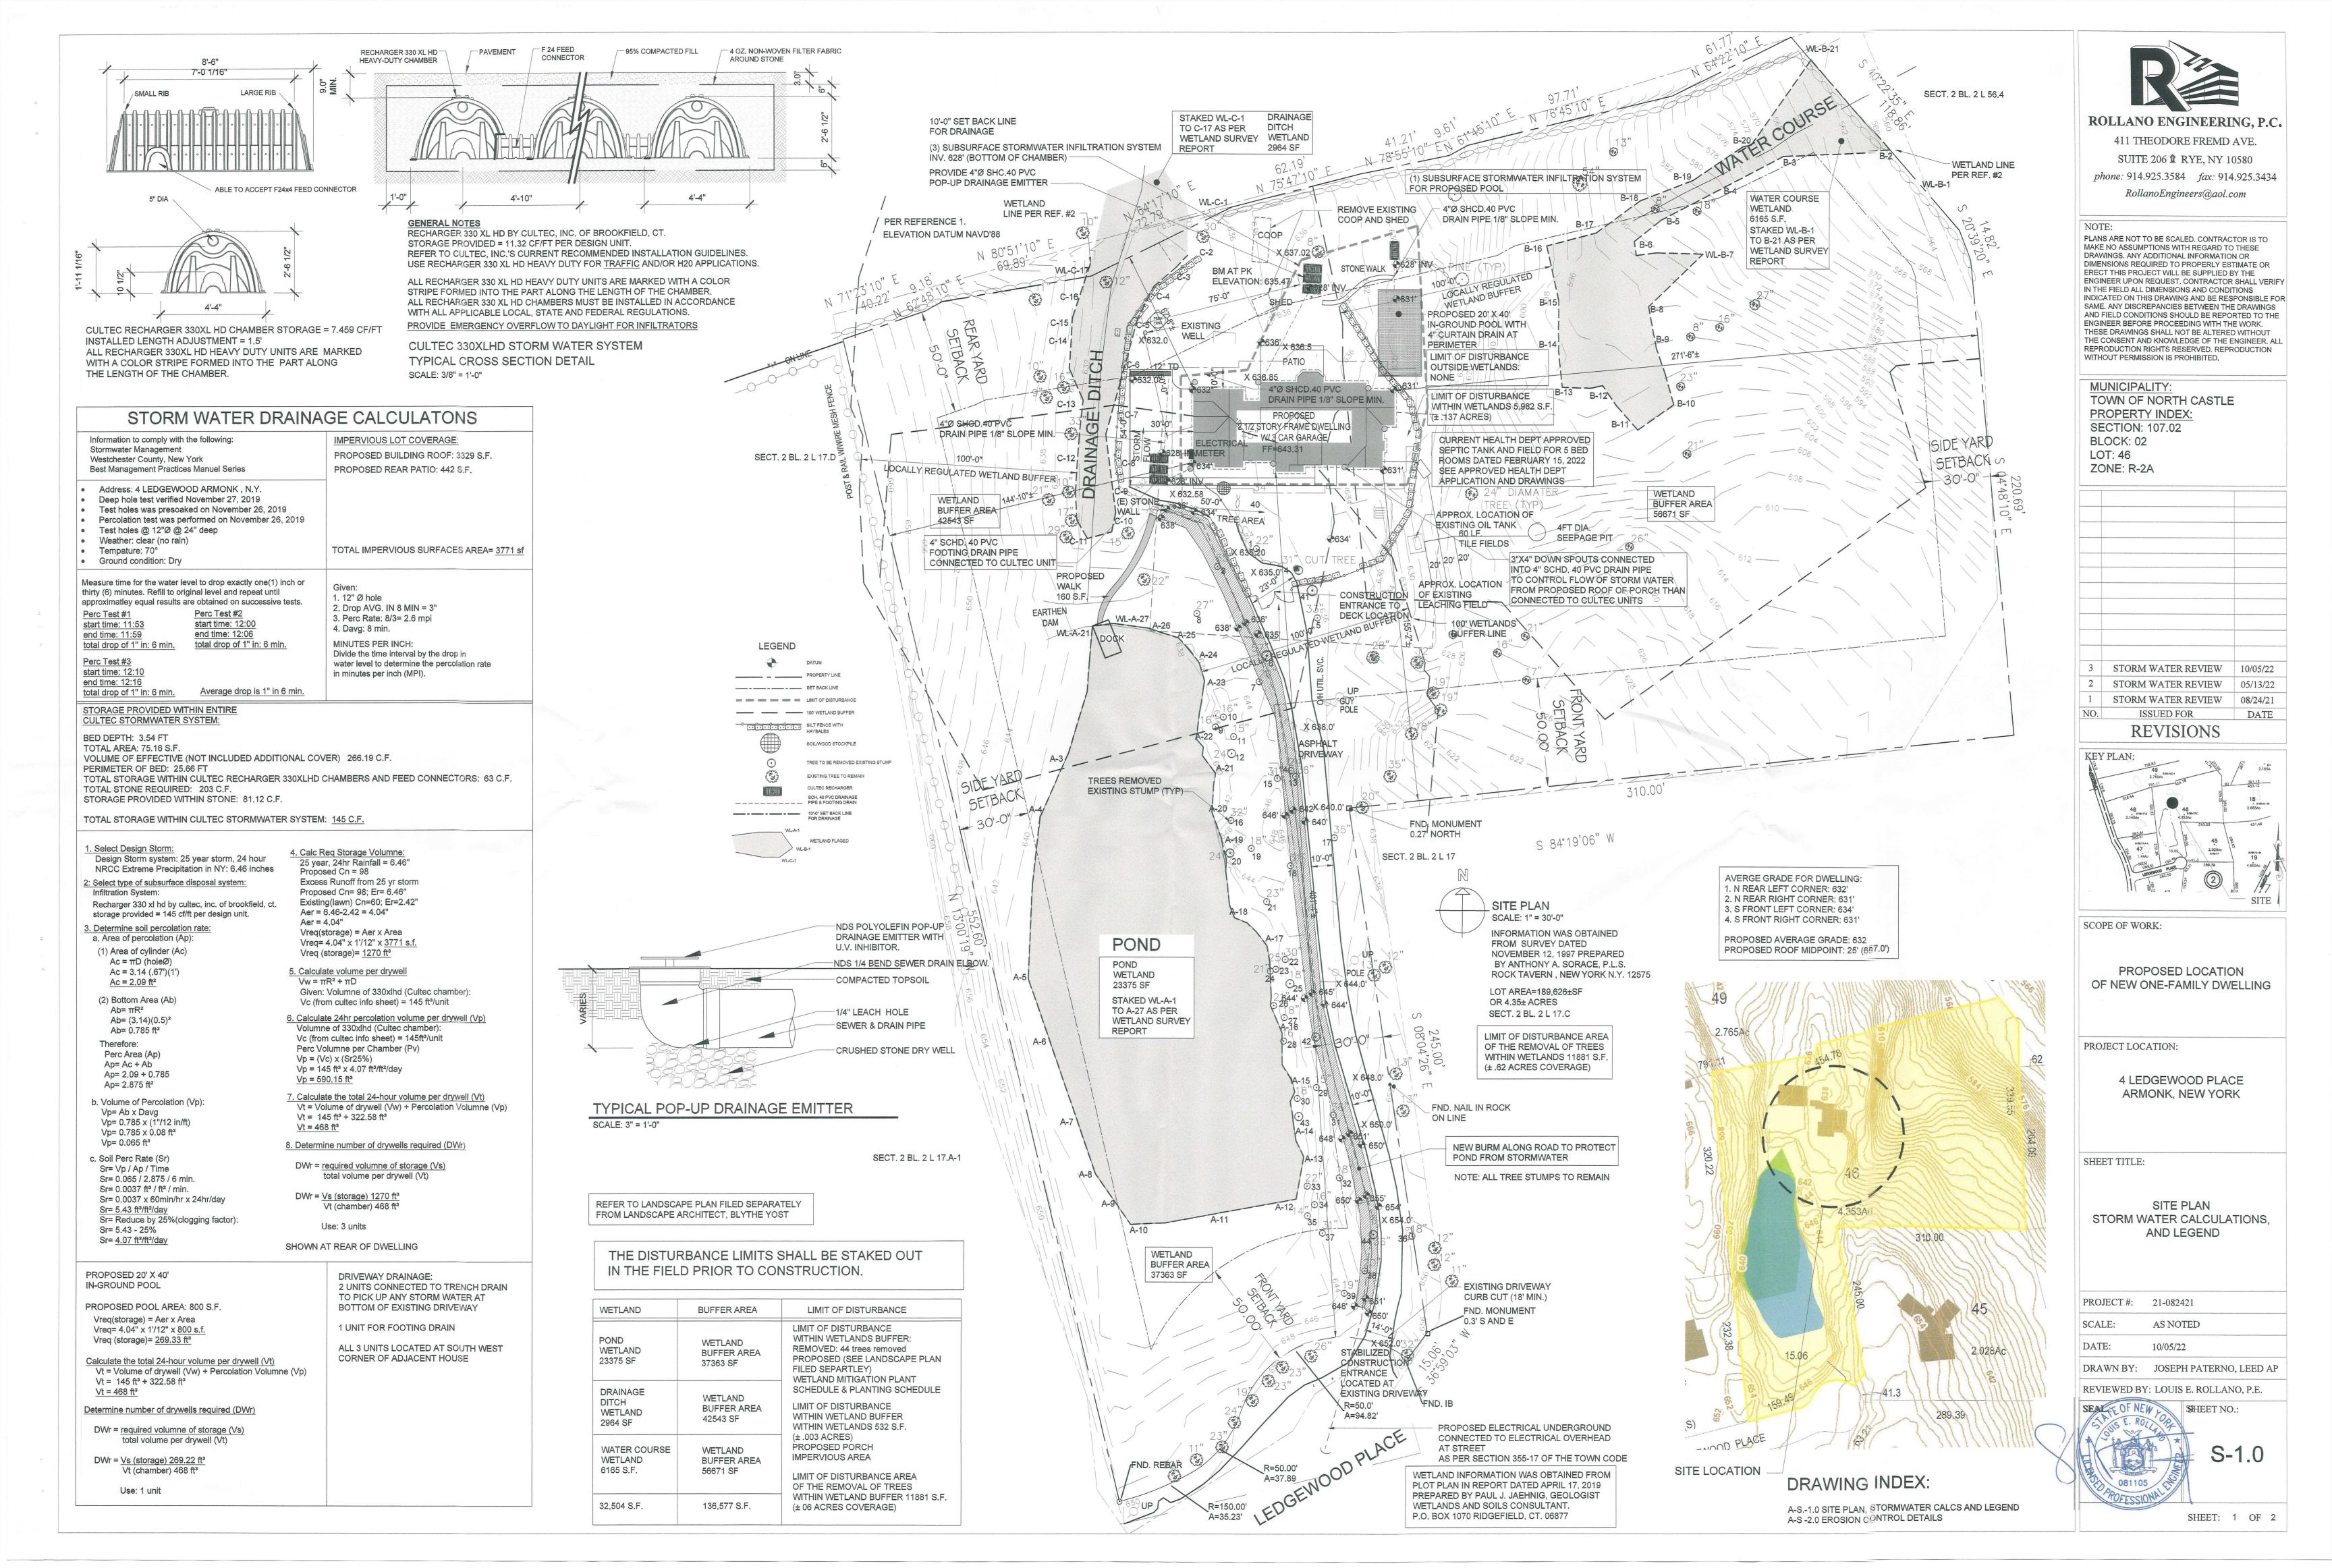

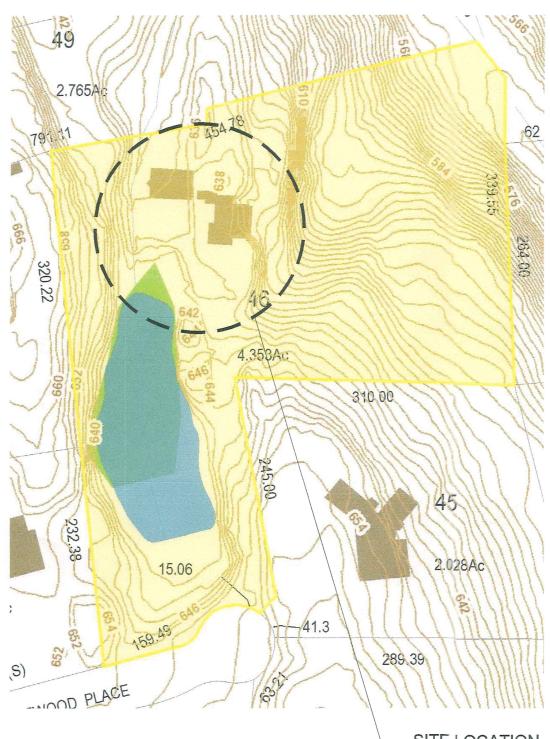

### SITE LOCATION

### **EROSION AND SEDIMENT CONTROL INSPECTIONS:**

1) AN INITIAL INSPECTION PRIOR TO THE PLAN APPROVAL 2) AN EROSION AND SEDIMENT CONTROL INPSECTION TO ENSURE THAT EROSION AND SEDIMENT CONTROL PRACTICES ARE IN ACCORD WITH THE APPROVED PLAN. 3) AN INSPECTION PRIOR TO BACKFILLING ANY UNDERGROUND DRAINAGE OR STORMWATER 4) A FINAL INSPECTION WHEN ALL WORK, INCLUDING CONSTRUCTION OF STORMWATER

MANAGEMENT FACILITIES AND PERMANENT SOIL STABILIZATION, HAS BEEN COMPLETED.

### CONSTRUCTION INSPECTION SCHEDULE:

1) PRE INSPECTION OF THE LAND AREA TO BE AFFECTIVE. 2) INSPECTION OF THE HAYBALES, SILT FENCE AND ETC. 3) FOOTING INSPECTION 4) STOCKPILE INSPECTION

### 5) FINAL GRADE & VEGETATION INSPECTION

SPECIFICATIONS:

1. ALL WORK MUST BE PERFORMED IN ACCORDANCE W/ THE TOWN OF NORTH CASTLE BUILDING CODE, & THE NEW YORK STATE UFPBC AND ALL OTHER APPLICABLE ORDINANCES, REGULATIONS, AND STANDARDS REQUIRED. 2. ALL MANUFACTURED ITEMS SHALL BE INSTALLED OR APPLIED AS DIRECTED BY THE

MANUFACTURERS RECOMMENDATIONS. 3. CONTRACTOR TO INCLUDE ALL MATERIALS, LABOR, INCIDENTALS AND SERVICES FOR

SATISFACTORYS COMPLETION OF THE WORK. 4. CONTRACTOR SHALL VERIFY ALL EXISTING CONDITIONS IN THE FIELD AND SHALL NOTIFY THE ARCHITECT OF ANY DISCREPANCIES BEFORE STARTING THE WORK.

5. CONTRACTOR SHALL PERFORM ALL WORK REQUIRED FOR THE TOTAL COMPLETION OF THE PROJECT, WHETHER OR NOT INDICATED ON THE DRAWINGS. THE INTENTION OF THE DRAWINGS IS FOR A COMPLETE AND PROPER FUNCTIONING OF THE ENTIRE PROJECT.

### INSURANCE:

1, CONTRACTOR, AND HIS SUBCONTRACTORS, SHALL MAINTAIN WORKMEN'S CONPENSATION INSURANCE AS WELL AS ADEQUATE LIABILITY INSURANCE DURING THE ENTIRE LENGTH OF THE JOB. 2. OWNER SHALL PROVIDE ADEQUATE PROPERTY INSURANCE ON VALUE OF THE CONSTRUCTION, INCLUDING FIRE & VANDALISM.

### PERMITS & SURVEYS

1, CONTRACTOR SHALL FURNISH ALL PERMITS, LICENSES AND APPROVALS NECESSARY TO COMPLETE THE WORK. 2. BUILDING SHALL BE STAKED OUT BY A LICENSED SURVEYOR WHO SHALL FILE A FINAL SURVEY AT

THE COMPLETION OF WORK. 3. CONTRACTOR SHALL PROVIDE TEH OWNER WITH A CERTIFICATE OF OCCUPANCY UPON COMPLETION OF WORK.

### SITE MAINTENANCE:

1. JOB SITE TO BE KEPT CLEAN AT ALL TIMES, TRASH TO BE REMOVED FROM THE SITE WEEKLY OR STORED IN APPROVED DUMPSTER UNTIL FULL THAN THAN CARTED AWAY FROM THE SITE. 2. CARE SHALL BE TAKEN TO PROTECT THE TREES ON THE PROPERTY FROM THE METHODS AND MANNERS OF CONSTRUCTION. TRAFFICKING AND STORAGE OF MATERIALS. RETURN THOSE AREAS DAMAGED BY SUCH TO THEIR ORIGINAL CONDITION.

### **EXCAVATION:**

1. STOCKPILE ALL EXCAVATED SOIL FOR FUTURE REUSE AS FILL MATERIAL OR REMOVE AND DISPOSE OF AS REQUIRED.



### **EROSION CONTROL NOTES:**

 CONTRACTOR SHALL BE RESPONSIBLE FOR COMPLIANCE WITH ALL SEDIMENT AND EROSION CONTROL PRACTICES. THE SEDIMENT AND EROSION CONTROL PRACTICES ARE TO BE INSTALLED PRIOR TO ANY MAJOR SOIL DISTURBANCES, AND MAINTAINED UNTIL PERMANENT

2. TIMELY MAINTENANCE OF SEDIMENT CONTROL STRUCTURES IS THE RESPONSIBILITY OF THE CONTRACTOR. ALL STRUCTURES SHALL BE MAINTAINED IN GOOD WORKING ORDER AT ALL TIMES. THE SEDIMENT LEVEL IN ALL SEDIMENT TRAPS SHALL BE CLOSELY MONITORED AND SEDIMENT REMOVED PROMPTLY WHEN MAXIMUM LEVELS ARE REACHED OR AS ORDERED BY THE ENGINEER. ALL SEDIMENT CONTROL STRUCTURES SHALL BE INSPECTED ON A REGULAR BASIS, AND AFTER EACH HEAVY RAIN TO INSURE PROPER OPERATION AS DESIGNED. AN INSPECTION SCHEDULE SHALL BE SET FORTH PRIOR TO THE START OF CONSTRUCTION.

3. THE LOCATIONS AND THE INSTALLATION TIMES OF THE SEDIMENT CAPTURING STANDARDS SHALL BE AS ORDERED BY THE ENGINEER, AND IN ACCORDANCE WITH THE STANDARDS SET FORTH IN THIS MANUAL.

4. ALL TOPSOIL NOT TO BE USED FOR FINAL GRADING SHALL REMOVED FROM THE SITE IMMEDIATELY AND PLACED IN A STABILIZED STOCKPILE OR FILL AREA. ALL TOPSOIL REQUIRED FOR FINAL GRADING AND STORED ON SITE SHALL BE LIMED, FERTILIZED, TEMPORARILY SEEDED AND MULCHED WITH 14 DAYS.

5. ANY DISTURBED AREAS THAT WILL BE LEFT EXPOSED MORE THAN 21 DAYS AND NOT SUBJECT TO CONSTRUCTION TRAFFIC, SHALL IMMEDIATELY RECEIVE TEMPORARY SEEDING. MULCH SHALL BE USED IF THE SEASON PREVENTS THE ESTABLISHMENT OF A TEMPORARY COVER. DISTURBED AREAS SHALL BE LIMED AND FERTILIZED PRIOR TO TEMPORARY SEEDING.

6. ALL DISTURBED AREAS WITHIN 500 FEET OF AN INHABITED DWELLING SHALL BE WETTED AS NECESSARY TO PROVIDE DUST CONTROL.


7. THE CONTRACTOR SHALL KEEP THE ROADWAYS WITHIN THE PROJECT CLEAR OF SOIL AND DEBRIS AND IS RESPONSIBLE FOR ANY STREET CLEANING NECESSARY DURING THE COURSE OF

8. SEDIMENT AND EROSION CONTROL STRUCTURES SHALL BE REMOVED AND THE AREA STABILIZED WHEN THE DRAINAGE AREA HAS BEEN PROPERLY STABILIZED BY PERMANENT

9. ALL SEDIMENT AND EROSION CONTROL MEASURES SHALL BE INSTALLED IN ACCORDANCE WITH CURRENT EDITION OF "WESTCHESTER COUNTY BEST MANAGEMENT PRACTICES MANUAL FOR EROSION AND SEDIMENT CONTROL".

10. ALL DESIGNATED TREES SHALL BE PROTECTED DURING THE CONSTRUCTION PERIOD, EXCEPT THOS DESIGNATED TO BE REMOVED. TREE PROTECTION SHALL BE IN ACCORDANCE WITH THE WESTCHESTER COUNTY BEST MANAGEMENT PRACTICES MANUAL

> 5. MAINTENANCE SHALL BE PERFORMED AS NEEDED AND MATERIAL REMOVED WHEN "BULGES" DEVELOP IN THE SILT FENCE. ADAPTED FROM DETAILS PROVIDED BY: USDA - NRCS, STABILIZE ENTIRE PILE WITH NEW YORK STATE DEPARTMENT OF TRANSPORTATION WEGETAITON OR COVER NEW YORK STATE DEPARTMENT OF ENVIRONMENTAL CONSERVATION,

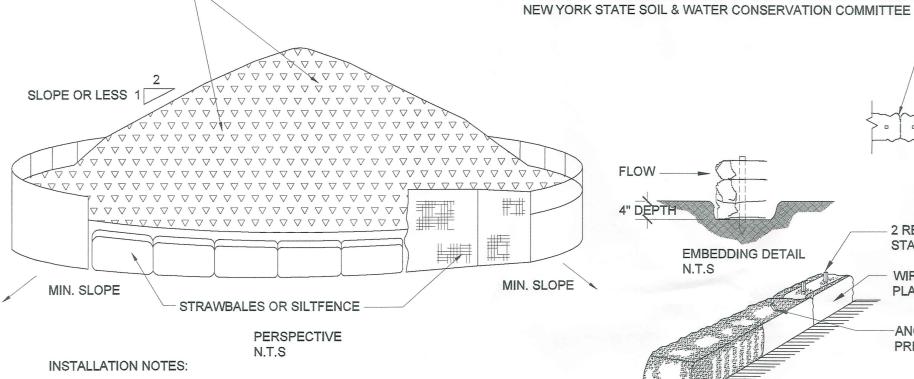

1. AREA CHOSEN FOR STOCKPILES OPERATIONS SHALL BE DRY AND STABLE.

2. MAXIMUM SLOPE OF STOCKPILE SHALL BE 1:2

3. UPON COMPLETION OF SOIL STOCKPILING, EACH PILE SHALL BE SURROUNDED WITH EITHER SILT FENCING OR STRAWBALES, THEN STABILIZED WITH VEGETATION OR COVERED.

4. SEE SPECIFICATIONS (THE MANUAL) FOR INSTALLATION OF SILTFENCE.

### SOIL STOCKPILE DETAIL


SCALE: 1/4" = 1'-0"

BALES. SEDIMENT CONTROL NOTE: SEDIMENT CONTROL AT INDICATE PROPERTY LINES SHALL BE PERFORMED OW 2% TO 4% SLOPE DURING PROPERTY EXCENATION AND GRADING, AND SHALL REMAIN LINTIL'
PROPER FINAL CURBING, DRAINAGE, AND GRADING IS COMPLETED. PROPOSED SUBGRADE HAYBALE BARRIER 8" TO 12" BERM -SCALE: N.T.S. **SECTION** SECTION N.T.S 2" X 2" STAKES DRAIN INLET-BERM ROADWAY PROPOSED **GROUND LEVEL** DRIVEWAY BERM SCALE: N.T.S. **BOTTOM OF BALES** 

**PERSPECTIVE** 

SCALE: N.T.S.

INLET PROTECTION

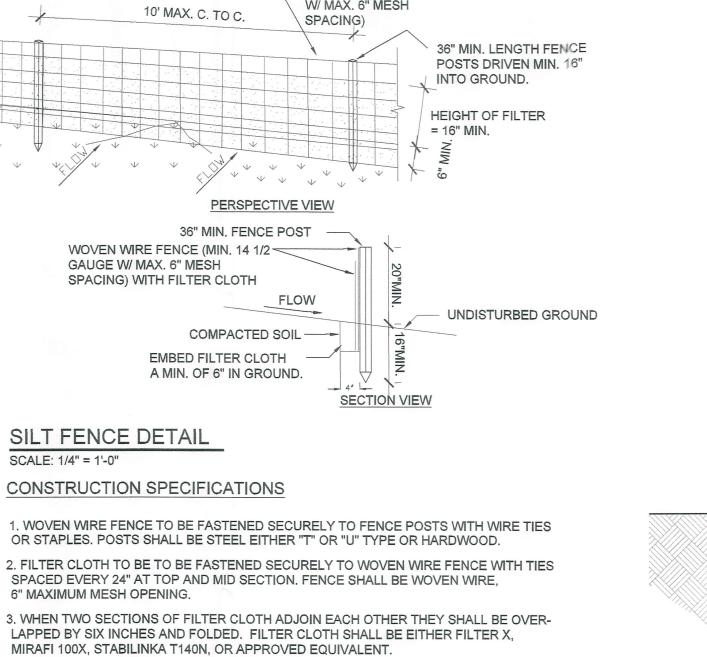

**WOVEN WIRE FENCE** 

SECTION VIEW

BALES TO BUTT TOGETHER TIGHTLY

PLAN VIEW

2 RE-BAR, STEEL PICKETS, OR 2X2

STAKES 1 1/2" TO 2" IN GROUND

WIRE OR NYLON BOUND BALES

ANGLE FIRST STAKE TOWARD

PLACE ON THE CONTOUR

PREVIOUSLY LAID BALE

N.T.S

2 RE-BAR, STEEL PICKETS, OR 2X2 STAKES 1 1/2" TO 2" IN GROUND

1. ALL BALES ARE TO BE TIGHTLY BUTTED TOGETHER

3. PROVIDE FREQUENT INSPECTION AND MAINTENANCE.

REMOVE ACCUMULATED SEDIMENT AND REPLACE

CLOGGED BALES TO MAINTAIN EFFECTIVENESS OF

2. BALES SHALL BE EITHER STRAW OR HAY

INSTALLATION.

(MIN. 14 GAUGE W/ MAX, 6" MESH

SPACING)

10' MAX. C. TO C.

WOVEN WIRE FENCE (MIN. 14 1/2 -

GAUGE W/ MAX. 6" MESH

CONSTRUCTION SPECIFICATIONS

SILT FENCE DETAIL

6" MAXIMUM MESH OPENING.

SPACING) WITH FILTER CLOTH

36" MIN. FENCE POST

COMPACTED SOIL ---

EMBED FILTER CLOTH

MIRAFI 100X, STABILINKA T140N, OR APPROVED EQUIVALENT.

EMBEDDING DETAIL

**PERSPECTIVE** 

1. BALES SHALL BE PLACE IN A ROW WITH ENDS TIGHTLY ABUTTING THE

3. BALES SHALL BE SECURELY ANCHORED IN PLACE BY STAKES OR RE-BAR

DRIVEN THROUGH THE BALES. THE FIRST STAKE IN EACH BALE SHALL BE

4. BALES SHALL BE REMOVED WHEN THEY HAVE SERVED THEIR USEFULNESS

ANGLED TOWARD PREVIOUSLY LAID BALE TO FORCE BALES TOGETHER.

2. EACH BALE SHALL BE EMBEDDED IN THE SOIL A MINIMUM OF 4".

SO AS NOT TO BLOCK OR IMPEDE STORM FLOW OR DRAINAGE.

N.T.S

INSTALLATION NOTES:

ADJACENT BALES.

4. PREFABRICATED UNITS SHALL BE GEOFAB, ENVIROFENCE, OR APPROVED EQUIVALENT.

A MIN. OF 6" IN GROUND.

1. USE THIS DETAIL WHERE USE OF PROTECTIVE FENCING DOES NOT ALLOW FOR SUFFICIENT CONSTRUCTION MANEUVERING ROOM 2. REMOVE ALL CHEKERS, BOARDS, ROPES, FILL AND PLYWOOD IMMEDIATELY AFTER COMPLETION OF

CONSTRUCTION. IF CONSTRUCTION TIME IS EXTENDED, DO NOT ALLOW THESE MATERIALS TO STRANGULATE TREE OR DAMAGE BARK. 3. IF LOWER LIMBS INTERFERE WITH WORK, TIE UP WITH HEAVY DUTY JUTE GORD.

4. TIE UP LIMBS IN WARM WEATHER IF POSSIBLE 5. ADJUST HEIGHT OF PROTECTIVE BOARDS TO PREVENT ANTICIPATED DAMAGE BY EQUIPMENT.

OUTLINE OF TREE ○ROWN (EDGE OF DRIPLINE) CORRESPONDS WITH ROOT SPREAD TRUNK PROTECTION BOARDS (2" THK) BENEATH BOARDS


ARE 3-4 LAYERS OF BURLAP AROUND TRUNK TIE BOARDS SECURELY AT TOP, BOTTOM AND CENTER WITH HEAVY DUTY CORD, WIRE, OR CABLE CHOKERS.

COVER PLYWOOD LAYER WITH (3'-6") FILL

SPREAD (3/4") THICK (USED) PLYWOOD SHEETS OR EQUAL AT TREE BASE TO ABSORB OR SPREAD ANY VEHICULAR LOADS OVER ROOT AREA WITHIN DRIPLINE ZONE.

GRADE

TYP TREE PROTECTION (DURING CONSTRUCTION) SCALE: 1/4" = 1'-0" TO REMAIN 4 STAKES UNDISTURBED ALL CONSTRUCTION FENCING TO BE **INSTALLED PRIOR** TO START OF WORK **INSTALL FENCING AT** DRIPLINE OF EXISTING TREE WHERE POSSIBLE DRIP LINE DRIP LINE

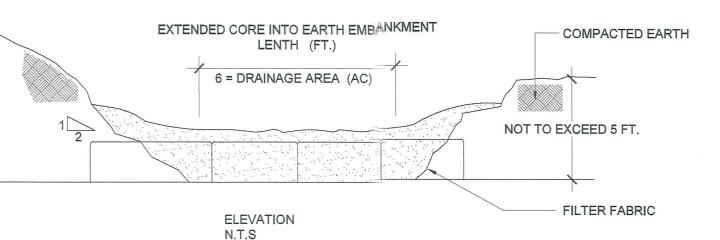

SCALE: 1/4" = 1-0"

TYP TREE PROTECTION

(DURING CONSTRUCTION)

### **INSTALLATION NOTES:**

1. AREA UNDER EMBANKMENT SHALL BE CLEARED, GRUBBED, AND STRIPPED OF ANY VEGETATION AND ROOT MAT. THE POOL AREA SHALL BE CLEARED AS WELL.

2. THE FILL MATERIAL FOR THE EMBANKMENT SHALL BE FREE OF ROOTS OR OTHER WOODY VEGETATION AS WELL AS OVER SIZED STONES, ROCKS, ORGANIC MATERIAL AND OTHER QUESTIONABLE MATERIAL. THE EMBANKMENT SHALL BE COMPACTED BY TRAVERSING WITH EQUIPMENT WHILE IT IS BEING CONSTRUCTED.

3. THE STRUCTURE SHALL BE REMOVED AND TRAP RESTORED TO ITS ORIGINAL DIMENSIONS WHEN THE SEDIMENT HAS ACCUMULATED TO 1/2 THE DESIGN DEPTH OF THE TRAP. REMOVED SEDIMENT SHALL BE DEPOSITED IN A SUITABLE AREA AND IN SUCH A MANNER THAT IT WILL NOT ERODE.

4. THE STRUCTURE SHALL BE INSPECTED AFTER EACH RAIN REPAIRS MADE AS NEEDED.

5. CONSTRUCTION OPERATIONS SHALL BE CARRIED OUT IN SUCH A MANNER THAT EROSION AND WATER POLLUTION IS MINIMIZED.

6. THE STRUCTURE SHALL BE REMOVED AND THE AREA STABILIZED WHEN THE DRAINAGE AREA HAS BEEN PROPERLY STABILIZED.

7. ALL CUT AND FILL SLOPES SHALL BE 1:2 OR FLATTER

TEMPORARY SEDIMENT BASIN SCALE: N.T.S.

ROLLANO ENGINEERII

411 THEODORE FREMD.

phone: 914.925.3584 fax: 914 RollanoEngineers@aol.c

SUITE 206 RYE, NY 10

PLANS ARE NOT TO BE SCALED, CONTRACT

MAKE NO ASSUMPTIONS WITH REGARD TO DRAWINGS. ANY ADDITIONAL INFORMATION DIMENSIONS REQUIRED TO PROPERLY EST **ERECT THIS PROJECT WILL BE SUPPLIED B** ENGINEER UPON REQUEST, CONTRACTOR IN THE FIELD ALL DIMENSIONS AND CONDIT INDICATED ON THIS DRAWING AND BE RES SAME. ANY DISCREPANCIES BETWEEN THE AND FIELD CONDITIONS SHOULD BE REPORT ENGINEER BEFORE PROCEEDING WITH THI THESE DRAWINGS SHALL NOT BE ALTERED THE CONSENT AND KNOWLEDGE OF THE E REPRODUCTION RIGHTS RESERVED, REPR WITHOUT PERMISSION IS PROHIBITED.

MUNICIPALITY: TOWN OF NORTH CASTLE PROPERTY INDEX: **SECTION: 107.02** BLOCK: 02 LOT: 46 ZONE: R-2A

3 STORM WATER REVIEW 2 STORM WATER REVIEW 1 STORM WATER REVIEW ISSUED FOR **REVISIONS** 

SCOPE OF WORK:

PROPOSED LOCATIC OF NEW ONE-FAMILY DWI

PROJECT LOCATION:

4 LEDGEWOOD PLAC ARMONK, NEW YOR

SHEET TITLE:

EROSION CONTROL DE


PROJECT #: 21-082421 SCALE: AS NOTED DATE: 10/05/22

DRAWN BY: JOSEPH PATERNO

REVIEWED BY: LOUIS E. ROLLAN

SHEET NO

SHEET:

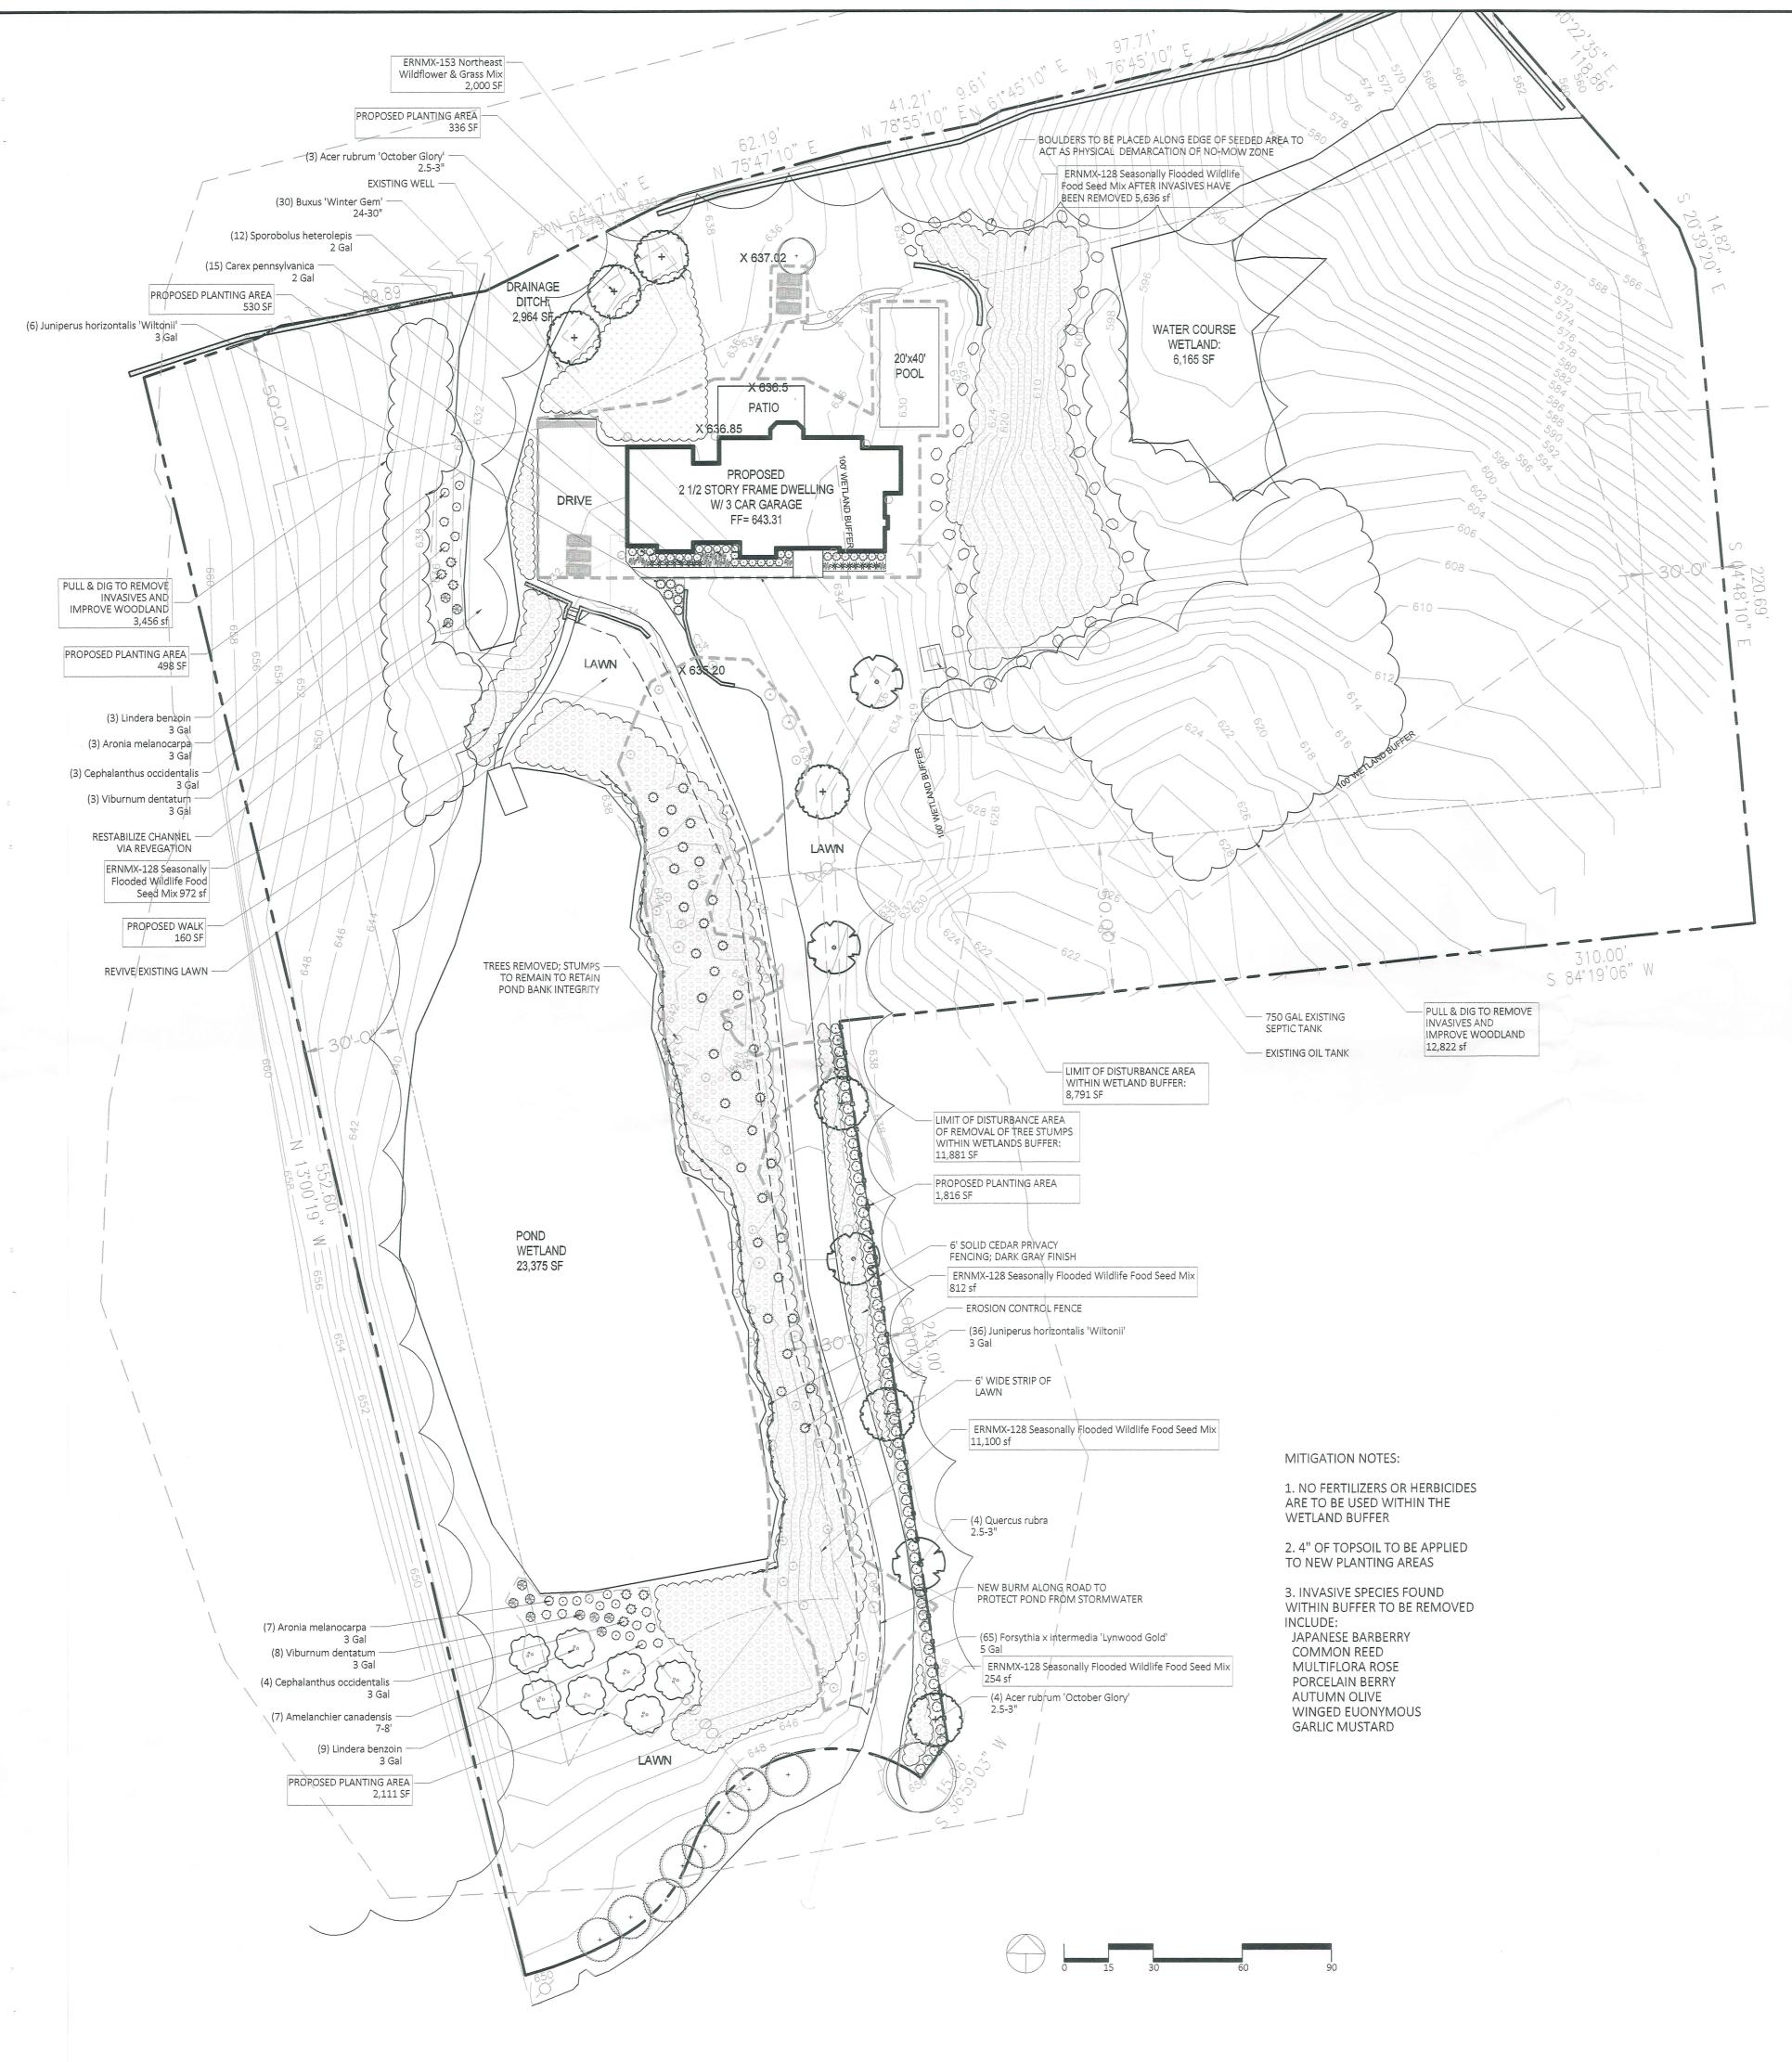

### ■ WETLAND BUFFER AREAS OF DISTURBANCE & IMPROVEMENTS

WETLAND TYPE	BUFFER AREA	LIMIT OF DISTURBANCE	IMPROVEMENTS WITHIN BUFFER
POND	WETLAND	TOTAL DISTURBANCE	AREA OF PROPOSED PLANTINGS
WETLAND	BUFFER AREA	OUTSIDE WETLAND BUFFER: 360 S	WITHIN WETLAND BUFFER:
23,375 SF	37,363 SF		5,291 S
		PROPOSED 2.5 STORY HOUSE & POOL	AREA OF RESTABILIZER SEED MIX
DRAINAGE	WETLAND	DISTURBANCE WITHIN WETLAND BUFFER	ERNMX-128 SEASONALLY FLOODED
DITCH WETLAND	BUFFER AREA	8,791 SF	WILDLIFE FOOD SEED MIX:
2,964 SF	42,543 SF		18,774 S
		LIMIT OF DISTURBANCE AREA	AREA OF NORTHEAST WILDFLOWER &
WATER COURSE	WETLAND	OF THE 42 REMOVED TREES	GRASS MIX ERNMX-153:
WETLAND	BUFFER AREA	WITHIN WETLAND BUFFER	2,000 SF
6,165 SF	56,671 SF	11,881 SF	AREA OF INVASIVE REMOVAL &
			WOODLAND IMPROVEMENTS:
		PPD WALKWAY TO DOCK	
		160 SF	16,278 S
32,504 SF	136,577 SF	DISTURBANCE WITHIN BUFFER: 20,832 SF	42,343 SF (41,664 REQUIRED FOR 2:1

### ■ WETLAND BUFFER IMPROVEMENT PLANT SCHEDULE

QTY	BOTANICAL NAME	COMMON NAME	SIZE	COMMENT9_
REES				
7	Acer rubrum 'October Glory'	October Glory Red Maple	2.5-3" Cal	
4	Quercus rubra	Red Oak	2.5-3" Cal	
7	Amelanchier canadensis	Serviceberry	7-81	Multi-Stem
1RUBS				
10	Aronia melanocarpa	Black Chokeberry	3 Gallon	
30	Buxus 'Winter Gem'	Winter Gem Boxwood	24-30"	
7	Cephalanthus occidentalis	Button Bush	3 Gallon	
42	Juniperus horizontalis 'Wiltonii'	Creeping Juniper	Gallon	
65	Forsythia x intermedia 'Lynwood Gold'	Forsythia	5 Gallon	
12	Lindera benzoin	Spice Bush	3 Gallon	
11	Viburnum dentatum	Arrowood Viburnum	3 Gallon	
RASSES				
12	Sporobolus heterolepis	Prairie Dropseed	2 Gal	
15	Carex pennyslvanica	Pennsylvania Sedge	2 Gal	
EED MIX				
10 LBs	18,774 SF of ERNMX-128 by Ernst Seeds	Seasonally Flooded Wildlife Food Mix	I LB B	ag per 2,00051
LBs	2,000 SF of ERNMX-153 by Ernst Seeds	Northeast Wildflower and Grass Mix		ag per 2,00051

### □ PLANT IMAGES

























TO SCALE WHEN PLOTTED ON 24x36 PROGRESS SET NOT FOR CONSTRUCTION

178 elizabeth st pearl river, ny 10965 p 845.365.4595 | f 914.361.4473 yostdesign.com

SURVEYOR:

DATE: APRIL 23, 2020 DRAWN BY: AVM JOB NO: 042420 SCALE: 1"=30' FILENAME: 2022\_1020 4 Ledgewood

ARMONK


**REVISIONS:** 8/26/2020 9/30/2020 11/11/2020 9/13/2021 10/20/2021 6/22/2022 10/20/2022



Blythe M Yost ASLA | Registered Landscape Architect

MITIGATION/ **PLANTING PLAN** 

SHEET NO.

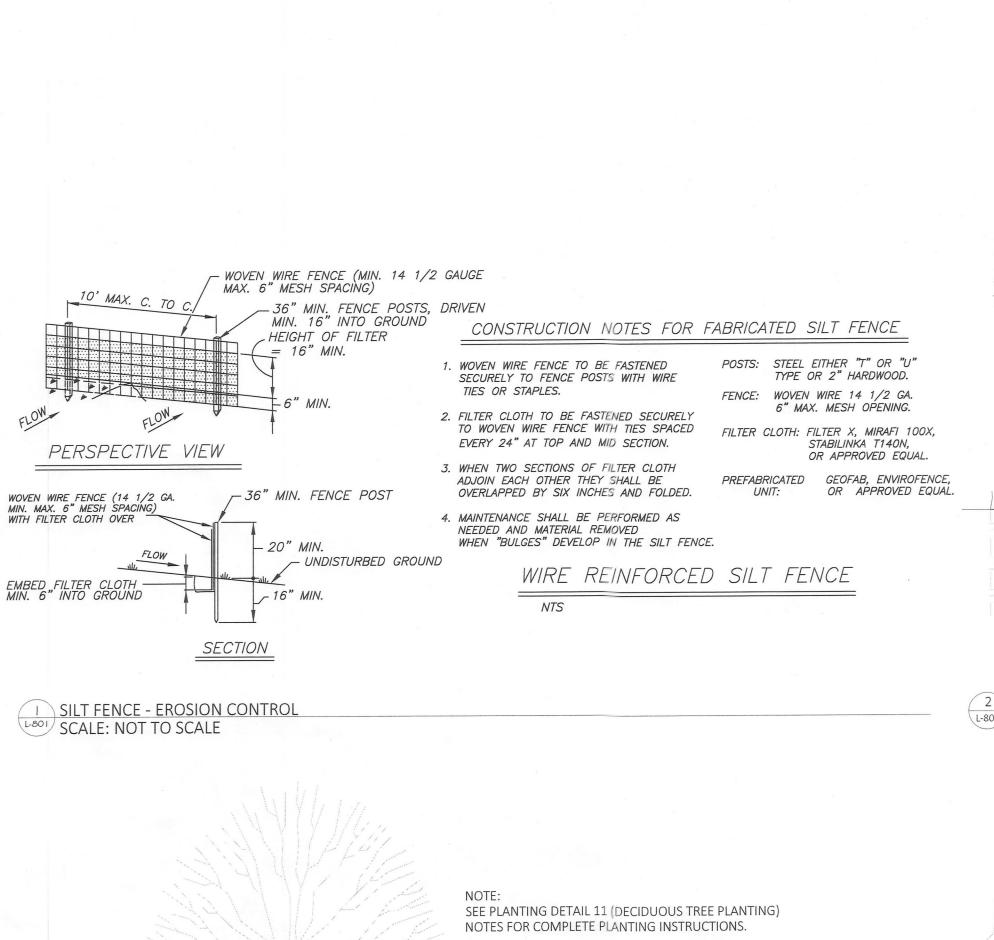

BALL DEPTH

5 MULTISTEM TREE PLANTING

L-801 SCALE: 1/2"=1'

TREE AS SPECIFIED

3" MOUNDED SAUCER

3" MULCH LAYER,

WITH THE TREE

FINISH GRADE

PLANT BED MIX

LOW ORGANIC SOIL

STONE DUST FILTER


COMPACTED SUBGRADE

DO NOT PLACE IN CONTACT

SCARIFY SIDES OF PLANT PIT

COMPACTED SOIL MOUND

GRADED CRUSHER RUN WITH

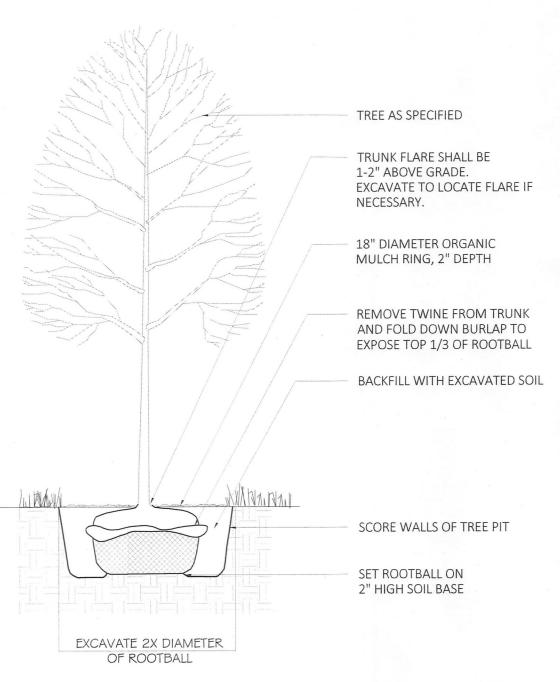

2 DECIDUOUS TREE PLANTING L-801 SCALE: 1/4"=1'

NOTES: SET TREE PLUMB. 2. DO NOT STAKE UNLESS DIRECTED TO DO SO BY LANDSCAPE ARCHITECT 3. REMOVE COMPLETELY ANY NON-BIODEGRADABLE MATERIALS BINDING THE ROOTBALL. 4. REMOVE WIRE BASKET COMPLETELY IF ROOTBALL WILL BARE. OTHERWISE, CLIP AND PEEL BACK WIRE BASKET AT LEAST ONE THIRD OF THE WAY FROM THE TOP OF THE ROOTBALL. 5. SATURATE SOIL WITHIN SIX (6) HOURS OF PLANTING AND WATER AS NECESSARY UNTIL IRRIGATION IS INSTALLED. 6. DO NOT ADD ANY SOIL AMENDMENTS OTHER THAN COMPOST UNLESS DIRECTED TO BY LANDSCAPE ARCHITECT. 7. DO NOT ADD ANY SOIL OR MULCH AGAINST TRUNK OF TREE. IF ROOT FLARE IS NOT EXPOSED, REMOVE SOIL AND EXPOSE.

SHRUB, AS SPECIFIED 2" DEEP ORGANIC MULCH RING SET PLANT PLUMB IN **EXCAVATED HOLE** BACKFILL WITH TOPSOIL

TOP 1/2 OF BALL. IF ANY MATERIALS USED TO BIND THE ROOTBALL ARE NON-BIODEGRADEABLE, REMOVE COMPLETELY INCLUDING WIRE BASKET. 2. FOR CONTAINER GROWN PLANT MATERIAL, REMOVE CONTAINER. TO HELP PREVEN LOOSENING OF SOIL AND SCARIFY BALL TO HELP PREVENT GIRDLING

1. FOR B & B PLANT MATERIAL, REMOVE ALL TWINE AND ROLL BACK BURLAP FROM

NOTES:

3. SATURATE SOIL WITHIN SIX (6) HOURS OF PLANTING, AND WATER AS NECESSARY UNTIL IRRIGATION INSTALLED.

4. NO MULCH OR SOIL SHOULD BE PLACED AGAINST THE PLANT'S TRUNK.

3 SHRUB PLANTING L-801 SCALE: 1/2"=1'

> POSITION ROOT CROWN AT FINISHED GRADE 2" MULCH REMOVE CONTAINER AND GENTLY LOOSEN ROOTS ROTOTILL 2" TOPSOIL AND 2" OF COMPOST INTO NATIVE SOIL UNLESS LANDSCAPE ARCHITECT SPECIFIES OTHERWISE

4 GROUNDCOVER PLANTING L-801 SCALE:1/2"=1'

178 elizabeth st pearl river, ny 10965 p 845.365.4595 | f 914.361.4473 yostdesign.com

Blythe M Yost ASLA | Registered Landscape Architect

SURVEYOR:

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Z

DATE: APRIL 23, 2020 DRAWN BY: AVM JOB NO: 042420 SCALE: VARIES FILENAME: 2022\_0622 4 Ledgewood

**REVISIONS:** 8/26/2020 9/30/2020 11/11/2020 9/13/2021


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Blythe M Yost ASLA | Registered Landscape Architect

**DETAILS** SHEET

SHEET NO.



EXISTING TREE TO BE PROCTECTED ORANGE PLASTIC BARRIER FENCE WITH STEEL POSTS INSTALLED AT 8' O.C.

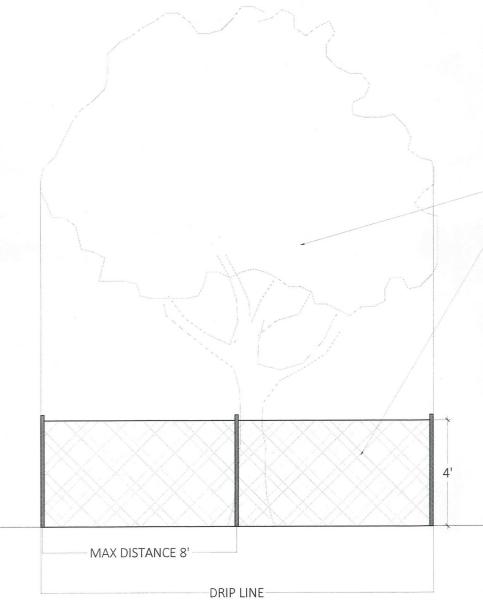NOTES:

1. ORANGE BARRIER FENCING SHALL BE USED TO PROTECT ALL EXISTING TREES AND ROOT ZONES.


2. FENCING SHALL CREATE A ZONE OF PROTECTION WITH A MINIMUM RADIUS OF 1' FROM TREE TRUNK FOR EVERY 1" OF OF TRUNK DIAMETER (I.E. 12"DBH TREE=12' RADIUS ROOT ZONE PROTECTION)

3. NO CONSTRUCTION MATERIALS OR DEBRIS SHALL BE STORED INSIDE OF THE FENCING.

4. THE FENCING SHALL BE INSTALLED PRIOR TO THE COMMENCEMENT OF CONSTRUCTION ACTIVITIES, AND SHALL BE REMOVED WHEN CONTRUCTION IS COMPLETE.

5. THE OWNER SHALL BE INFORMED IMMEDIATELY OF ANY DAMAGE TO EXISTING TREES TO BE PRESERVED, INCLUDING BARK AND BRANCH DAMAGE.


6 TREE PROTECTION L-801 SCALE: 1/4"=1'

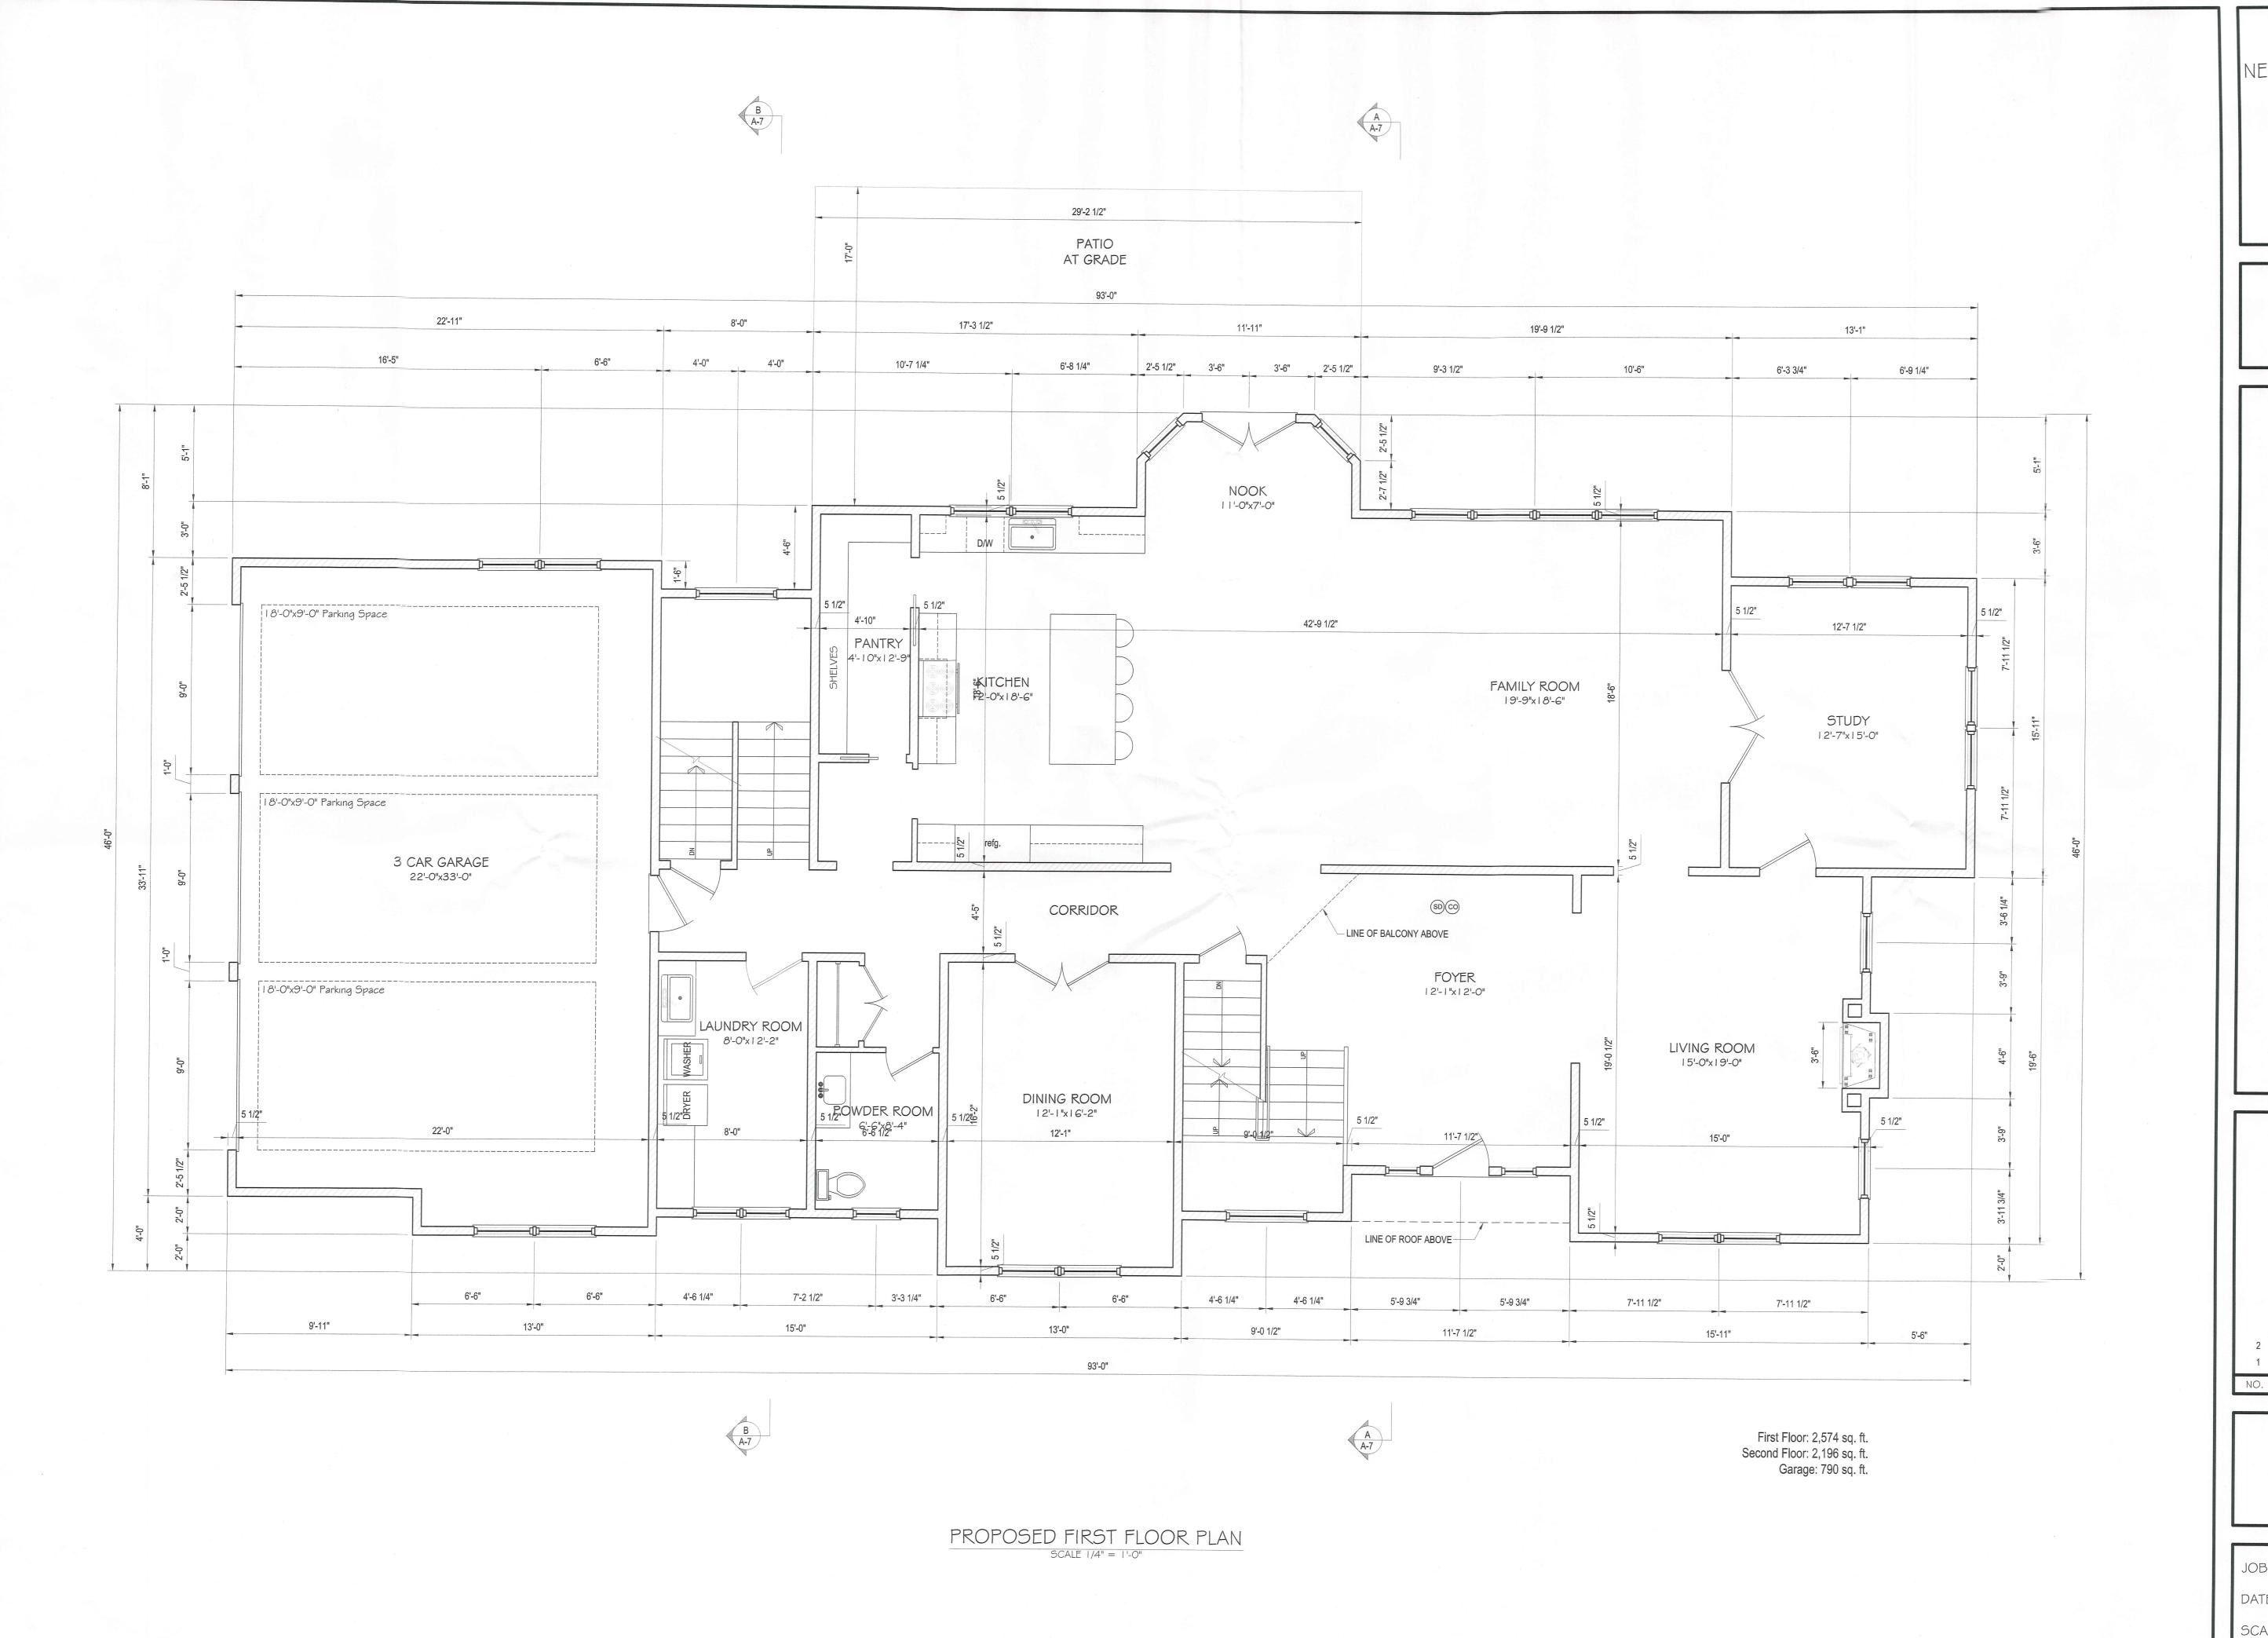

NEW SINGLE FAMILY DWELLING FOR:

4 LEDGEWOOD PL ARMONK, NY

> JOSEPH GUGLIELMO ARCHITECT 64 ROGERS DRIVE NEW ROCHELLE, NY 10804 1EL. (914) 804-7157 JGNYarch@gmail.com

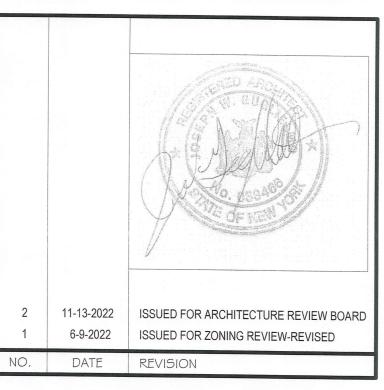

PROPOSED FIRST FLOOR PLAN

JOB NO.: 2106 DATE: 6-23-21


DATE: 6-23-21

SCALE: AS NOTED

DRAWN BY: JWG

A-3

DRAWING NO .:

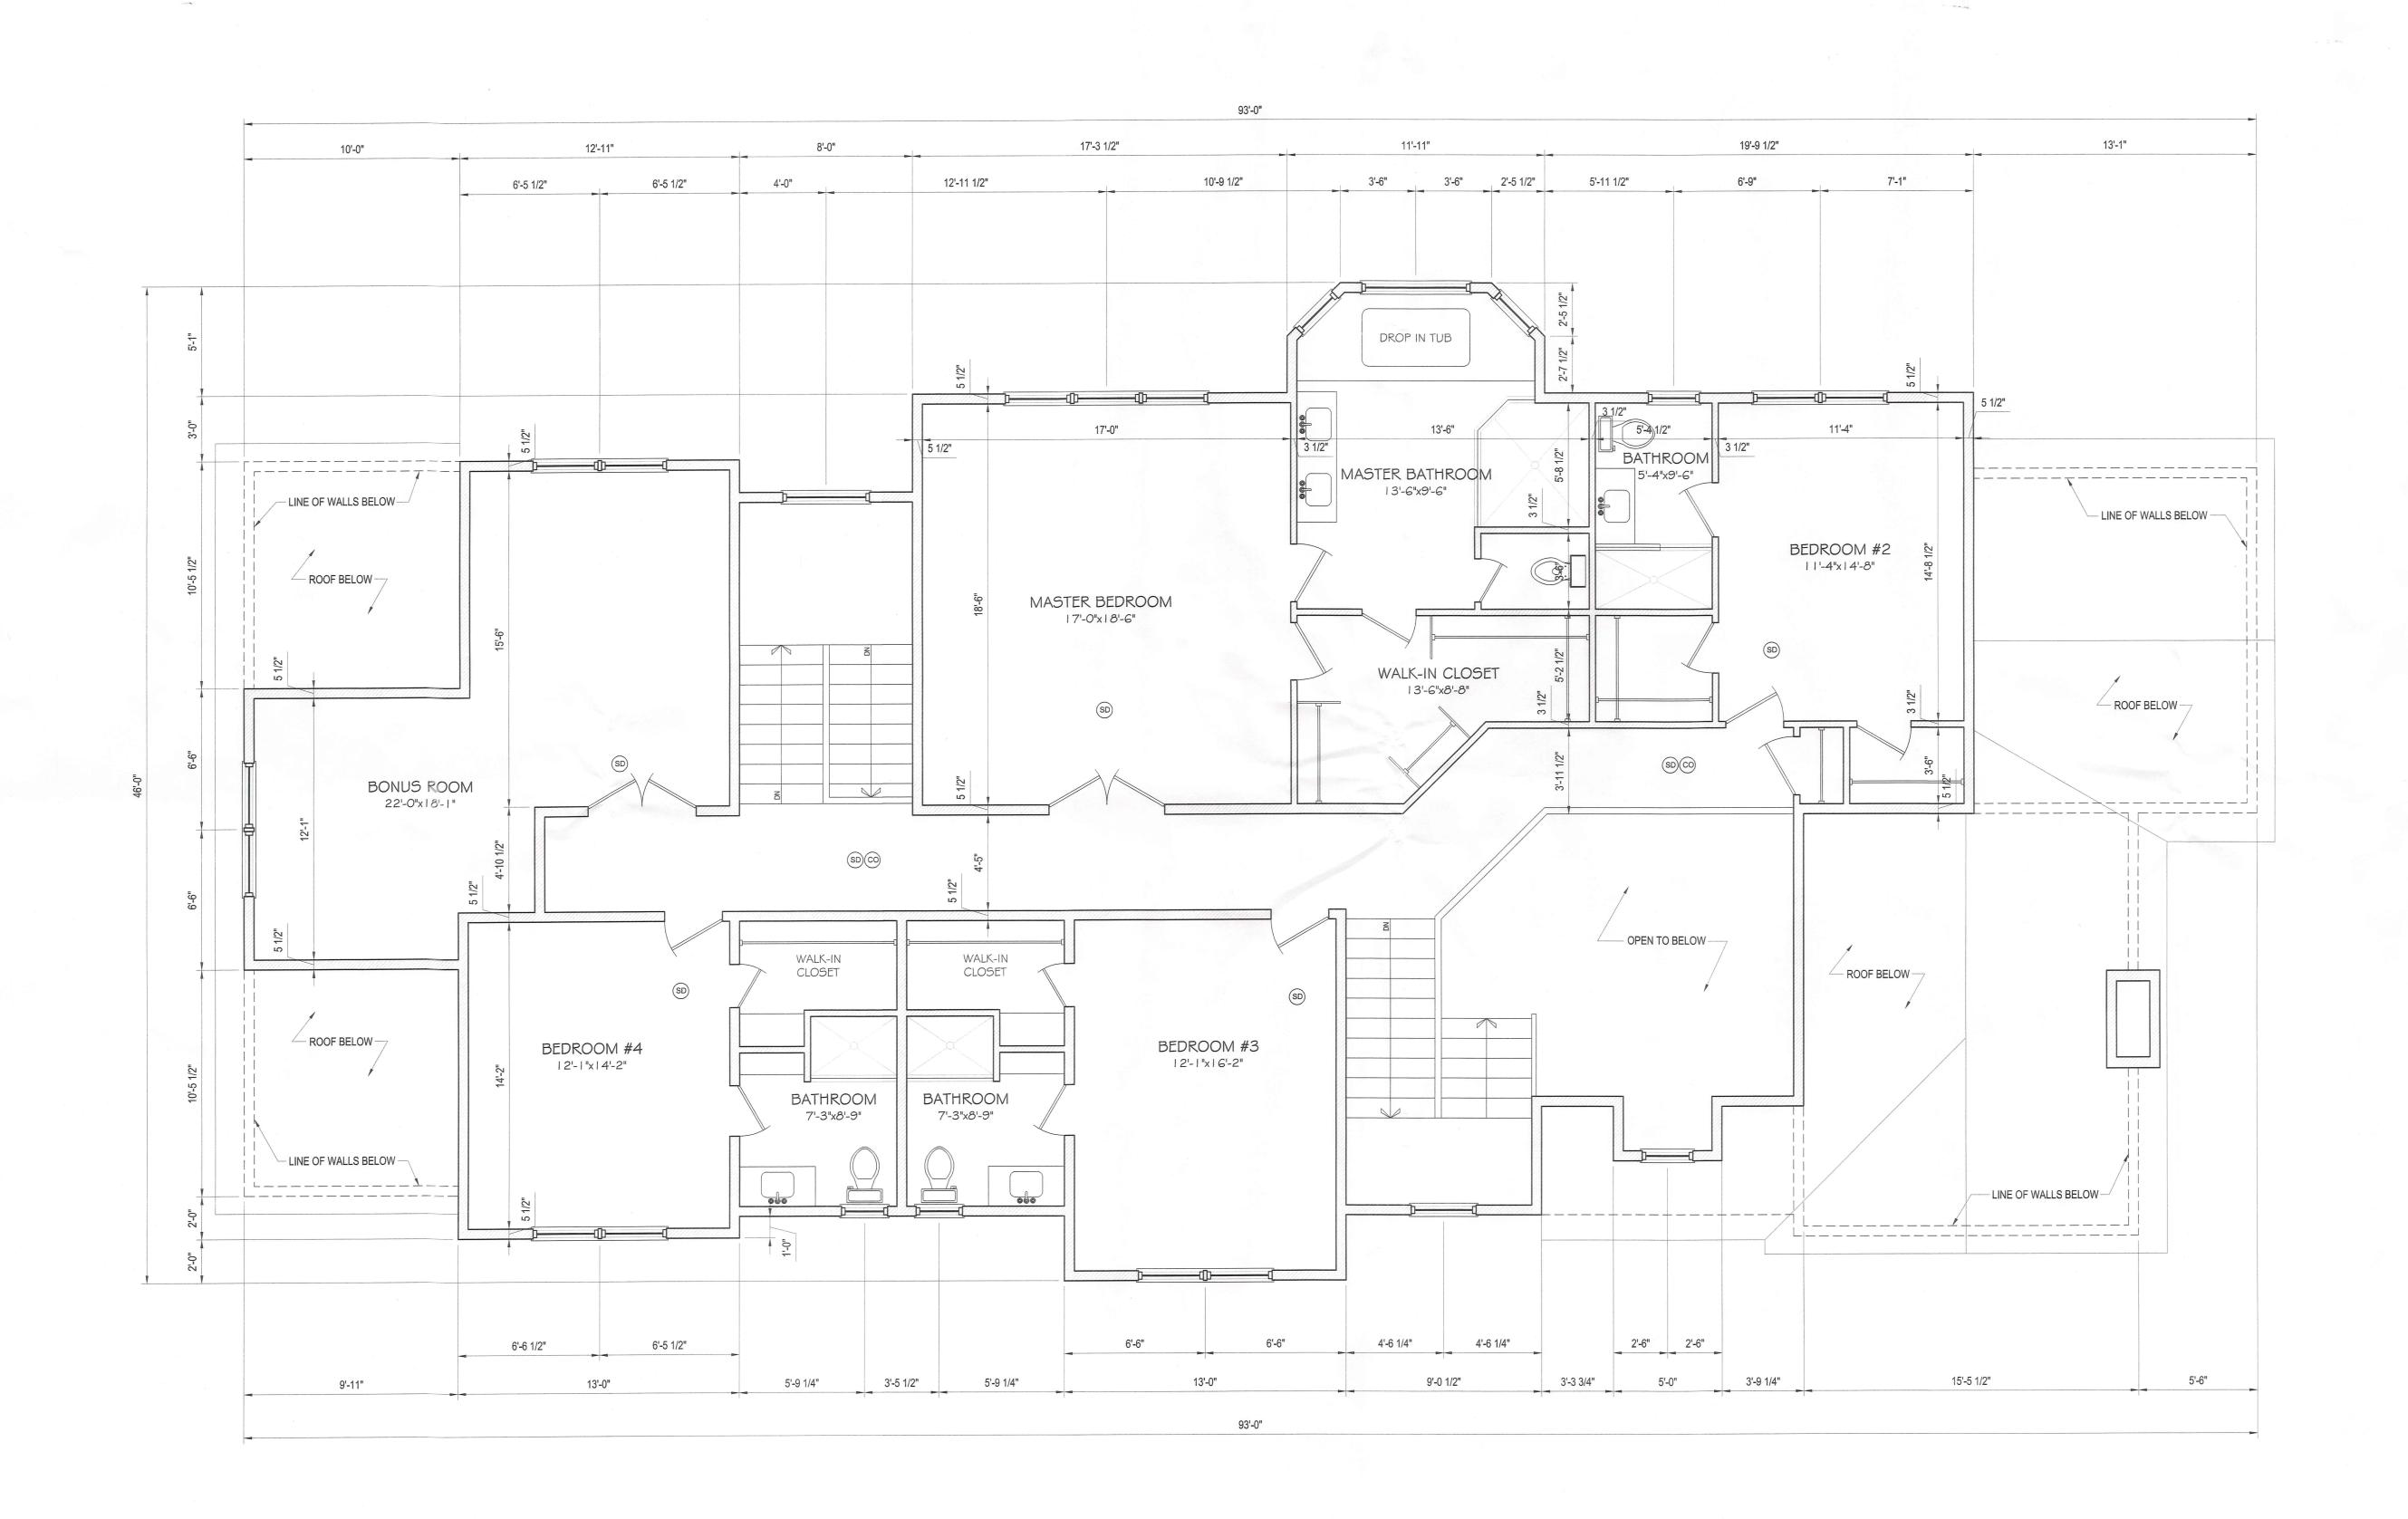

PROPOSED SECOND FLOOR PLAN


SCALE 1/4" = 1'-0"

Second Floor: 2,196 sq. ft.

NEW SINGLE FAMILY DWELLING FOR:

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PROPOSED SECOND FLOOR PLAN


JOB NO.: 2106

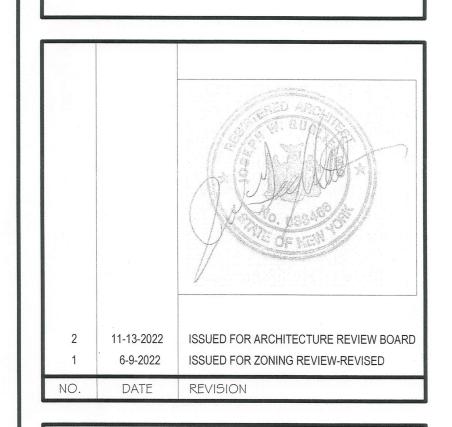DRAWING NO .:

SCALE: AS NOTED

DRAWN BY: JWG


DATE: 6-23-21

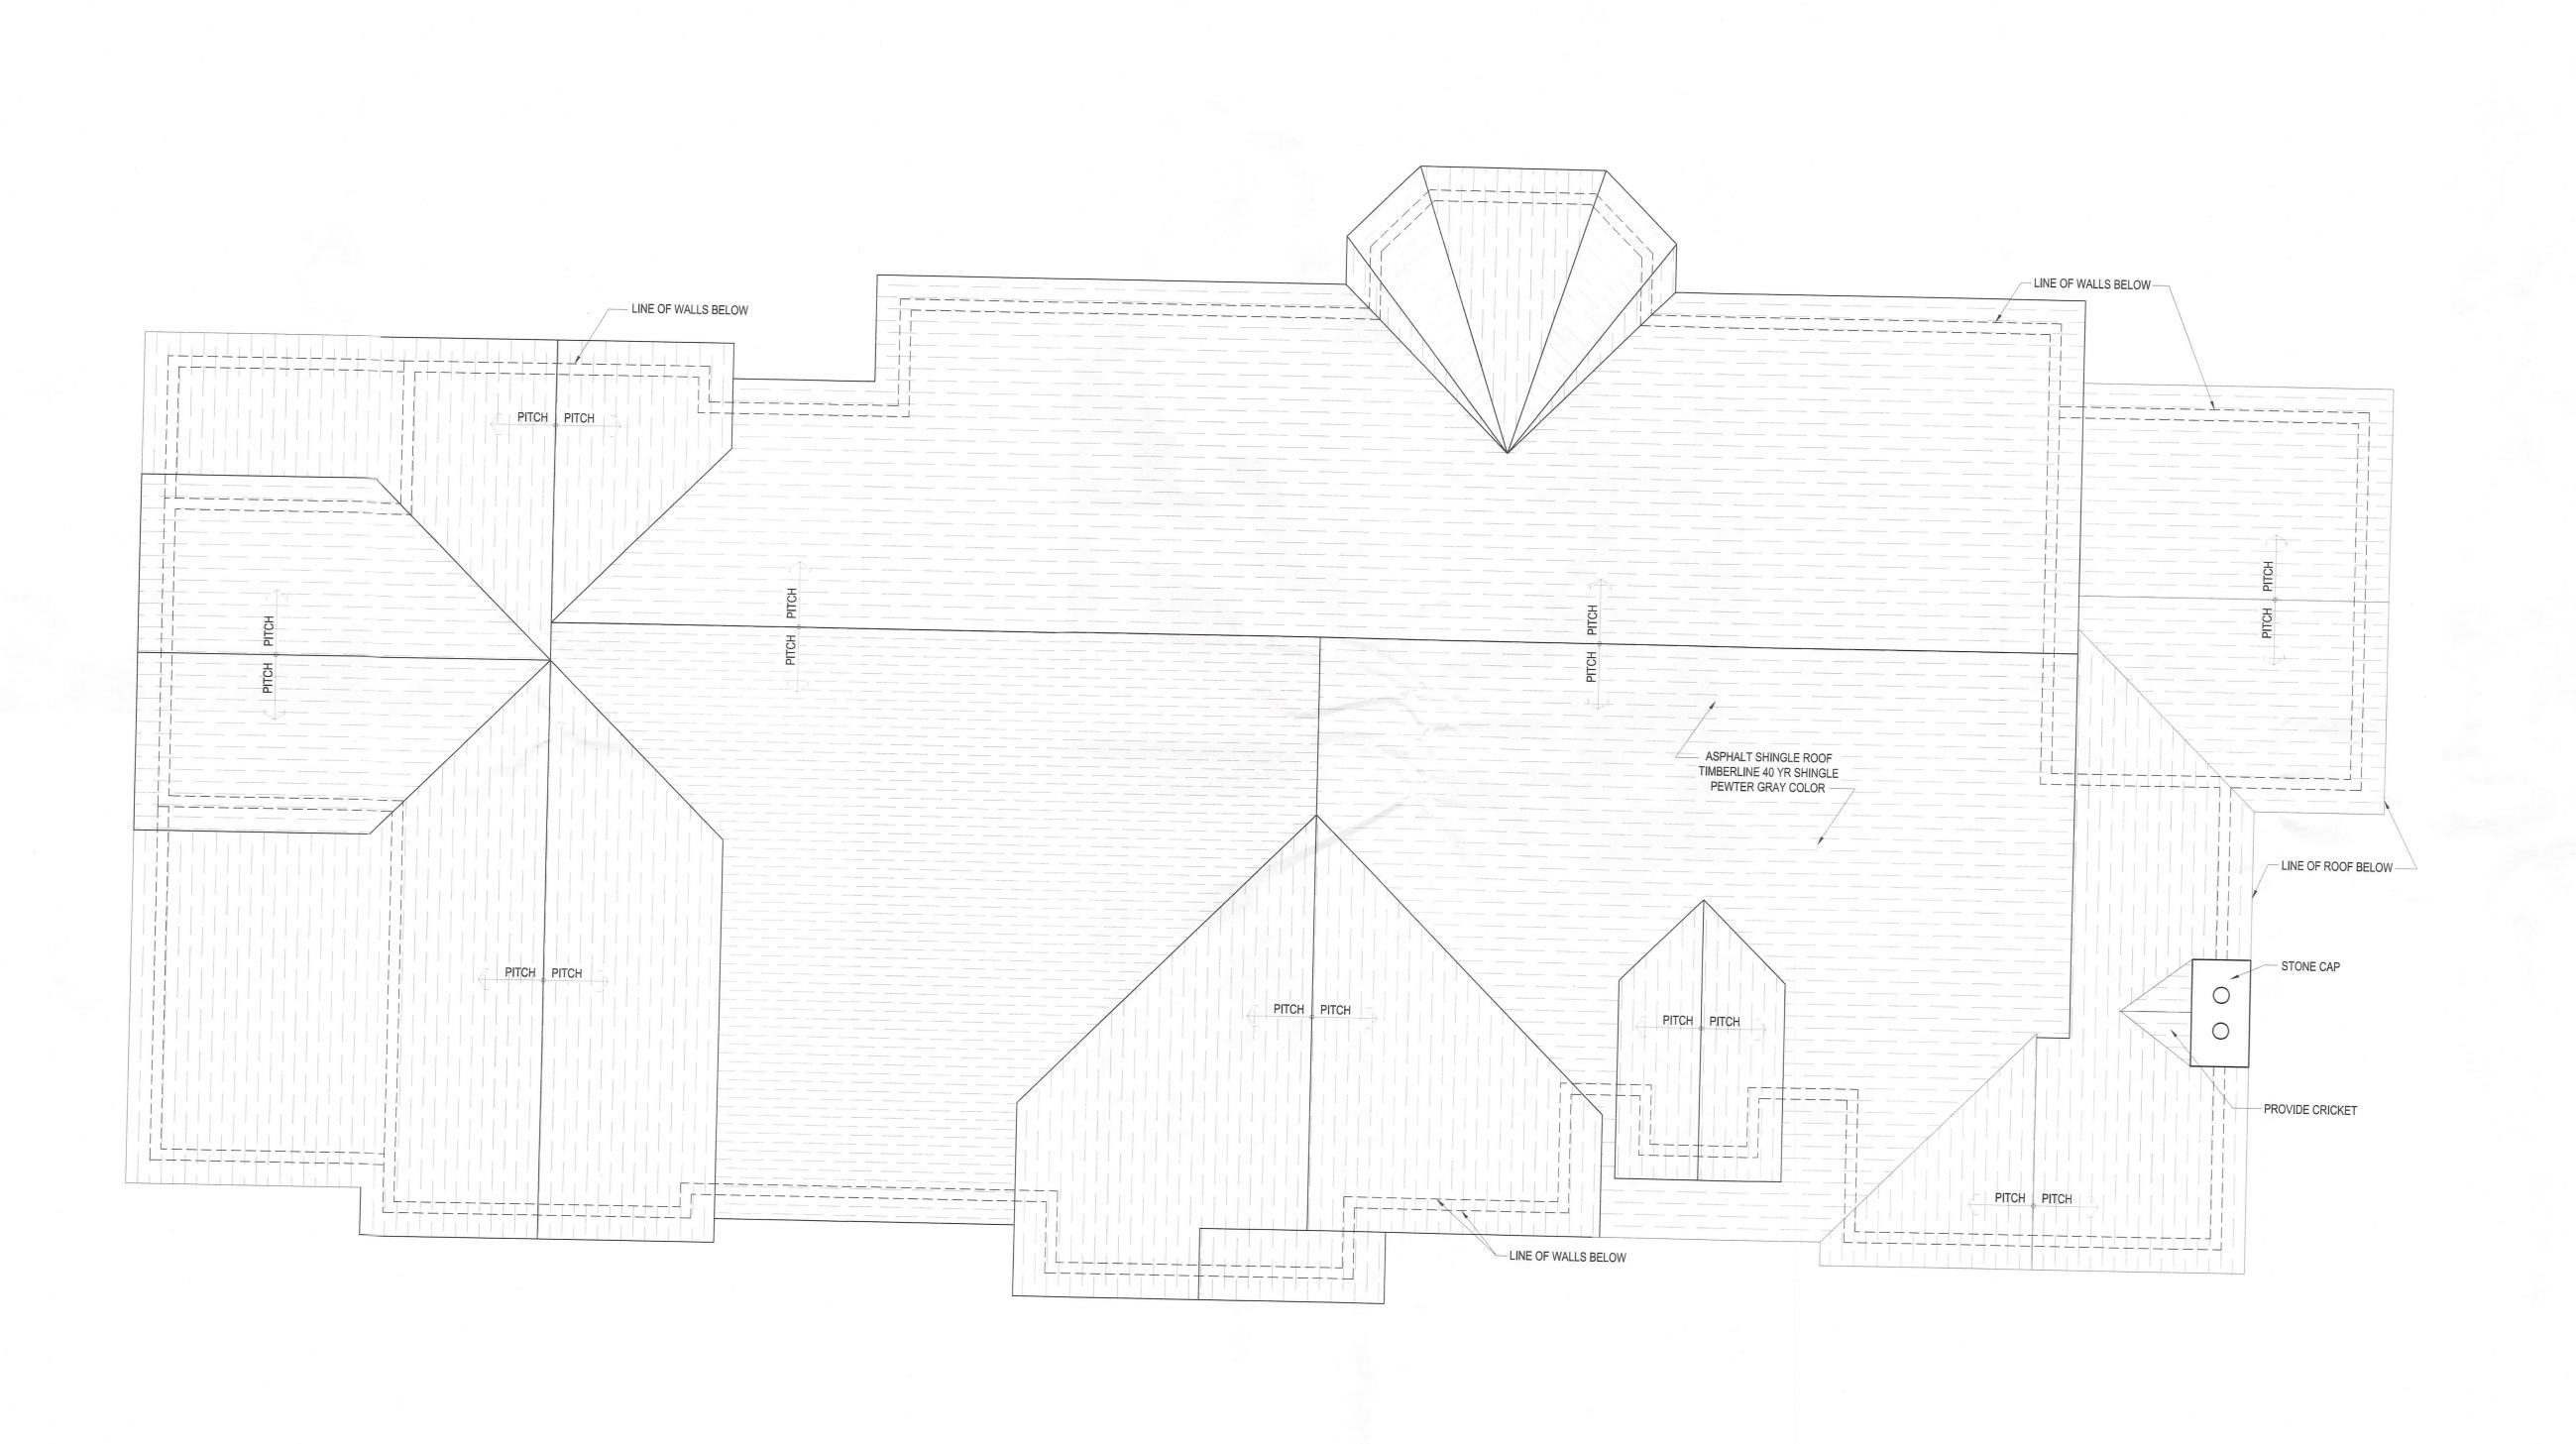

NEW SINGLE FAMILY DWELLING FOR:

4 LEDGEWOOD PL ARMONK, NY

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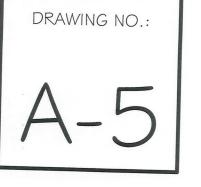
PROPOSED ROOF PLAN

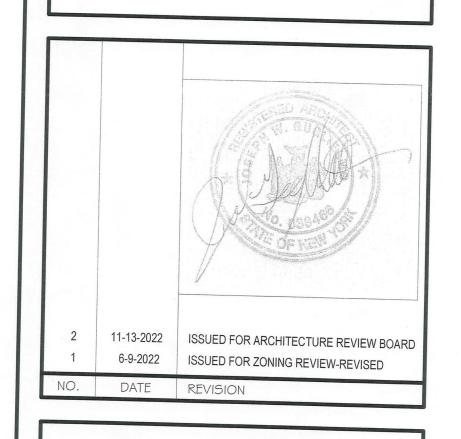JOB NO.: 2106

DATE: 6-23-21

SCALE: AS NOTED

DRAWN BY: JWG



PROPOSED ROOF PLAN
SCALE 1/4" = 1'-0"

