# GENERAL NOTES

# GENERAL

- 1. STANDARDS OF CONSTRUCTION: ALL CONSTRUCTION SHALL CONFORM TO THE TOWN OF CARMEL STANDARDS, RULES AND REGULATIONS REGARDLESS OF WHAT MAY BE INDICATED ON THE PLANS.
- IMPORTED FILL: IF THE SITE REQUIRES IMPORTED FILL IN THE PROPOSED MUNICIPAL RIGHT OF WAY OR MUNICIPAL OWNED PROPERTY, ALL FILL MUST BE TESTED FOR COMPOSITION AND CHEMICALS IN ACCORDANCE WITH TOWN ENGINEER DIRECTIONS AND AT THE FULL EXPENSE OF THE OWNER. THESE TEST RESULTS MUST BE RECEIVED PRIOR TO DEPOSITING MATERIAL ON MUNICIPAL PROPERTY. A LICENSED PROFESSIONAL ENGINEER MUST BE ON SITE TO APPROVE THE FILL, KEEP RECORDS, AND REVIEW THE CHAIN OF CUSTODY DOCUMENTATION OF EACH TRUCK BROUGHT TO THE SITE. THE REQUIRED NUMBER OF SAMPLES MUST BE TAKEN AND TESTED BY A NEW YORK STATE CERTIFIED LABORATORY. IN ADDITION, POLLUTION INSURANCE MUST BE PROVIDED PRIOR TO CONSTRUCTION, IN THE AMOUNT TO HE DETERMINED BY THE TOWN ENGINEER
- 3. EROSION, DUST & SEDIMENT CONTROL: THE DEVELOPER SHALL BE RESPONSIBLE FOR PROVIDING PROPER EROSION, SEDIMENT AND DUST CONTROL. ALL EROSION AND SEDIMENT CONTROL MUST BE SIZED AND DESIGNED IN ACCORDANCE WITH THE STANDARDS AND GUIDELINES PRESENTED IN THE LATEST NYSDEC REGULATIONS. THE DEVELOPER SHALL SUBMIT TO THE COMMISSIONER FOR APPROVAL, A PLAN WITH DETAILS DELINEATING THE METHODS HE INTENDS TO USE FOR EROSION, SEDIMENTATION AND DUST CONTROL DURING THE CONSTRUCTION OF THIS PROJECT. SILT PROTECTION AND ANY WATER RETENTION BASINS WILL BE THE FIRST ITEMS OF CONSTRUCTION, THE EROSION, SEDIMENTATION AND DUST CONTROLS MUST BE MAINTAINED THROUGHOUT CONSTRUCTION OR A STOP WORK ORDER WILL BE ISSUED BY TOWN ENGINEER.
- 4. ELEVATION DATUM: ELEVATIONS SHOWN ON THE PLANS ARE FROM THE FIELD SURVEY IN NAVD 83.
- 5. INDUSTRIAL CODE RULE '753: THE DEVELOPER SHALL NOTIFY ALL UTILITY COMPANIES 72 HOURS PRIOR TO THE START OF HIS OPERATIONS AND SHALL COMPLY WITH ALL THE LATEST INDUSTRIAL CODE RULE 753 REGULATIONS.
- 6. VERIFICATION AND PROTECTION OF EXISTING UTILITIES: THE DEVELOPER SHALL VERIFY THE SIZE, LOCATION, DEPTH AND INVERTS OF ALL EXISTING UTILITIES PRIOR TO COMMENCING HIS OPERATIONS. THE DEVELOPER SHALL PRESERVE AND PROTECT EXISTING PRIVATE AND MUNICIPAL UNDERGROUND AND OVERHEAD UTILITIES AND STRUCTURES, WHETHER OR NOT THEY ARE SHOWN ON THE APPROVED PLANS OR LOCATED UNDER INDUSTRIAL CODE RULE 753. THE COST OF REPAIRING DAMAGED UTILITIES OR STRUCTURES SHALL BE BORNE BY THE DEVELOPER. IF TEMPORARY UTILITIES ARE REQUIRED IT IS THE RESPONSIBILITY OF THE DEVELOPER TO PROVIDE AND MAINTAIN SAID UTILITIES.
- 7. PIPE LAYOUT: THE DEVELOPER SHALL PERFORM ALL PROPOSED PIPE LAYOUT REQUIRED BY MEANS OF A LASER FOR EXACT VERTICAL AND HORIZONTAL ALIGNMENT. THE USE OF BATTER BOARDS, AS SPECIFIED IN THE MUNICIPAL STANDARD CONSTRUCTION SPECIFICATIONS ARTICLE 33.132 "LAYOUT", SHALL NOT BE ALLOWED. THE DEVELOPER'S EQUIPMENT MUST HAVE BEEN CALIBRATED WITHIN THE PREVIOUS SIX (6) MONTHS PRIOR TO CONSTRUCTION. WRITTEN PROOF OF CALIBRATION MUST BE PROVIDED IF REQUIRED BY THE TOWN ENGINEER
- 8. INSPECTION & BACKFILL: NO BACKFILL SHALL BE PLACED OVER NEW CONSTRUCTION PRIOR TO INSPECTION AND APPROVAL BY TOWN ENGINEER. THE DEVELOPER MUST HAVE A SUFFICIENT STOCKPILE OF CLEAN FILL IF EXCAVATED MATERIAL IS UNSUITABLE FOR BACKFILL (IE., ROCK, ORGANIC MATERIAL). THE USE OF CONTROLLED BACKFILL MATERIAL MAY BE REQUIRED IN TRENCHES IF DETERMINED BY THE TOWN ENGINEER.

# EROSION CONTROL:

- 1. INSTALL ALL EROSION CONTROL DEVICES AS INDICATED ON DRAWINGS AND IN ACCORDANCE WITH THE NEW YORK STATE STANDARDS & SPECIFICATIONS FOR EROSION & SEDIMENT CONTROL, LATEST REVISION.
- CONTRACTOR SHALL MAINTAIN ALL EROSION CONTROL DEVICES DURING COURSE OF CONSTRUCTION.
   EROSION CONTROL DEVICES SHALL NOT BE REMOVED UNTIL FULL VEGETATION GROWTH HAS OCCURRED AND AS
- APPROVED BY THE TOWN INSPECTOR.

  4. SEEDING AND MULCHING SHALL BE AS FOLLOWS:
  - 4.1. LIME: 90LBS./1,000 SQ.FT. GROUND LIMESTONE, FERTILIZER: 4LBS./1,000 SQ.FT., 10-20-10 OR EQUIVALENT
  - WORKED INTO SOIL A MINIMUM OF 4 INCHES.
    4.2. SEED: ANNUAL RYEGRASS 40 LBS./ACRE OR OTHER APPROVED SEED, PLANT BETWEEN MARCH 1 AND MAY 15
  - OR BETWEEN AUGUST 15 AND OCTOBER 1.

    4.3. MULCH: SALT HAY OR SMALL GRAIN STRAW AT A RATE OF 70 TO 90 LBS./1,000 SQ.FT. TO BE APPLIED ACCORDING TO STANDARD PRACTICES, MULCH SHALL BE SECURED BY APPROVED METHODS.
- THE APPLICANT SHALL BE REQUIRED TO CLEAN ROADWAYS FROM ALL SILTATION AND CONSTRUCTION DEBRIS AS REQUIRED, AND UPON COMPLETION OF THE WORK, WITHIN THE VICINITY OF THE PROJECT SITE
   ALL PLANS SHOULD FULLY INCORPORATE THE APPROPRIATE RECOMMENDATIONS FROM NEW YORK STATE DEPARTMENT OF ENVIRONMENTAL CONSERVATION'S <u>STANDARDS AND SPECIFICATIONS FOR EROSION AND SEDIMENT CONTROL DATED AUGUST 2001</u>, OR THE MOST CURRENT VERSION OR ITS SUCCESSOR. THE PLAN AND ITS IMPLEMENTATION SHALL BE SUBJECT TO THE APPROVAL OF THE TOWN ENGINEER.

## SITE WORK

- THE SITE SHALL BE GRADED AS INDICATED ON THE DRAWINGS. ALL PROPOSED CONTOURS SHALL BE GRADED TO BLEND EVENLY WITH THE EXISTING CONTOURS.
- 2. ALL DISTURBED AREAS WHICH WILL BE LEFT EXPOSED FOR MORE THAN THIRTY (30) DAYS AND NOT SUBJECTED TO CONSTRUCTION TRAFFIC SHALL IMMEDIATELY RECEIVE TEMPORARY SEEDING. IF THE SEASON PROHIBITS TEMPORARY SEEDING, THE DISTURBED AREA WILL BE MULCHED WITH SALT HAY, OR APPROVED EQUAL, AND BOUND AS PER THE NEW YORK STATE STANDARDS & SPECIFICATIONS FOR EROSION AND SEDIMENT CONTROL.
- 3. FILL MATERIAL SHALL BE CLEAN FILL AND SHALL BE INSTALLED IN 12 INCH LIFTS AND COMPACTED TO 95% OPTIMUM DENSITY
- 4. ALL STORM DRAIN PIPES SHALL BE H.D.P.E. PIPES UNLESS OTHERWISE NOTED.
- 5. ALL GRAVEL SHALL BE 3/4" CRUSHED STONE OR RECYCLED MATERIAL IF ALLOWED BY THE MUNICIPALITY.
  6. MAINTAIN POSITIVE PITCHES ON ALL DRAIN PIPES TO EXISTING & PROPOSED DRAINAGE STRUCTURES UNLESS OTHERWISE
- 7. PIPE LAYOUT MUST MEET TOWN CODE.

TEMPORARY SEEDING & MULCHING

# PROPOSED 1 FAMILY RESIDENCE FOR ARMONK ESTATES LLC

4 ARMONK HEIGHTS ROAD
TOWN OF NORTH CASTLE, NEW YORK
SEC.: 101.34 BLOCK: 1 TAX LOT: 34

ENGINEERING, P.C.

CONSULTING ENGINEERS & LAND SURVEYORS

Licensed in New York and Connecticut

Tel:. 914-920-6372

EMail: admin@masengpc.com

www.masengpc.com

owned by and the property of this office and were created, evolved an

developed for use and in connection with this specific project. None of suc

MIDLAND AVENUE, SUITE 100, PORT CHESTER, N.Y. 10573

Z

Drawing North

ant Name and Address
ARMONK

ESTATES

LLC
21 BRASSIE ROAD
EASTCHESTER, NY

Project Information
PROPOSED 1
FAMILY

RESIDENCE

Situated At

4 ARMONK HEIGHTS RD

TOWN OF NORTH CASTLE

WESTCHESTER CO.

NEW YORK

TAX ASSESSMENT INFO:
SEC: 101.01
BLOCK: 1
TAX LOT: 34

Job No. MISC
Scale AS NOTED
Date 1 OCT, 2023
Drawn By M.M.
Checked By M.M.

T10(

Sed & Signature

OF NEW YORK STATE RAN IT AND DRIESS.

MICHAEL MASTROQIACOMO, P.E., L.S.

NEW YORK STATE RAN IT AND DRIESS.

# Soil Mage—West Details Control Mage—West Det

Page 1 of 3

# Map Unit Legend Map Unit Symbol Map Unit Name Fit Fluvaquents-Udifluvents complex, frequently flooded LeB Leicester loam, 3 to 8 percent slopes, stony RhD Riverhead loam, 15 to 25 percent slopes Totals for Area of Interest Map Unit Name Acres in AOII Percent of AGI Percent

### Soil Map-Westchester County, New York **MAP LEGEND** MAP INFORMATION Area of Interest (AOI The soil surveys that comprise your AOI were mapped at Stony Spot Warning: Soil Map may not be valid at this scale. Very Stony Spot Soil Map Unit Polygor Enlargement of maps beyond the scale of mapping can cause misunderstanding of the detail of mapping and accuracy of soil Soil Map Unit Lines line placement. The maps do not show the small areas of Soil Map Unit Points contrasting soils that could have been shown at a more detailed Special Line Features Please rely on the bar scale on each map sheet for map Source of Map: Natural Resources Conservation Service Web Soil Survey URL: Closed Depression Coordinate System: Web Mercator (EPSG:3857) Maps from the Web Soil Survey are based on the Web Mercator Gravelly Spot projection, which preserves direction and shape but distorts distance and area. A projection that preserves area, such as the Albers equal-area conic projection, should be used if more accurate calculations of distance or area are required. Lava Flow This product is generated from the USDA-NRCS certified data as Marsh or swamp Aerial Photography of the version date(s) listed below. Mine or Quarry Soil Survey Area: Westchester County, New York Miscellaneous Wate Survey Area Data: Version 19, Sep 6, 2023 Perennial Water Soil map units are labeled (as space allows) for map scales 1:50,000 or larger. Rock Outcrop Date(s) aerial images were photographed: Oct 21, 2022—Oct Sandy Spot The orthophoto or other base map on which the soil lines were Severely Eroded Spot compiled and digitized probably differs from the background imagery displayed on these maps. As a result, some minor Sinkhole shifting of map unit boundaries may be evident. Slide or Stip

Web Soil Survey

National Cooperative Soil Survey

10/10/2023

Page 2 of 3

# LIST OF DRAWINGS

T100 - TITLE SHEET, VICINITY MAP & GENERAL NOTES

T101 - TAX MAP

TOPOGRAPHIC SURVEY

C100 - EROSION CONTROL & TREE REMOVAL PLAN

C101 - PARTIAL SITE PLAN & ZONING ANALYSIS TABLE

C102 - PARTIAL GRADING &UTILITY PLAN

C200 - STORMWATER DESIGN COMPUTATIONS & DETAILS

C201 - CONSTRUCTION DETAILS

C202 - CONSTRUCTION DETAILS

C203 - CONSTRUCTION DETAILS

ARCHITECTURAL ELEVATIONS

PLANNING BOARD CHAIRMAN

) - ARCHITECTURAL ELEVATIONS

TOWN OF NORTH CASTLE BUILDING DEPARTMENT

DATE

APR 2 4 REC'D

RECEIVED

A200 - FIRST FLOOR PLAN


A201 - SECOND FLOOR PLAN


NORTH CASTLE PLANNING BOARD APPROVAL:

APPROVED BY THE TOWN OF NORTH CASTLE PLANNING BOARD AS PER RESOLUTION No. \_\_\_\_\_\_ DATED: \_\_\_\_\_\_

A WEB SOIL SURVEY

National Cooperative Soil Survey

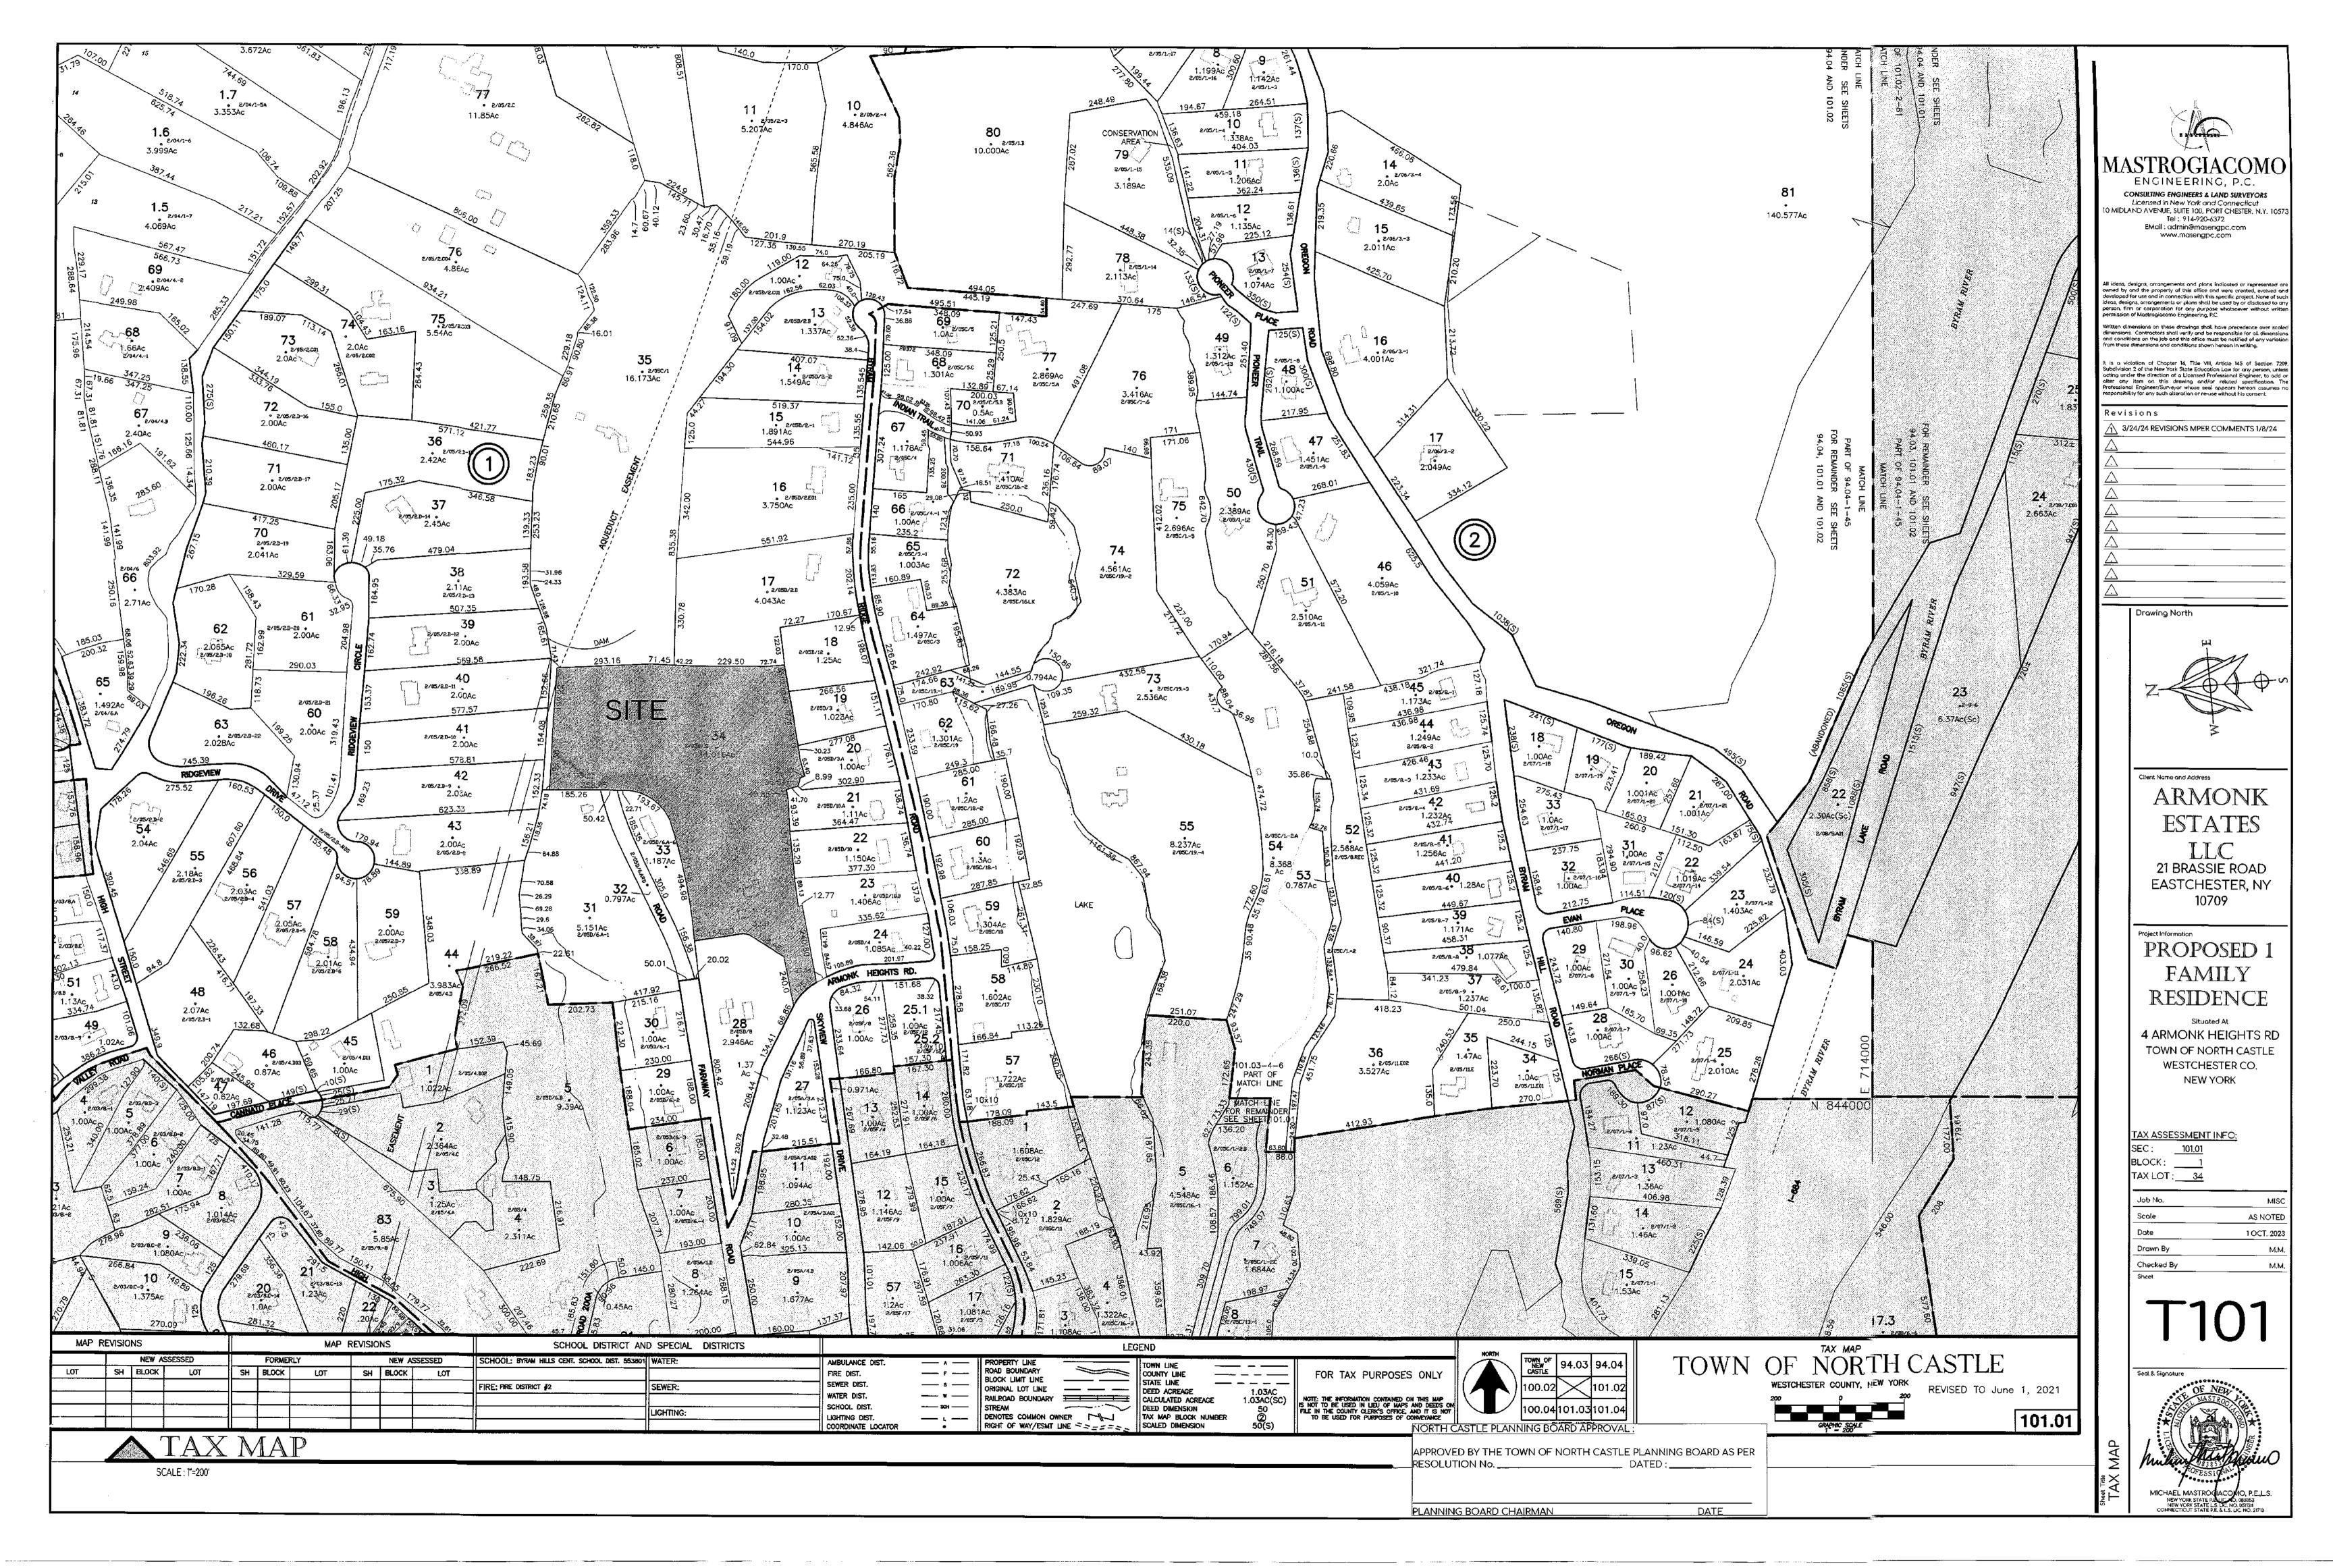

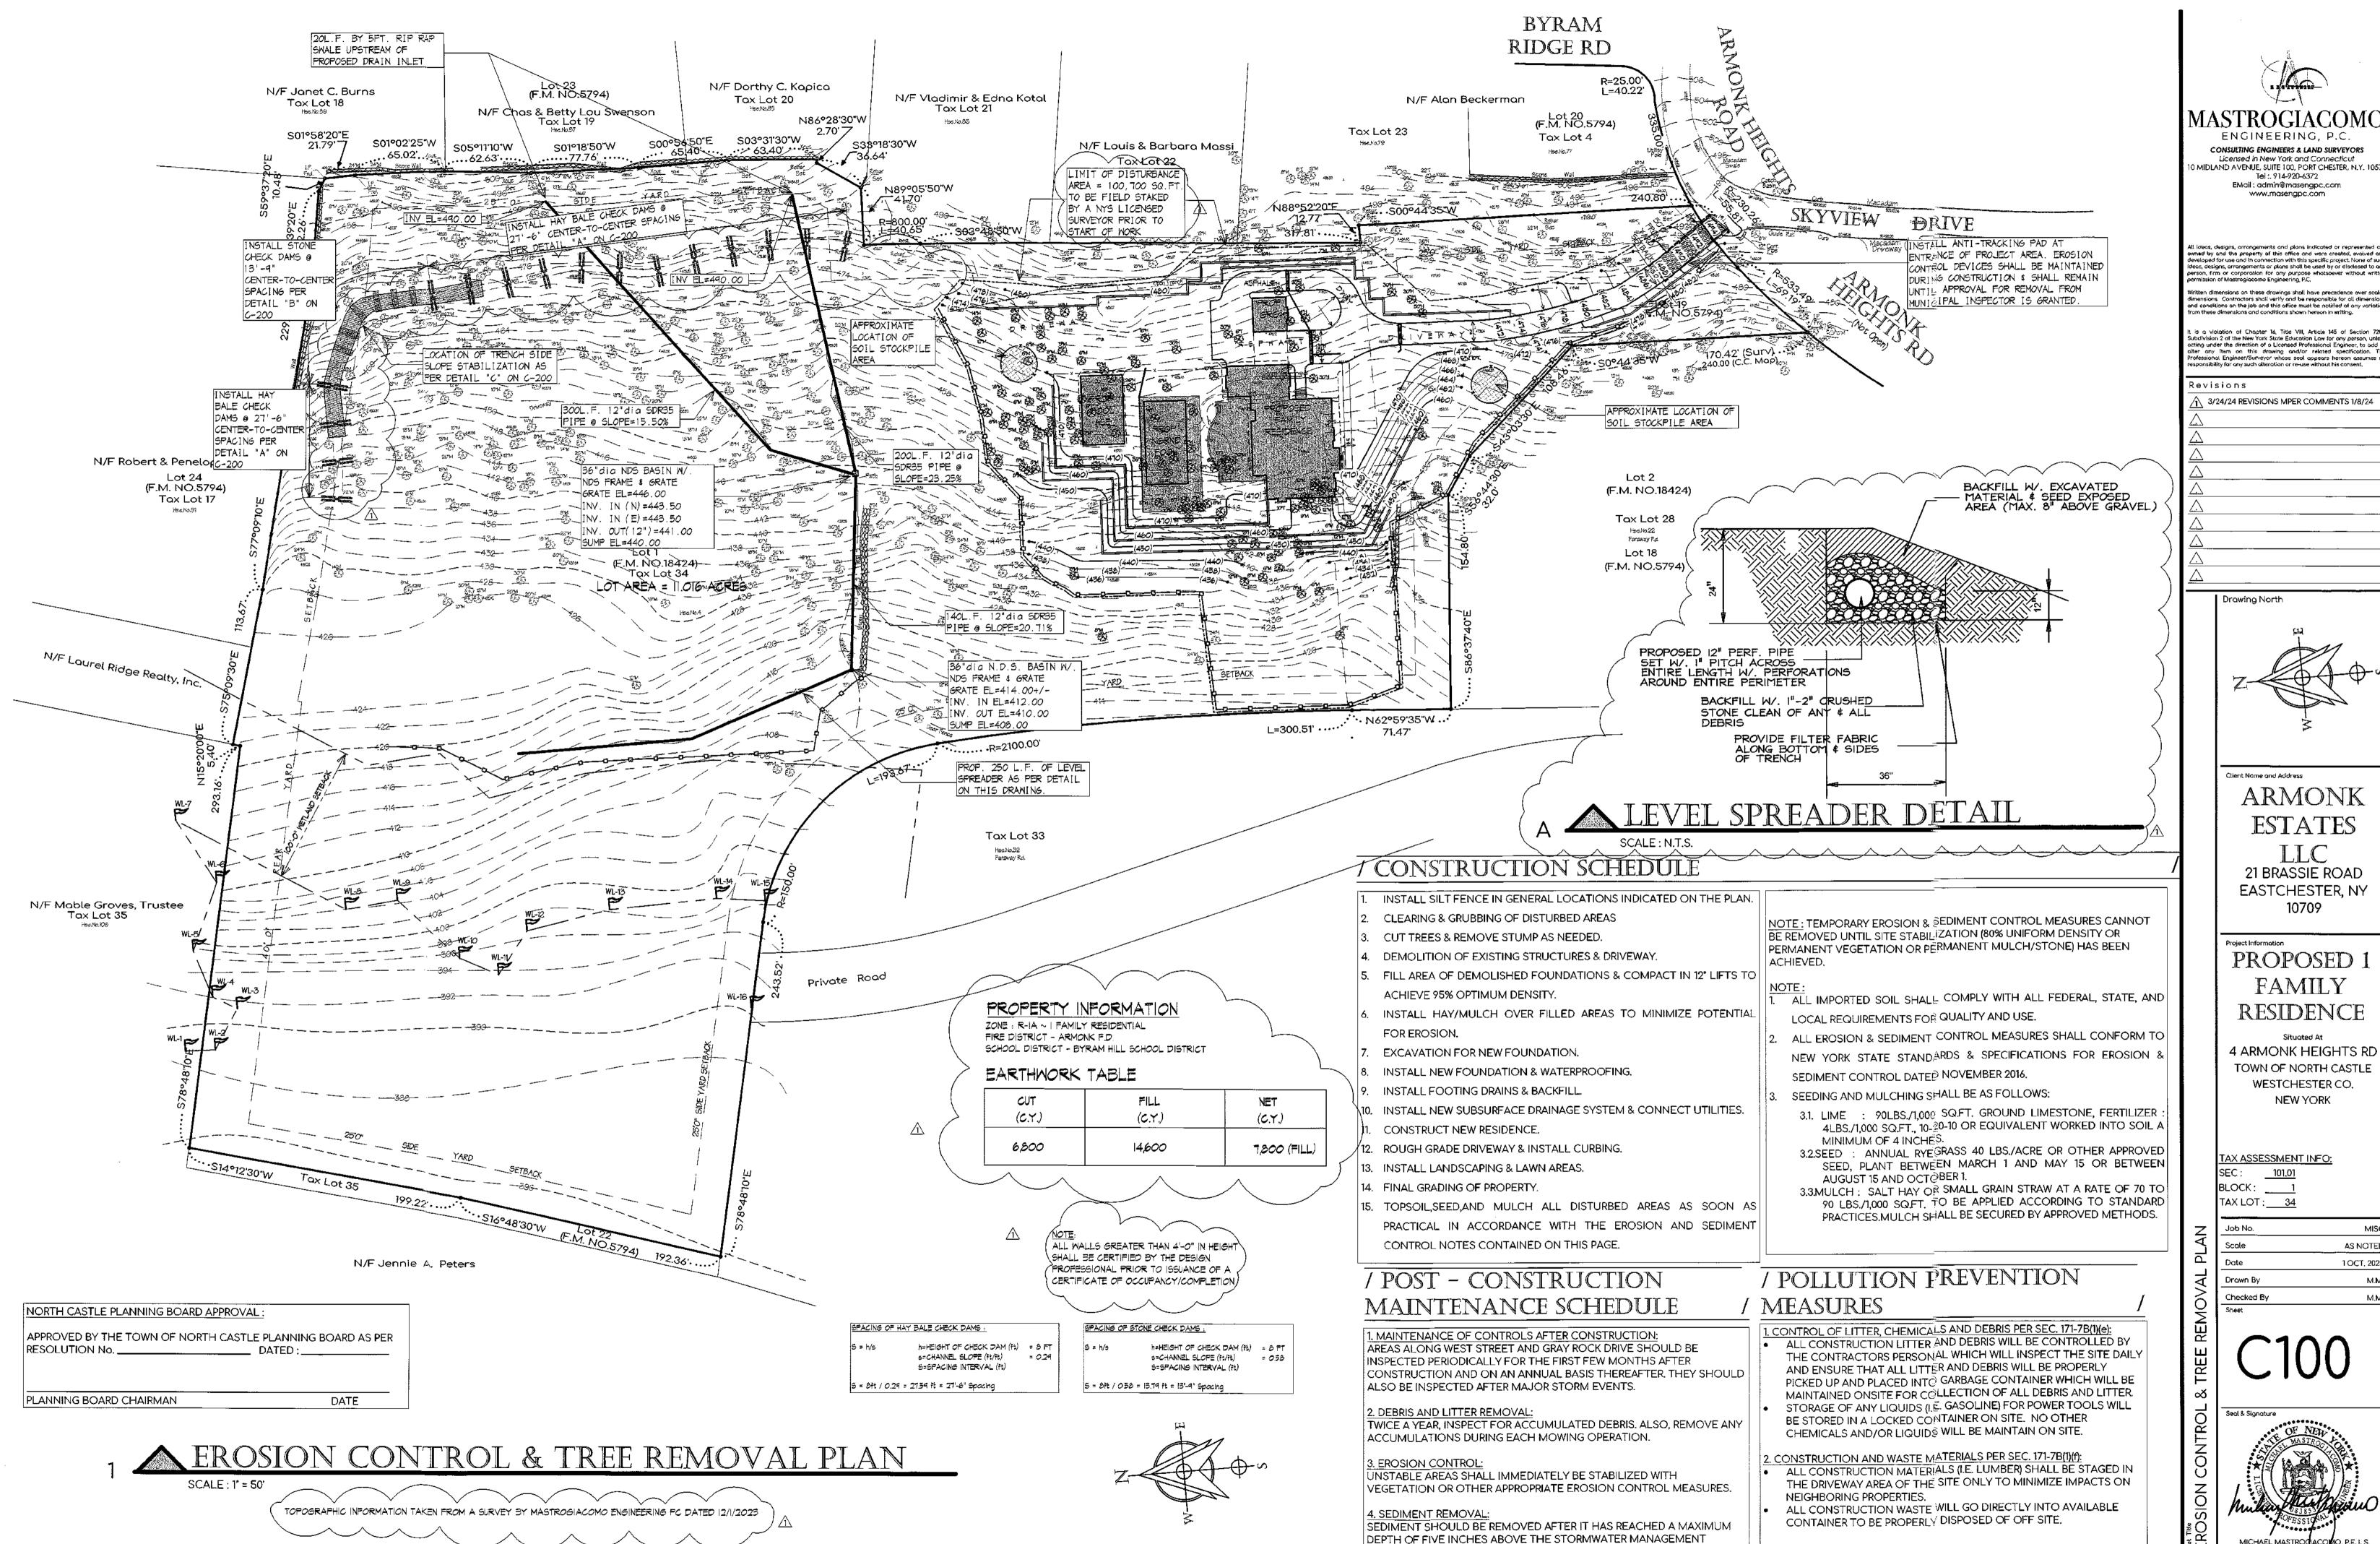

SYSTEM FLOOR.

ENGINEERING, P.C.


Tel:. 914-920-6372 EMail: admin@masengpc.com www.masengpc.com

whed by and the property of this office and were created, evolved an eveloped for use and in connection with this specific project. None of suc Jeas, designs, arrangements or plans shall be used by or disclosed to an erson, firm or corporation for any purpose whatsoever without wr

rensions. Contractors shall verify and be responsible for all dimensions. conditions on the job and this office must be notified of any varia

t is a violation of Chapter 16. Title VIII, Article 145 of Section 720 Subdivision 2 of the New York State Education Law for any person, unles acting under the direction of a Licensed Professional Engineer, to add a

3/24/24 REVISIONS MPER COMMENTS 1/8/24

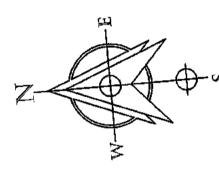

ARMONK


21 BRASSIE ROAD EASTCHESTER, NY


PROPOSED 1 FAMILY RESIDENCE


4 ARMONK HEIGHTS RD TOWN OF NORTH CASTLE WESTCHESTER CO.

AS NOTED 1 OCT, 2023

MICHAEL MASTROCIACOMO, P.E., L.S.

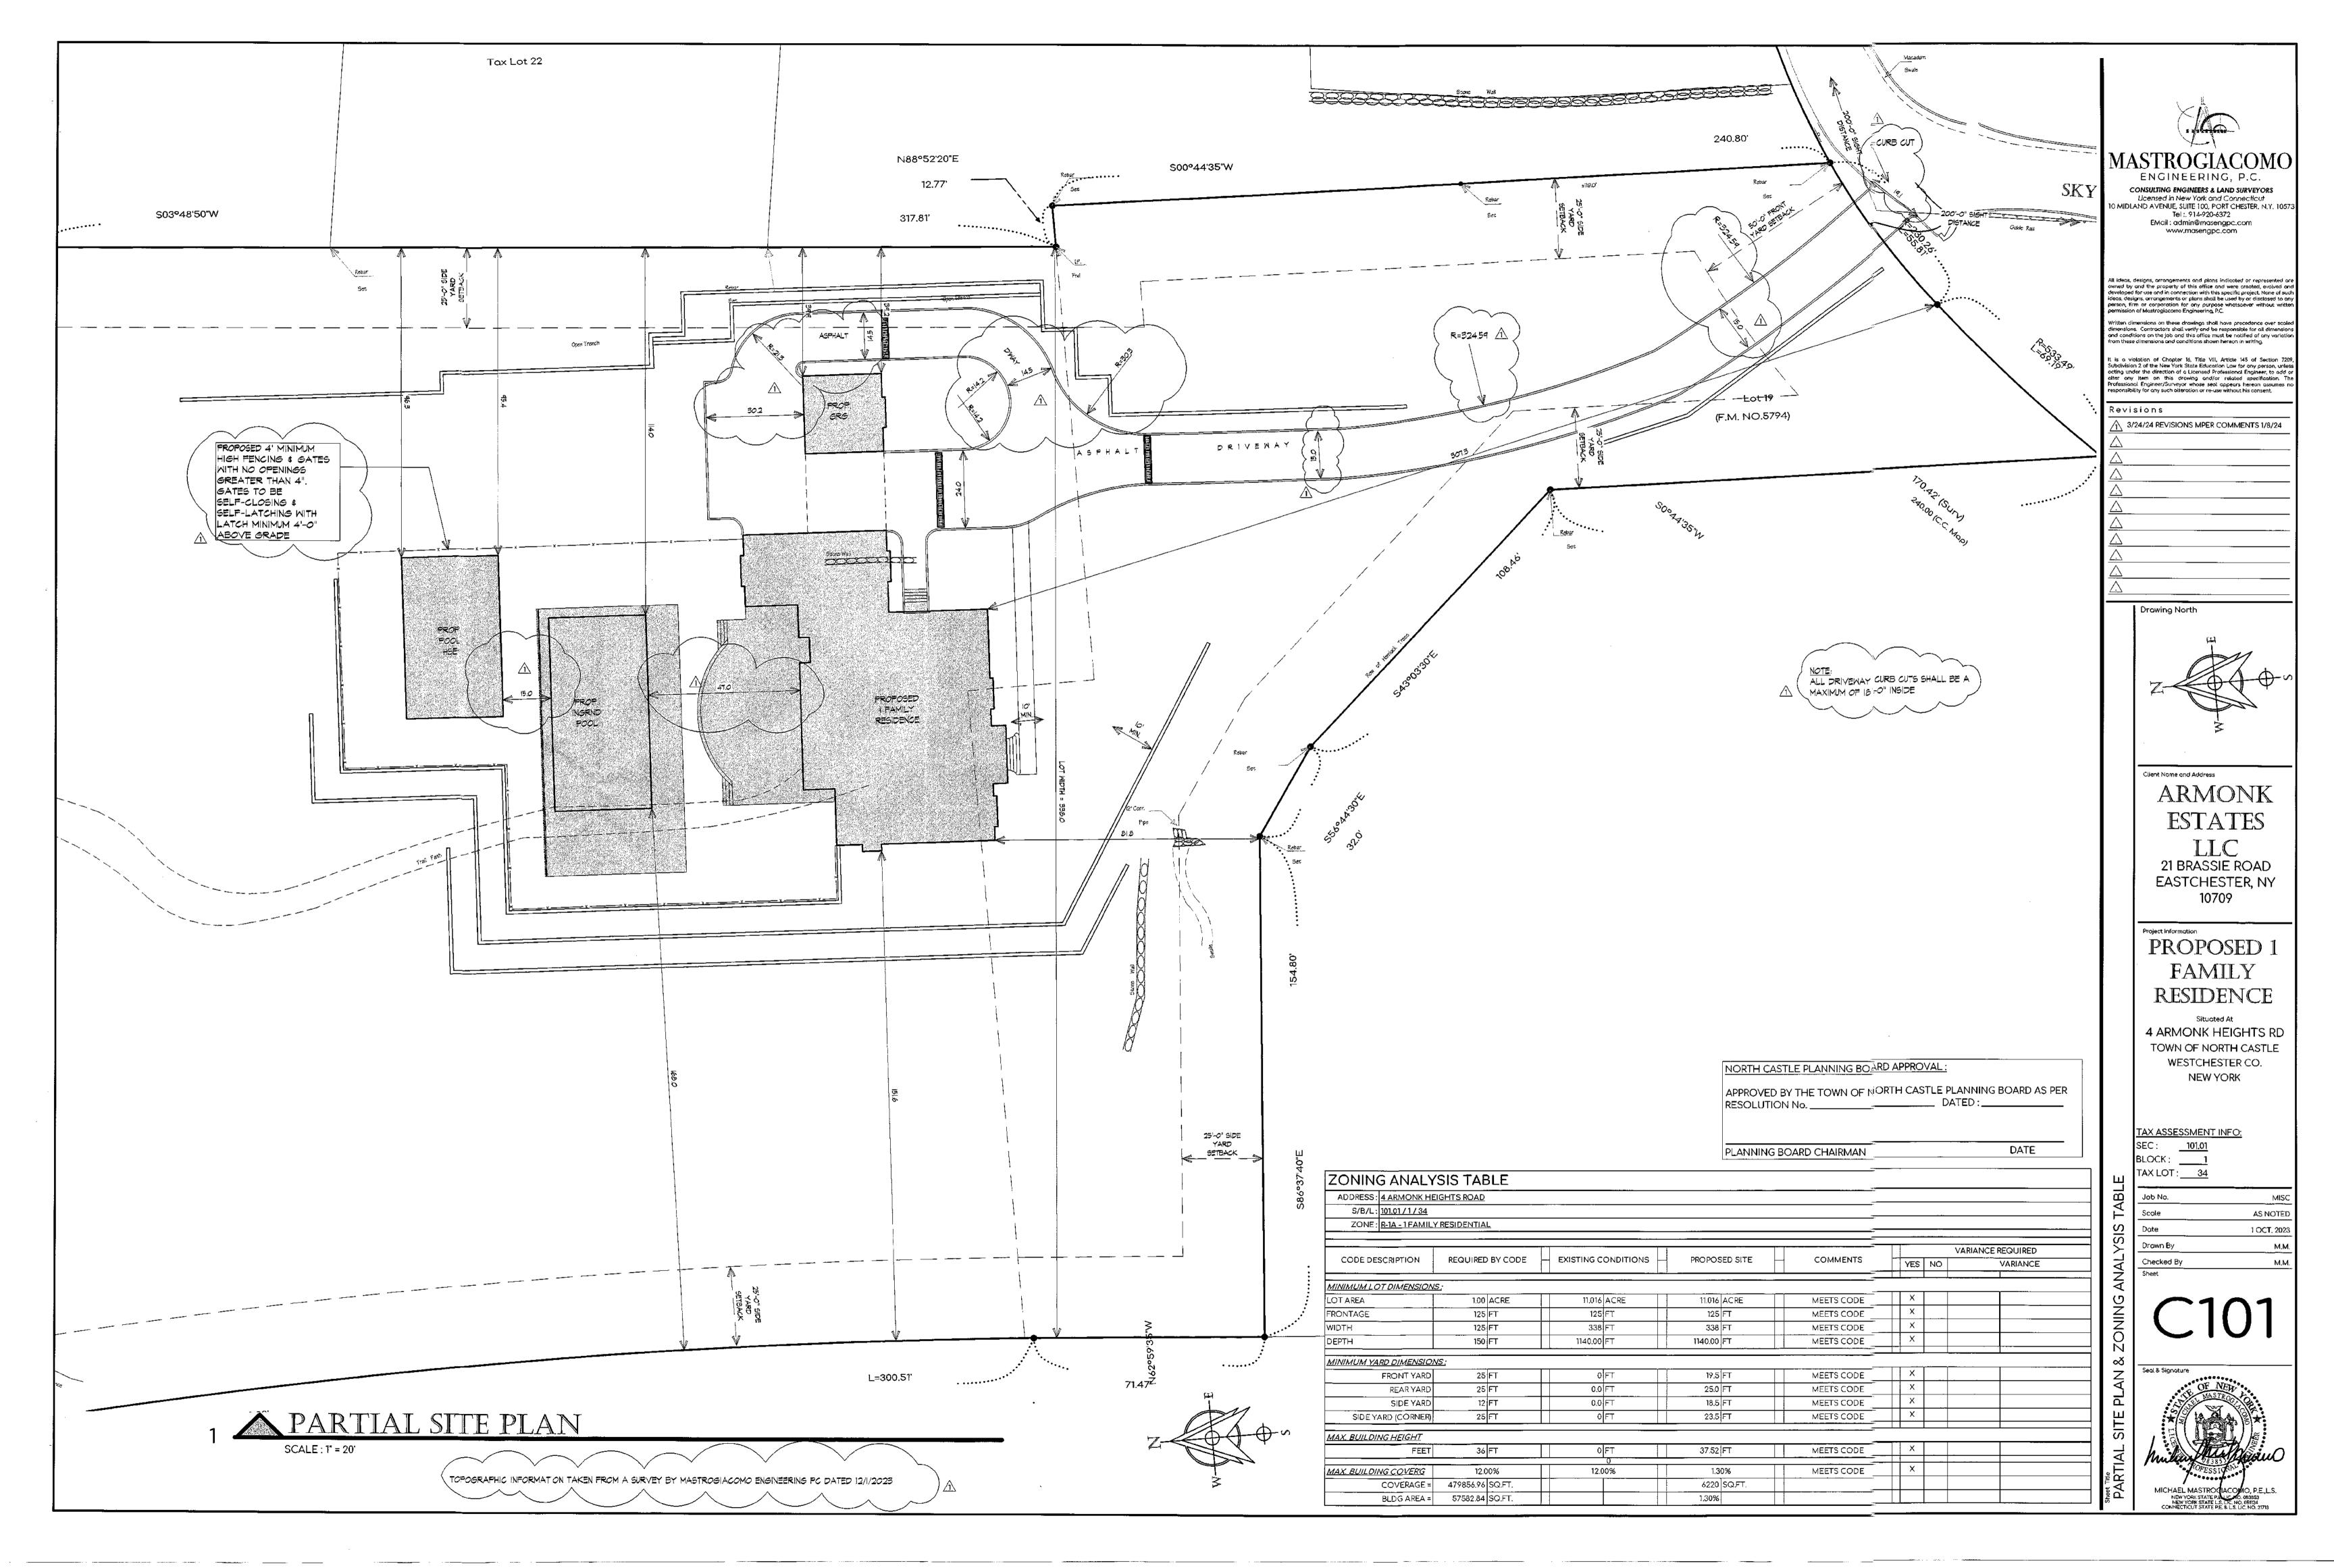

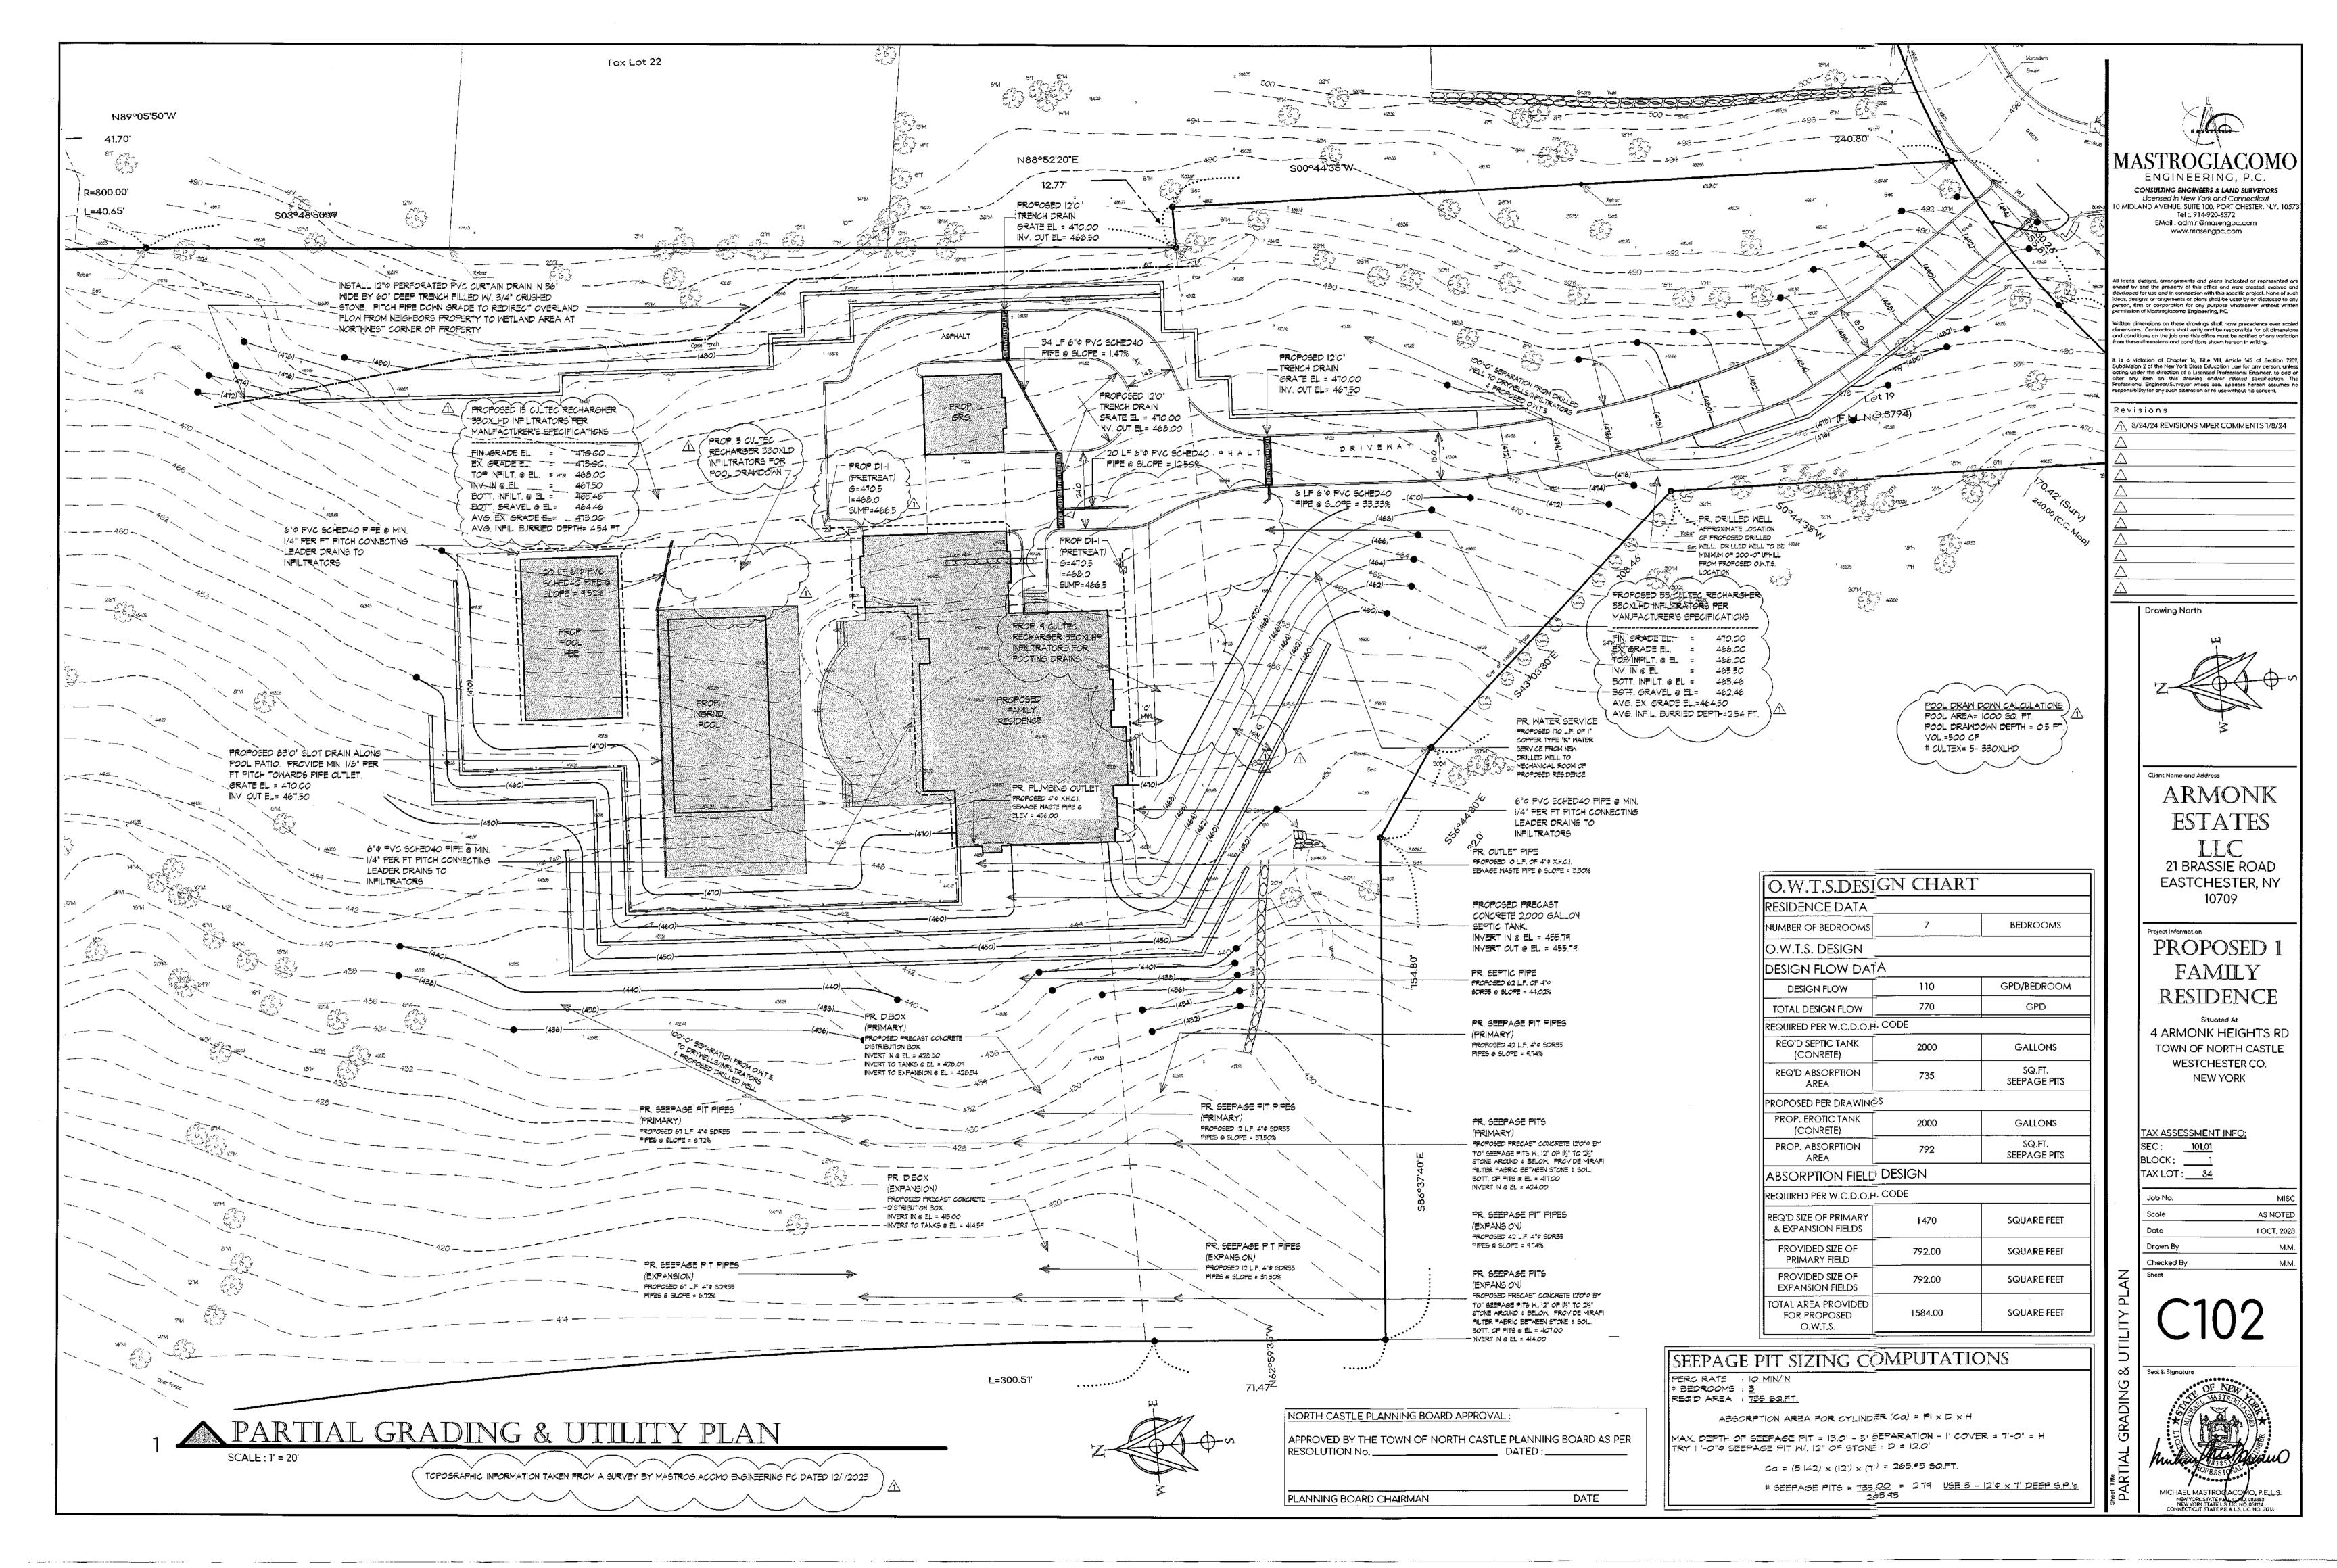

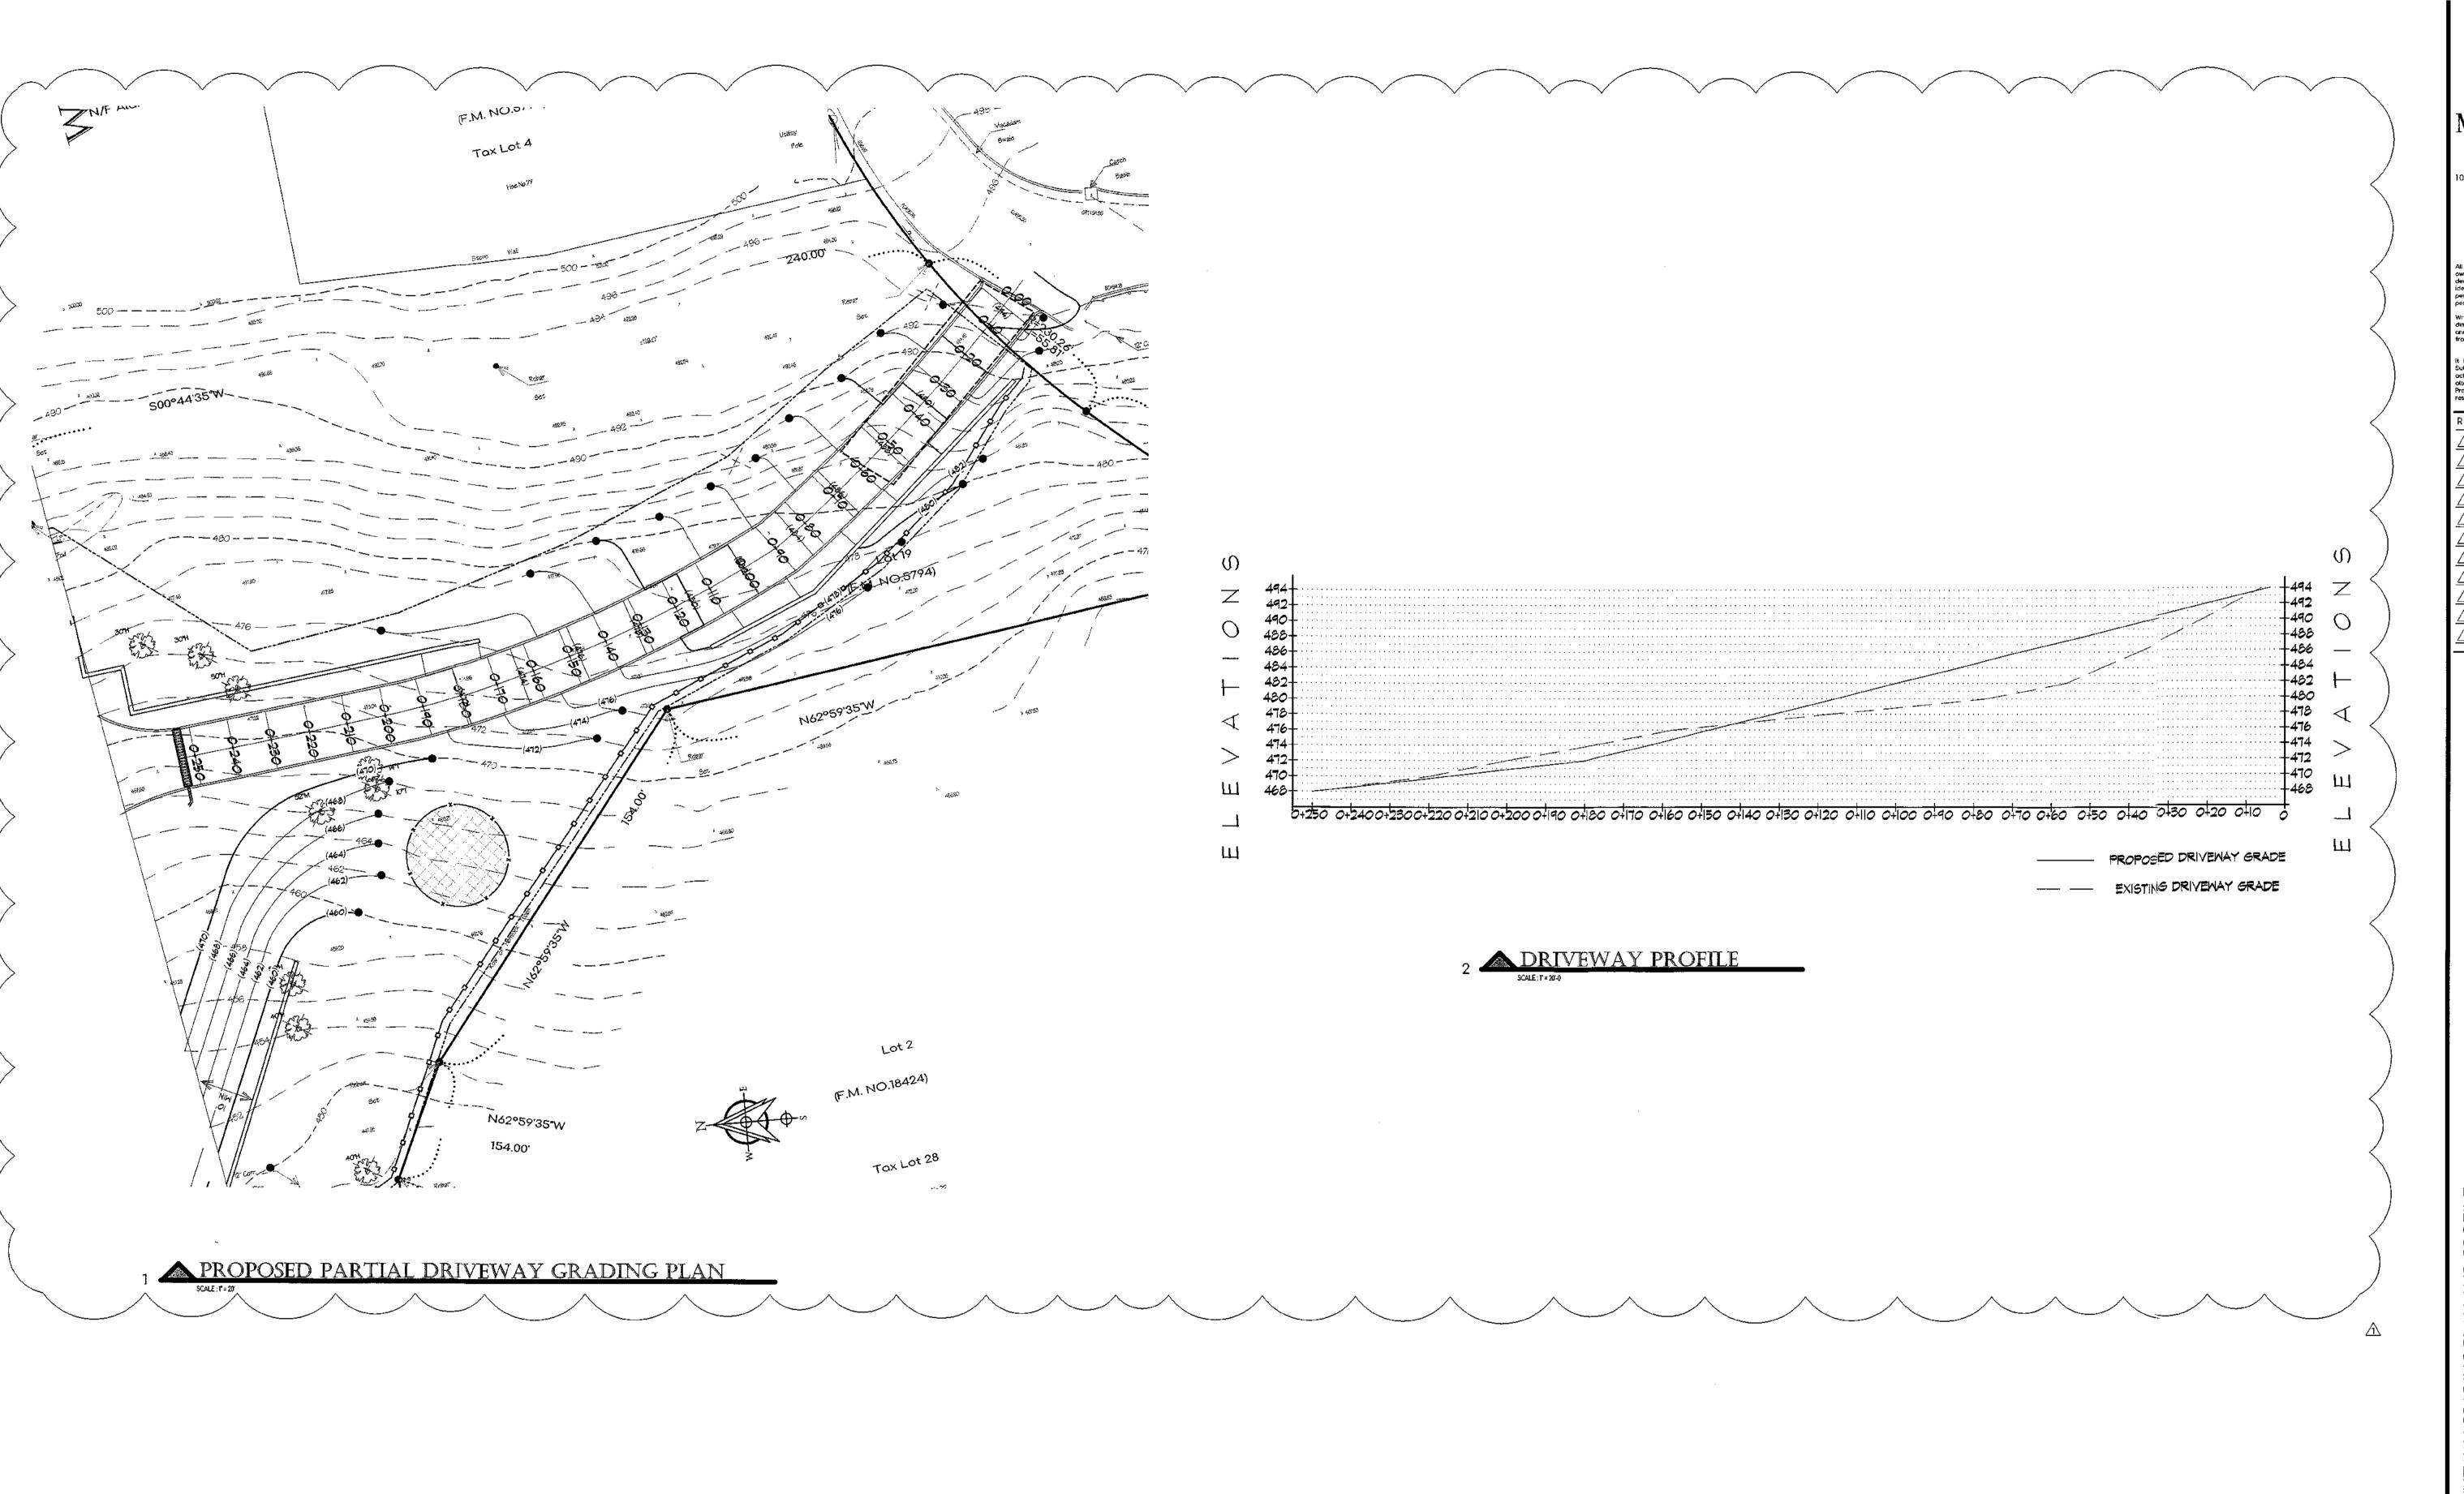



CONSULTING ENGINEERS & LAND SURVEYORS Licensed in New York and Connecticut 10 MIDLAND AVENUE, SUITE 100, PORT CHESTER, N.Y. 10573 Tel:. 914-920-6372 EMail: admin@masengpc.com www.masengpc.com

All ideas, designs, arrangements and plans indicated or represented are owned by and the property of this office and were created, evolved and developed for use and in connection with this specific project. None of such ideas, designs, arrangements or plans shall be used by or disclosed to any person, firm or corporation for any purpose whatsoever without written permission of Mostrogiacomo Engineering, P.C. Written dimensions on these drawings shall have precedence over scaled dimensions. Contractors shall verify and be responsible for all dimensions and conditions on the job and this office must be notified of any variation from these dimensions and conditions shown hereon in writing.

It is a violation of Chapter 16, Title VIII, Article 145 of Section 7209, Subdivision 2 of the New York State Education Law for any person, unless acting under the direction of a Licensed Professional Engineer, to add or atler only item on this drawing and/or related specification. The Professional Engineer/Surveyor whose seal appears hereon assumes no responsibility for any such alteration or re-use without his consent.

Revisions 3/24/24 REVISIONS MPER COMMENTS 1/8/24

Drawing North

Client Name and Address ARMONK ESTATES

LLC 21 BRASSIE ROAD EASTCHESTER, NY 10709

# PROPOSED 1 FAMILY RESIDENCE

4 ARMONK HEIGHTS RD TOWN OF NORTH CASTLE WESTCHESTER CO. **NEW YORK** 


TAX ASSESSMENT INFO:


SEC: 101.01

BLOCK: 1

TAX LOT: 34

AS NOTED 1 OCT. 2023 Checked By

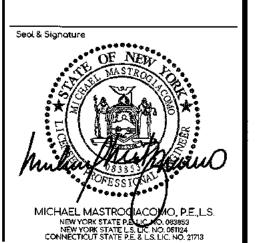

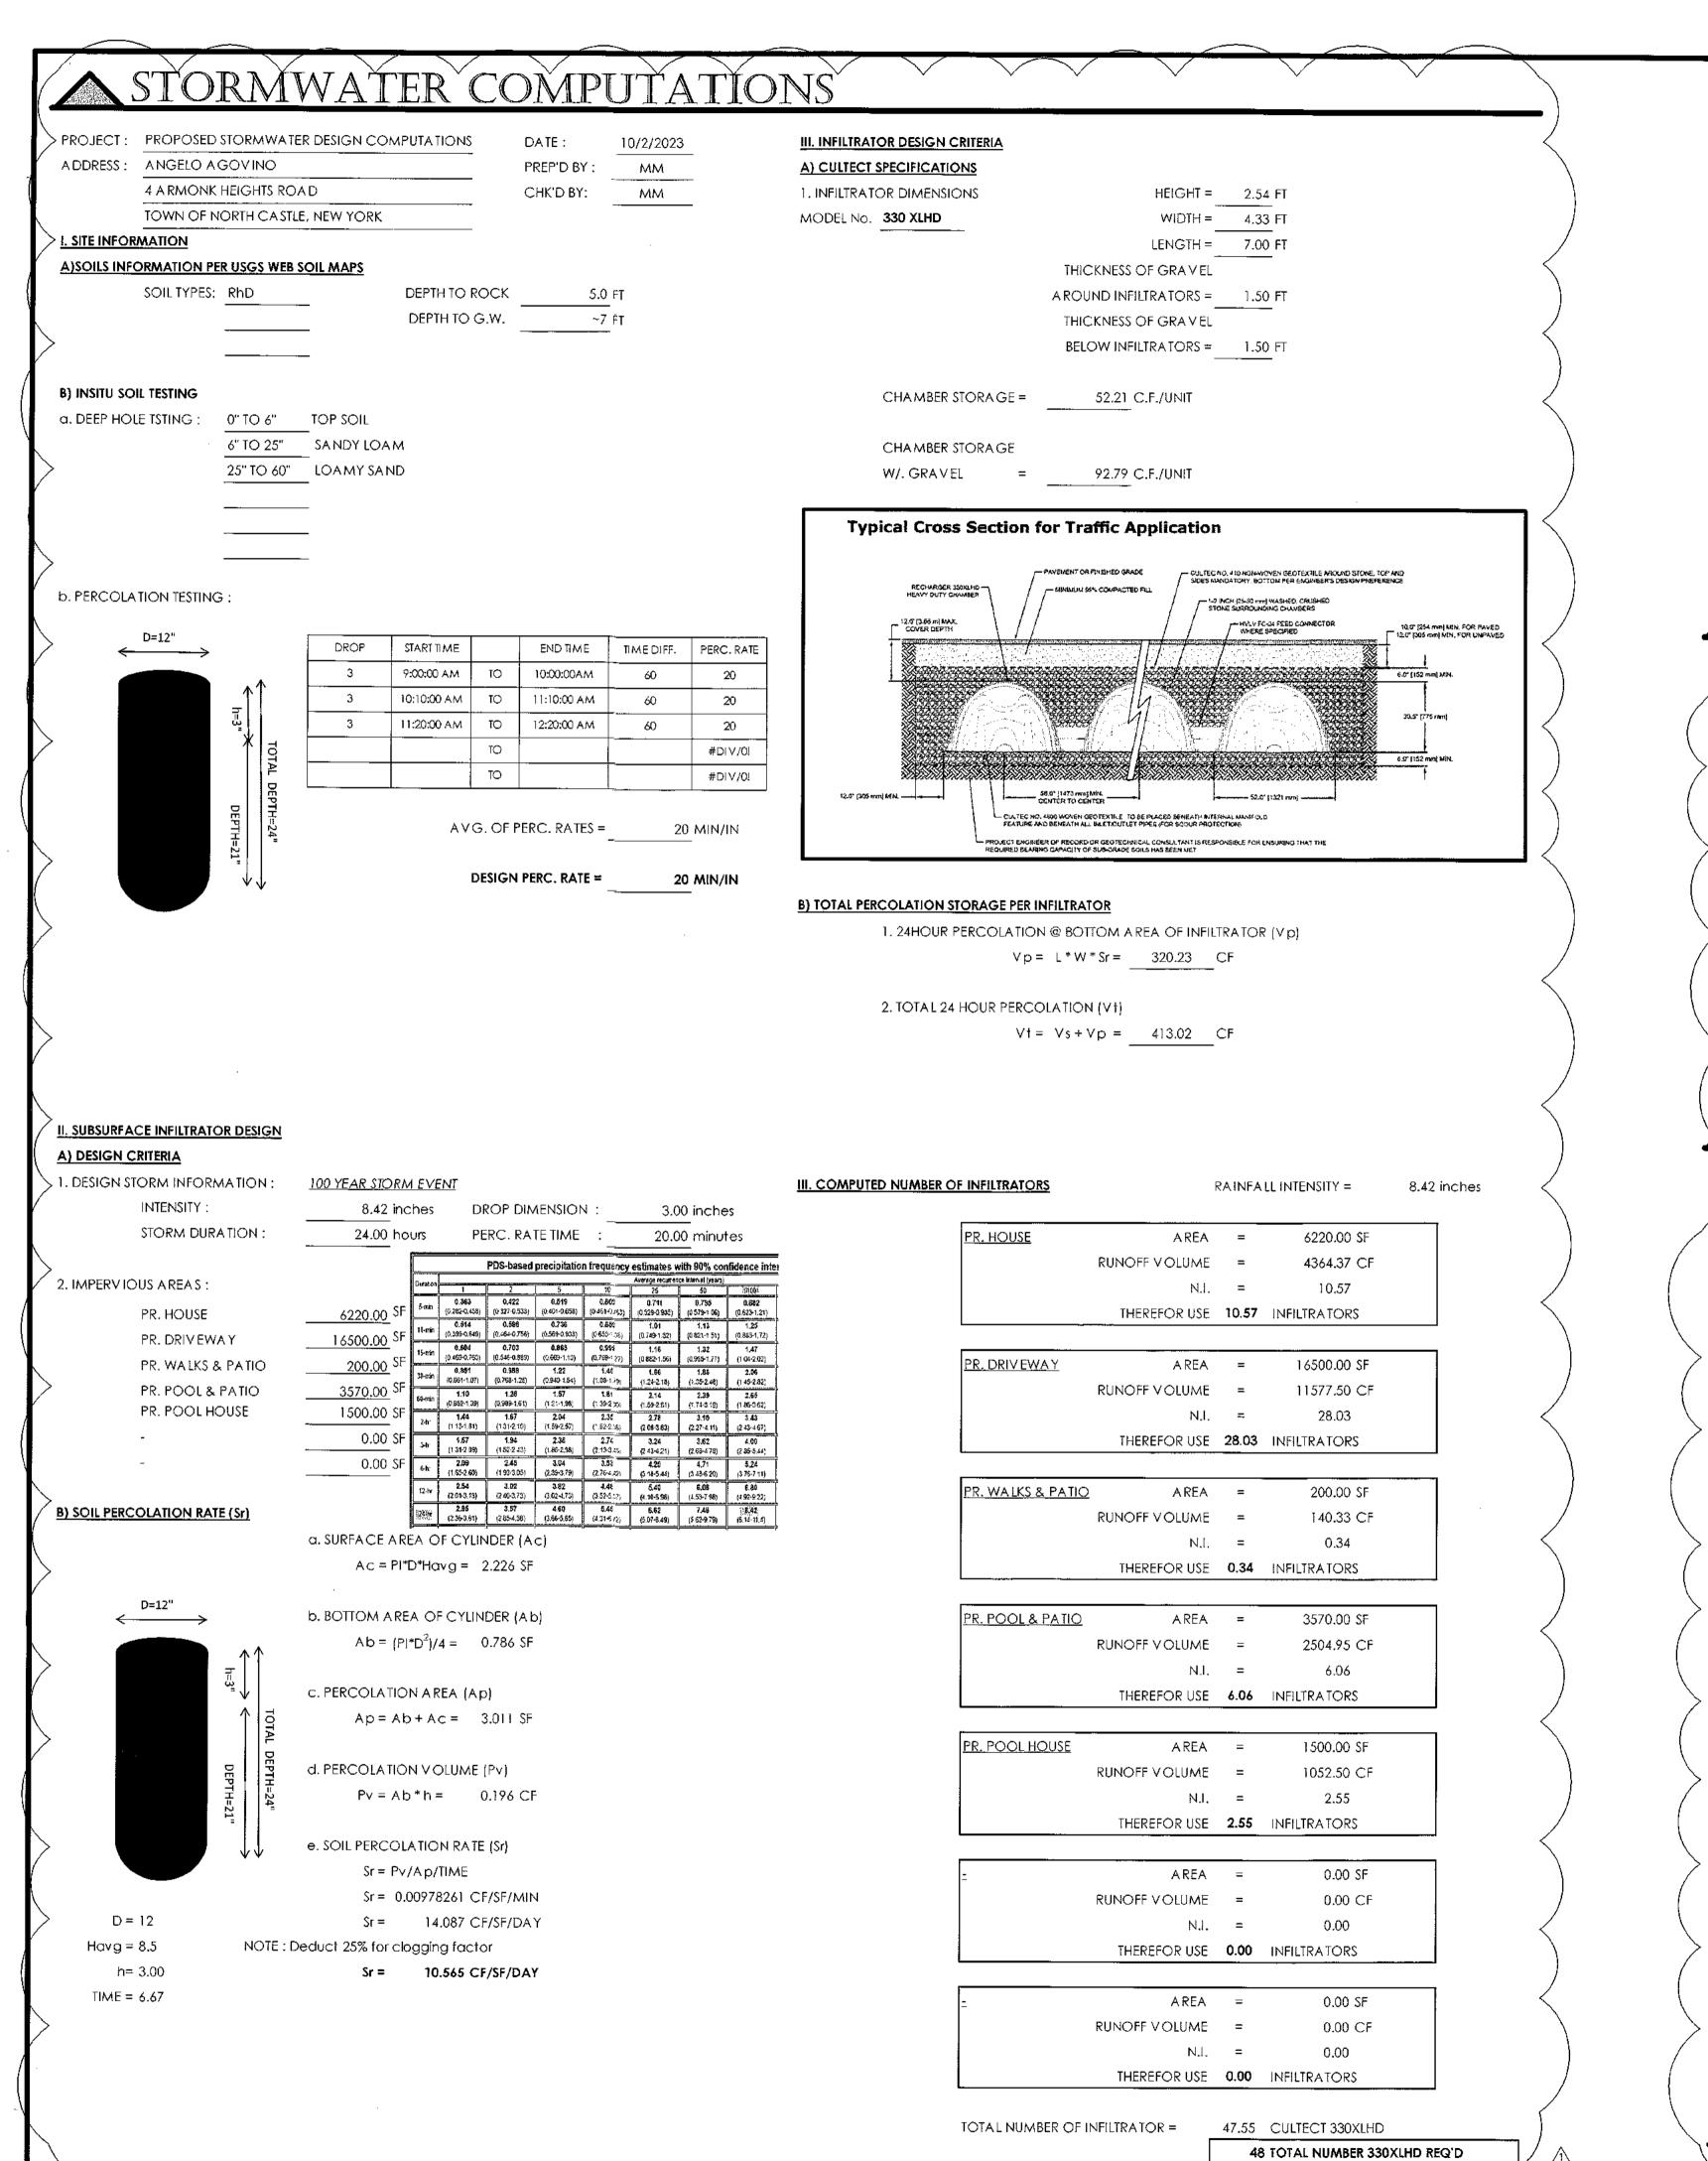

The following guidelines shall be adhered to for the operation and maintenance of the CULTEC stormwater The owner shall keep a maintenance log which shall include details of any events which would have an effect on the system's operational capacity. The operation and maintenance procedure shall be reviewed periodically and changed to meet site Maintenance of the stormwater management system shall be performed by qualified workers and shall follow applicable occupational health and safety requirements. Debris removed from the stormwater management system shall be disposed of in accordance with applicable laws and regulations. IV. Suggested Maintenance Schedules Minor Maintenance The following suggested schedule shall be followed for routine maintenance during the regular operation of the stormwater system:


Check inlets and outlets for clogging and remove any debris, as required. Check Inlets and outlets for clogging and remove any debris, as required. Check inlets and outlets for clogging and remove any debris, as required.

Major Maintenance
The following suggested maintenance schedule shall be followed to maintain the performance of the CULTEC stormwater management chambers. Additional work may be necessary due to nsufficient performance and other issues that might be found during the inspection of the stormwater management chambers. (See table on next page)

	Frequency	Action
Iniets and Outlets	Every 3 years	Obtain documentation that the inlets, outlets and vents have been cleaned and will function as intended.
	Spring and Fall	Check inlet and outlets for clogging and remove any debris as required.
CULTEC Stormwater Chambers	2 years after commis- signing	Inspect the interior of the stormwater management chambers through inspection part for deficiencies using CCTV or comparable technique.
		Obtain documentation that the stormwater management chambers and feed connectors will function as anticipated.
	9 years after commis- sioning every 9 years following	Clean stormwater management chambers and feed connectors of any debris.
		Inspect the interior of the stormwater management structu <sup>ces</sup> for deficiencies using CCTV or comparable technique.
		Obtain documentation that the stormwater management chambers and feed connectors have been cleaned and will function as intended.
	45 years after com- missioning	Clean stormwater management chambers and feed connectors of any debris.
		Determine the remaining life expectancy of the stormwate:      management chambers and recommended schedule and actions to rehabilitate the stormwater management chambers as required:
		<ul> <li>Inspect the interior of the stormwater management chambers for deficiencies using CCTV or comparable technique.</li> </ul>
		Replace or restore the stormwater management chambers in accordance with the schedule determined at the 45-year inspection.
		Attain the appropriate approvals as required.
		Establish a new operation and maintenance schedule.
Surrounding Site	Monthly in 1º year	<ul> <li>Check for depressions in areas over and surrounding the stormwater management system.</li> </ul>
	Spring and Fall	<ul> <li>Check for depressions in areas over and surrounding the stormwater management system.</li> </ul>
	Yearly	<ul> <li>Confirm that no unauthorized modifications have been performed to the site.</li> </ul>

tact CULTEC, Inc. at 1-800-428-5832.

# INFILTRATOR MAINTENANCE SCHEDULE

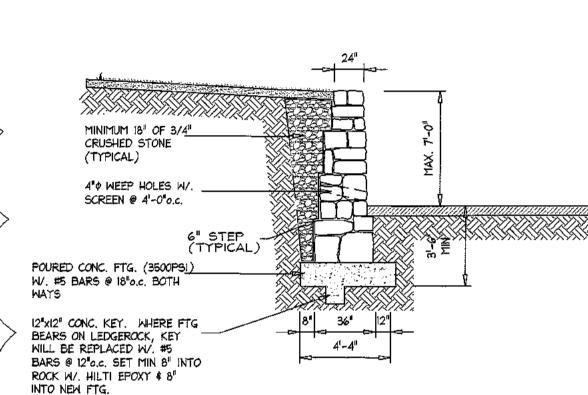

N.T.S.

SCALE: N.T.S.

SCALE: N.T.S.

DRY STONE RETAINING WALL NOTES: GENERAL:

1. ALL WORK SHALL COMPLY WITH THE PROVISIONS OF THE NEW YORK STATE FIRE PREVENTION & BUILDING & ALL OTHER APPLICABLE LOCAL BUILDING CODE

REQUIREMENTS & REGULATIONS HAVING JURISDICTION. 2. WORK THIS DRAWING IN CONJUNCTION WITH THE OTHER DRAWINGS, SPECIFICATIONS, \$ ALL OTHER PERTINENT DOCUMENTS RELATED TO THE PROJECT.

MISCELLANEOUS:


1. THE GRAVITY RETAINING WALL INDICATED SHALL BE CONSTRUCTED UTILIZING STONES, STAGGERED & INTERLOCKED, VARY MINIMUM SIZE OF STONES FROM BASE PAD TO TOP OF WALL SO THAT THE STONES ARE APPROX. 1/2 CU, YD, AT THE BASE TO APPROX. 1/4 CU. YD. AT THE TOP. 2. ALL JOINTS SHALL HAVE MORTAR & HAVE FLUSH JOINTS, UNLESS OTHERWISE 3. THE CONCRETE (3,500 PSI) FOOTING SHALL BE SET ON CLEAN SOIL, FREE OF DEBRIS,

MUD, ICE, OR ANY OTHER UNACCEPTABLE MATERIALS & HAVE A MINIMUM SOIL BEARING CAPACITY OF 4,000 PSF (2 TON/SF). BACK FILLING BEHIND THE WALL SHALL CONSIST OF GRANULAR MATERIALS & GRAVELS. WHERE ROCK IS ENCOUNTERED THE STONE RETAINING WALL MAY BE ELIMINATED AS CONDITIONS ALLOW & AS DETERMINED BY TOWN ENGINEER.

6. WHERE RETAINING WALL IS TO BE SET ON ROCK, THE ROCK MUST BE BENCHED \$ #5 REBAR SHALL BE SET WITH HILTI EPOXY A MINIMUM OF 8' INTO ROCK \$ 8" INTO NEW CONCRETE FOOTING. 7. BOULDERS GREATER THAN 1 1/2 CUBIC YARD MAY BE USED IN PLACE OF STONE RETAINING WALL AS APPROVED BY THE TOWNVILLAGE ENGINEER BOULDERS MUST BE SET ON STABLE LEVEL EARTH OR ROCK.

8. THE CONTRACTOR SHALL PROVIDE ALL NECESSARY & REQUIRED SEDIMENT & EROSION

STONE RETAINING WALL DETAIL

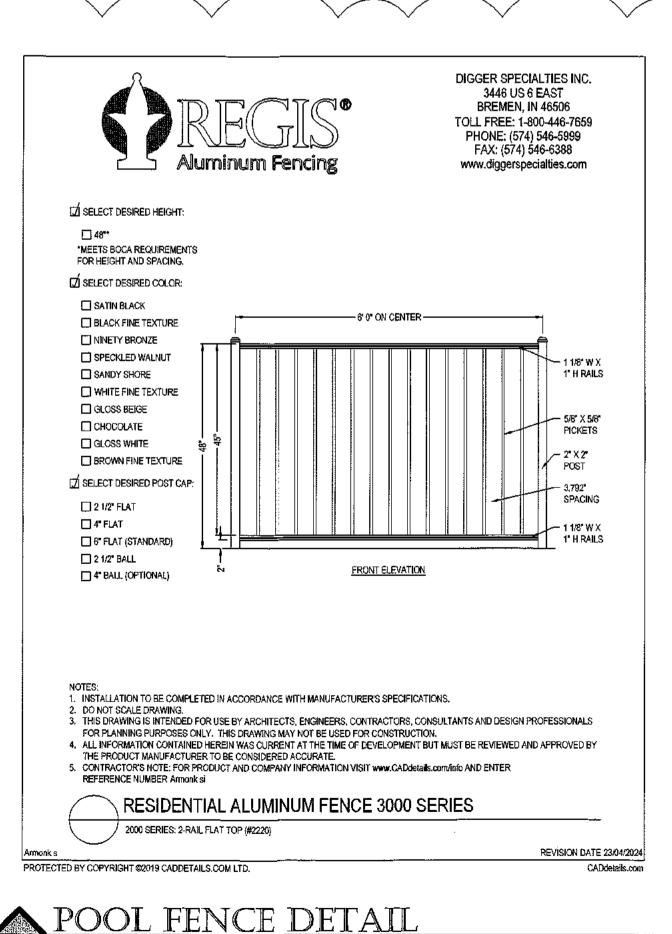

\	NORTH CASTLE PLANNING BOARD APPROVAL
1	
1	

APPROVED BY THE TOWN OF NORTH CASTLE PLANNING BOARD AS PER RESOLUTION No.

DATE PLANNING BOARD CHAIRMAN



Licensed in New York and Connecticut

MIDLAND AVENUE, SUITE 100, PORT CHESTER, N.Y. 1057

Tel:: 914-920-6372

EMail: admin@masengpc.com www.masengpc.com

owned by and the property of this office and were created, evolved an developed for use and in connection with this specific project. None of such ideas, designs, arrangements or plans shall be used by an disclosed to any person, firm or corporation for any purpose whatsoever without written

Written dimensions on these drawings shall have precedence over scaled dimensions. Contractors shall verify and be responsible for all dimensions and conditions on the job and this office must be notified of any variet from these dimensions and conditions shown hereon in writing.

It is a violation of Chapter 16, Title VIII, Article 145 of Section 7209, Subdivision 2 of the New York State Education Law for any person, unless acting under the direction of a Licensed Professional Engineer, to add ar alter any item on this drawing and/or related specification. I Professional Engineer/Surveyor whose seal appears hereon assumes responsibility for any such alteration or re-use without his consent.

> Revisions 3/24/24 REVISIONS MPER COMMENTS 1/8/24

> > Drawing North

**ESTATES** 

21 BRASSIE ROAD EASTCHESTER, NY 10709

Project Information

PROPOSED FAMILY RESIDENCE

Situated At 4 ARMONK HEIGHTS RD TOWN OF NORTH CASTLE WESTCHESTER CO.

NEW YORK

AX ASSESSMENT INFO: <u>101.01</u>


BLOCK: TAX LOT : \_\_\_\_ 34

∞ర

AS NOTED 1 OCT. 2023 Checked By

Seal & Signature



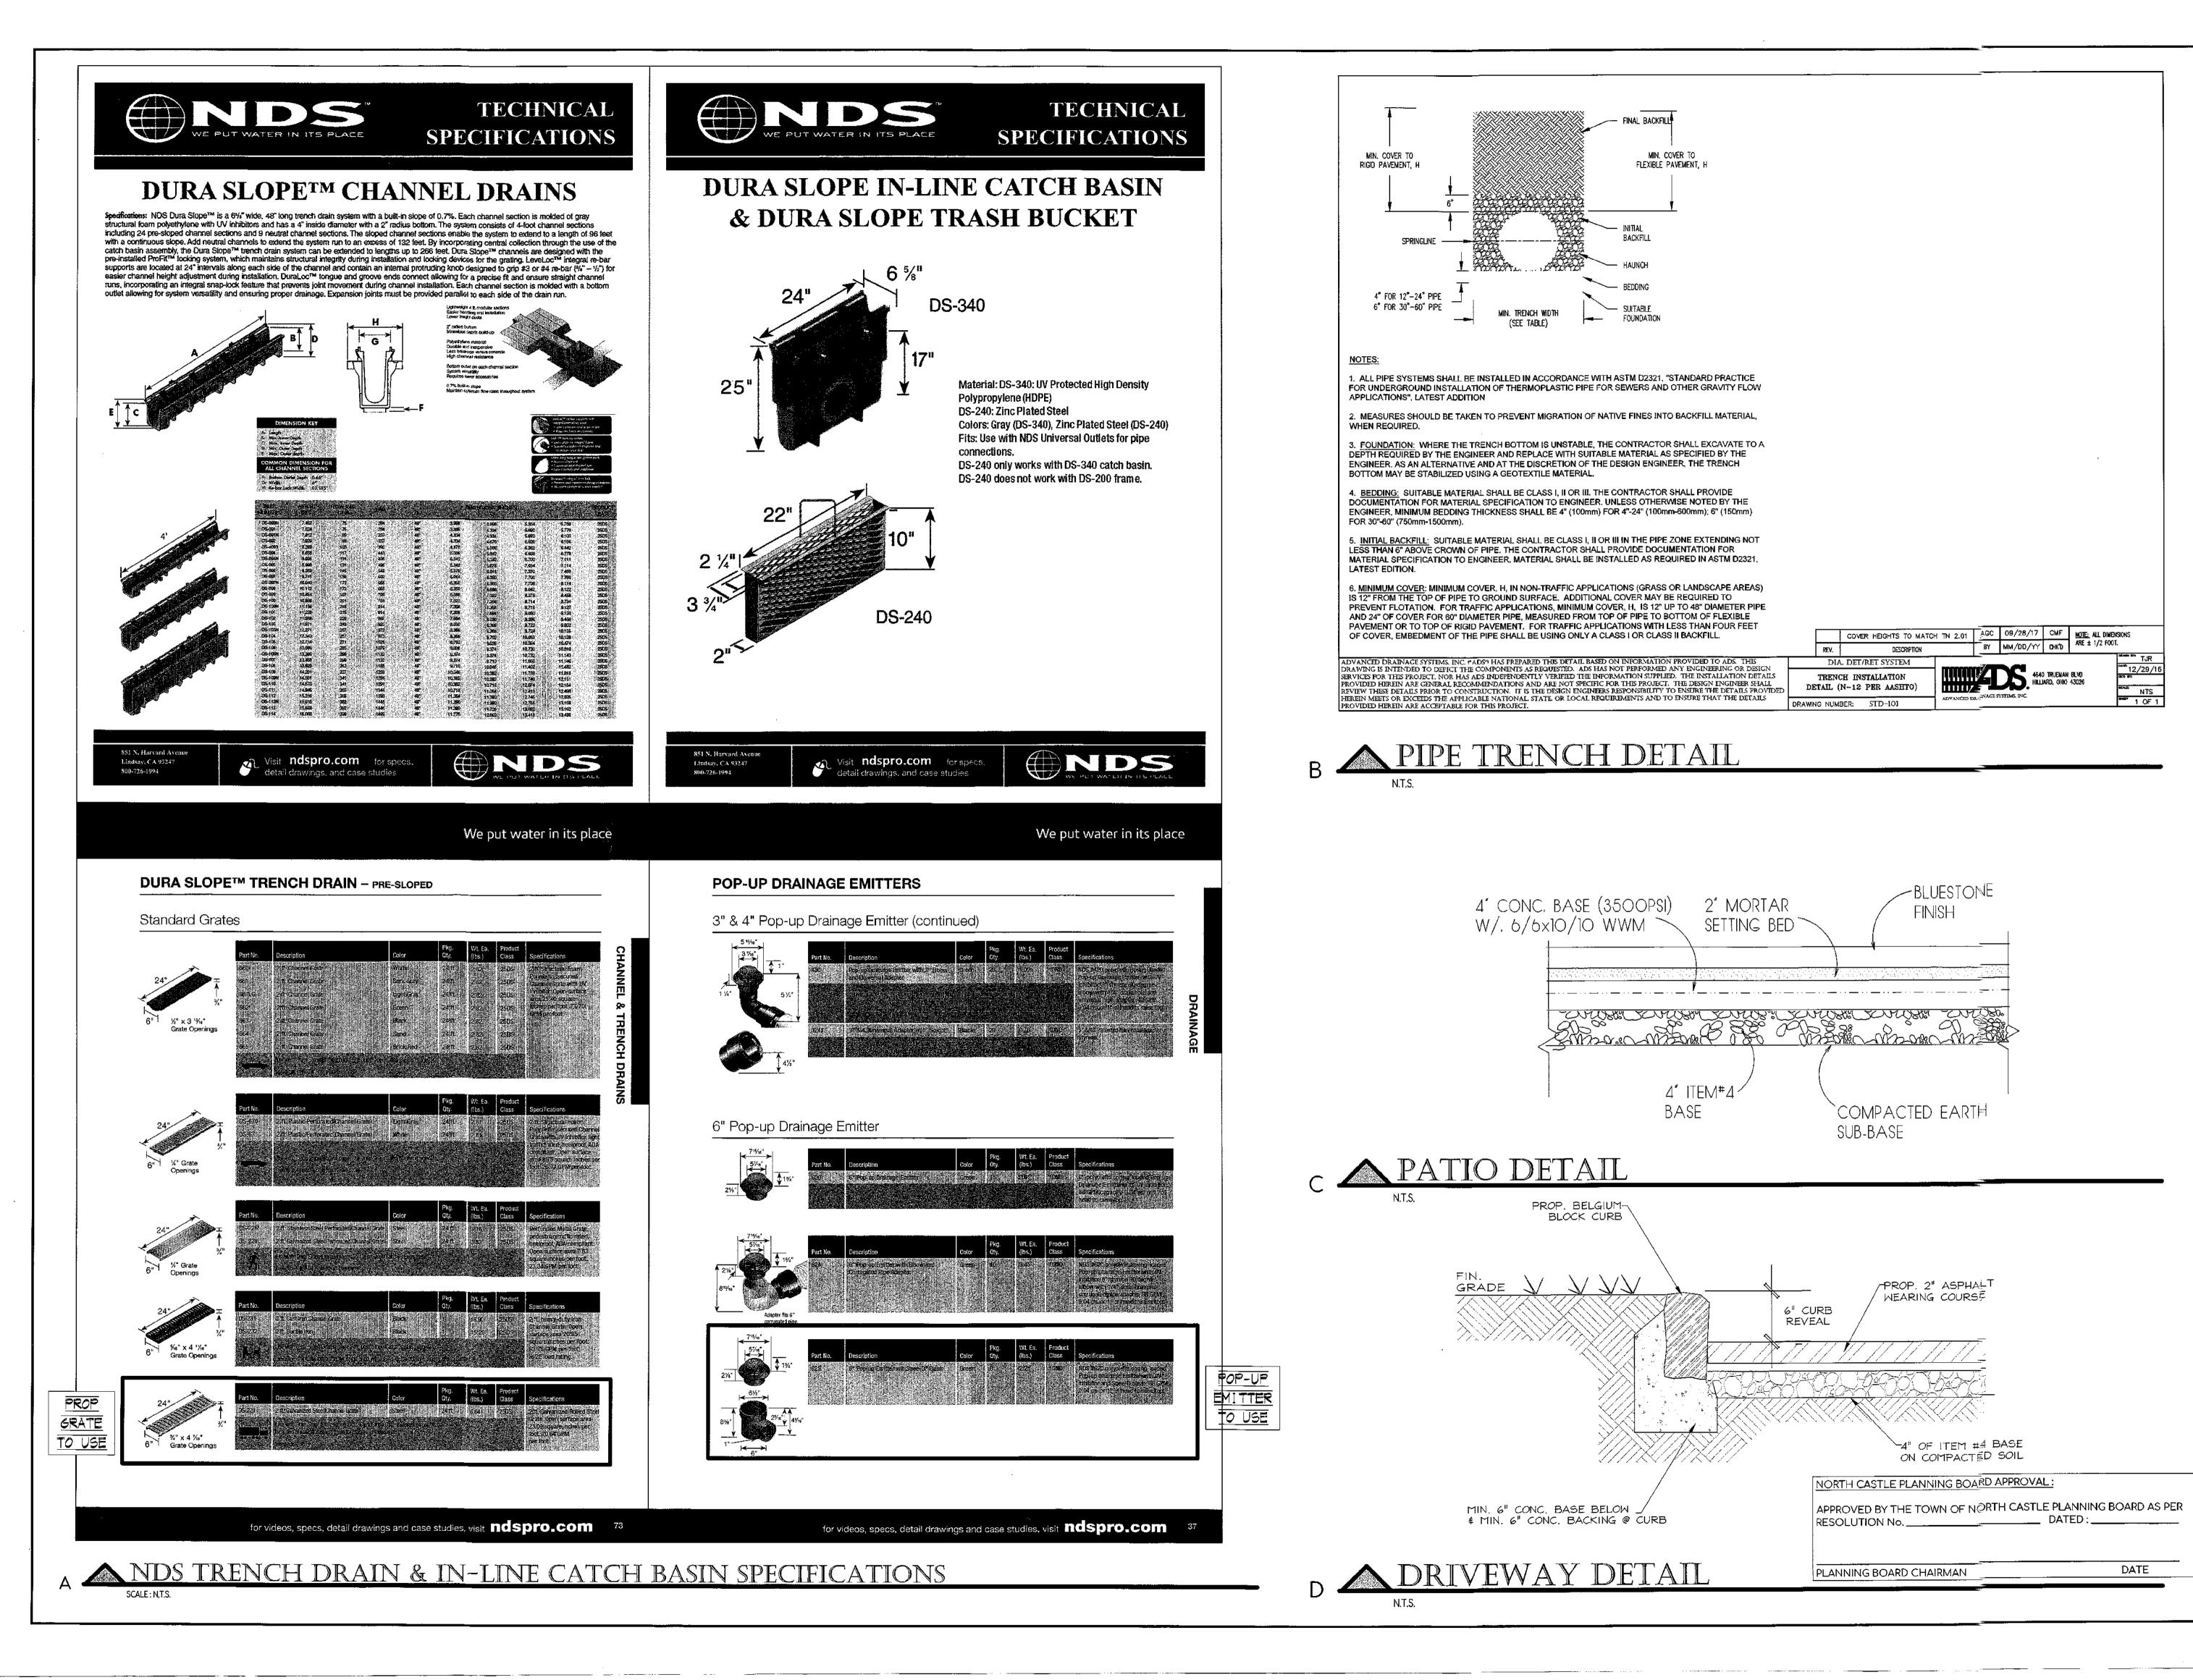

MASTROGIACOMO
ENGINEERING, P.C.
CONSULTING ENGINEERS & LAND SURVEYORS
Licensed in New York and Connecticut
0 MIDLAND AVENUE, SUITE 100, PORT CHESTER, N.Y. 1057

EMail: admin@masengpc.com

www.masengpc.com

All ideas, designs, arrangements and plans indicated or represented are bowned by and the property of this affice and were created, evolved and Jeveloped for use and in connection with this specific project. None of such deas, designs, arrangements or plans shall be used by or disclosed to any person, firm or corporation for any purpose whatsoever without written permission of Mastrogiacomo Engineering, P.C.

Written dimensions on these drawings shall have precedence over scaled dimensions. Contractors shall verify and be responsible for all dimensions and conditions on the Job and this office must be notified of any variation from these dimensions and conditions shown herean in writing.

It is a violation of Chapter 16, Title VIII, Article 145 of Section 720's Subdivision 2 of the New York State Education Law for any person, unless acting under the direction of a Licensed Professional Engineer, to add a atter any item on this drawing and/or related specification. The Professional Engineer/Surveyor whose seal appears hereon assumes in responsibility for any such alteration or re-use without his consent.

Professional Engineer/Surveyor whose seal appears hereon assumes responsibility for any such attention or re-use without his consent.

Revisions

3/24/24 REVISIONS MPER COMMENTS 1/8/24

Drawing North

ARMONK
ESTATES

LLC 21 BRASSIE ROAD EASTCHESTER, NY 10709

PROPOSED 1
FAMILY
RESIDENCE

4 ARMONK HEIGHTS RD
TOWN OF NORTH CASTLE
WESTCHESTER CO.
NEW YORK

TAX ASSESSMENT INFO:
SEC: 101,01
BLOCK: 1

 Job No.
 MISC

 Scale
 AS NOTED


 Date
 1 OCT. 2023

 Drown By
 M.M.

Drawn By
Checked By
Sheet

C201



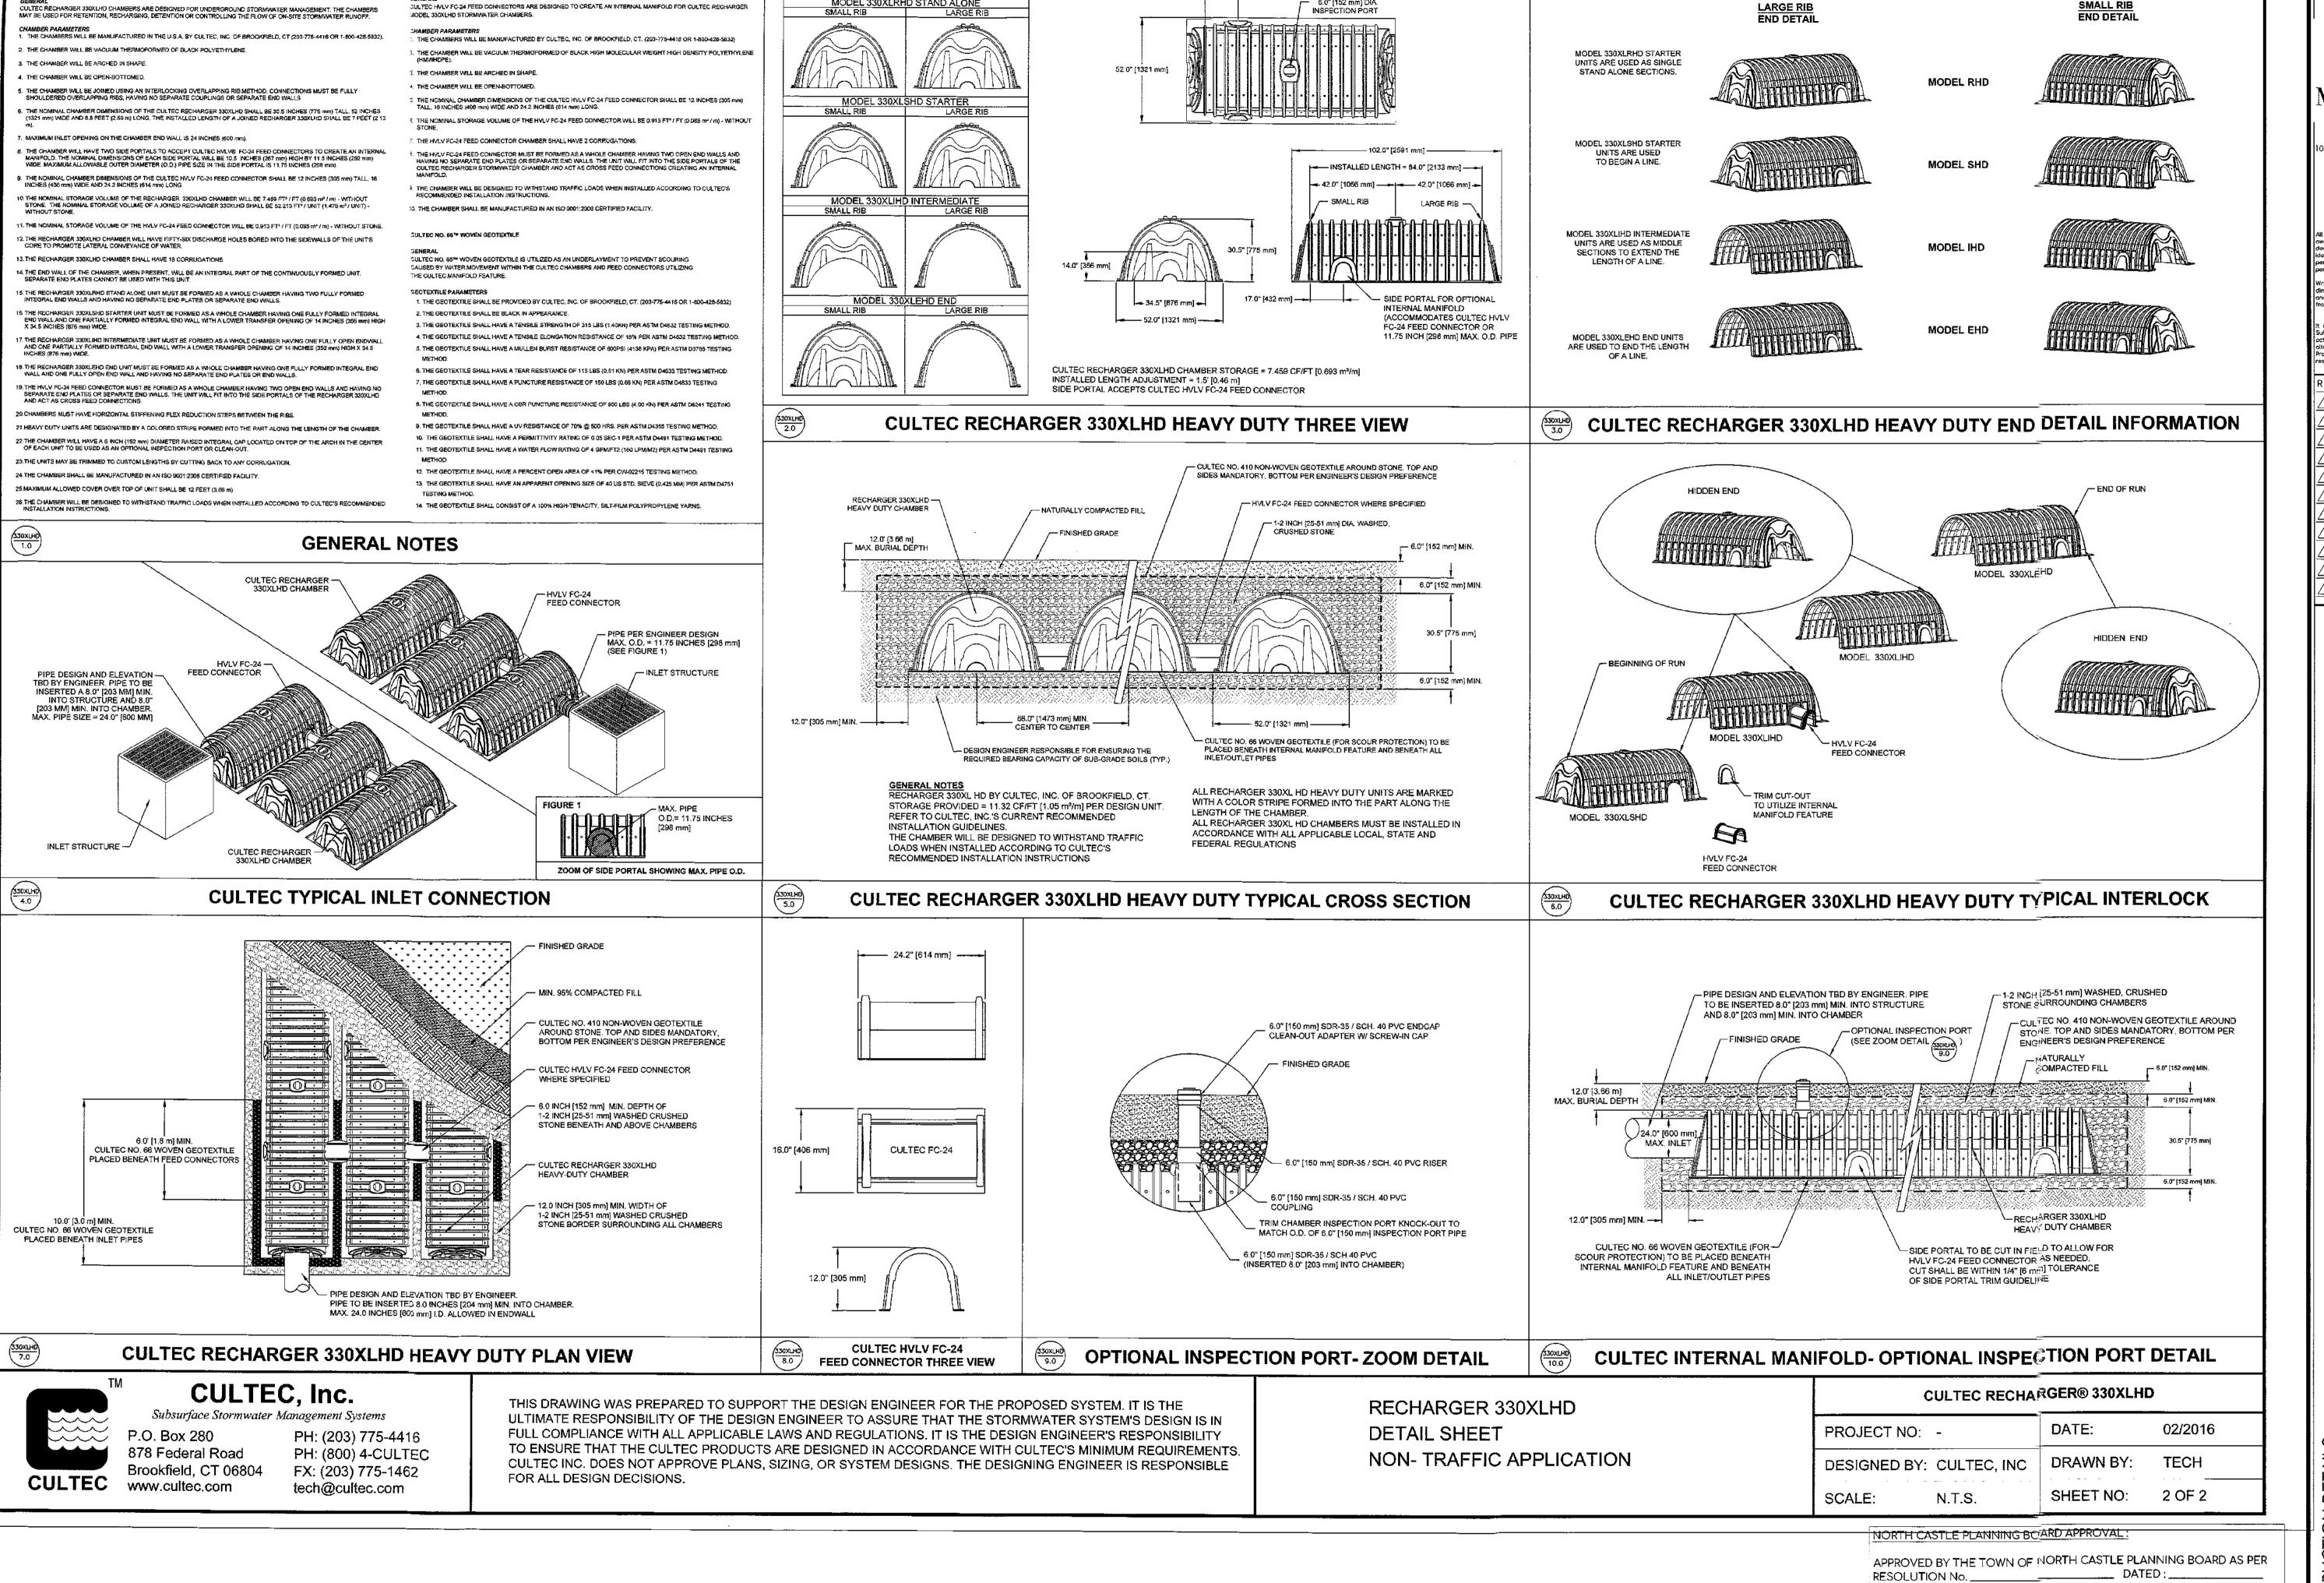

CULTEC RECHARGER® 330XLHD PRODUCT SPECIFICATIONS

BULTEC HVLV FC-24 FEED CONNECTOR PRODUCT SPECIFICATIONS

MASTROGIACOMO
ENGINEERING, P.C.

CONSULTING ENGINEERS & LAND SURVEYORS
Licensed in New York and Connecticut
10 MIDLAND AVENUE, SUITE 100, PORT CHESTER, N.Y. 1057;

All ideas, designs, arrangements and plans indicated or represented are awned by and the property of this office and were created, evolved and developed for use and in connection with this specific project. None of such ideas, designs, arrangements or plans shall be used by or disclosed to any person, firm or corporation for any purpose whatsoever without written permission of Mastragiacoma Engineering, P.C.
Written dimensions on these drawings shall have precedence over scaled dimensions. Contractors shall write and he recognished for all dimensions.

Tel:: 914-920-6372

EMail: admin@masengpc.com

www.masengpc.com

Written dimensions on these drowings shall have precedence over scalidimensions. Contractors shall verify and be responsible for all dimension and conditions on the job and this office must be notified of any variation these dimensions and conditions shown hereon in writing.

It is a violation of Chapter 16, Title VIII, Article 145 of Section 721 Subdivision 2 of the New York State Education Law for any person, unlet octing under the direction of a Licensed Professional Engineer, to add alter any item on this drawling and/or related specification. The Professional Engineer/Surveyor whose seal appears hereon assumes a responsibility for any such attention or re-use without his consent.

Revisions

3/24/24 REVISIONS MPER COMMENTS 1/8/24

\( \triangle \)

Drawing North

nt Name and Address

ARMONK

ESTATES

LLC
21 BRASSIE ROAD
EASTCHESTER, NY
10709

PROPOSED 1
FAMILY
RESIDENCE

Situoted At

4 ARMONK HEIGHTS RD

TOWN OF NORTH CASTLE

WESTCHESTER CO.

NEW YORK

 TAX ASSESSMENT INFO:


 SEC:
 101.01

 BLOCK:
 1

TAX LOT : 34

Job No. MISC
Scale AS NOTED
Date 1 OCT. 2023
Drawn By M.M.
Checked By M.M.
Sheet

C202

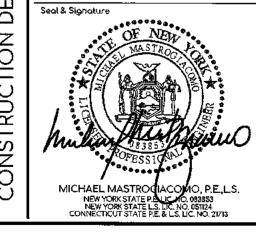

DATE

PLANNING BOARD CHAIRMAN

