

Kory Salomone ksalomone@zarin-steinmetz.com Also admitted in CT

February 26, 2024

<u>Sent Via Email</u> Christopher Carthy, Chairman North Castle Planning Board 17 Bedford Road Armonk, NY 10504

> Re: 111 Round Hill Realty LLC Application for Subdivision, Site Plan, Accessory Apartment Special Permit, and Tree Removal Permit 10 and 20 Round Hill Way (109.01-1-49.4 and 49.5)

Honorable Chair and Members of the Board:

I. INTRODUCTION

This firm, in collaboration with Lennon Architects, and Insite Engineering, Surveying & Landscape Architecture, P.C., represents 111 Round Hill Realty LLC ("Owner" or "Applicant"), owner of the property located at 10 and 20 Round Hill Way ("Property"). The Applicant is proposing to: (i) relocate the lot line between 10 Round Hill Way and 20 Round Hill Way; (ii) construct a single-family home on 10 Round Hill Way; and (iii) construct a single-family home, barn with accessory apartment and attached greenhouse, swimming pool, and tennis court on 20 Round Hill Way.

In order to achieve the foregoing, the Applicant requires subdivision approval for the lot line realignment, site plan/tree removal permit approvals for the proposed site improvements, and special permit approval for an accessory structure in excess of 800s.f. and the accessory apartment¹. The purpose of this letter is to transmit these applications and to request placement on your February 26th agenda for an initial presentation and, if your Board deems appropriate, referral to the Zoning Board of Appeals and the scheduling of the required public hearing.

II. <u>DESCRIPTION OF SITE AND ZONING</u>:

The Property is located at 10 and 20 Round Hill Way and is identified on the Tax Assessment map of the Town of North Castle as parcels 109.01-1-49.4 ("Lot 4") and 109.01-1-49.5

¹ Note that the Applicant will also require approval from the ZBA with respect to the size of the accessory structure, having an accessory apartment in an accessory structure, and relief from the required waiting period to have an accessory apartment.

("Lot 5"). The Property is located in the R-2A single family residence district and is approximately 20.7 acres². Both lots are currently vacant, unimproved land.

III. SITE HISTORY

The Property was created as part of the Rolling Hills Subdivision, which was approved by the Planning Board in 2006. The Rolling Hills Subdivision Pat was recorded with the Westchester County Clerk as Map # 27849 on December 15, 2006. It should be mentioned that note 2 on Map 27849 provides that "[f]urther subdivision of Lots 1 through 5 is to be prohibited by deed restriction." To that end, a Declaration of Covenants, Restrictions, and Easements was recorded with the Westchester County Clerk on February 28, 2007 in Control No. 470380020. The Declaration contains a "Prohibition Against Re-subdivision (Lots 3, 4, and 5)" that provides

Notwithstanding the fact that Lots 3, 4, and 5 presently or may continue in the future to each have a lot area of more than twice the minimum lot size permitted in the zoning district in which said Lots are located, Lots 3, 4, and 5 shall not be further subdivided or resubdivided so as to create any new building lots. *The foregoing shall not preclude a lot line adjustment or change or a subdivision or resubdivision the object of which is not to create a new building lot.* (emphasis added)

Accordingly, while there is a deed restriction which prohibits further subdivision or resubdivison, the Applicant's proposal to realign the lot lines between Lot 4 and Lot 5 is clearly permitted so long as no new building lot is created.

In addition to the declaration discussed above, approximately 9.6 acres of the Property are burdened by a Conservation Easement. As shown on the enclosed plans, no work is being proposed in the Conservation Easement area.

IV. CURRENT PROPOSAL

As noted above, the Applicant is proposing to (i) relocate the lot line between Lot 4 and Lot 5; (ii) construct a single-family home on Lot 4; and (iii) construct a single-family home, barn with accessory apartment and greenhouse, swimming pool, and tennis court on Lot 5.

Lot Line Realignment: Currently, Lot 4 is 10.011 acres and Lot 5 is 10.673 acres. The Applicant is proposing to relocate the lot lines so that Lot 4 will end up being approximately 4.7 acres and Lot 5 will be approximately 16.0 acres. As shown on the Zoning Conformance Table enclosed herewith, both lots will remain fully compliant with the R-2A zoning district standards.

Lot 4 Development: The Owner is proposing an approximately 7,169 s.f., 5-bedroom home, swimming pool, and associated site improvements. Access to Lot 4 will be provided via a shared driveway with Lot 5 directly from Round Hill Road.

² Currently, Lot 4 is approximately 10.011 acres and Lot 5 is approximately 10.673 acres.

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Lot 5 Development: The Owner is proposing to develop Lot 5 with an approximately 11,277 s.f., 5-bedroom house with pool and tennis court. Additionally, a 2,779 s.f. accessory structure, which contains: (i) a 1,344 s.f. first floor barn; (ii) a 1,302 s.f., 2-bedroom accessory apartment above, a 132 s.f. covered porched, and a 216 s.f. attached greenhouse.

In support of this application, the following plans and documents are submitted herewith:

- 1. Site Development Plan Application and Checklist;
- 2. Special Use Permit Application and Checklist;
- 3. Preliminary Subdivision Approval Application and Checklist;
- 4. Gross Land Coverage Calculations Worksheet;
- 5. Gross Floor Area Calculations Worksheet;
- 6. Tree Removal Permit Application;
- 7. Site Plan Drawing Set, 12 sheets, dated February 12, 2024;
- 8. Lot 4 Residence Architectural Drawing Set, 14 Sheets;
- 9. Lot 5 Residence Architectural Drawing Set, 12 Sheets; and
- 10. Lot 5 Barn with Accessory Apartment Architectural Drawing Set, 11 Sheets.

V. CONSIDERATION FOR SPECIAL PERMIT APPROVAL

A. Necessity for Special Permit Approval: As set forth above, the Property is located in the R-2A zoning district. Pursuant to § 355-21 – Attachment 1, permitted accessory uses in the R-2A district include:

Private Barn/Greenhouse³: "Private gardenhouses, toolhouses, greenhouses, gatehouses, garages or similar private accessory uses not over 1 story and 15 feet in height and limited to 800 square feet in area, except that the Planning Board may, by special permit, authorize the construction of accessory buildings not over 2 stories or 22 feet in height, provided that any such individual accessory building does not exceed 25% of the floor area of the main building, and further provided that all such accessory buildings meet all required setbacks for main buildings in the district in which they are located and are not located within any front yard. (emphasis added)

In this case, the proposed Barn/Greenhouse will be in excess of 800 s.f. and 1 story, accordingly a special permit from your Board is required. The proposed residence on the Property is approximately 11,277s.f., therefore, the proposed approximately 2,779s.f. barn/greenhouse is roughly 24.6% of the floor area of the main building, which complies with maximum permitted by the zoning code. Additionally, the proposed barn meets all required setbacks and is not located within the front yard.

³ The Applicant is also proposing to include a 1-bedroom accessory apartment on the second floor of the barn/greenhouse, which is discussed separately in section V(A)(2) of this letter.

2. <u>Accessory Apartment</u>: "Accessory apartments, in single-family residence districts, subject to the requirements of § 355-40(K)."

Pursuant to § 355-40(K)(1),

"[i]t is the specific purpose and intent in allowing accessory apartments in singlefamily residence districts to provide opportunity and encouragement for the development of small rental housing units designed to meet the special housing needs of persons of low- and moderate-income especially the young and old, and of relatives of families living in North Castle. It is also the purpose and intent of this subsection to allow the more efficient use of the Town's existing housing stock of dwellings and accessory buildings, to provide economic support for present families of limited income and thereby promote the protection and preservation of property values. Further, it is the purpose and intent of these regulations to assure the maintenance of the single-family character and property values of neighborhoods through resident-owner occupancy of lots and dwelling where an accessor apartment might be located. To help achieve these goals and to promote other objectives of this subsection, the following specific standards are set forth for such accessory apartment uses."

Despite the fact that the Applicant will need variances from the ZBA: (i) so that the accessory apartment can be located in an accessory building and (ii) so that the accessory apartment be permitted prior to the required 4 year waiting period, it is respectfully submitted that this special permit application for an accessory apartment meets the specific purpose and intent of these regulations by utilizing a portion of the proposed accessory building as a small housing unit. The Owner does not intend to rent the accessory apartment. Instead, it's intended use to provide temporary housing for family and friends when they come to visit or to provide housing for a caretaker in the future.

B. North Castle Specific Conditions and Standards Applicable to Accessory Apartments: As provided for in § 355-40(K)(1), there are certain specific standards that must be met prior to the granting of a special permit for an accessory apartment. Those standards are contained in §355-40(K)(3)-(11) and are listed below, followed by an explanation of how each is met.

1. Occupancy. The owner of the lot on which the accessory apartment is located shall occupy either of the dwelling units on the premises. Owner occupancy of one of the dwelling units shall continue for the duration of the special permit.

Upon completion of the single-family home and issuance of a Certificate of Occupancy, the Owner will occupy the single-family residence on the Property and will continue living there for the duration of the special permit.

2. Accessory apartments are only permitted in any of the single-family residence districts. Accessory apartments may be located in a principal residence or accessory building,

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provided that such building existed prior to October 11, 1984, and conforms to the other requirements of this chapter, unless a variance therefor shall have been granted by the Zoning Board of Appeals.

In this case, the Property is located in the R-2A single-family residence district and the accessory apartment is being proposed in an accessory building. Because the accessory building that is being proposed as part of this application was not in existence prior to 1984 a variance will be required from the ZBA in order to locate an accessory apartment in the accessory building.

3. No accessory apartment shall be permitted until four years after the issuance of a certificate of occupancy for the principal dwelling, and no accessory apartment shall be permitted in a structure until at least two years after the current owner has acquired title to the property, whichever comes later.

As provided above, the Property is currently vacant land, so no certificates of occupancy have been issued. Further, the Owner took title to the Property in August of 2023. Therefore, the required two years of ownership has not yet been met.

Notwithstanding the foregoing, it is respectfully submitted that the proposed accessory apartment meets the stated intent and goals of § 355-40(K)(1) in that it will provide a small housing unit for relatives and could be used as a small rental unit in the future. Further, there is no negative impact associated with allowing the Owner to utilize an accessory apartment on the Property prior to meeting these seemingly arbitrary time limits. Accordingly, it is requested that the Planning Board refer this application to the ZBA for the required variance from these time limits.

4. There shall be no more than one accessory apartment per lot.

There will only be one accessory apartment on the Property.

5. No accessory apartment shall be permitted in any dwelling unit utilized as a boarding house previously established under the provisions of Chapter 355.

The accessory structure will be brand new and, accordingly, was never utilized as a boarding house.

6. No accessory apartment shall be permitted on any lot currently utilized as an office of a professional person or home occupation, as defined in § 355-4 and regulated in § 355-21.

The Property is not currently utilized as an office of a professional person or home occupation.

7. Any principal or accessory building in which an accessory apartment is proposed shall meet all applicable setback requirements and other standards for the district in which it is located.

Both the principal and accessory building in which the accessory apartment is proposed meet all applicable setback requirements and most other standards for the R-2A district.

8. Off-street parking for accessory apartments in residence districts shall be provided in accordance with the requirements of Article IX. Where practicable, the Planning Board shall require that off-street parking for accessory apartments be located in the side or rear yard of the lot and in no case less than 20 feet from the front property line.

Pursuant to Article IX, accessory apartments require 1 parking space per bedroom or 2 per dwelling unit. In this case two parking spaces are provided. The parking for the accessory apartment is located in the side yard and is not less than 20 feet from the property line.

9. If an accessory apartment is located in a principal dwelling, the entry to the unit and its design shall be such that the appearance of the dwelling shall remain as a single-family residence.

In this case, the accessory apartment is not located in the principal dwelling unit.

10. The minimum size of an accessory apartment within a principal dwelling shall be 300 square feet. Where the gross floor area of the dwelling is less than or equal to 2,000 square feet, the accessory apartment shall in no case exceed 33% of such area. Where the gross floor area of the dwelling is greater than 2,000 square feet, the permitted maximum size of the accessory apartment may be increased by 25% of the gross floor area in excess of 2,000 square feet. In cases of accessory apartments established prior to October 11, 1984, upon recommendation of the Building Inspector, the Planning Board may, at its option, increase these percentages to no more than 35% and 27%, respectively. The minimum size of an accessory apartment located in an accessory building shall be at least 300 gross square feet. There shall be no more than two bedrooms per accessory apartment. (Emphasis added)

In this case, the accessory apartment is located in an accessory building and is approximately 1,300 square feet, thereby meeting and exceeding the minimum required size of 300 square feet. Additionally, there is only 1 bedroom in the accessory apartment.

C. North Castle General Conditions and Standards: Article VII of the Zoning Code of the Town of North Castle establishes the general procedures for Planning Board review of an application for special use permits. Specifically, § 355-37 requires that before granting a special use permit, six "conditions and standards" must be met. Additionally, § 355-38 permits the Planning Board to "attach such conditions and safeguards to any proposed use

and development plan as are, in [the Board's] opinion, necessary to ensure initial and continual conformance to all applicable standards and requirements." The six "conditions and standards" are set forth below, followed by an explanation of how each standard is met.

1. The location and size of the use, the nature and intensity of the operations involved in it or conducted in connection with it, the size of the site in relation to it and the location of the site with respect to the streets giving access to it are such that it will be in harmony with the appropriate and orderly development of the district in which it is located and that it complies with all special requirements for such uses established in [Chapter 355 of the North Castle Zoning Code].

The accessory structure, including the accessory apartment, that is proposed in connection with the single-family home will be located on the northern portion of the Property. The building will be fully compliant with all required setbacks. Additionally, the proposed location for the accessory building is located at an elevation of 234.5 and is approximately 200 feet from the nearest single-family home. The 20 foot +/- existing hill separating the structures, existing mature trees between the accessory structure and neighboring properties and the proposed additional plantings provides appropriate screening. Moreover, the addition of an approximately 2,779s.f. barn/greenhouse with accessory apartment on a property that is over 15 acres, with the vast majority of the site being maintained in its present wooded state precisely how the Property was anticipated to be developed and will be in harmony with the appropriate and orderly development of the R-2A district.

2. The location, nature and height of buildings, walls, fences and the nature and extent of existing or proposed plantings on the site are such that the use will not hinder or discourage the appropriate development and use of adjacent land and buildings.

The Property is approximately 15 acres and heavily wooded. The location of the accessory structure with accessory apartment, coupled with the existing trees, topography, and proposed plantings, will provide adequate screening from adjoining properties. It is respectfully submitted that the location, nature and height of the existing structures will not hinder or discourage the appropriate development and use of adjacent land and buildings. The properties located to the north, east, and west are already improved with single-family homes. Further, the property to the south (Lot 4) is owned by the Applicant and is similarly proposed to be developed with a single-family home.

3. Operations in connection with any special use will not be more objectionable to nearby properties by reason of noise, fumes, vibration or other characteristics than would be the operations of any permitted uses not requiring a special permit.

The accessory building and apartment will not be more objectionable to nearby properties by reason of noise, fumes, vibration or other characteristics than would the operations of any permitted uses not requiring a special permit.

4. Parking areas will be of adequate size for the particular use, properly located and suitably screened from adjoining residential uses, and the entrance and exit drives shall be laid out so as to achieve maximum convenience and safety.

The parking area proposed for the accessory building and apartment is of adequate size, is properly located, and is suitably screened from adjoining residential uses. Further, the entrance and exit drive is convenient and safe.

5. Where required, the provisions of Chapter 177 [of the North Castle Code], Flood Damage Prevention.

The Town Flood Hazard Ordinance is not applicable to the Applicant's proposal, as no changes are proposed to the site.

6. *The* [*Planning*] *Board finds that the proposed special permit use will not have a significant adverse effect on the environment.*

It is respectfully submitted that the approval of an accessory apartment located in an accessory structure will not have an adverse effect on the environment.

VI. CONCLUSION

Enclosed herewith please find the subdivision, site plan, and special permit application forms and Short Environmental Assessment Form respectively, together with the application fee of \$1,025.00.

Kindly place this matter on the Planning Board's Marh 11, 2024 agenda for an initial presentation and, if your Board deems appropriate, referral to the ZBA for the required variances and the scheduling of the required public hearing.

Please don't hesitate to contact me if you have questions.

Very truly yours,

Kory Salomone



TOWN OF NORTH CASTLE

WESTCHESTER COUNTY 17 Bedford Road Armonk, New York 10504-1898

PLANNING DEPARTMENT Adam R. Kaufman, AICP Director of Planning

Telephone: (914) 273-3542 Fax: (914) 273-3554 www.northcastleny.com

Application for Site Development Plan Approval

Application Name

10 & 20 Round Hill Way Site Plan



TOWN OF NORTH CASTLE

WESTCHESTER COUNTY 17 Bedford Road Armonk, New York 10504-1898

PLANNING DEPARTMENT Adam R. Kaufman, AICP Director of Planning

Telephone: (914) 273-3542 Fax: (914) 273-3554 www.northcastleny.com

PLANNING BOARD SCHEDULE OF ESCROW ACCOUNT DEPOSITS

Type of Application Deposit*	Amount of Initial Escrow Account				
Concept Study	\$500.00				
Site Plan Waiver for Change of Use	\$500.00				
Site Development Plan for:					
Multifamily Developments	\$3,000.00 plus \$100.00 per proposed dwelling unit				
Commercial Developments	\$3,000.00 plus \$50.00 for each required parking space				
1 or 2 Family Projects	\$2,000.00				
Special Use Permit	\$2,000.00 plus \$50.00 for each required parking space				
Subdivision:	required parking space				
Lot Line Change resulting in no new lots	\$1,500.00				
All Others	\$3,000.00 plus \$200.00 per proposed new lot in excess of two (2)				
Preparation or Review of Environmental Impact Statement	\$15,000.00				

* If a proposed action involves multiple approvals, a single escrow account will be established. The total amount of the initial deposit shall be the sum of the individual amounts indicated. When the balance in such escrow account is reduced to one-third (1/3) of its initial amount, the applicant shall deposit additional funds into such account to restore its balance to the amount of the initial deposit.

an (Feb 26, 2024 10:33 EST)

Applicant Signature

Date:

I. IDENTIFICATION OF PROPERTY OWNER, APPLICANT AND PROFESSIONAL REPRESENTATIVES

Mailing Address: 1325 Harbor Road, Hewlett, NY 11557 Telephone: 212-463-0900 Fax: e-mail blueeyes0401@aol.com Name of Applicant (if different):	Name of Property Owner: 111 Round H	ill Realty LLC	
Name of Applicant (if different): Address of Applicant: Telephone: Fax: e-mail Interest of Applicant, if other than Property Owner: Interest of Applicant, if other than Property Owner: Is the Applicant (if different from the property owner) a Contract Vendee? Yes Yes No If yes, please submit affidavit sating such. If no, application cannot be reviewed by Planning Board Name of Professional Preparing Site Plan: Richard D. Williams, Jr. P.E. (Insite Engineering) Address: Telephone: Fax: e-mail RWilliams@insite-eng.com	Mailing Address: <u>1325 Harbor</u>	Road, Hewlett, NY 11557	
Address of Applicant: Telephone: Fax: e-mail Interest of Applicant, if other than Property Owner: Is the Applicant (if different from the property owner) a Contract Vendee? Yes Yes No If yes, please submit affidavit sating such. If no, application cannot be reviewed by Planning Board Name of Professional Preparing Site Plan: Richard D. Williams, Jr. P.E. (Insite Engineering) Address: Telephone: Fax: e-mail RWilliams@insite-eng.com	Telephone: <u>212-463-0900</u> Fax:	e-ma	il blueeyes0401@aol.com
Telephone:	Name of Applicant (if different):		
Interest of Applicant, if other than Property Owner: Interest of Applicant, if other than Property Owner: Is the Applicant (if different from the property owner) a Contract Vendee? Yes Yes No If yes, please submit affidavit sating such. If no, application cannot be reviewed by Planning Board Name of Professional Preparing Site Plan: Richard D. Williams, Jr. P.E. (Insite Engineering) Address: Telephone: Fax: e-mail RWilliams@insite-eng.co	Address of Applicant:		
Is the Applicant (if different from the property owner) a Contract Vendee? Yes No If yes, please submit affidavit sating such. If no, application cannot be reviewed by Planning Board Name of Professional Preparing Site Plan: Richard D. Williams, Jr. P.E. (Insite Engineering) Address:	Telephone: Fax	e-mail	
Yes No If yes, please submit affidavit sating such. If no, application cannot be reviewed by Planning Board Name of Professional Preparing Site Plan: Richard D. Williams, Jr. P.E. (Insite Engineering) Address:	••	-	
If yes, please submit affidavit sating such. If no, application cannot be reviewed by Planning Board Name of Professional Preparing Site Plan: Richard D. Williams, Jr. P.E. (Insite Engineering) Address:	Is the Applicant (if different from the pro	perty owner) a Contract Vendee?	
Name of Professional Preparing Site Plan: Richard D. Williams, Jr. P.E. (Insite Engineering)			
Address:	If yes, please submit affidavit sating such	. If no, application cannot be reviewed b	y Planning Board
Telephone:	Name of Professional Preparing Site Plar	: Richard D. Williams, Jr. P.E. (Insit	e Engineering)
	Address:		
	Telephone:	Fax: e-	mail <u>RWilliams@insite-eng.com</u>
Name of Other Professional:	Name of Other Professional:		
Address:	Address:		
Telephone: Fax: e-mail	Telephone:	Fax:	e-mail
Name of Attorney (if any): Kory Salomone, Esq., Zarin & Steinmetz LLP	Name of Attorney (if any): Kory Salom	one, Esq., Zarin & Steinmetz LLP	
Address: 81 Main Street, Suite 415, White Plains, NY 10601	Address: 81 Main Str	<u>eet, Suite 415, White Plains, NY 10601</u>	-
Telephone: 914-220-9804 Fax: e-mail ksalomone@zarin-steinm	Telephone: 914-220-9804	Fax:	e-mail ksalomone@zarin-steinmetz.co

Applicant Acknowledgement

By making this application, the undersigned Applicant agrees to permit Town officials and their designated representatives to conduct on-site inspections in connection with the review of this application.

The Applicant also agrees to pay all expenses for the cost of professional review services required for this application.

It is further acknowledged by the Applicant that all bills for the professional review services shall be mailed to the Applicant, unless the Town is notified in writing by the Applicant at the time of initial submission of the application that such mailings should be sent to a designated representative instead.

Signature of Applicant: jill hoberman	Date:	
Signature of Property Owner:	jill hoberman jill hoberman (Feb 26, 2024 10:33 EST)	Date:

MUST HAVE BOTH SIGNATURES

P

II. IDENTIFICATION OF SUBJECT PROPERTY

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Street Address: 10 & 20 Round Hill Way				
Location (in relation to nearest intersecting street	t):			
feet (north, south, east or west) of		_		
Abutting Street(s):				
Tax Map Designation (NEW): Section 109.01	Block		Lot	49.4 & 49.5
Tax Map Designation (OLD): Section	Block	09	Lot	137 & 138
Zoning District: <u>R2A</u> Total Land A	rea <u>20.7 acres</u>			
Land Area in North Castle Only (if different)				
Fire District(s) #3 School Distri	ct(s) <u>Byram Hills</u>			
Is any portion of subject property abutting or loc	ated within five hun	dred (50	0) feet of the	following:
No _X _ Yes (adjacent) Yes (with If yes, please identify name(s): The boundary of any existing or proposed No _X _ Yes (adjacent) Yes (with The right-of-way of any existing or proposed rightway? No _X _ Yes (adjacent) Yes (with The existing or proposed right-of-way of for which the County has established cha No _X _ Yes (adjacent) Yes (with The existing or proposed right-of-way of for which the County has established cha No _X _ Yes (adjacent) Yes (with The existing or proposed right-of-way of for which the County has established cha No _X _ Yes (adjacent) Yes (with The exist of the county has established cha No _X _ Yes (adjacent) Yes (with The exist of the county has established cha No _X _ Yes (adjacent) Yes (with The exist of the county has established cha No _X _ Yes (adjacent) Yes (with The exist of the county has established cha No _X _ Yes (adjacent) Yes (with The exist of the county has established cha No _X _ Yes (adjacent) Yes (with The exist of the county has established cha No _X _ Yes (adjacent) Yes (with The exist of the county has established cha No _ X _ Yes (adjacent) Yes (with The exist of the county has established cha No _ X _ Yes (adjacent) Yes (with The exist of the county has established cha No _ X _ Yes (adjacent)	d County or State pa in 500 feet) osed County or State in 500 feet) any stream or draina nnel lines?	rk or any e parkwa - age chan	y, thruway, ex	xpressway, road
The existing or proposed boundary of any or institution is situated? No X Yes (adjacent) Yes (w	y county or State ow	ned land	l on which a p	ublic building
The boundary of a farm operation located No <u>x</u> Yes (adjacent) Yes (
Does the Property Owner or Applicant have an in No <u>x</u> Yes	nterest in any abuttir	ıg prope	rty?	

If yes, please identify the tax map designation of that property:

III. DESCRIPTION OF PROPOSED DEVELOPMENT

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		isting	S.F.	Proposed		S.F.	
Proposed Flo	or Area Brea	akdown:					
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Indus	trial)	_S.F.; Inst	itutional	0	S.F.;	
Othe	Nonresiden	tial <u>0</u>	S.F.; Res	idential ^{21,2}	225+-	S.F.;	
		ing Units:					
Number of F	arking Space	es: Existing	<u>0</u> Re	quired	6	Proposed _	6
Number of I	oading Spac	es: Existing _	0 Re	auired	0	Proposed	0
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(If ye Code	s, application may also be	n for a Develo	opment Pern	nit pursuant	to Chapte	er 177 of th	ne North Castle To
(If ye Code Trees No _ (If ye	s, application may also be with a diam	n for a Develo required) eter at breast <u>X</u> n for a Tree R	opment Pern height (DBI	nit pursuant H) of 8" or g	to Chapte reater?		he North Castle To he North Castle To
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Final Audit Report

2024-02-26

Created:	2024-02-12
By:	Tracy Russo (trusso@zarin-steinmetz.com)
Status:	Signed
Transaction ID:	CBJCHBCAABAAuWNqAHtSHfS9dlHrDn0yWpGdTtuExaZw

"site_devel_2022" History

- Document created by Tracy Russo (trusso@zarin-steinmetz.com) 2024-02-12 - 12:41:49 PM GMT- IP address: 69.126.206.207
- Document emailed to blueeyes0401@aol.com for signature 2024-02-12 - 12:42:16 PM GMT
- Email viewed by blueeyes0401@aol.com 2024-02-26 - 3:19:33 PM GMT- IP address: 209.73.183.24
- Signer blueeyes0401@aol.com entered name at signing as jill hoberman 2024-02-26 - 3:33:22 PM GMT- IP address: 108.46.209.150
- Document e-signed by jill hoberman (blueeyes0401@aol.com) Signature Date: 2024-02-26 - 3:33:24 PM GMT - Time Source: server- IP address: 108.46.209.150
- Agreement completed. 2024-02-26 - 3:33:24 PM GMT

Short Environmental Assessment Form Part 1 - Project Information

Instructions for Completing

Part 1 – Project Information. The applicant or project sponsor is responsible for the completion of Part 1. Responses become part of the application for approval or funding, are subject to public review, and may be subject to further verification. Complete Part 1 based on information currently available. If additional research or investigation would be needed to fully respond to any item, please answer as thoroughly as possible based on current information.

Complete all items in Part 1. You may also provide any additional information which you believe will be needed by or useful to the lead agency; attach additional pages as necessary to supplement any item.


Part 1 – Project and Sponsor Information			
			<u>_</u>
Name of Action or Project:			
10 and 20 Round Hill Way Development			
Project Location (describe, and attach a location map):			
10 and 20 Round Hill Way			
Brief Description of Proposed Action:			
The Applicant is proposing to relocate the common tot line between 10 Round Hill Wa in the creation of an additional lot. Both existing lots will remain zoning compliant. In Round Hill Way with a single-family home, barn with accessory apartment and associ single-family home. Finally, in order to have an accessory apartment over the barn, th	 addition, the Applicant is seeking site iated improvements. 20 Round Hill W 	e plan approval to /ay will be improve	develop 10
Name of Applicant or Sponsor:	Telephone: 212-463-0900	0	
111 Round Hill Realty LLC (C/O Robert Hoberman)	E-Mail: robert@hoberma	nlesser.com	
Address:			
1325 Harbor Rd			
City/PO:	State:	Zip Code:	
Hewlett	NY	11557	T
 Does the proposed action only involve the legislative adoption of a pla administrative rule, or regulation? 	an, local law, ordinance,	NO	YES
If Yes, attach a narrative description of the intent of the proposed action an may be affected in the municipality and proceed to Part 2. If no, continue	nd the environmental resources th to question 2.	iat 🖌	
2. Does the proposed action require a permit, approval or funding from a		NO	YES
If Yes, list agency(s) name and permit or approval: Area Variance, ZBA; West SPDES GP 0-20-001 cove		DEC	
 a. Total acreage of the site of the proposed action? b. Total acreage to be physically disturbed? c. Total acreage (project site and any contiguous properties) owned or controlled by the applicant or project sponsor? 	20.7 acres 5.9 acres 20.7 acres		
4. Check all land uses that occur on, are adjoining or near the proposed ac	stion:		
5. 🔲 Urban 🔲 Rural (non-agriculture) 🗌 Industrial 🗍 Com	nmercial 🔽 Residential (subur	ban)	
Forest Agriculture Aquatic Othe	er(Specify):		
Parkland			

	<u></u>				
If Y	es, identify the we	etland or waterbody and extent of alterations in square feet or acres:			
	- .	posed action physically alter, or encroach into, any existing wetland or waterbody?		\checkmark	
13.	wetlands or other	tion of the site of the proposed action, or lands adjoining the proposed action, contain waterbodies regulated by a federal, state or local agency?		NO	YES
arcl	b. Is the project states of	site, or any portion of it, located in or adjacent to an area designated as sensitive for n the NY State Historic Preservation Office (SHPO) archaeological site inventory?			\checkmark
Cor		National or State Register of Historic Places, or that has been determined by the NYS Office of Parks, Recreation and Historic Preservation to be eligible for listing on the oric Places?		\checkmark	
		ct site contain, or is it substantially contiguous to, a building, archaeological site, or district		NO	YES
New		be method for providing wastewater treatment:		\checkmark	
11.		d action connect to existing wastewater utilities?	ŀ	NO	YES
	wells are proposed I	for both properties.			
10.		scribe method for providing potable water:			
	Will the	d action connect to an existing public/private water supply?		NO	YES
ш tl	e proposed action	a will exceed requirements, describe design features and technologies:			\square
9.		ed action meet or exceed the state energy code requirements?		NO	YES
	action?	lestrian accommodations or bicycle routes available on or near the site of the proposed		\checkmark	
	b. Are public t	ransportation services available at or near the site of the proposed action?	ł		
8.	a. Will the prop	posed action result in a substantial increase in traffic above present levels?		NO	YES
If Y	es, identify:				
	Nam	proposed action located in, or does it adjoin, a state listed Critical Environmental Area? e:Mianus River, Reason:Exceptional or unique character, Agency:Westchester County, Date:1-31-90		NO	YES
		ection consistent with the predominant character of the existing built or natural landscape?			\checkmark
				NO	YES
	-	vith the adopted comprehensive plan?			
5.	Is the proposed a a. A permitted	use under the zoning regulations?			
			NO I	YES	N/A


14. Identify the typical habitat types that occur on, or are likely to be found on the project site. Check all that apply:		
Shoreline 🖌 Forest 🗌 Agricultural/grasslands 🔲 Early mid-successional		
🗹 Wetland 🔲 Urban 🗹 Suburban		
15. Does the site of the proposed action contain any species of animal, or associated habitats, listed by the State or	NO	YES
Federal government as threatened or endangered?	\checkmark	
16. Is the project site located in the 100-year flood plan?	NO	YES
		\checkmark
17. Will the proposed action create storm water discharge, either from point or non-point sources?	NO	YES
If Yes,	\mathbf{V}	
a. Will storm water discharges flow to adjacent properties?	\checkmark	
b. Will storm water discharges be directed to established conveyance systems (runoff and storm drains)?	$\mathbf{\nabla}$	
If Yes, briefly describe:		
18. Does the proposed action include construction or other activities that would result in the impoundment of water	NO	YES
or other liquids (e.g., retention pond, waste lagoon, dam)? If Yes, explain the purpose and size of the impoundment:		
We are proposing underground infiltration as a stormwater management practice.		
19. Has the site of the proposed action or an adjoining property been the location of an active or closed solid waste management facility?	NO	YES
If Yes, describe:	\checkmark	
20.Has the site of the proposed action or an adjoining property been the subject of remediation (ongoing or completed) for hazardous waste?	NO	YES
If Yes, describe:	\checkmark	
I CERTIFY THAT THE INFORMATION PROVIDED ABOVE IS TRUE AND ACCURATE TO THE BE MY KNOWLEDGE	ST OF	
Applicant/sponsor/name: Kong Saloman Date: 2/26/	2y	
Signature:		

\$


EAF Mapper Summary Report

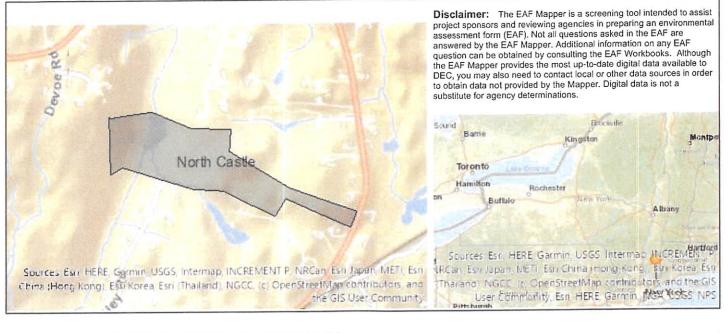

Part 1 / Question 7 [Critical Environmental Area]	Yes
Part 1 / Question 7 [Critical Environmental Area - Identify]	Name:Mianus River, Reason:Exceptional or unique character, Agency:Westchester County, Date:1-31-90
Part 1 / Question 12a [National or State Register of Historic Places or State Eligible Sites]	No
Part 1 / Question 12b [Archeological Sites]	Yes
Part 1 / Question 13a [Wetlands or Other Regulated Waterbodies]	Yes - Digital mapping information on local and federal wetlands and waterbodies is known to be incomplete. Refer to EAF Workbook.
Part 1 / Question 15 [Threatened or Endangered Animal]	No
Part 1 / Question 16 [100 Year Flood Plain]	Yes
Part 1 / Question 20 [Remediation Site]	No

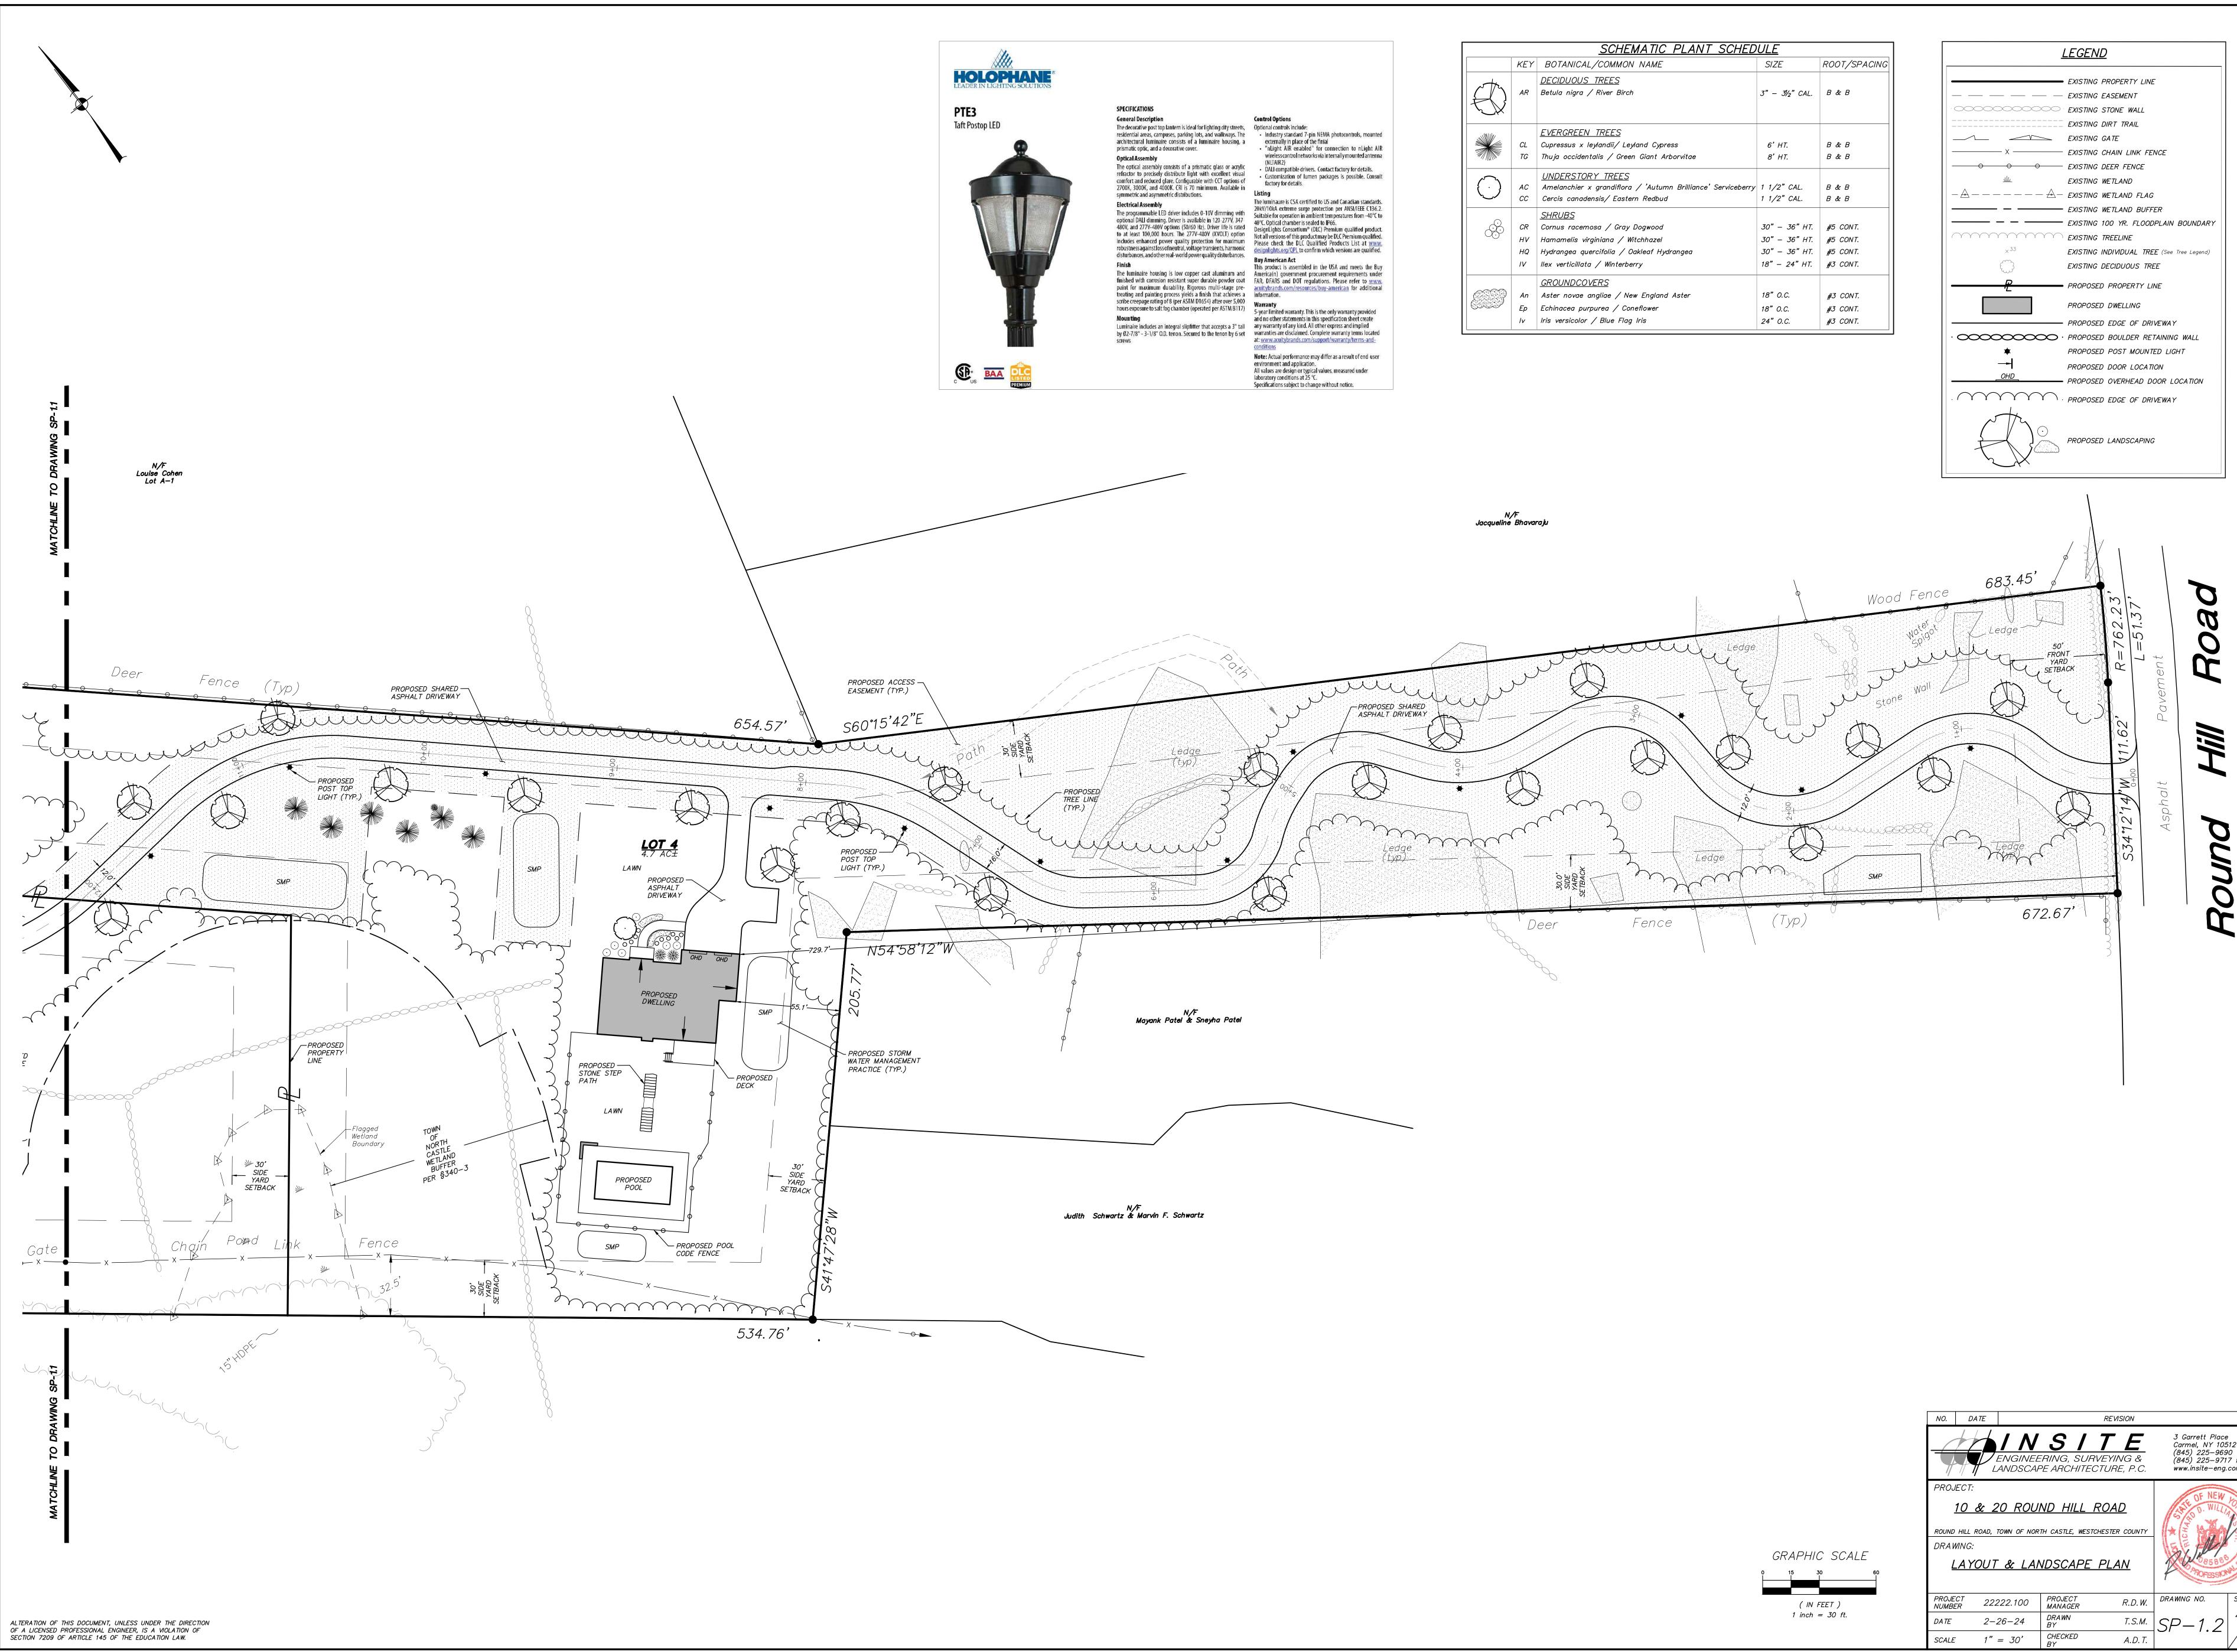

	KEY	BOTANICAL/COMMON NAME	SIZE	ROOT/SPACING
\bigcirc	AR	<u>DECIDUOUS_TREES</u> Betula nigra / River Birch	3" − 3½" CAL.	B & B
	CL TG	<u>EVERGREEN_TREES</u> Cupressus x leylandii/ Leyland Cypress Thuja occidentalis / Green Giant Arborvitae	6' HT. 8' HT.	B & B B & B
\bigcirc	AC CC	<u>UNDERSTORY TREES</u> Amelanchier x grandiflora / 'Autumn Brilliance' Serviceberry Cercis canadensis/ Eastern Redbud	1 1/2" CAL. 1 1/2" CAL.	8 & 8 8 & 8
	CR HV HQ IV	<u>SHRUBS</u> Cornus racemosa / Gray Dogwood Hamamelis virginiana / Witchhazel Hydrangea quercifolia / Oakleaf Hydrangea Ilex verticillata / Winterberry	30" – 36" HT. 30" – 36" HT. 30" – 36" HT. 18" – 24" HT.	#5 CONT.
	An Ep Iv	<u>GROUNDCOVERS</u> Aster novae angliae / New England Aster Echinacea purpurea / Coneflower Iris versicolor / Blue Flag Iris	18" O.C. 18" O.C. 24" O.C.	#3 CONT. #3 CONT. #3 CONT.

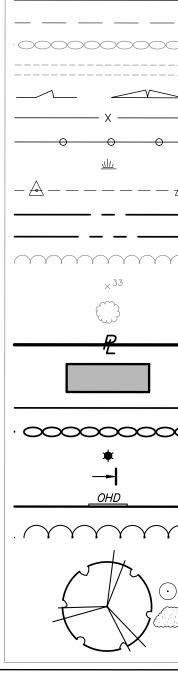



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	EXISTING WETLAND BUFFER
	EXISTING 100 YR. FLOODPLAIN BOUNDARY
\sim	EXISTING TREELINE
	EXISTING INDIVIDUAL TREE (See Tree Legend)
	EXISTING DECIDUOUS TREE
	PROPOSED PROPERTY LINE
	PROPOSED DWELLING
	PROPOSED EDGE OF DRIVEWAY
Σ.	PROPOSED BOULDER RETAINING WALL
	PROPOSED POST MOUNTED LIGHT
	PROPOSED DOOR LOCATION
	PROPOSED OVERHEAD DOOR LOCATION
<u> </u>	PROPOSED EDGE OF DRIVEWAY
)	PROPOSED LANDSCAPING

	REVISION		BY
	S / T E FRING, SURVEYING & PE ARCHITECTURE, P.C.	3 Garrett Place Carmel, NY 10512 (845) 225–9690 (845) 225–9717 f www.insite–eng.com	
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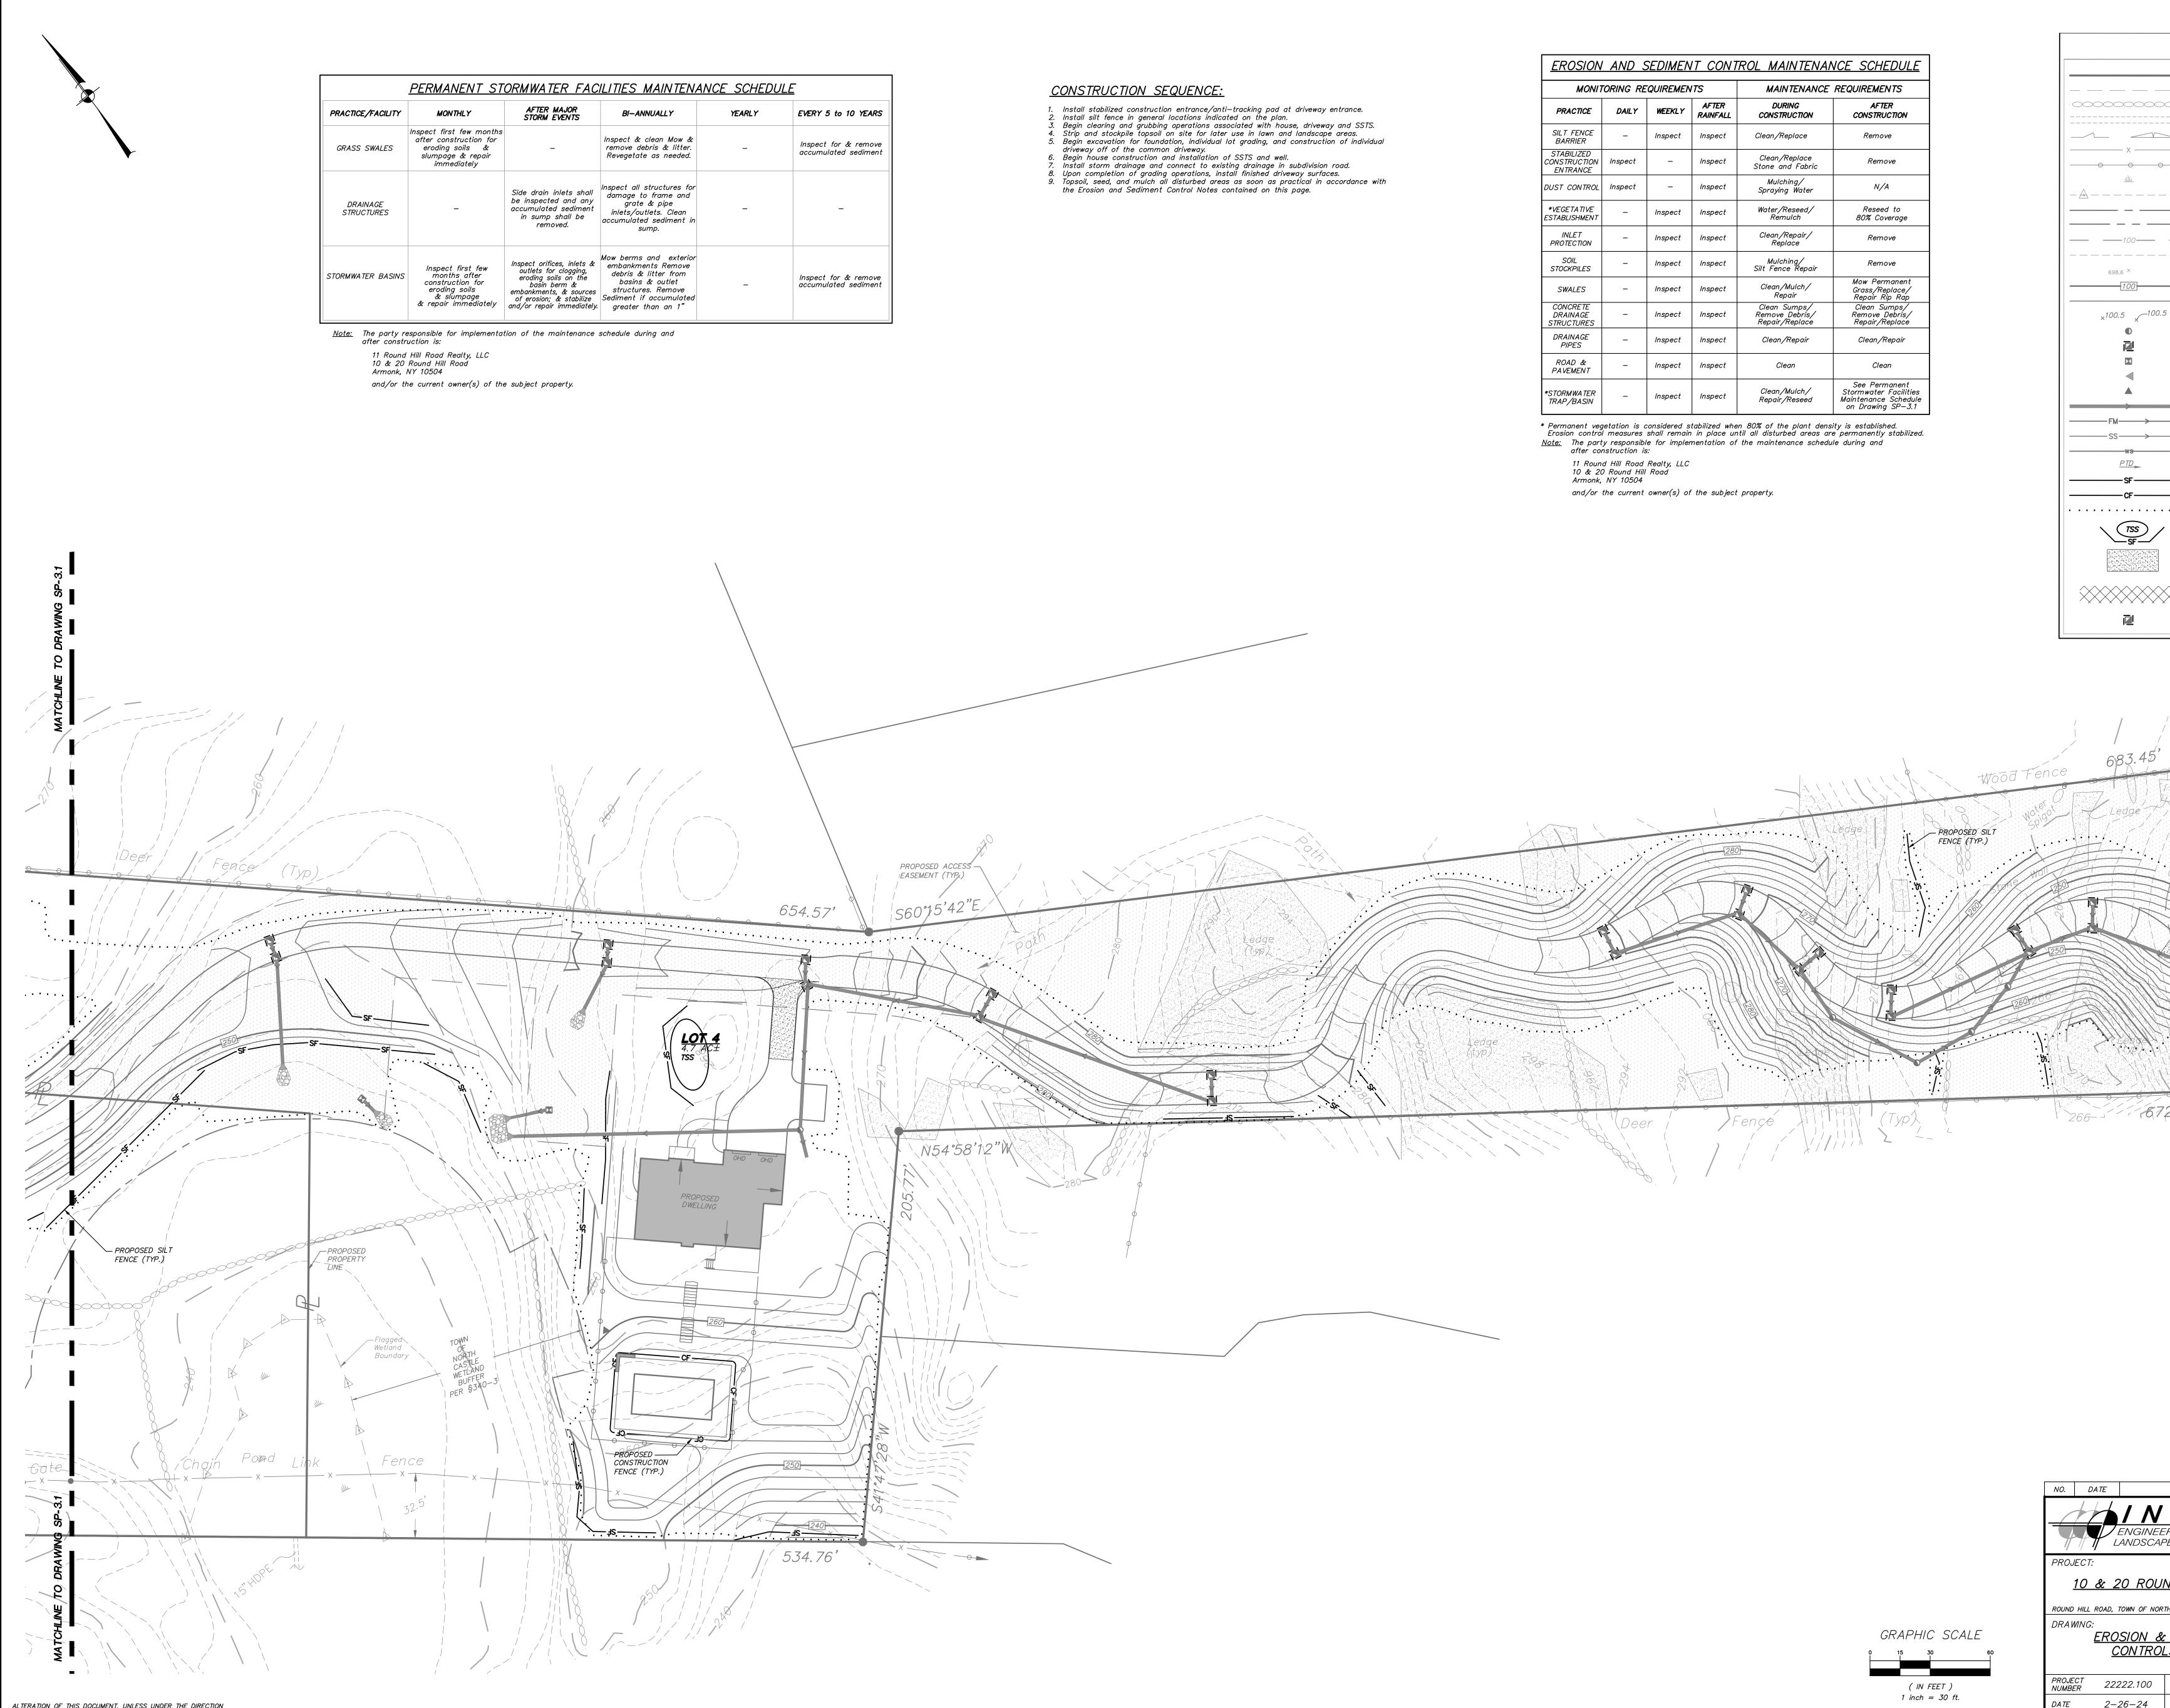


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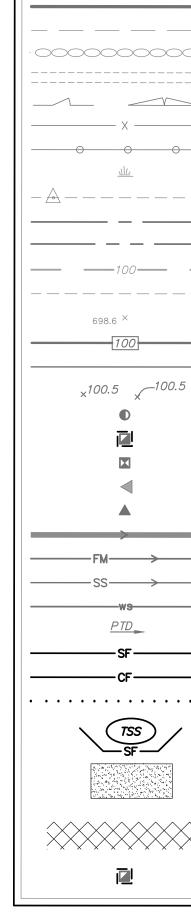
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5	PROPOSED SPOT ELEVATION
	PROPOSED DRAINAGE MANHOLE
	PROPOSED CATCH BASIN
	PROPOSED OUTLET STRUCTURE
	PROPOSED END SECTION
	PROPOSED WELL
	PROPOSED DRAINAGE PIPE
	PROPOSED SEWER FORCE MAIN
	PROPOSED SEWER SERVICE LINE
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LLY	YEARLY	EVERY 5 to 10 YEARS
n Mow & & litter. needed.	_	Inspect for & remove accumulated sediment
ctures for ime and pipe . Clean diment in	_	_
exterior Remove outlet Remove cumulated an 1"	_	Inspect for & remove accumulated sediment

MONIT	ORING RE	QUIREMEN	ITS	MAINTENANCE REQUIREMENTS		
PRACTICE	DAILY	WEEKLY	AFTER RAINFALL	DURING CONSTRUCTION	AFTER CONSTRUCTION	
SILT FENCE BARRIER	_	Inspect	Inspect	Clean/Replace	Remove	
STABILIZED CONSTRUCTION ENTRANCE	Inspect	_	Inspect	Clean/Replace Stone and Fabric	Remove	
DUST CONTROL	Inspect	_	Inspect	Mulching/ Spraying Water	N/A	
*VEGETATIVE ESTABLISHMENT	_	Inspect	Inspect	Water/Reseed/ Remulch	Reseed to 80% Coverage	
INLET PROTECTION	_	Inspect	Inspect	Clean/Repair/ Replace	Remove	
SOIL STOCKPILES	_	Inspect	Inspect	Mulching/ Silt Fence Repair	Remove	
SWALES	_	Inspect	Inspect	Clean/Mulch/ Repair	Mow Permanent Grass/Replace/ Repair Rip Rap	
CONCRETE DRAINAGE STRUCTURES	_	Inspect	Inspect	Clean Sumps/ Remove Debris/ Repair/Replace	Clean Sumps/ Remove Debris/ Repair/Replace	
DRAINAGE PIPES	_	Inspect	Inspect	Clean/Repair	Clean/Repair	
ROAD & PAVEMENT	_	Inspect	Inspect	Clean	Clean	
*STORMWATER TRAP/BASIN	_	Inspect	Inspect	Clean/Mulch/ Repair/Reseed	See Permanent Stormwater Facilities Maintenance Schedul on Drawing SP-3.1	

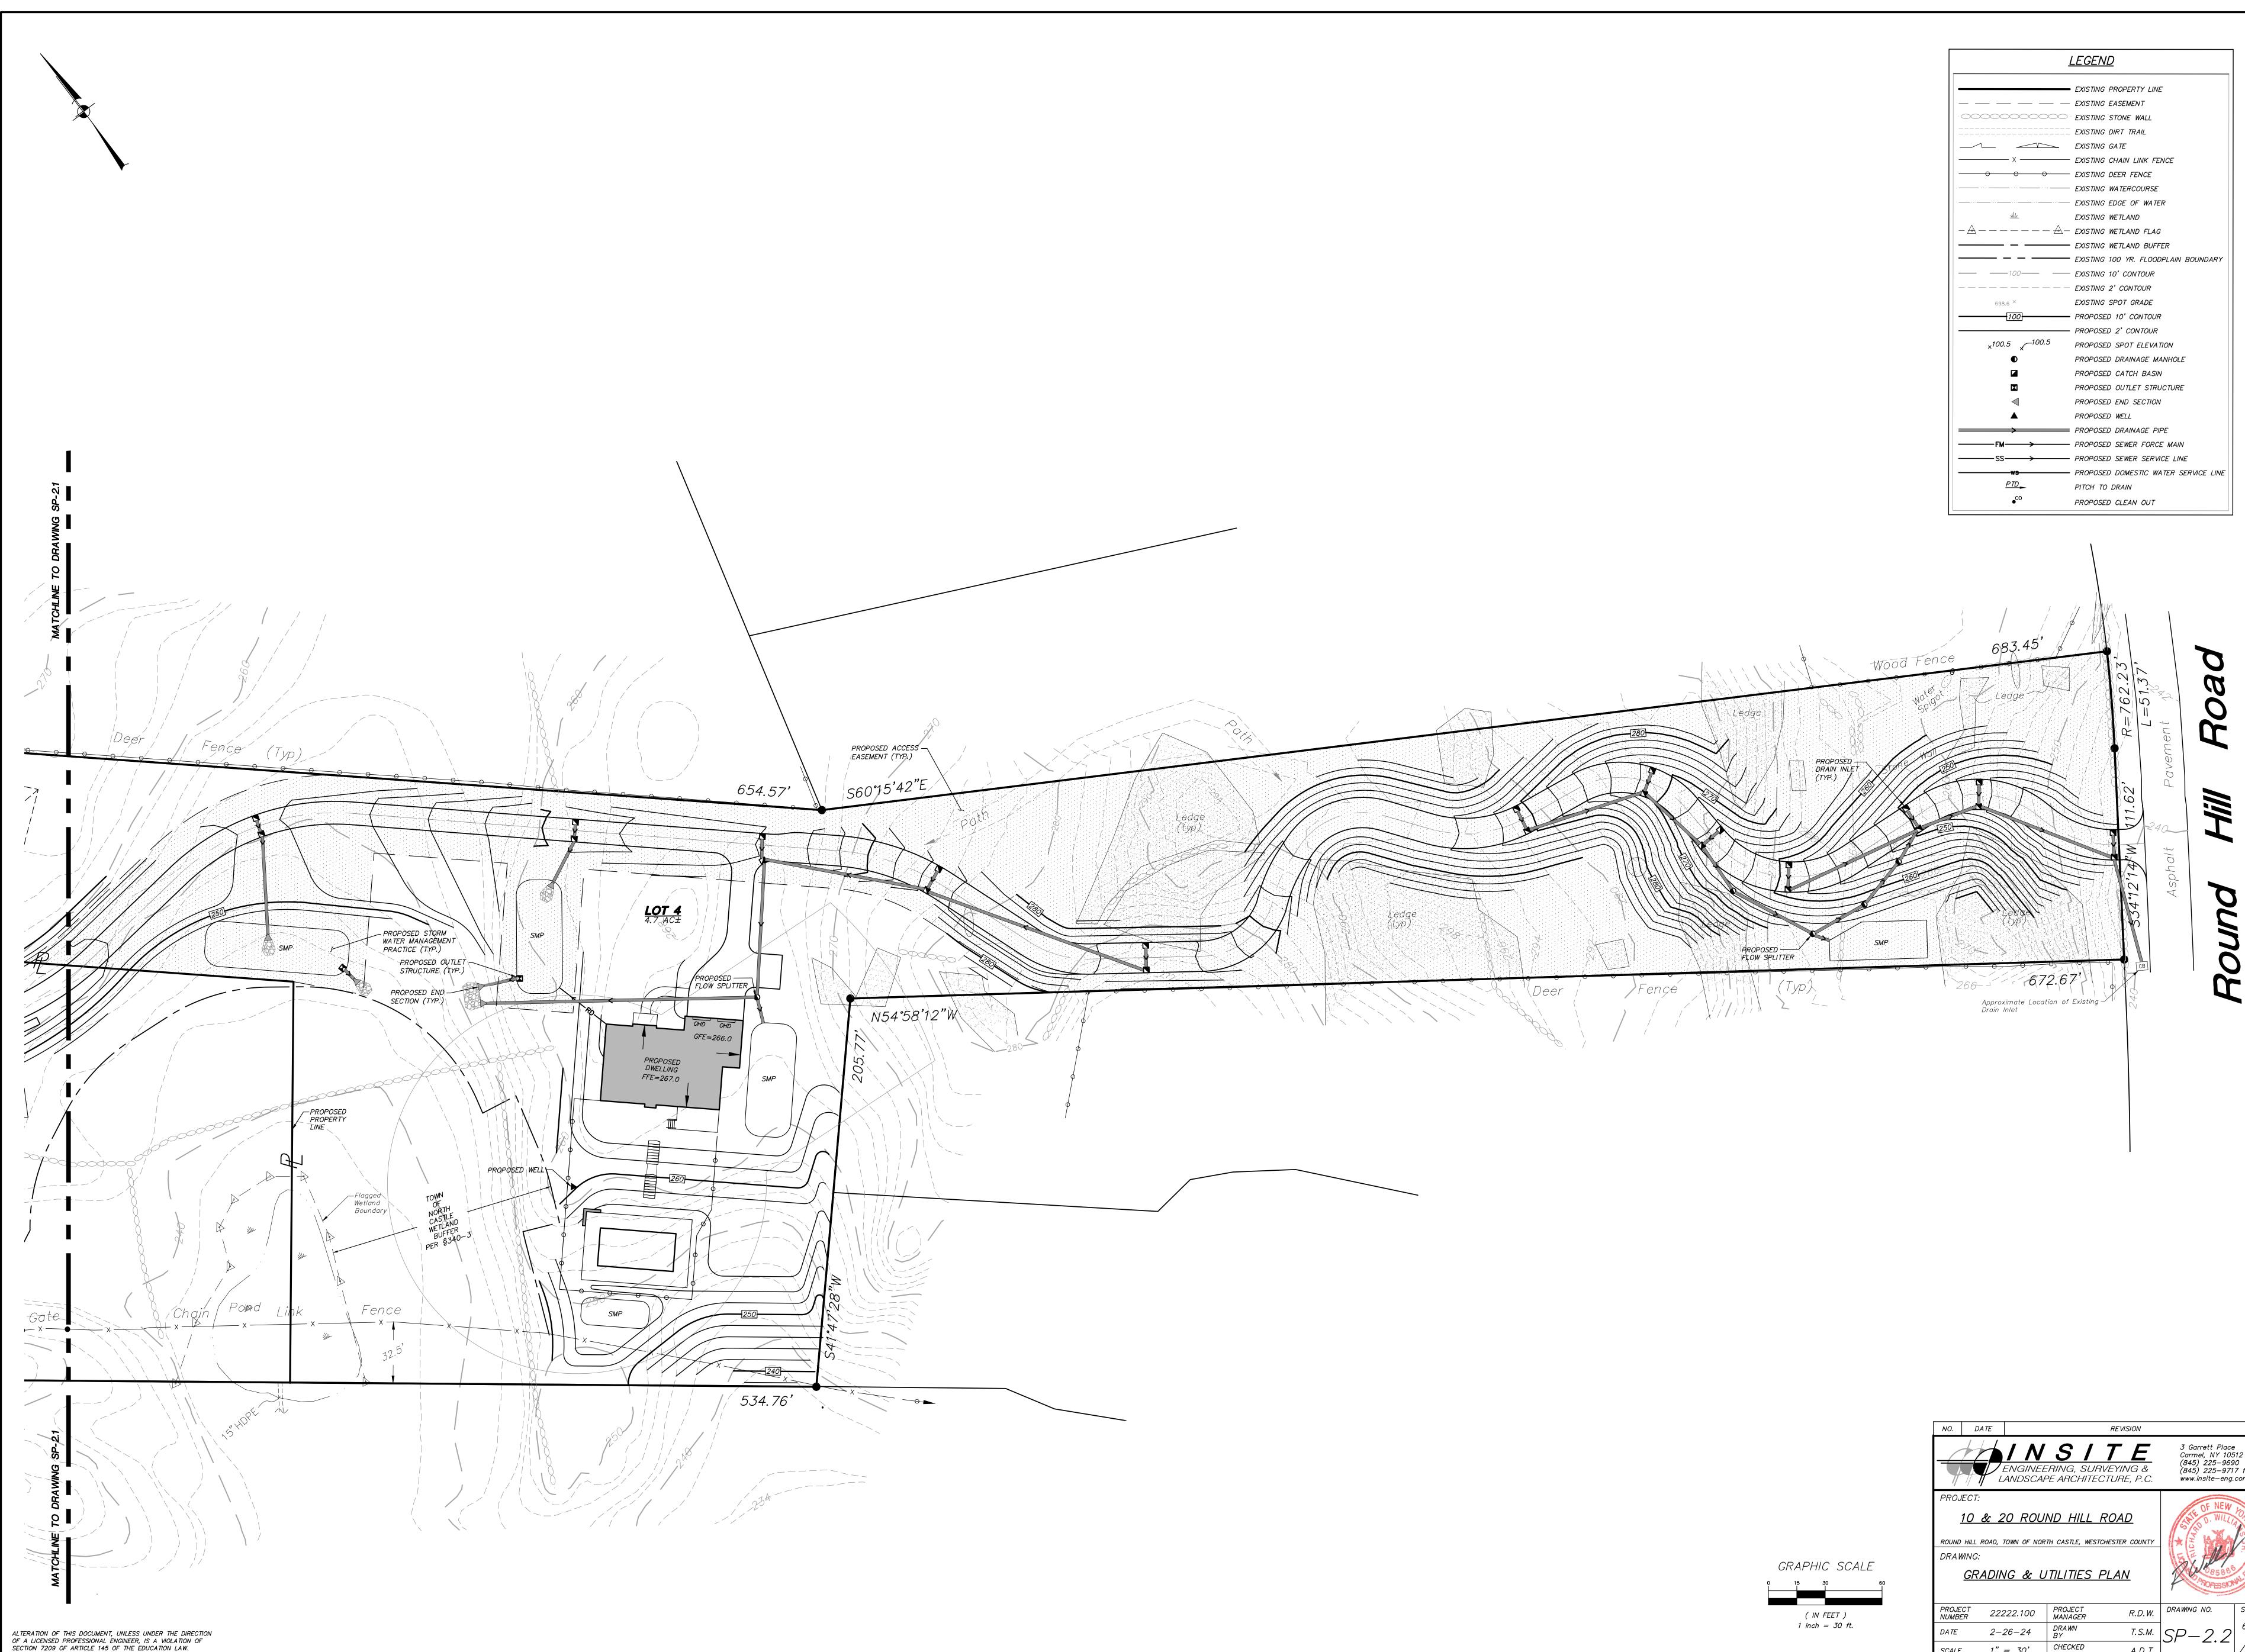

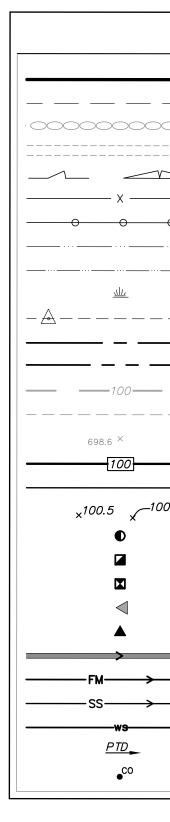
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${\sim}$	PROPOSED EROSION CON PROPOSED DRAINAGE ST INLET PROTECTION	TROL BLANKET	
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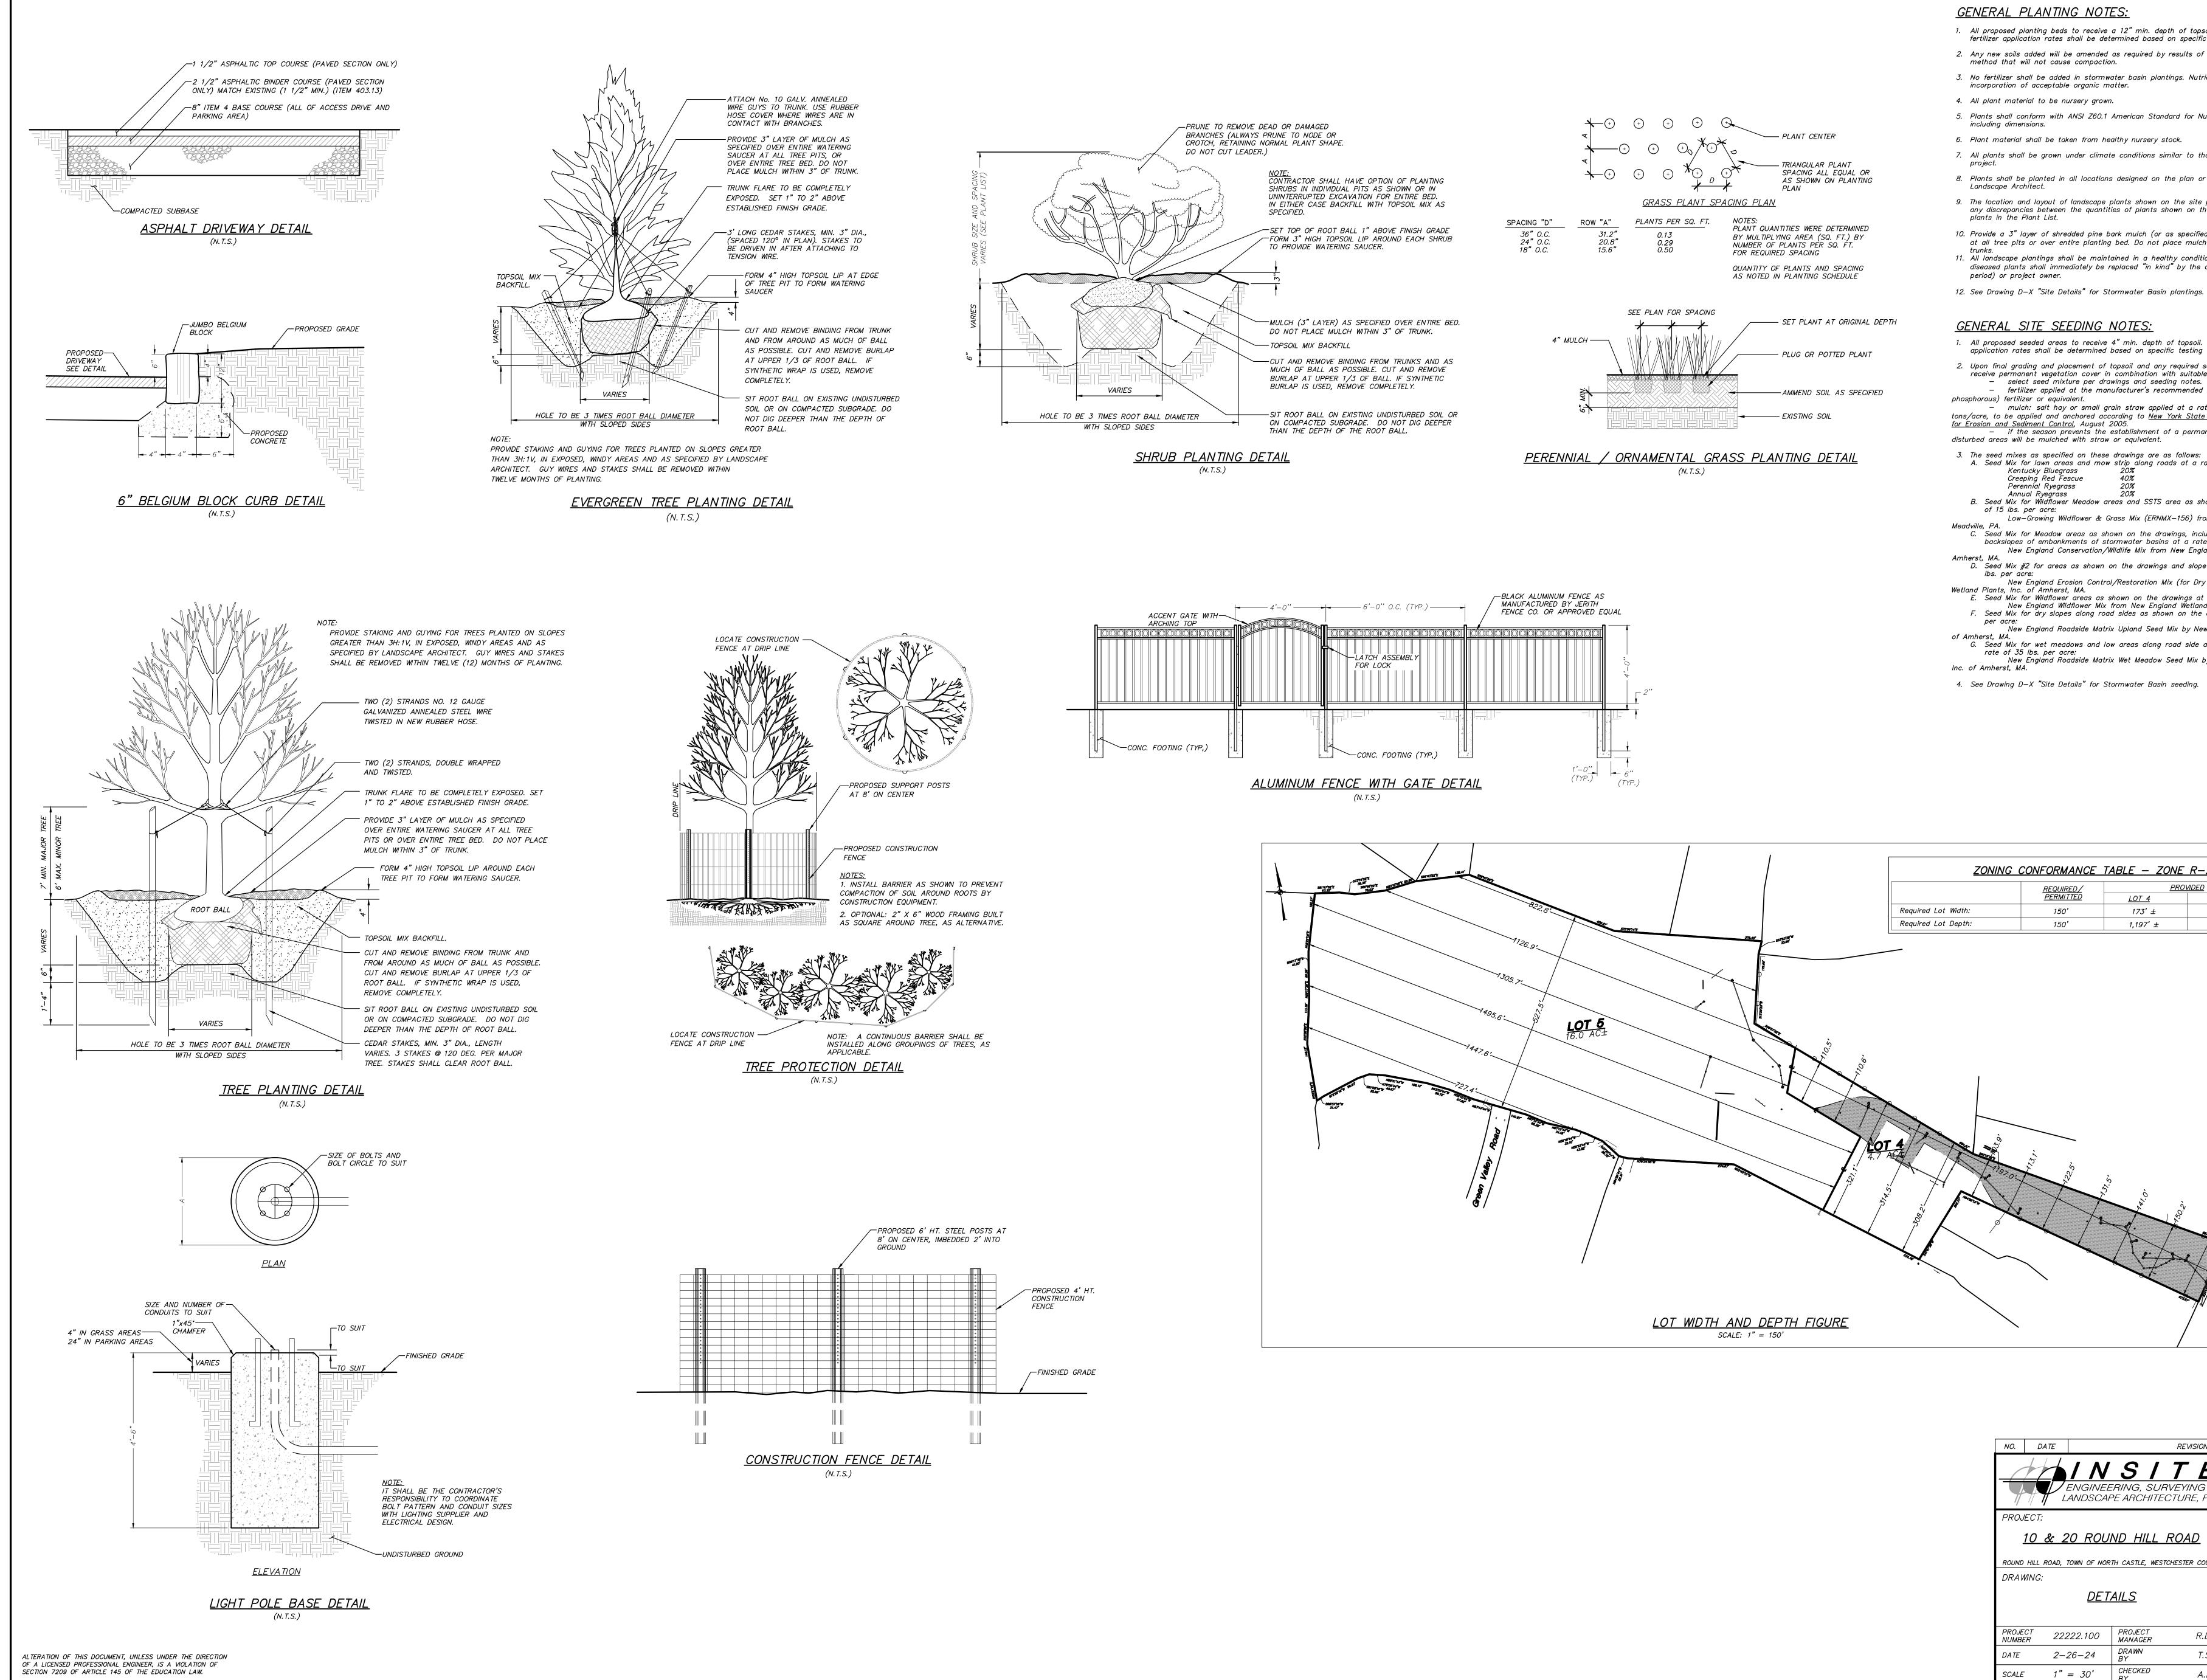



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ΥΎ).	EXISTING TREELINE	
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• • • •	PROPOSED LIMITS OF DISTURBANCE	

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S / T / ERING, SURVEYING PE ARCHITECTURE, F	&	3 Garrett Place Carmel, NY 10512 (845) 225–9690 (845) 225–9717 www.insite–eng.co	fax
I <u>ND HILL ROAD</u> RTH CASTLE, WESTCHESTER CO DVALS PLAN	UNTY	STATE OF NEW PO Software D. WILLIA * HOLE D. WILLIA	ALL ALL
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1. All proposed planting beds to receive a 12" min. depth of topsoil. Soil amendments and fertilizer application rates shall be determined based on specific testing of topsoil material. 2. Any new soils added will be amended as required by results of soil testing and placed using a

3. No fertilizer shall be added in stormwater basin plantings. Nutrient requirements to be met by

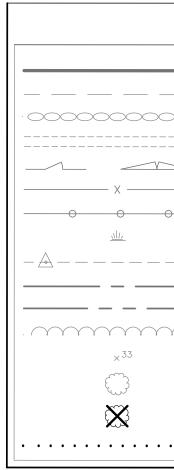5. Plants shall conform with ANSI Z60.1 American Standard for Nursery Stock in all ways

7. All plants shall be grown under climate conditions similar to those in the locality of the 8. Plants shall be planted in all locations designed on the plan or as staked in the field by the

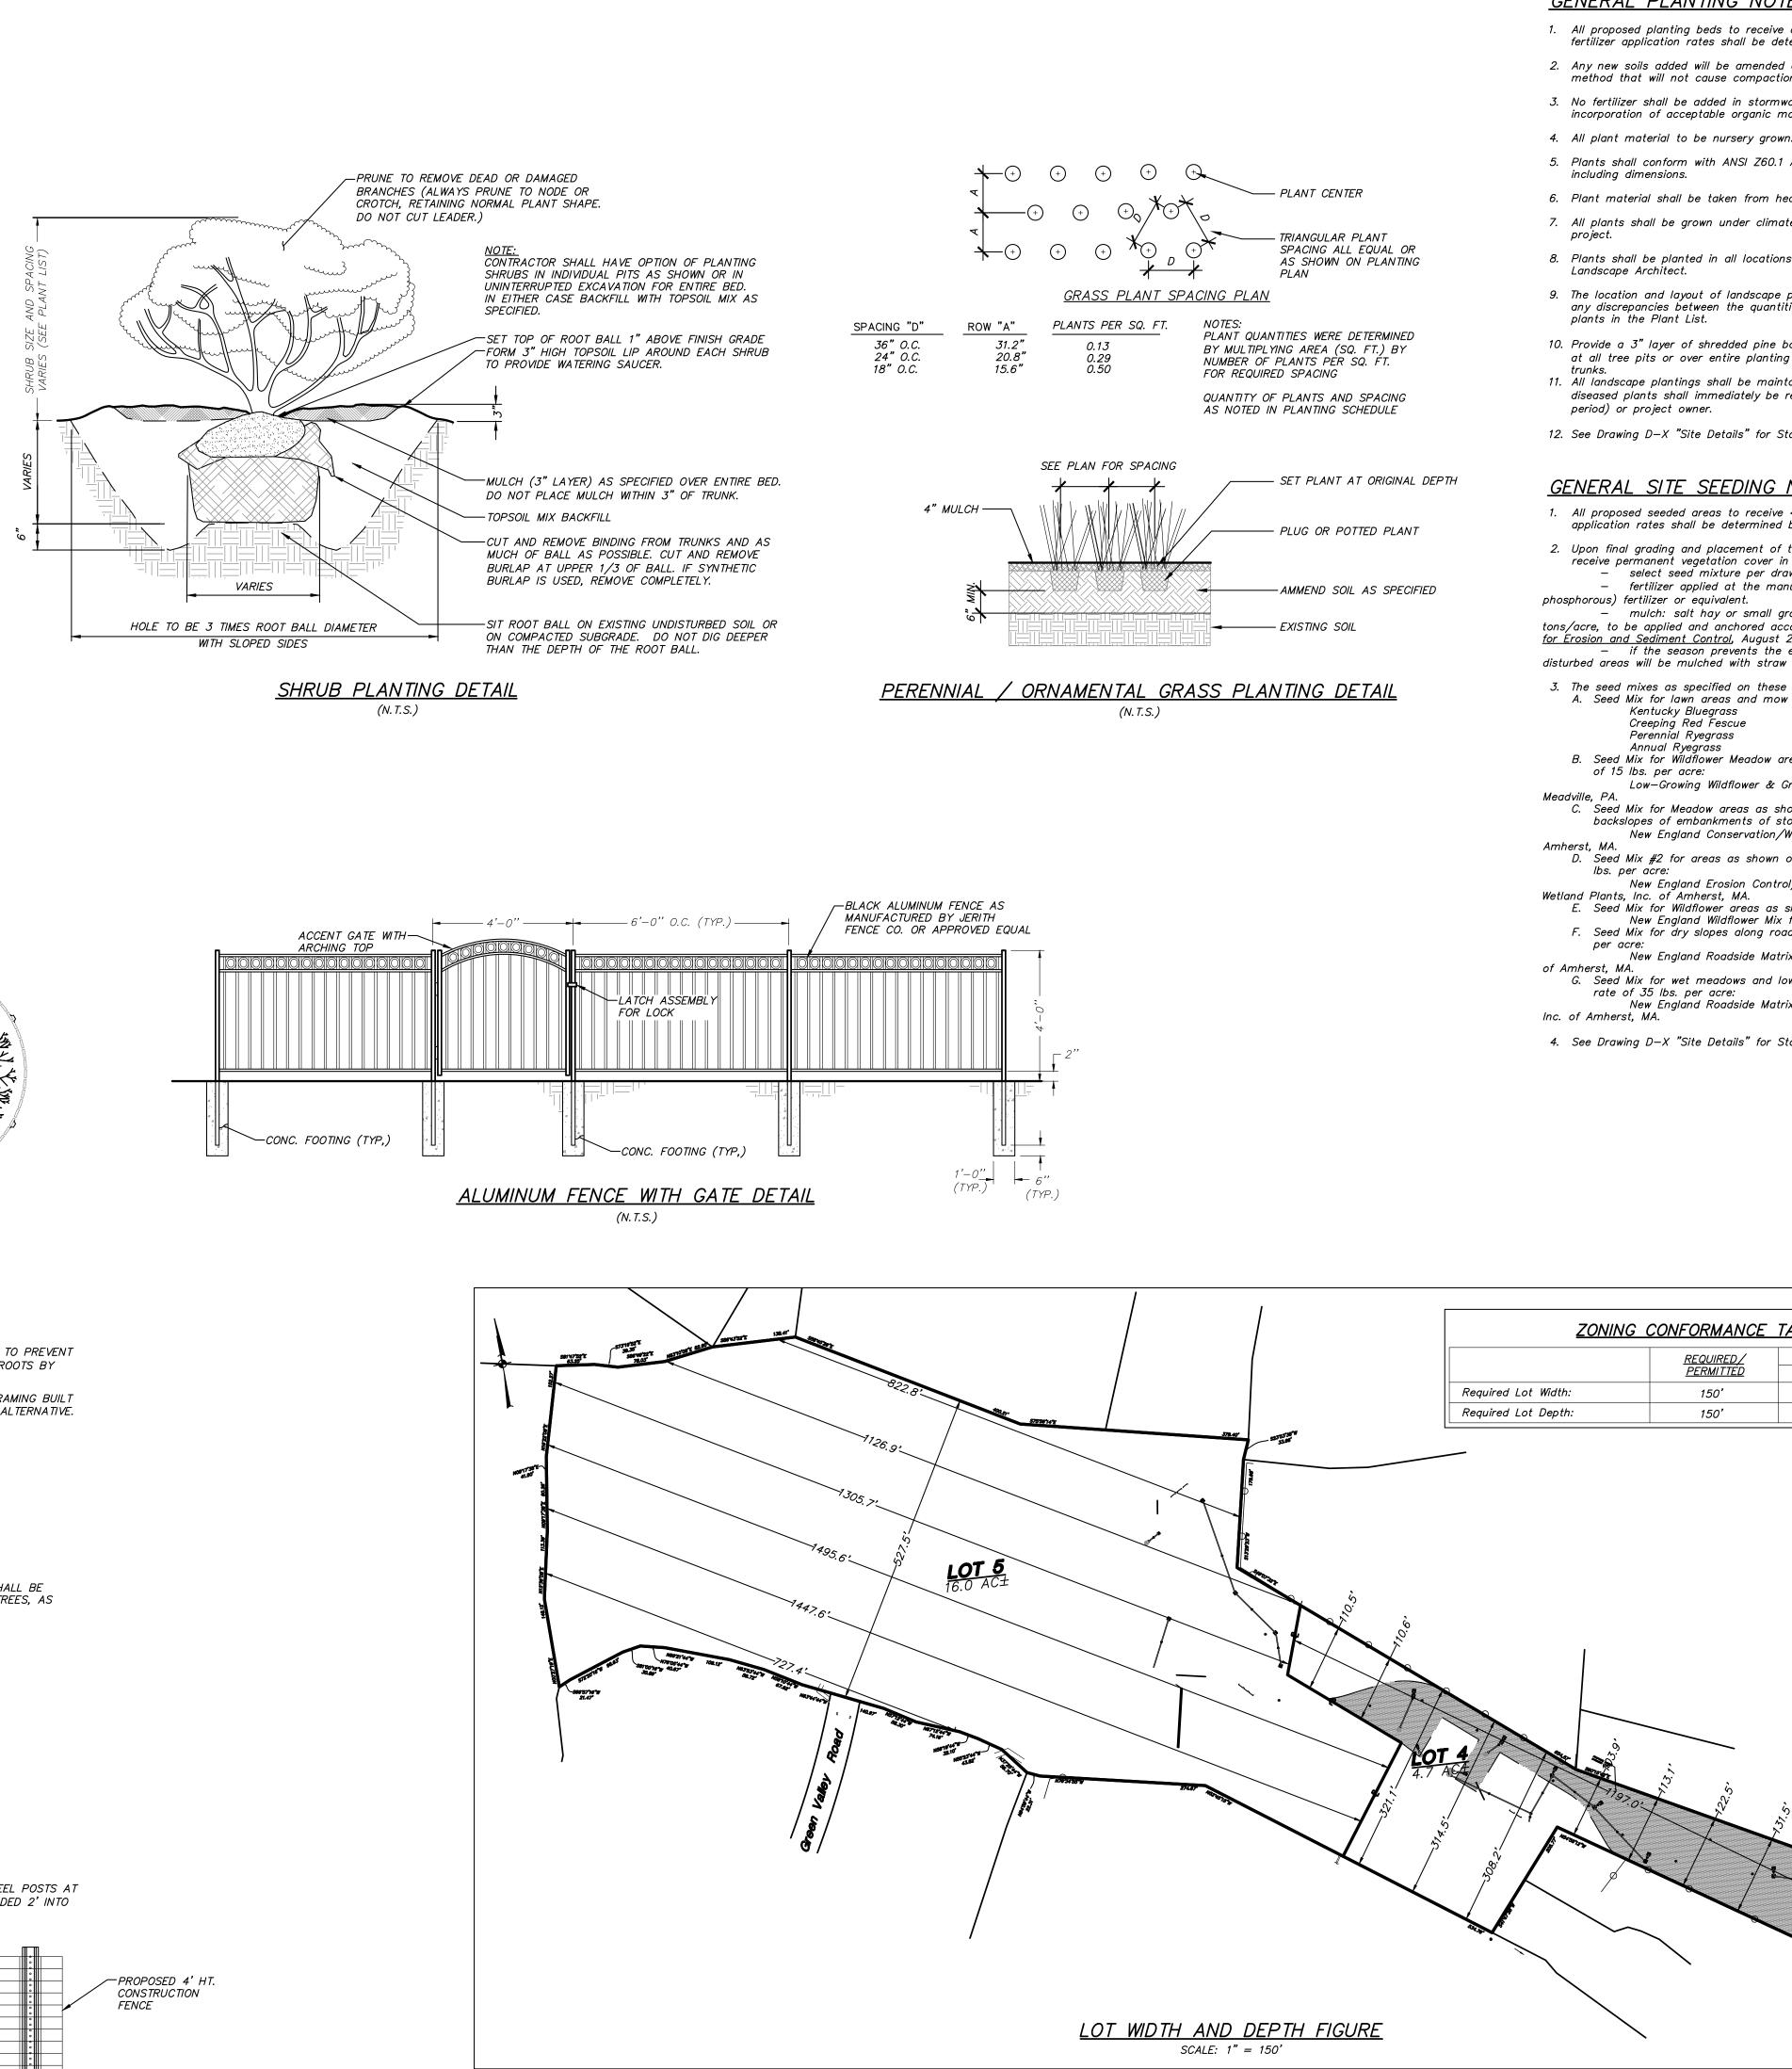9. The location and layout of landscape plants shown on the site plan shall take precedence in any discrepancies between the quantities of plants shown on the plans and the quantity of

10. Provide a 3" layer of shredded pine bark mulch (or as specified) over entire watering saucer at all tree pits or over entire planting bed. Do not place mulch within 3" of tree or shrub

11. All landscape plantings shall be maintained in a healthy condition at all times. Any dead or diseased plants shall immediately be replaced "in kind" by the contractor (during warranty

1. All proposed seeded areas to receive 4" min. depth of topsoil. Soil amendments and fertilizer application rates shall be determined based on specific testing of topsoil material. 2. Upon final grading and placement of topsoil and any required soil amendments, areas to receive permanent vegetation cover in combination with suitable mulch as follows: - fertilizer applied at the manufacturer's recommended rate using Lesco 10-0-18 (no – mulch: salt hay or small grain straw applied at a rate of 90 lbs./1000 s.f. or 2 tons/acre, to be applied and anchored according to New York State Standards and Specifications - if the season prevents the establishment of a permanent vegetation cover, the


A. Seed Mix for lawn areas and mow strip along roads at a rate of 100 lbs. per acre: 20% 40%


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Annual Ryegrass 20% B. Seed Mix for Wildflower Meadow areas and SSTS area as shown on the drawings at a rate Low—Growing Wildflower & Grass Mix (ERNMX—156) from Ernst Conservation Seeds of C. Seed Mix for Meadow areas as shown on the drawings, including tops of berms and backslopes of embankments of stormwater basins at a rate of 25 lbs. per acre: New England Conservation/Wildlife Mix from New England Wetland Plants, Inc. of D. Seed Mix #2 for areas as shown on the drawings and slope areas 2:1 at a rate of 35 New England Erosion Control/Restoration Mix (for Dry Sites) from New England E. Seed Mix for Wildflower areas as shown on the drawings at a rate of 23 lbs. per acre: New England Wildflower Mix from New England Wetland Plants, Inc. of Amherst, MA. F. Seed Mix for dry slopes along road sides as shown on the drawings at a rate of 35 lbs. New England Roadside Matrix Upland Seed Mix by New England Wetland Plants, Inc. G. Seed Mix for wet meadows and low areas along road side as shown on drawings at a New England Roadside Matrix Wet Meadow Seed Mix by New England Wetland Plants,

<u></u>	ROVIDED
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PROPERTY LOCATION

PROPERTY LOCATION

Shee Number
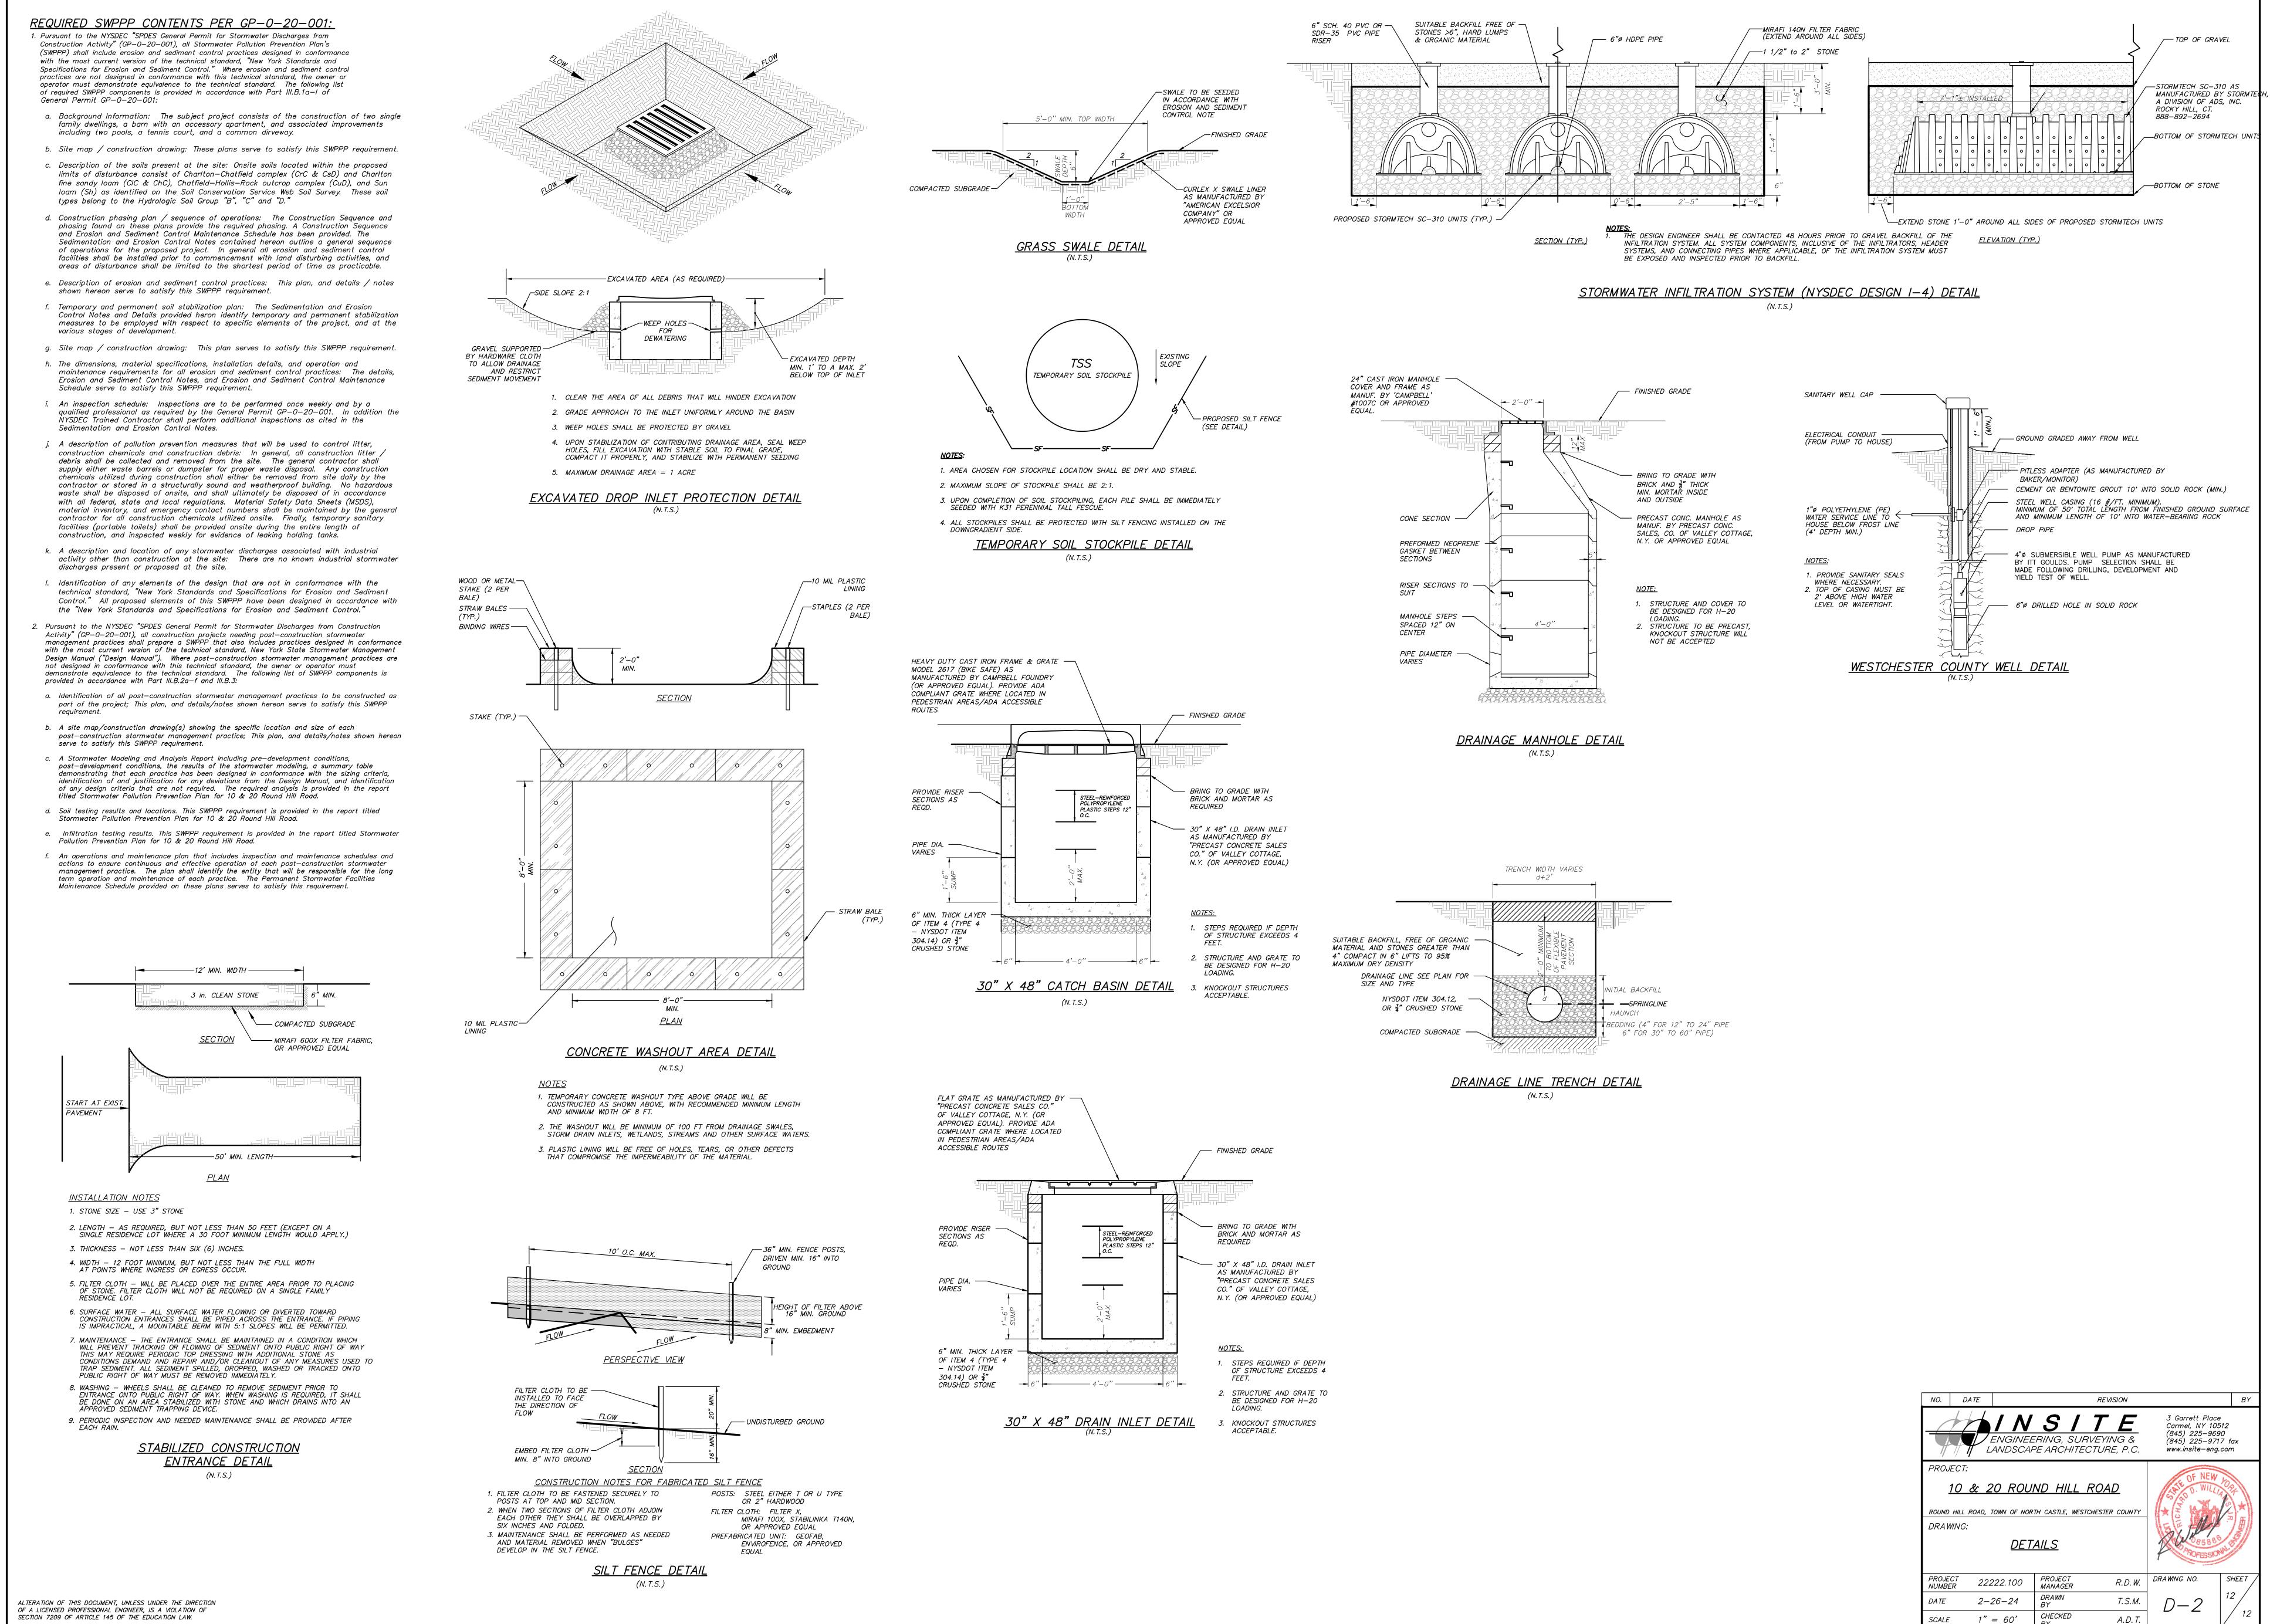
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DRAWING INDEX
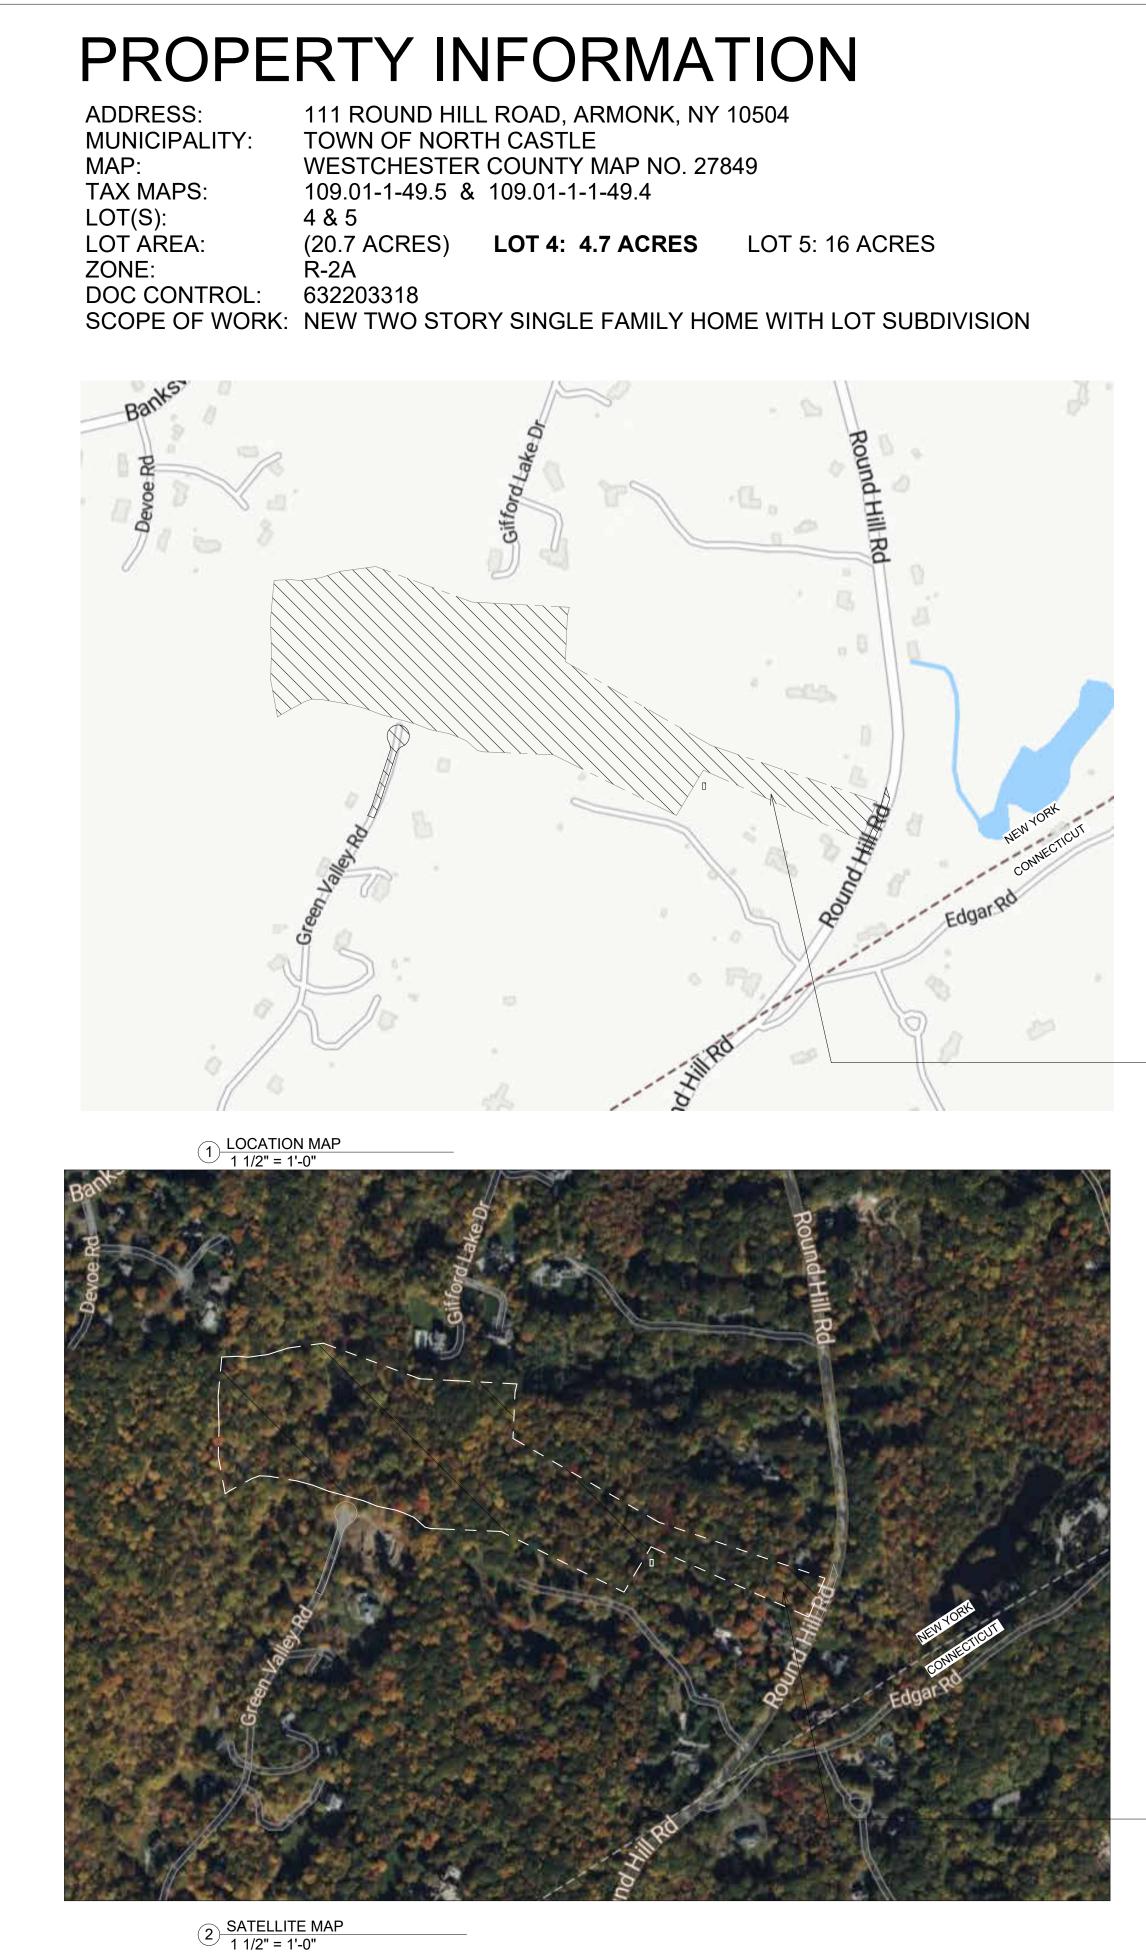
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Sheet Name

00	COVER SHEET
3	AREA DIAGRAMS (GROSS)
4	AREA DIAGRAMS (CALCULATED)
5	ROOF HEIGHTS CALCULATION
)0	CELLAR PLAN
)1	FIRST FLOOR PLAN
)2	SECOND FLOOR PLAN
)4	ROOF PLAN
)0	ELEVATIONS
)1	ELEVATIONS
)0	BUILDING SECTION
)1	BUILDING SECTION
)0	EXTERIOR 3D VIEWS
)1	HOME RENDERING

ZACHARY HARWIN, RA

CONTACT INFO

OWNERSHIP ROUND HILL ROAD REALTY LLC

DESIGN ARCHITECT ZACHARY HARWIN, RA PHONE: 516-510-3747 EMAIL: zacharyharwin@gmail.com

ARCHITECT OF RECORD TERRY LENNON TPL ARCHITECT 100B Danbury Road, Suite 105M, Ridgefield, CT 06877 (914) 276-0225

CIVIL ENGINEER Richard Williams, Jr., PE INSITE ENGINEERING, SURVEYING & LANDSCAPE ARCHITECTURE, P.C. 3 Garrett Place Carmel, New York 10512 (845) 225-9690 x118 (845) 225-9717 Fax www.insite-eng.com

KEY PLAN

UNLESS PREVIOUSLY AGREED OTHERWISE, THE AUTHOR OF THESE DRAWINGS EXPRESSLY RESERVES THEIR COMMON LAW COPYWRIGHT AND OTHER PROPERTY RIGHTS TO THESE PLANS. ALL DESIGNS, SPECIFICATIONS AND DRAWINGS ARE THE PROPERTY OF THE AUTHOR; WHICH ARE TO BE USED ONLY AS INDICATED FOR THIS PROJECT. THEY SHALL NOT BE USED ON ANY OTHER PROJECT IN FULL OR IN PART, WITHOUT FIRST OBTAINING THE WRITTEN APPROVAL OF THE AUTHOR. THESE DOCUMENTS SHALL NOT BE TRANSFERED TO ANY UNAUTHORIZED 3RD PARTY WITHOUT THE SAME PRIOR CONSENT.

NOTE: ALL WORK SHALL COMPLY WITH LOCAL, MUNICAPAL, AND STATE CODES, ORDINANCES ETC. THE ARCHITECT/DESIGNER IS NOT RESPONISBLE FOR SITE SUPERVISION, SAFETY, OR CONSTRUCTION MEANS AND METHODS No. Description Date

DEPT OF BUILDINGS NO. ---- ----PROFESSIONAL SEAL FILING TYPE

IF REQUIRED


Project Number Project Number LOT 4 RESIDENCE

111 ROUND HILL ROAD ARMONK, NY


LOT: DRAWING TITLE COVER SHEET

DRAWING NO.

A000 Drawn By: Author Sheet: of

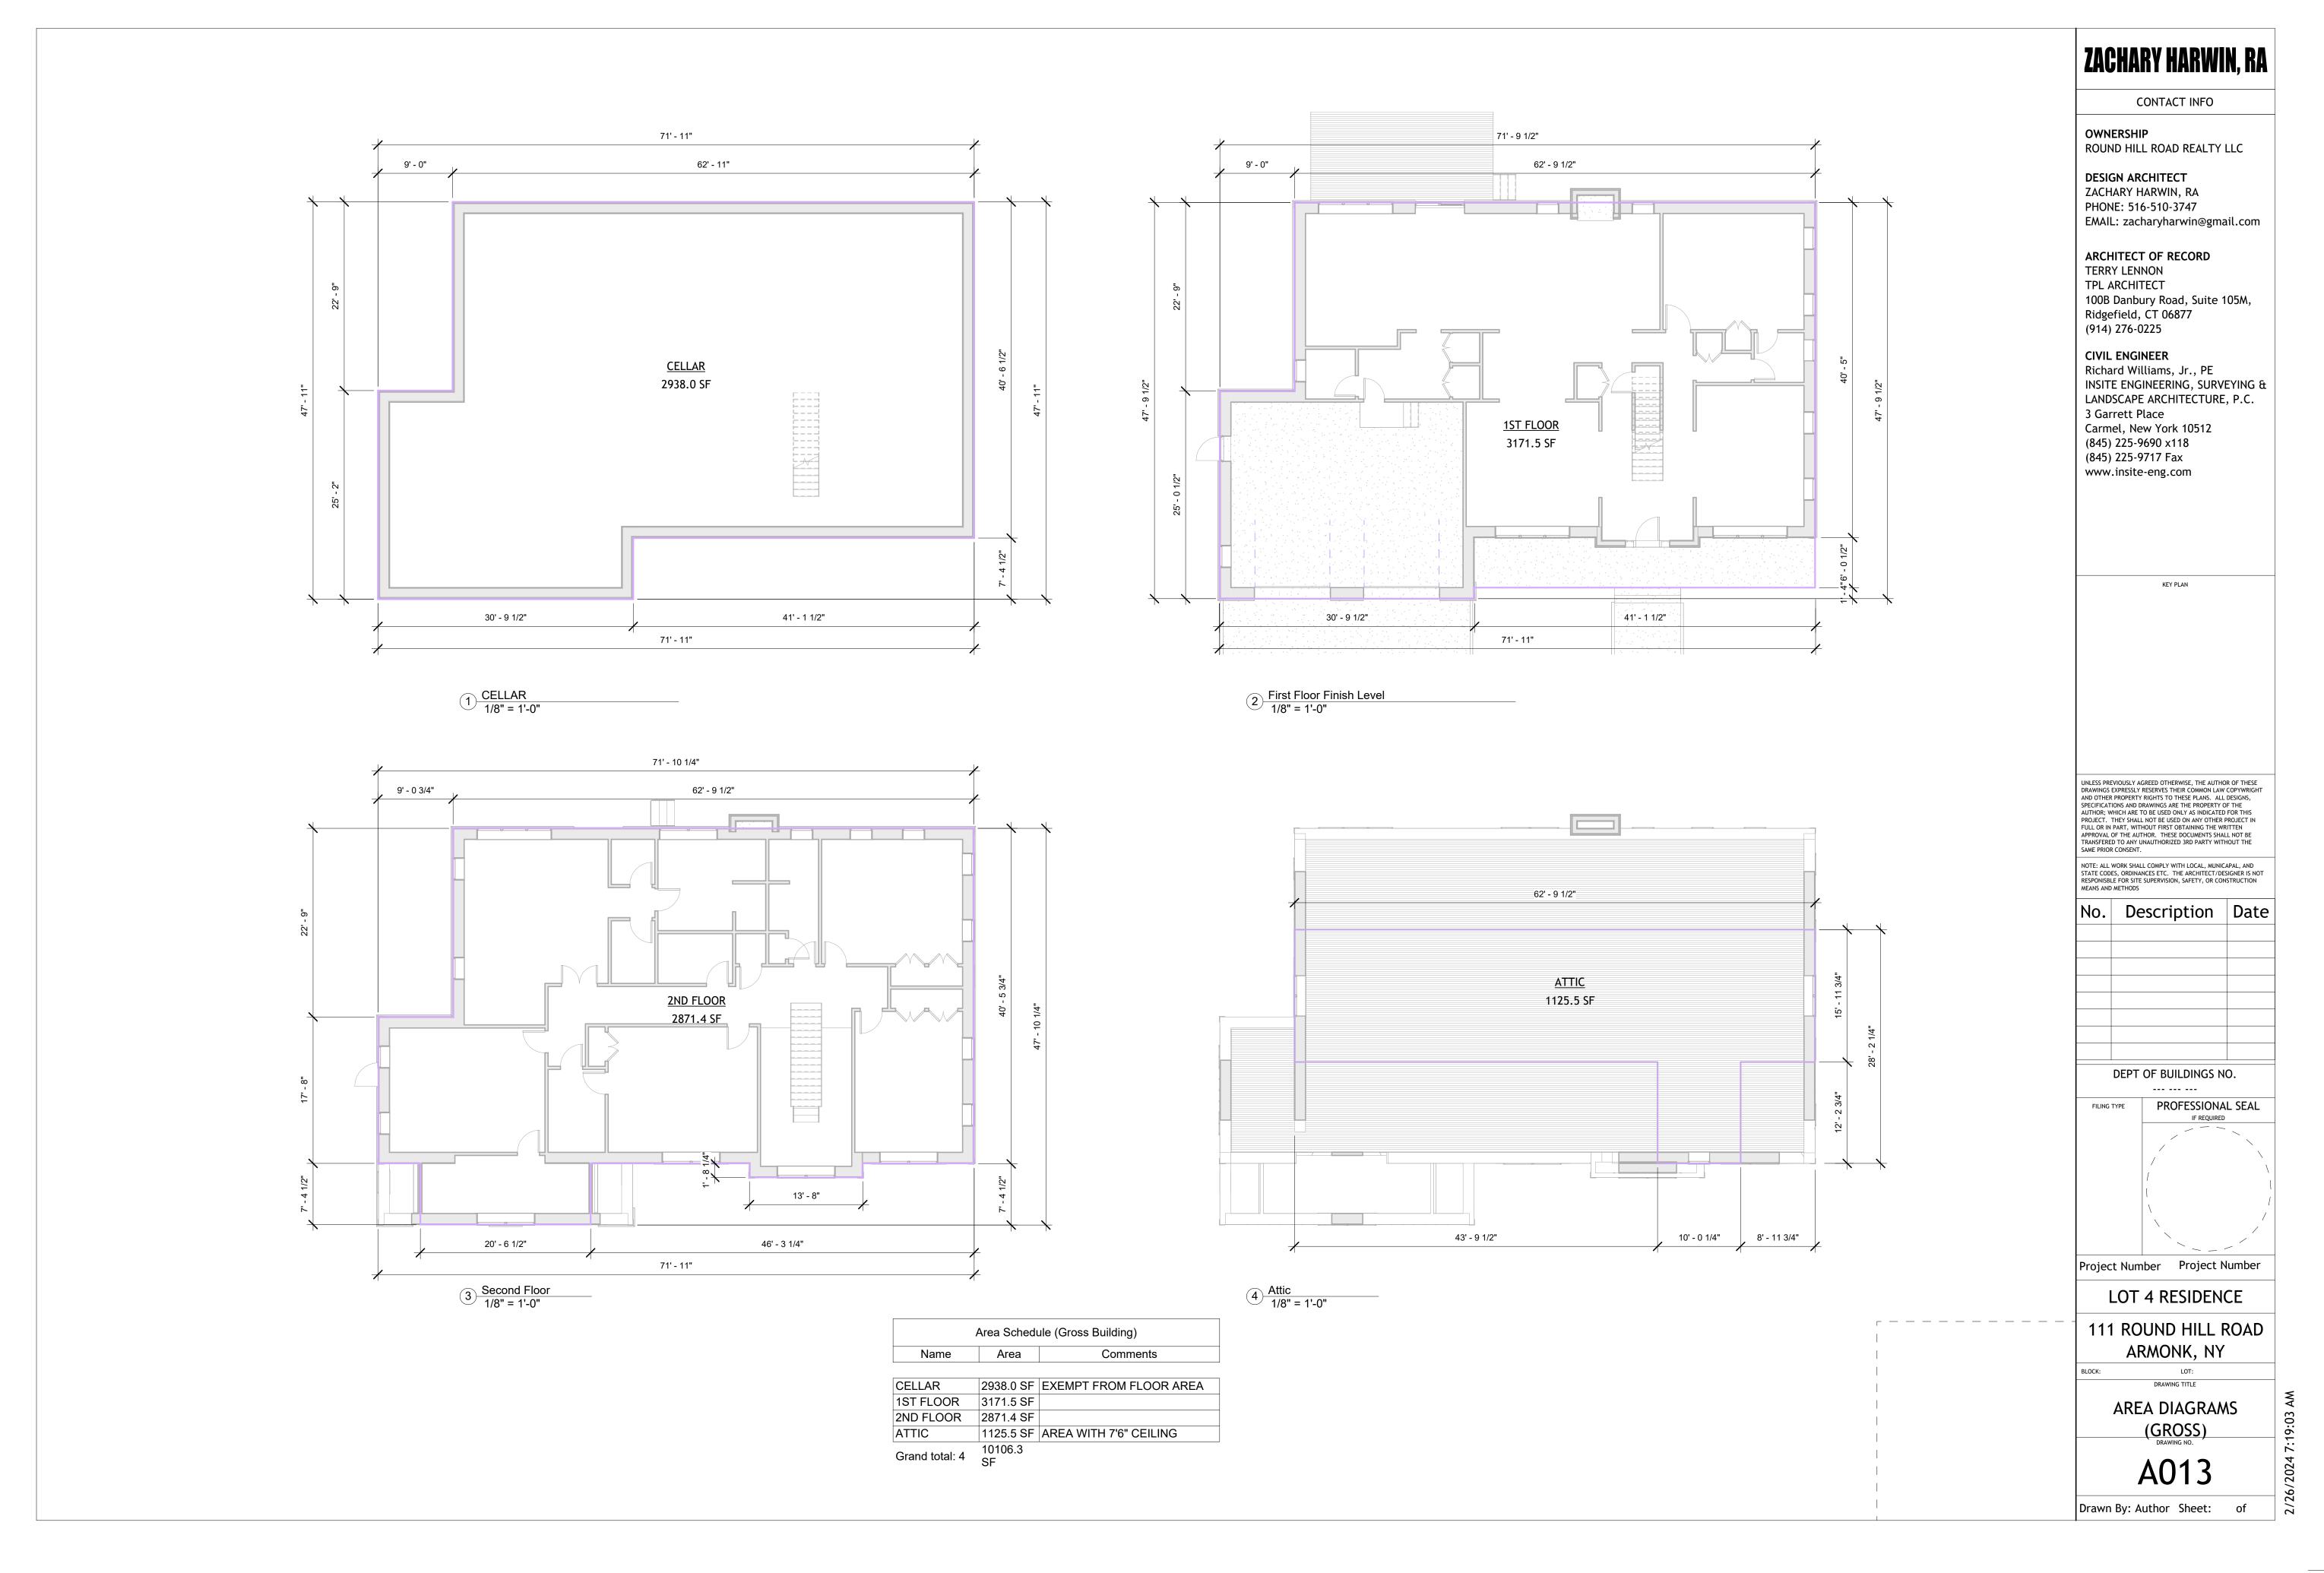

	FLOOR ARE	AS	
Level	Name	Area	Comments
First Floor Finish Level	1A	159.0 SF	GARAGE
First Floor Finish Level	1B	226.2 SF	GARAGE
First Floor Finish Level	1C	866.7 SF	
First Floor Finish Level	1D	525.0 SF	
First Floor Finish Level	1E	561.6 SF	
First Floor Finish Level	1XA	88.2 SF	COVERED PORCH
First Floor Finish Level	1XB	61.5 SF	COVERED PORCH
First Floor Finish Level	1XC	84.0 SF	COVERED PORCH
First Floor Finish Level	1G	260.2 SF	
First Floor Finish Level	1F	339.0 SF	GARAGE
Second Floor	2A	159.0 SF	
Second Floor	2B	151.5 SF	
Second Floor	2C	1444.9 SF	
Second Floor	2D	575.4 SF	
Second Floor	2E	540.6 SF	
Attic	ATTIC 1	1003.4 SF	AREA WITH 7'6" CEILING
Attic	ATTIC 2	122.5 SF	AREA WITH 7'6" CEILING
Grand total: 17	1	7168.7 SF	1

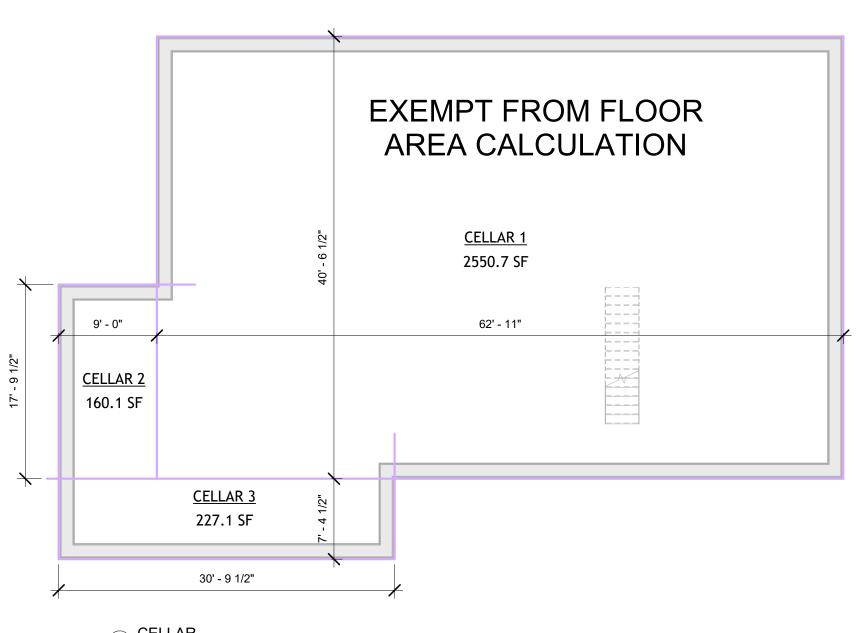


1 <u>CELLAR</u> 1/8" = 1'-0"


Area Schedule (CALCULATED) FIRST FLOOR					
Nam					
е	Area	Comments			
1A	159.0 SF	GARAGE			
1B	226.2 SF	GARAGE			
1C	866.7 SF				
1D	525.0 SF				
1E	561.6 SF				
1XA	88.2 SF	COVERED PORCH			
1XB	61.5 SF	COVERED PORCH			
1XC	84.0 SF	COVERED PORCH			
1G	260.2 SF				
1F	339.0 SF	GARAGE			
	3171.5 SF	·			
	Nam 1A 1B 1C 1D 1E 1XA 1XB 1XC 1G	Nam e Area 1A 159.0 SF 1B 226.2 SF 1C 866.7 SF 1D 525.0 SF 1E 561.6 SF 1XA 88.2 SF 1XB 61.5 SF 1XC 84.0 SF 1G 260.2 SF 1F 339.0 SF			


Area Schedule (CALCULATED) SECOND FLOOR						
Level	Name	Area	Comments			
Second Floor	2A	159.0 SF				
Second Floor	2B	151.5 SF				
Second Floor	2C	1444.9 SF				
Second Floor	2D	575.4 SF				
Second Floor	2E	540.6 SF				
Grand total: 5		2871.4 SF				

Area Schedule (CALCULATED) ATTIC							
Level Name Area Comments							
Attic	ATTIC 1	1003.4 SF	AREA WITH 7'6" CEILING				
Attic ATTIC 2		122.5 SF	AREA WITH 7'6" CEILING				
Grand total: 2		1125.9 SF					

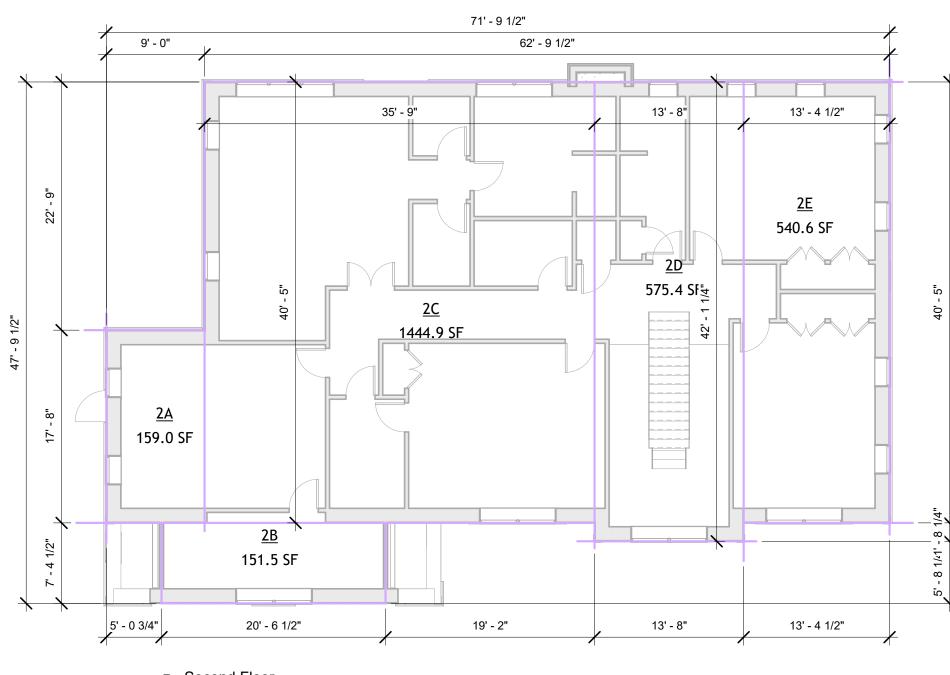

3 Second Floor 1/8" = 1'-0"

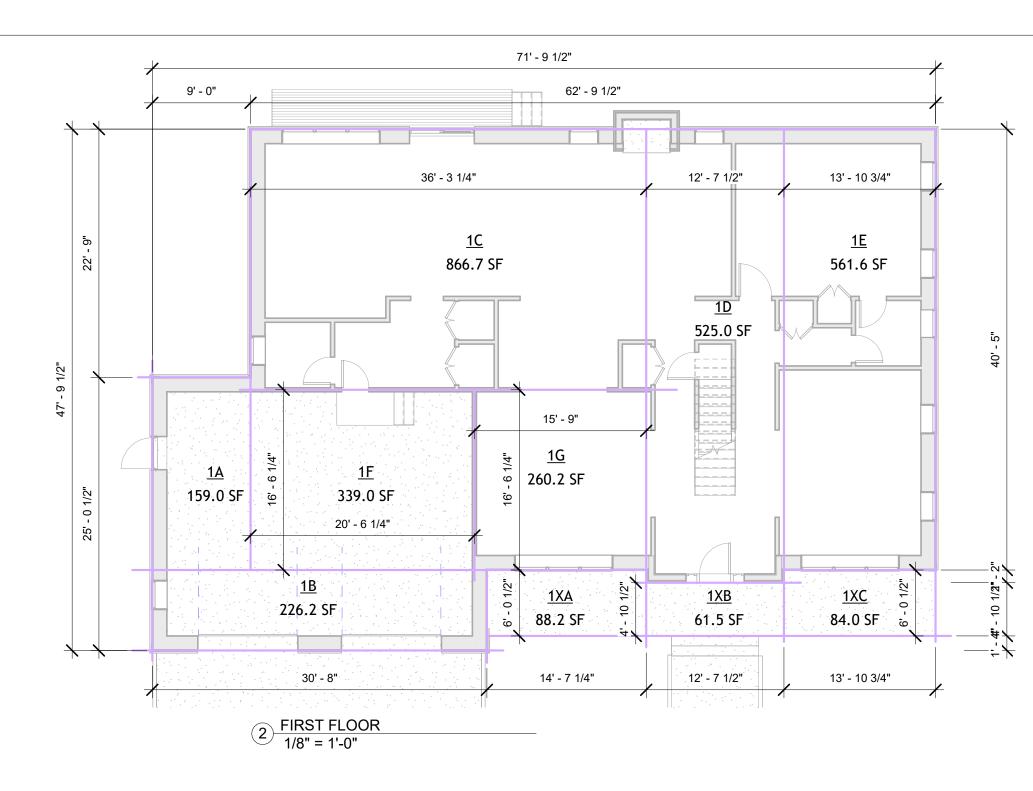

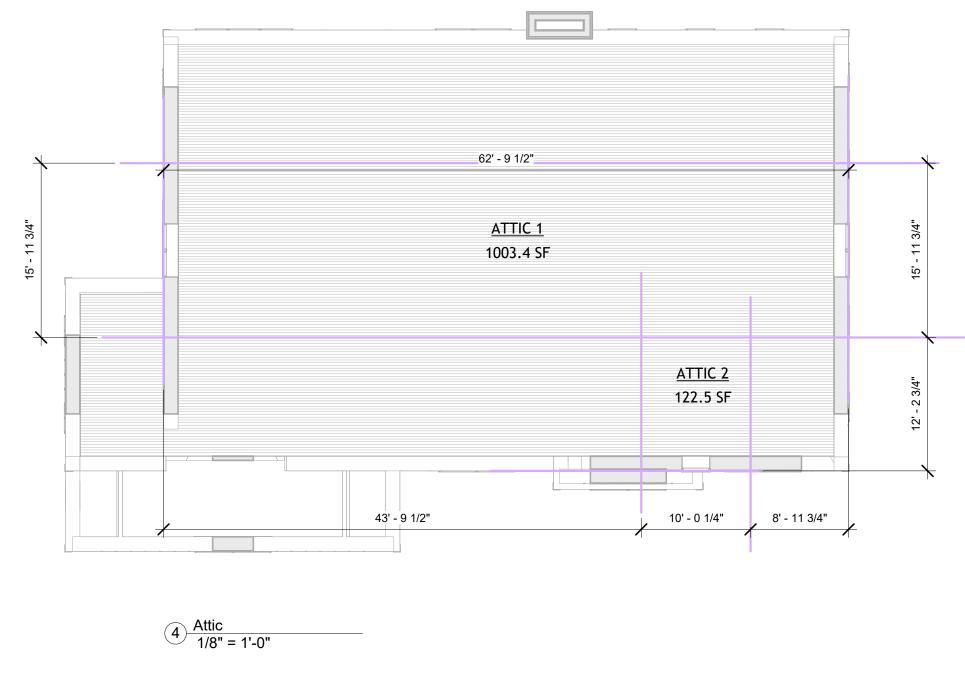

ZACHARY HARWIN, RA

CONTACT INFO

OWNERSHIP ROUND HILL ROAD REALTY LLC

DESIGN ARCHITECT ZACHARY HARWIN, RA PHONE: 516-510-3747 EMAIL: zacharyharwin@gmail.com

ARCHITECT OF RECORD TERRY LENNON TPL ARCHITECT 100B Danbury Road, Suite 105M, Ridgefield, CT 06877 (914) 276-0225

CIVIL ENGINEER Richard Williams, Jr., PE INSITE ENGINEERING, SURVEYING & LANDSCAPE ARCHITECTURE, P.C. 3 Garrett Place Carmel, New York 10512 (845) 225-9690 x118 (845) 225-9717 Fax www.insite-eng.com

KEY PLAN

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No. Description Date DEPT OF BUILDINGS NO. ---- ----PROFESSIONAL SEAL FILING TYPE IF REQUIRED

Project Number Project Number


LOT 4 RESIDENCE 111 ROUND HILL ROAD ARMONK, NY


LOT: BLOCK: DRAWING TITLE


AREA DIAGRAMS


Drawn By: Author Sheet: of


(CALCULATED) A014

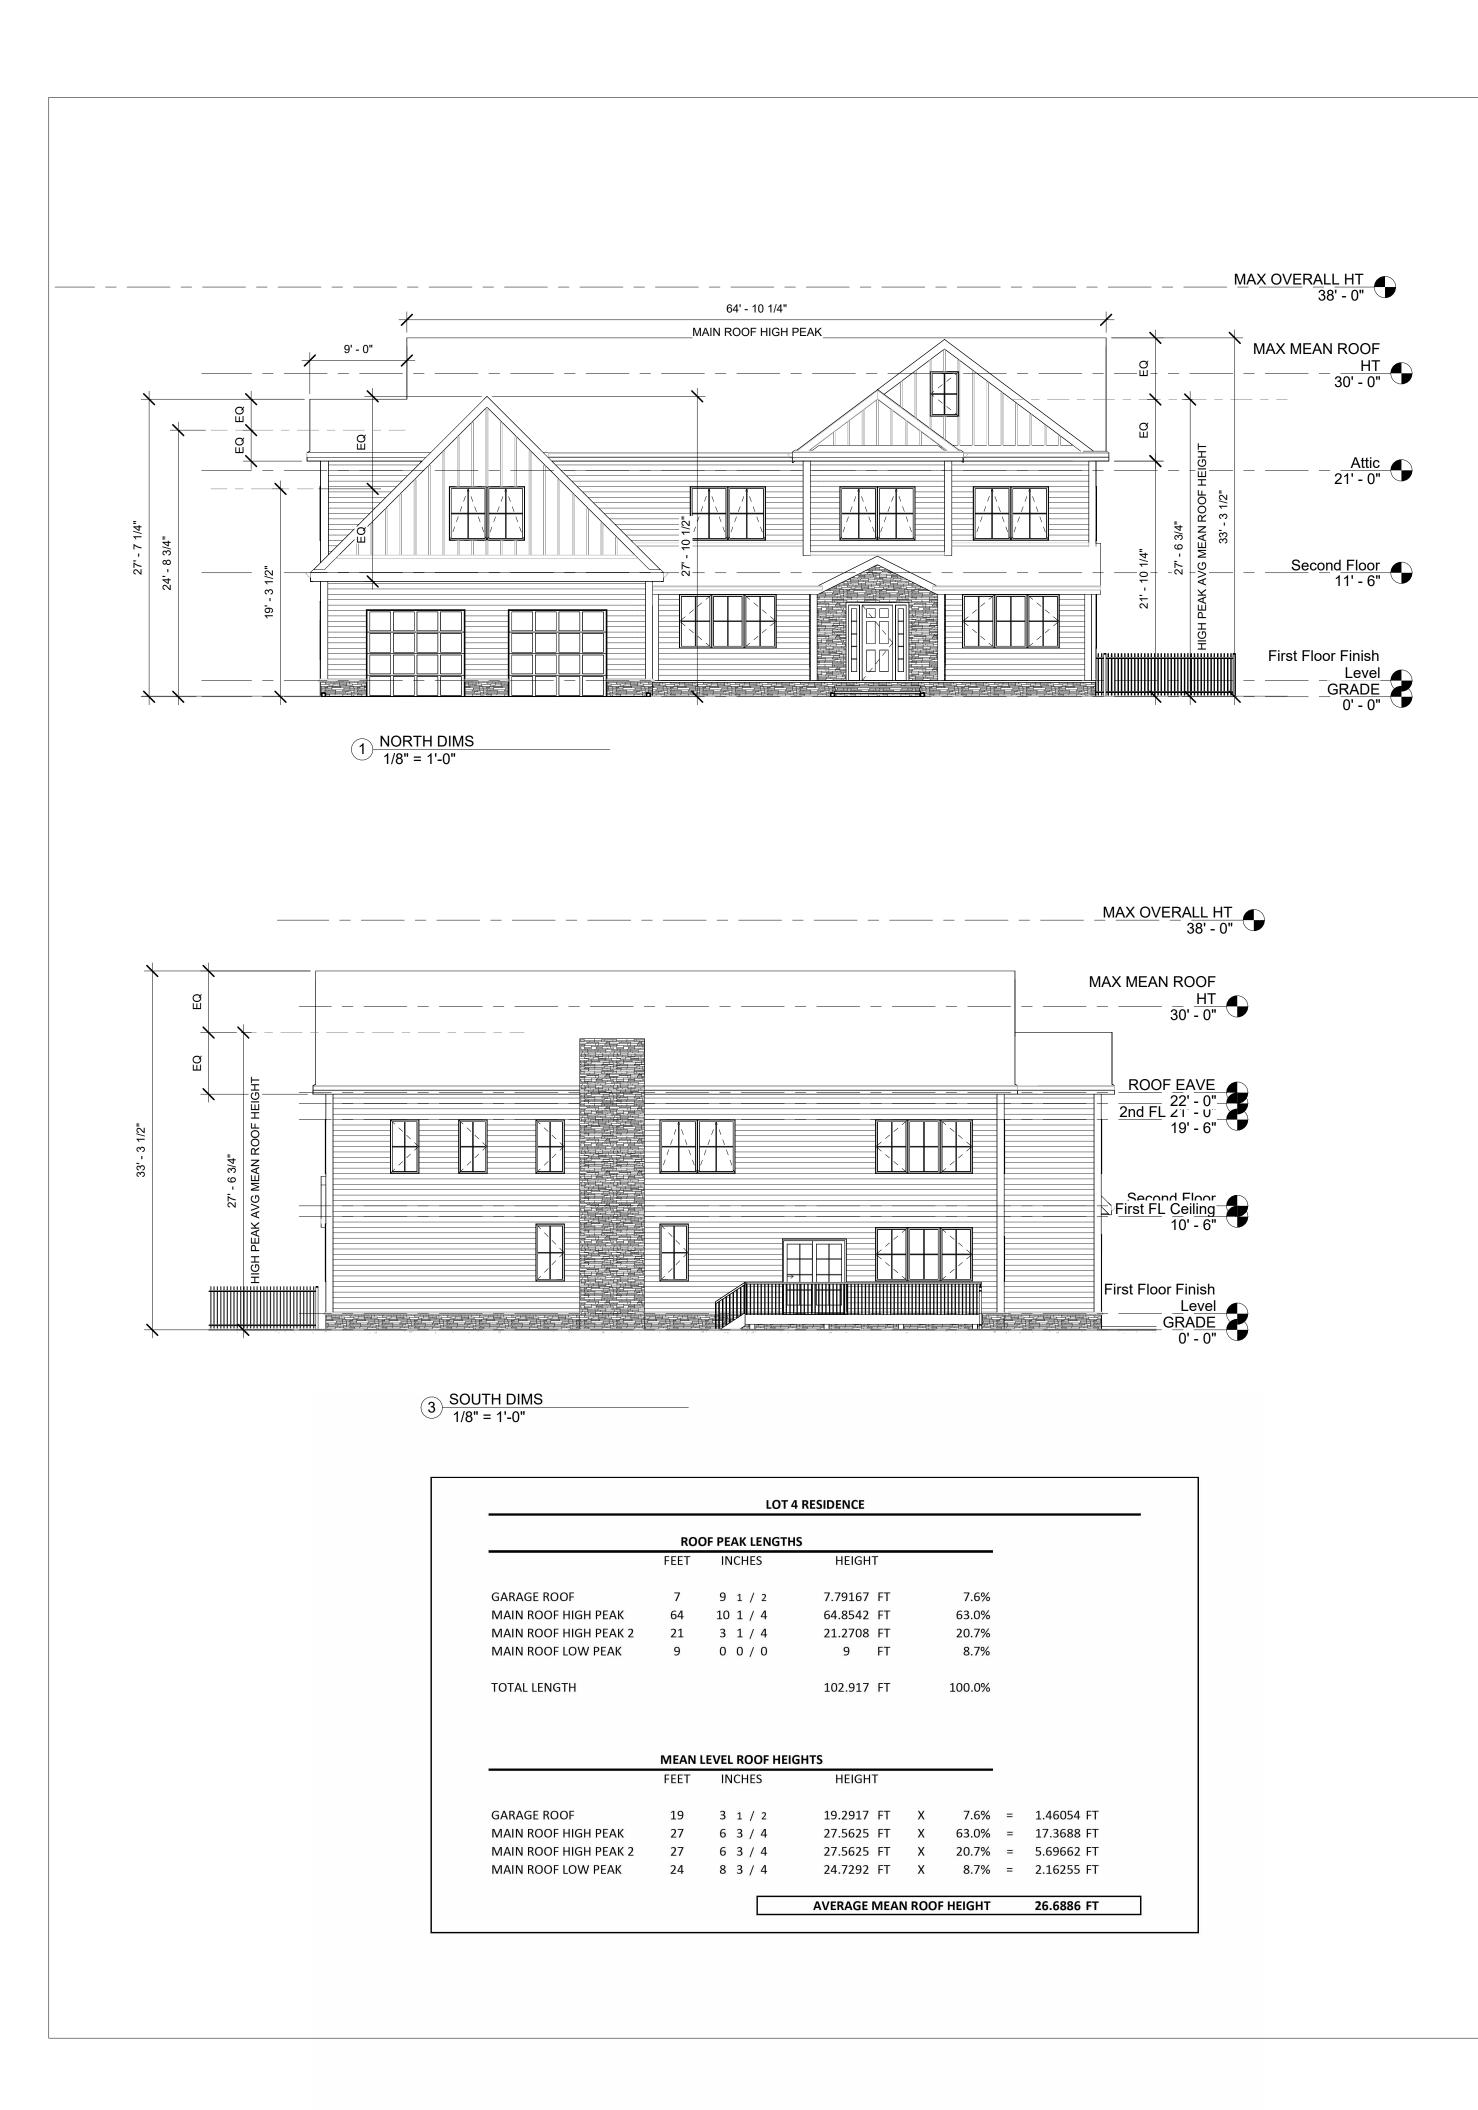

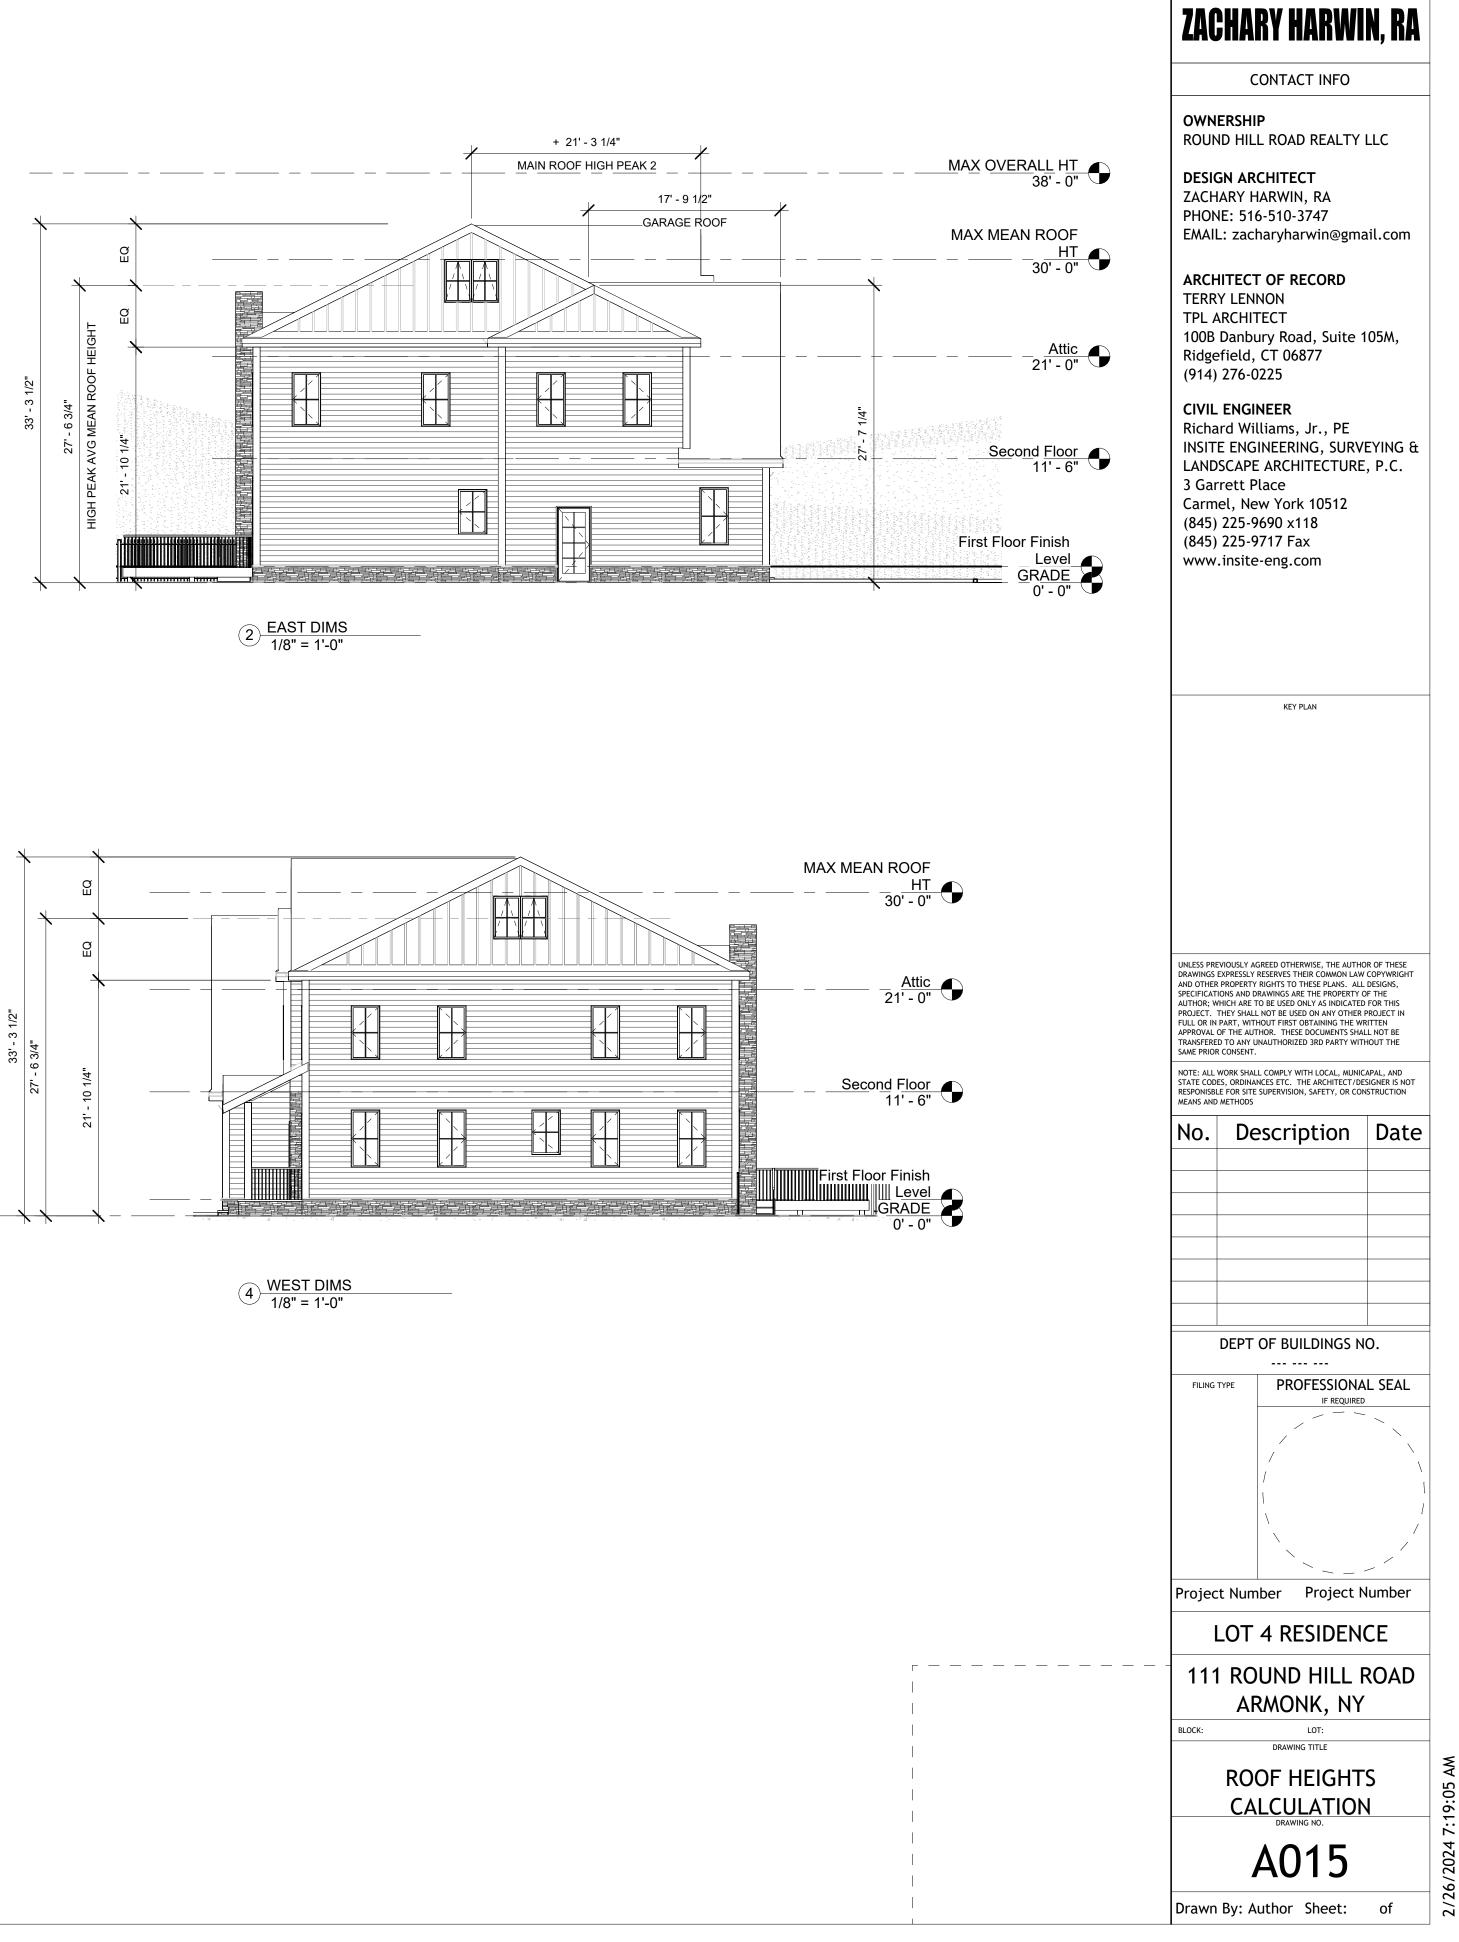

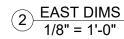

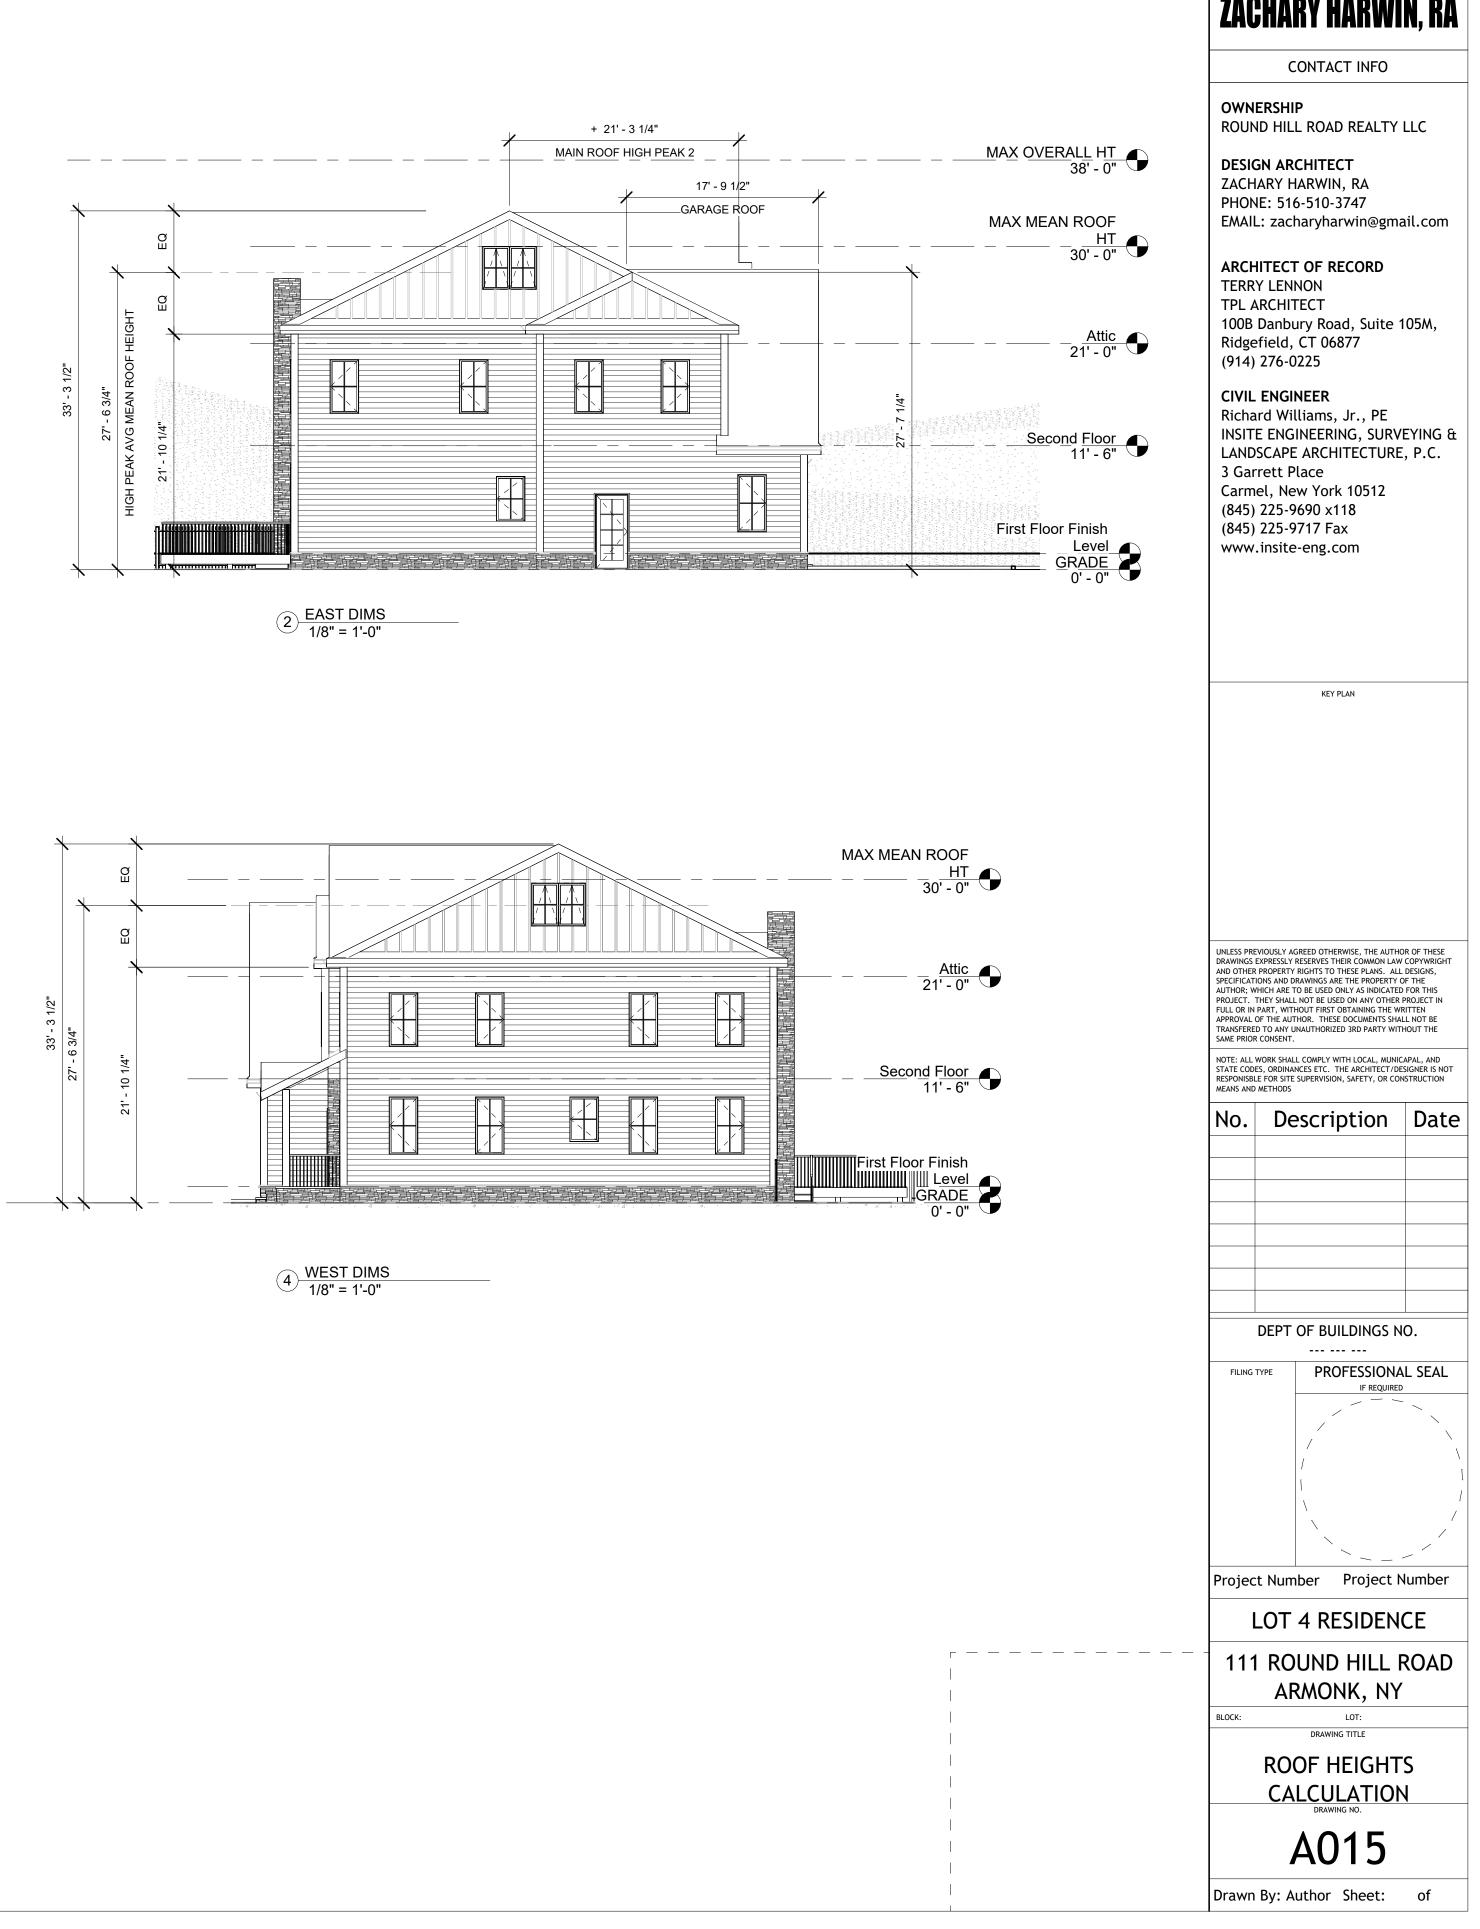

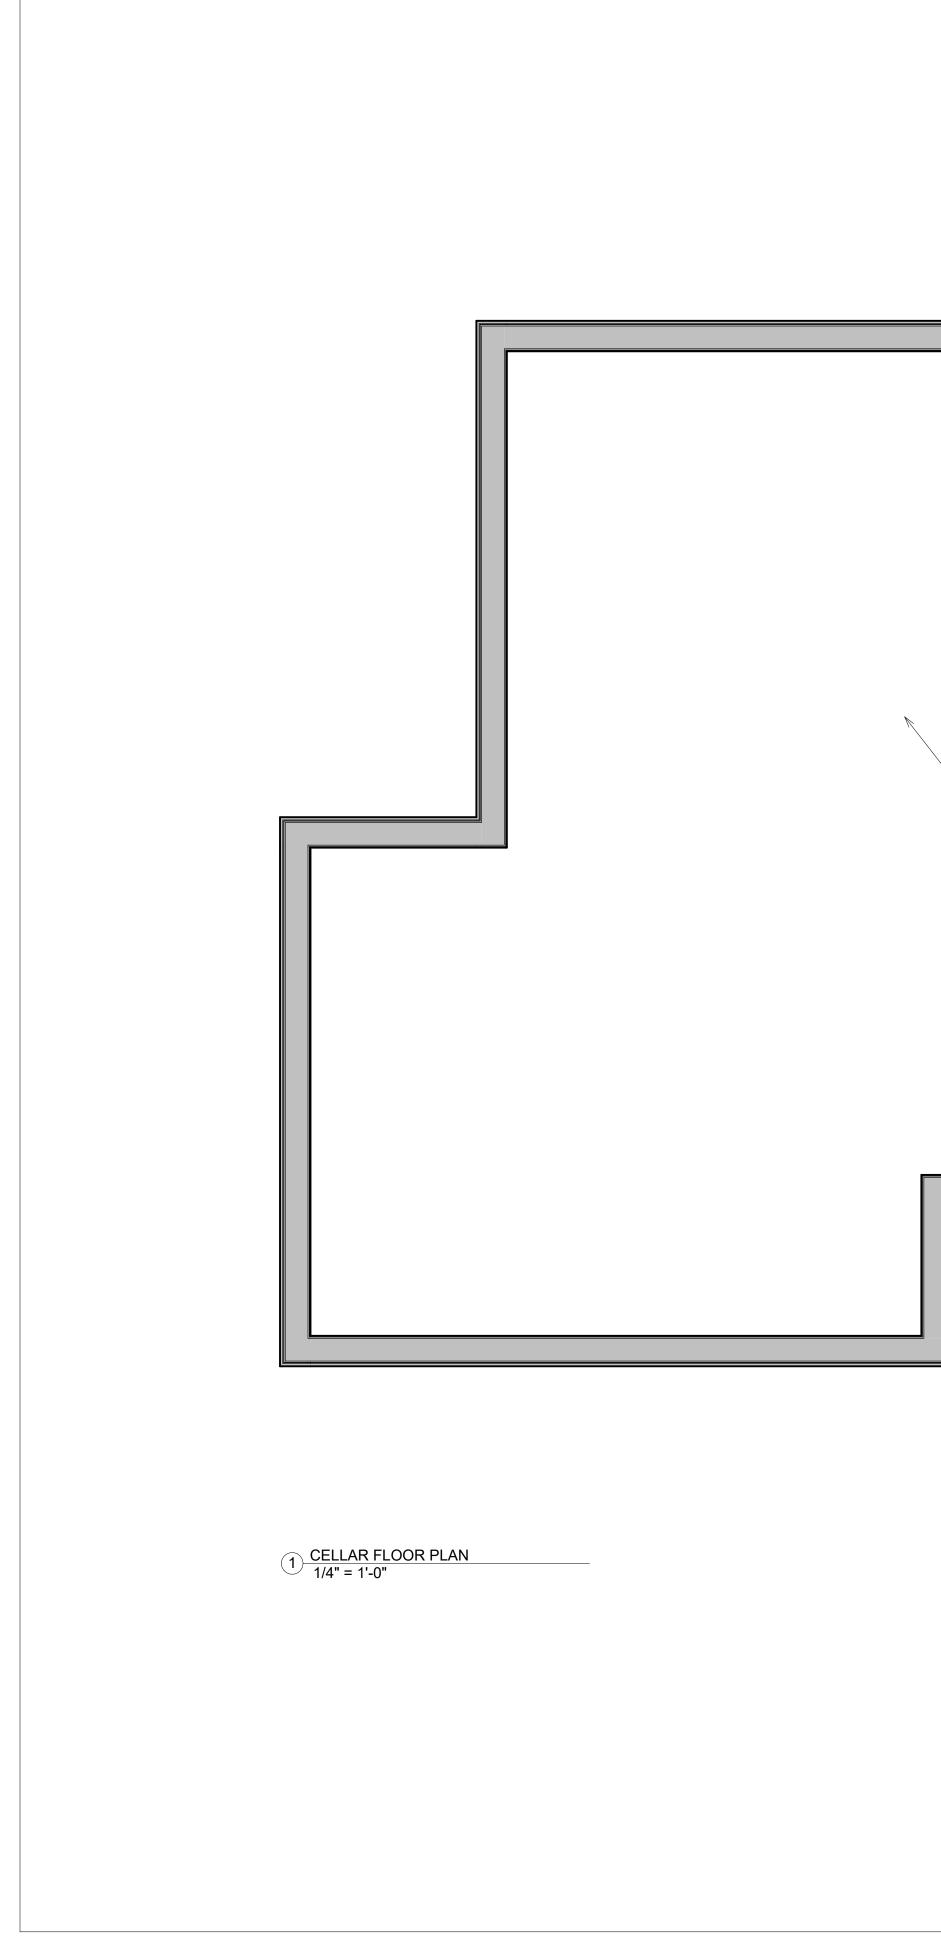

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No. Description Date

DEPT OF BUILDINGS NO.

FILING TYPE PROFESSIONAL SEAL IF REQUIRED

Project Number Project Number

LOT 4 RESIDENCE

111 ROUND HILL ROAD ARMONK, NY


BLOCK: LOT: DRAWING TITLE CELLAR PLAN

DRAWING NO.

A100 Drawn By: Author Sheet: of

N



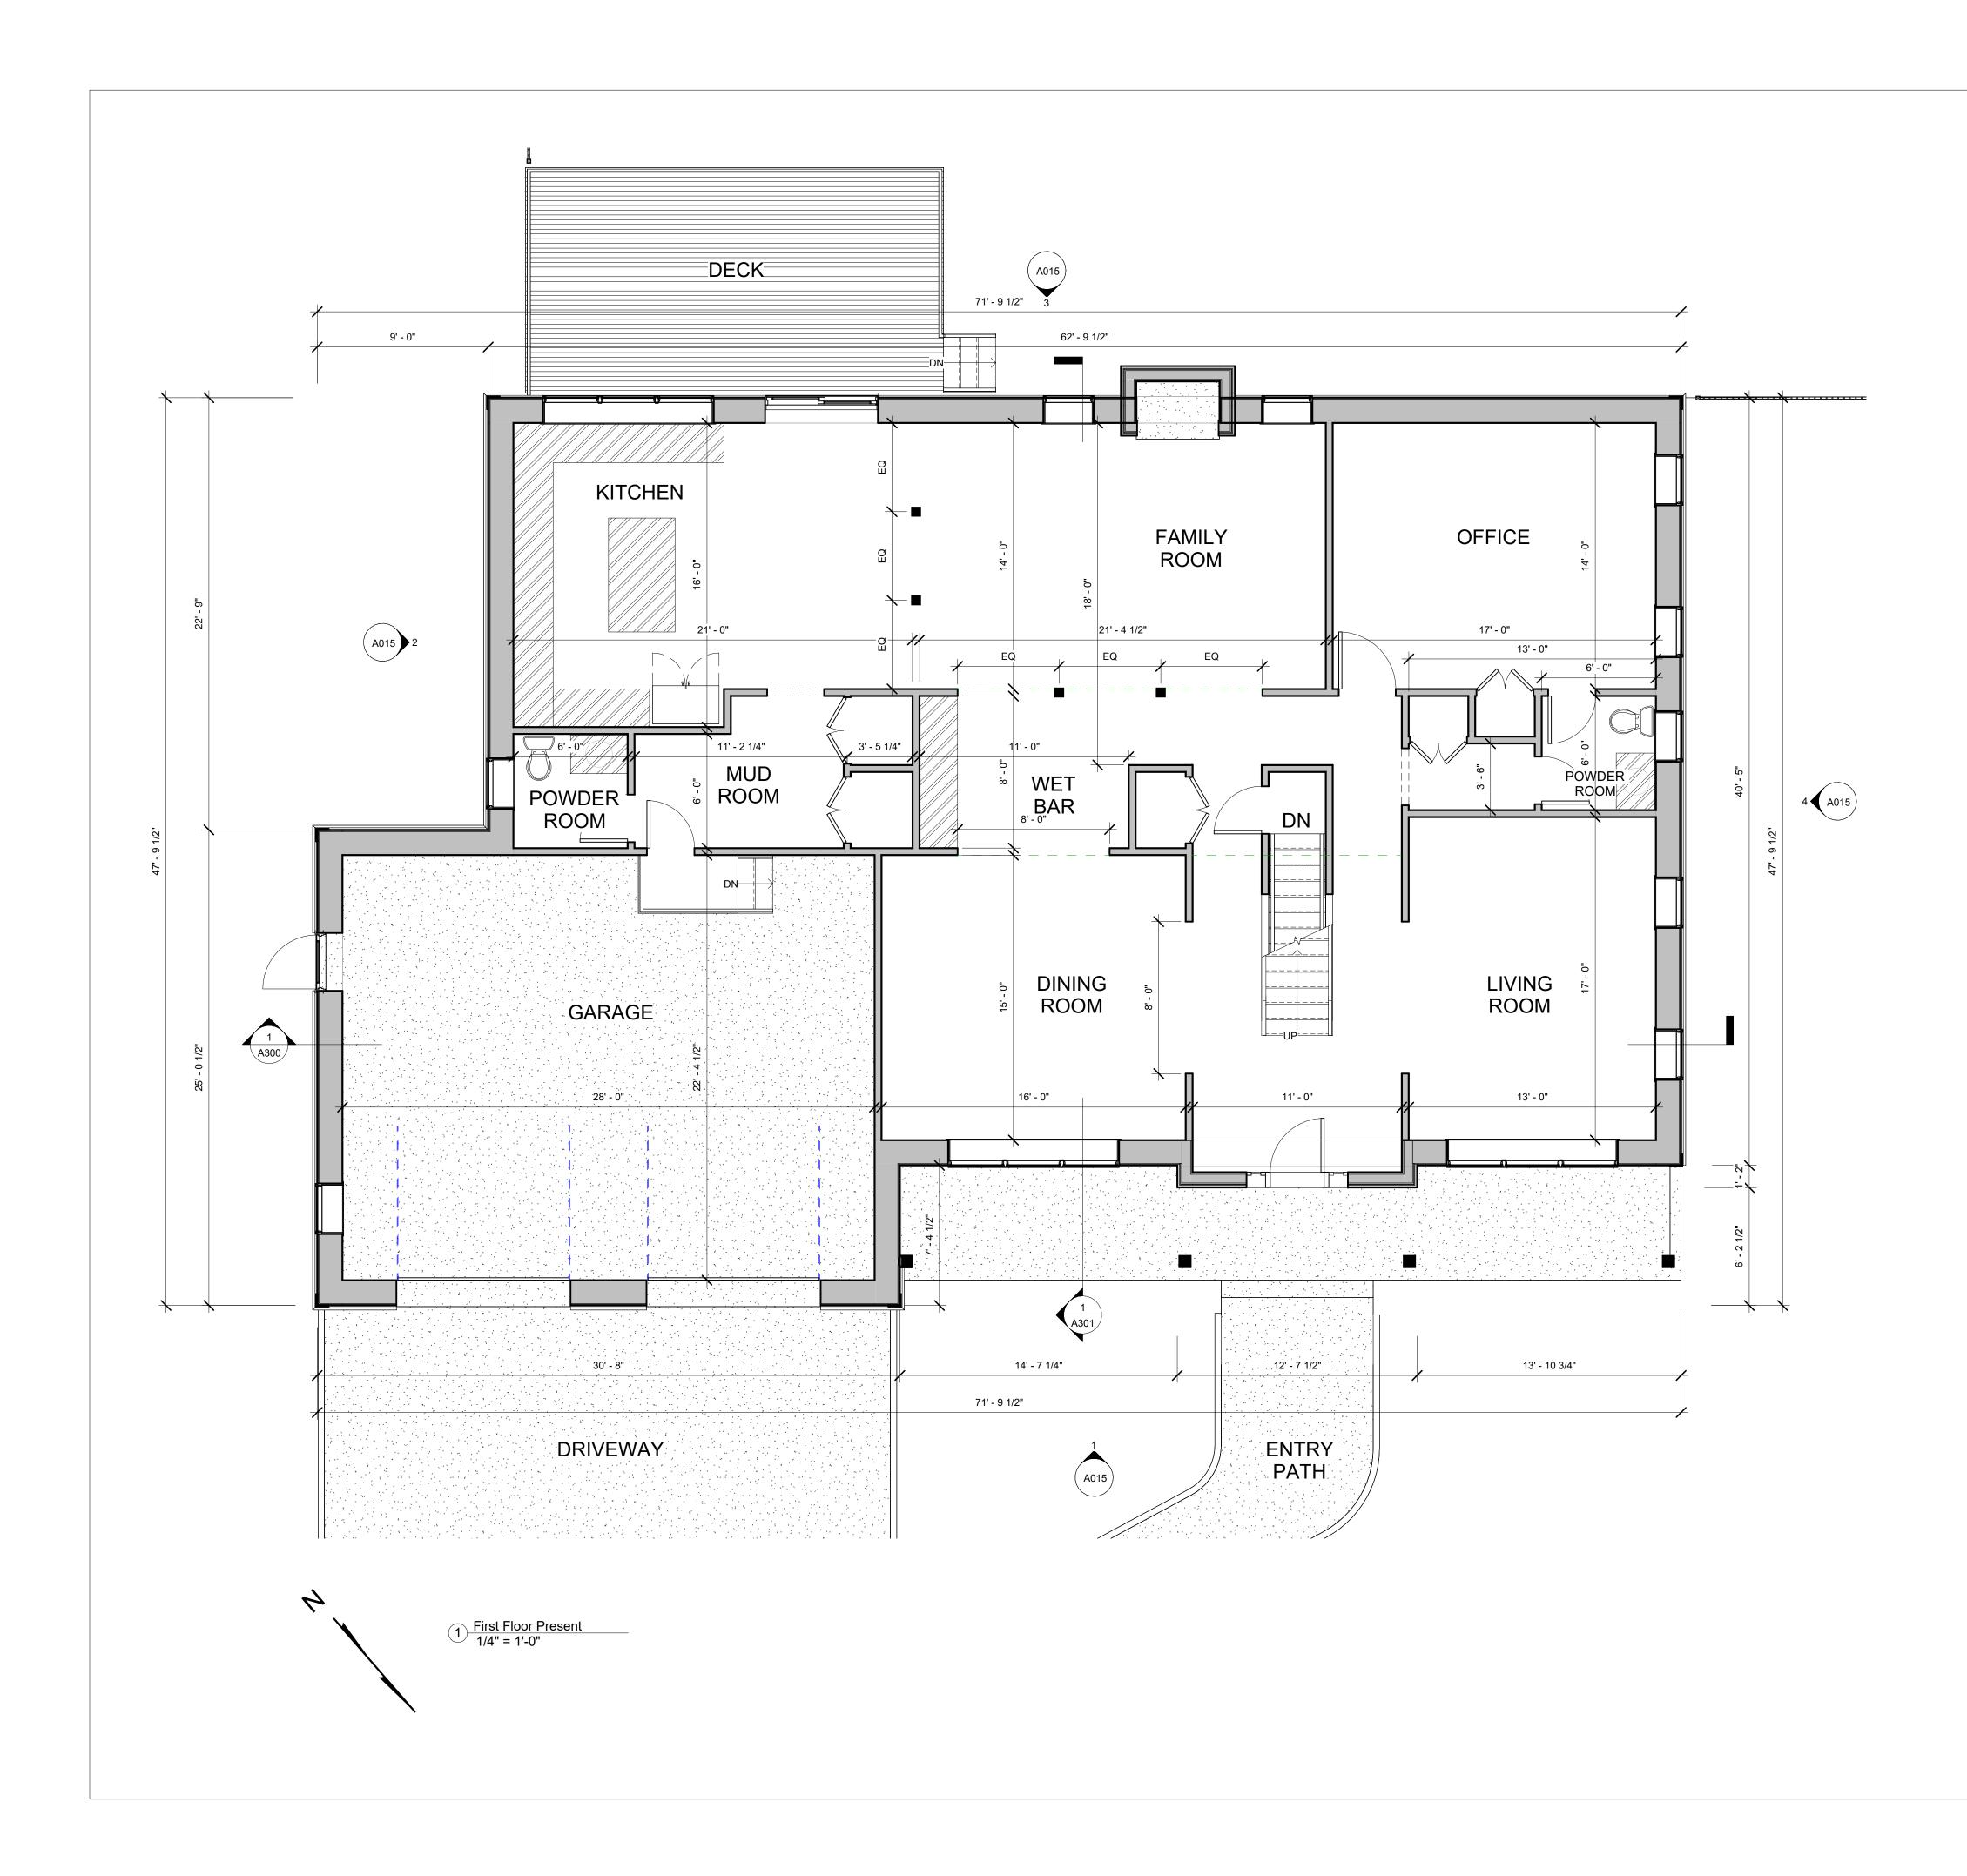

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No. Description Date

DEPT OF BUILDINGS NO.

FILING TYPE PROFESSIONAL SEAL IF REQUIRED

Project Number Project Number


LOT 4 RESIDENCE

111 ROUND HILL ROAD ARMONK, NY

BLOCK: LOT: DRAWING TITLE FIRST FLOOR PLAN DRAWING NO.

A101



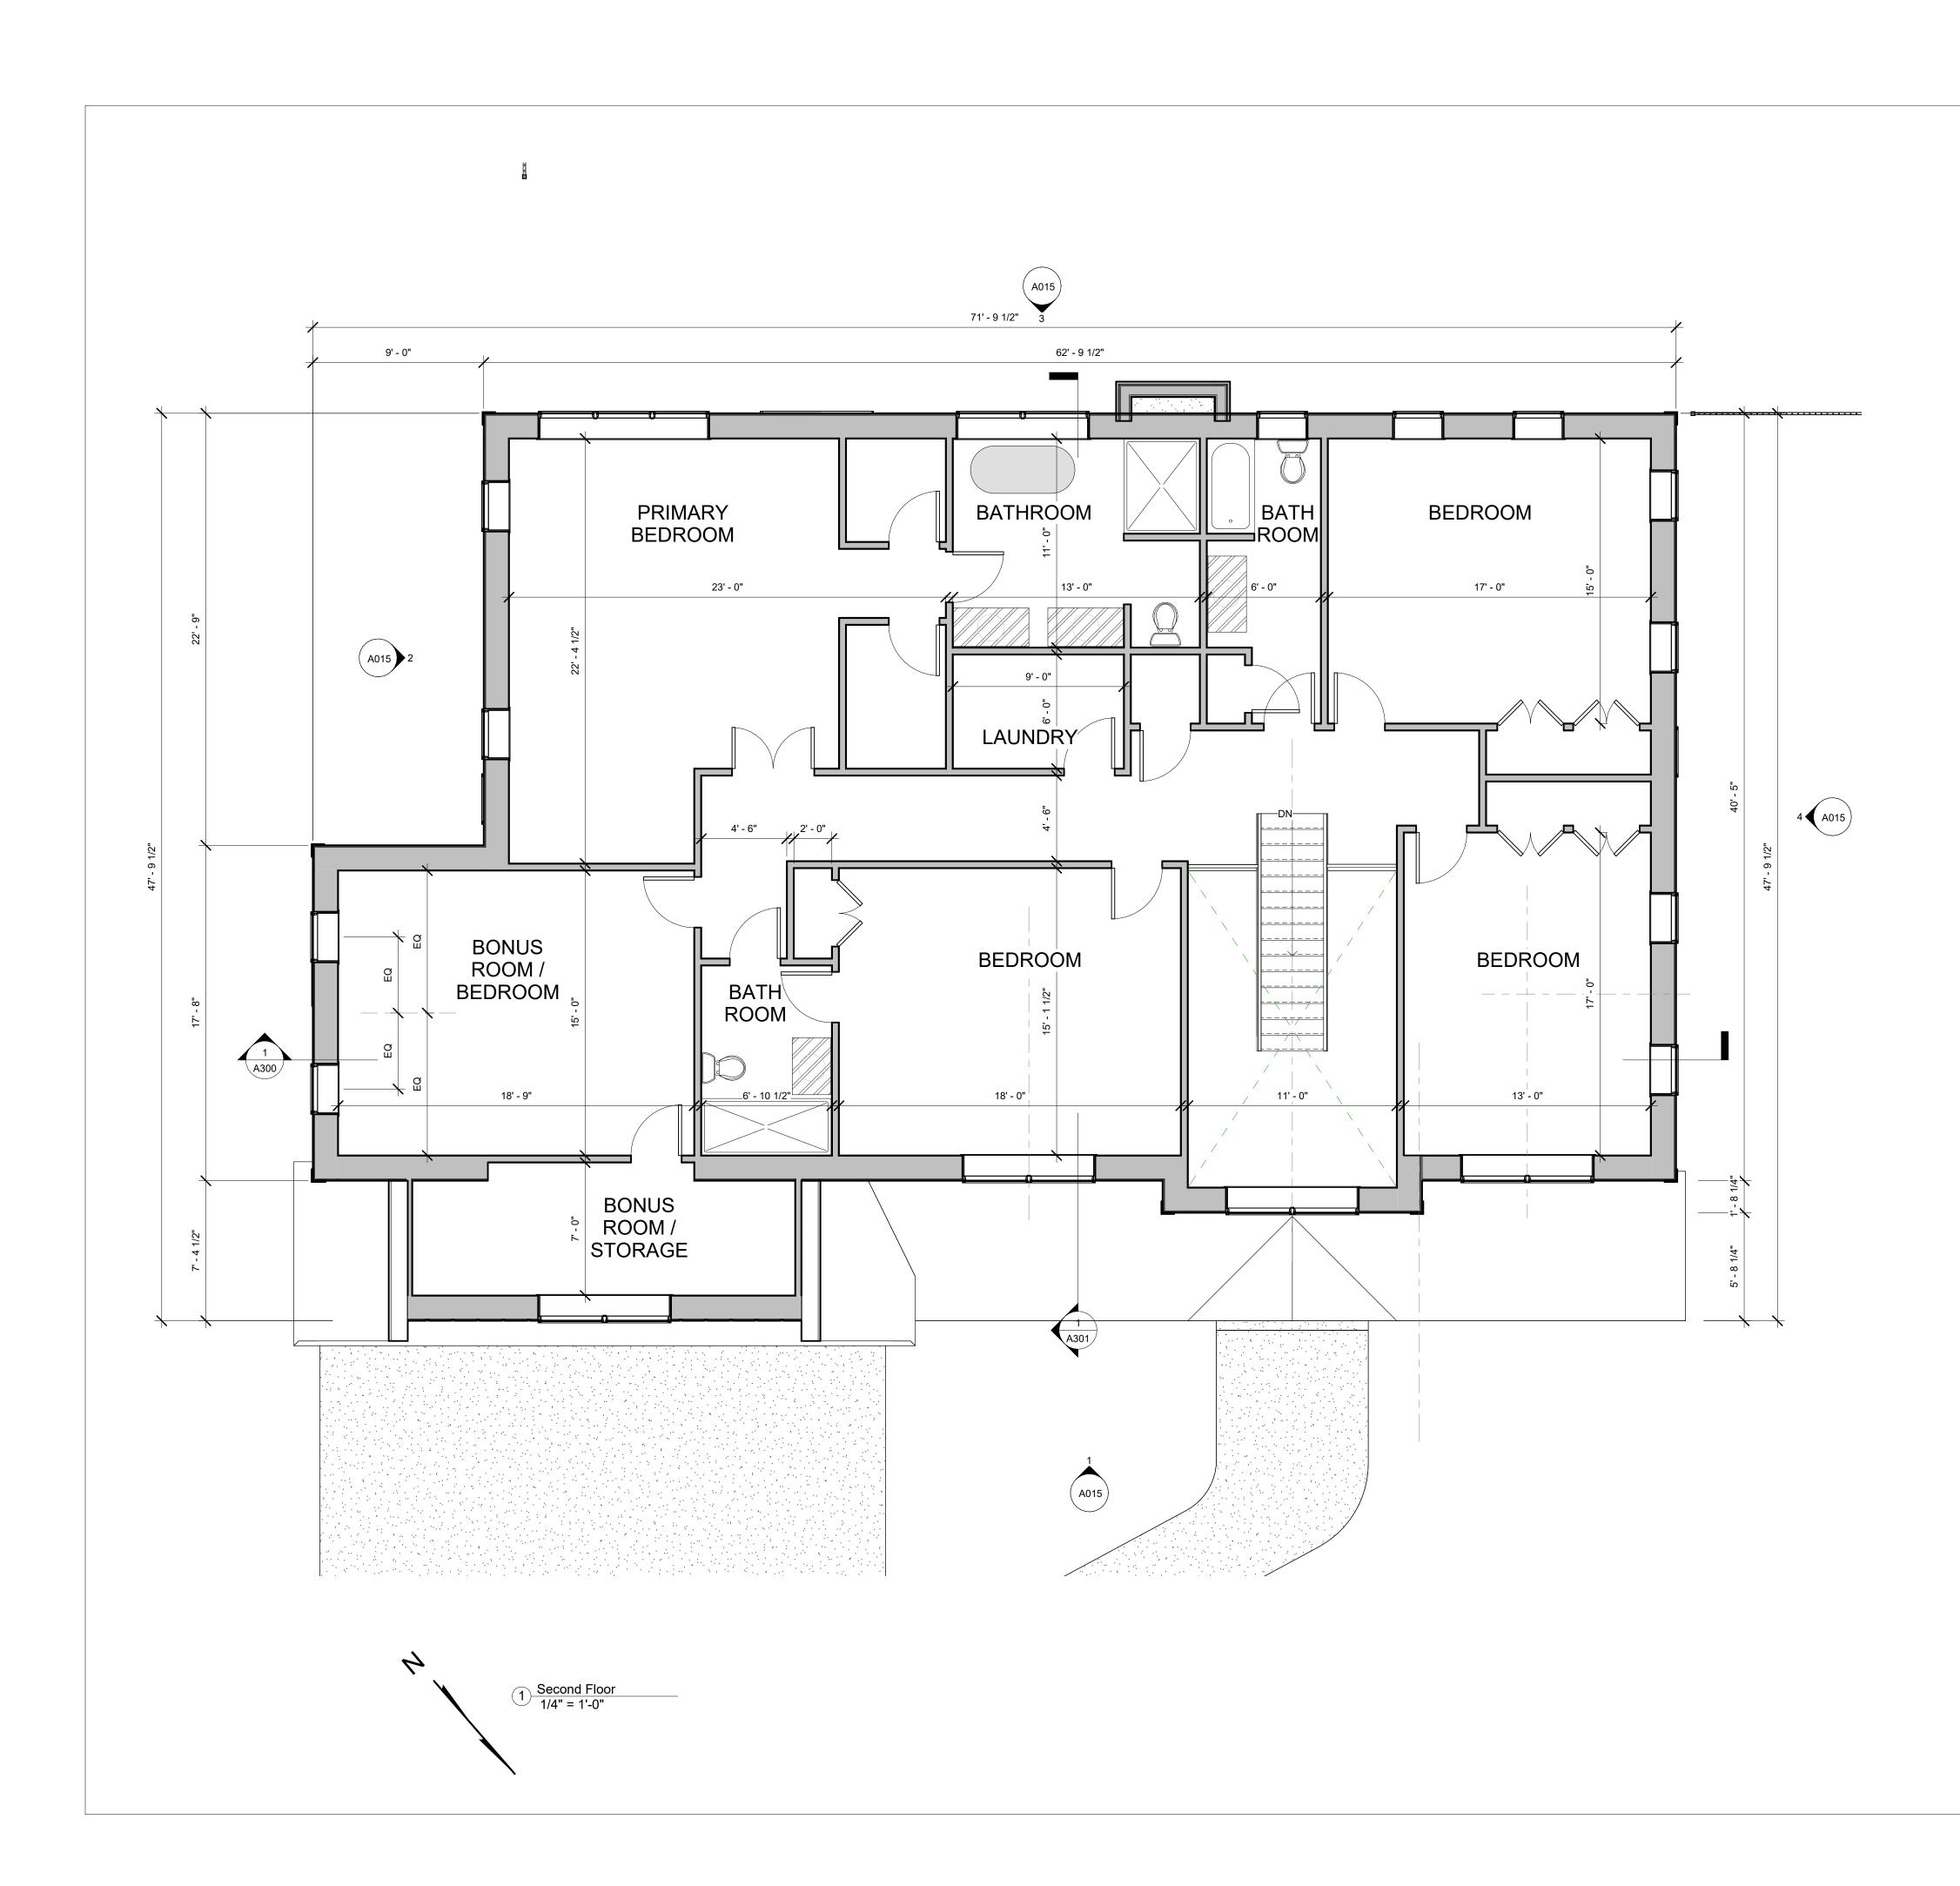

CONTACT INFO

OWNERSHIP ROUND HILL ROAD REALTY LLC

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No. Description Date

DEPT OF BUILDINGS NO.

FILING TYPE PROFESSIONAL SEAL IF REQUIRED


Project Number Project Number

LOT 4 RESIDENCE

111 ROUND HILL ROAD ARMONK, NY

DRAWING TITLE SECOND FLOOR PLAN DRAWING NO. A102



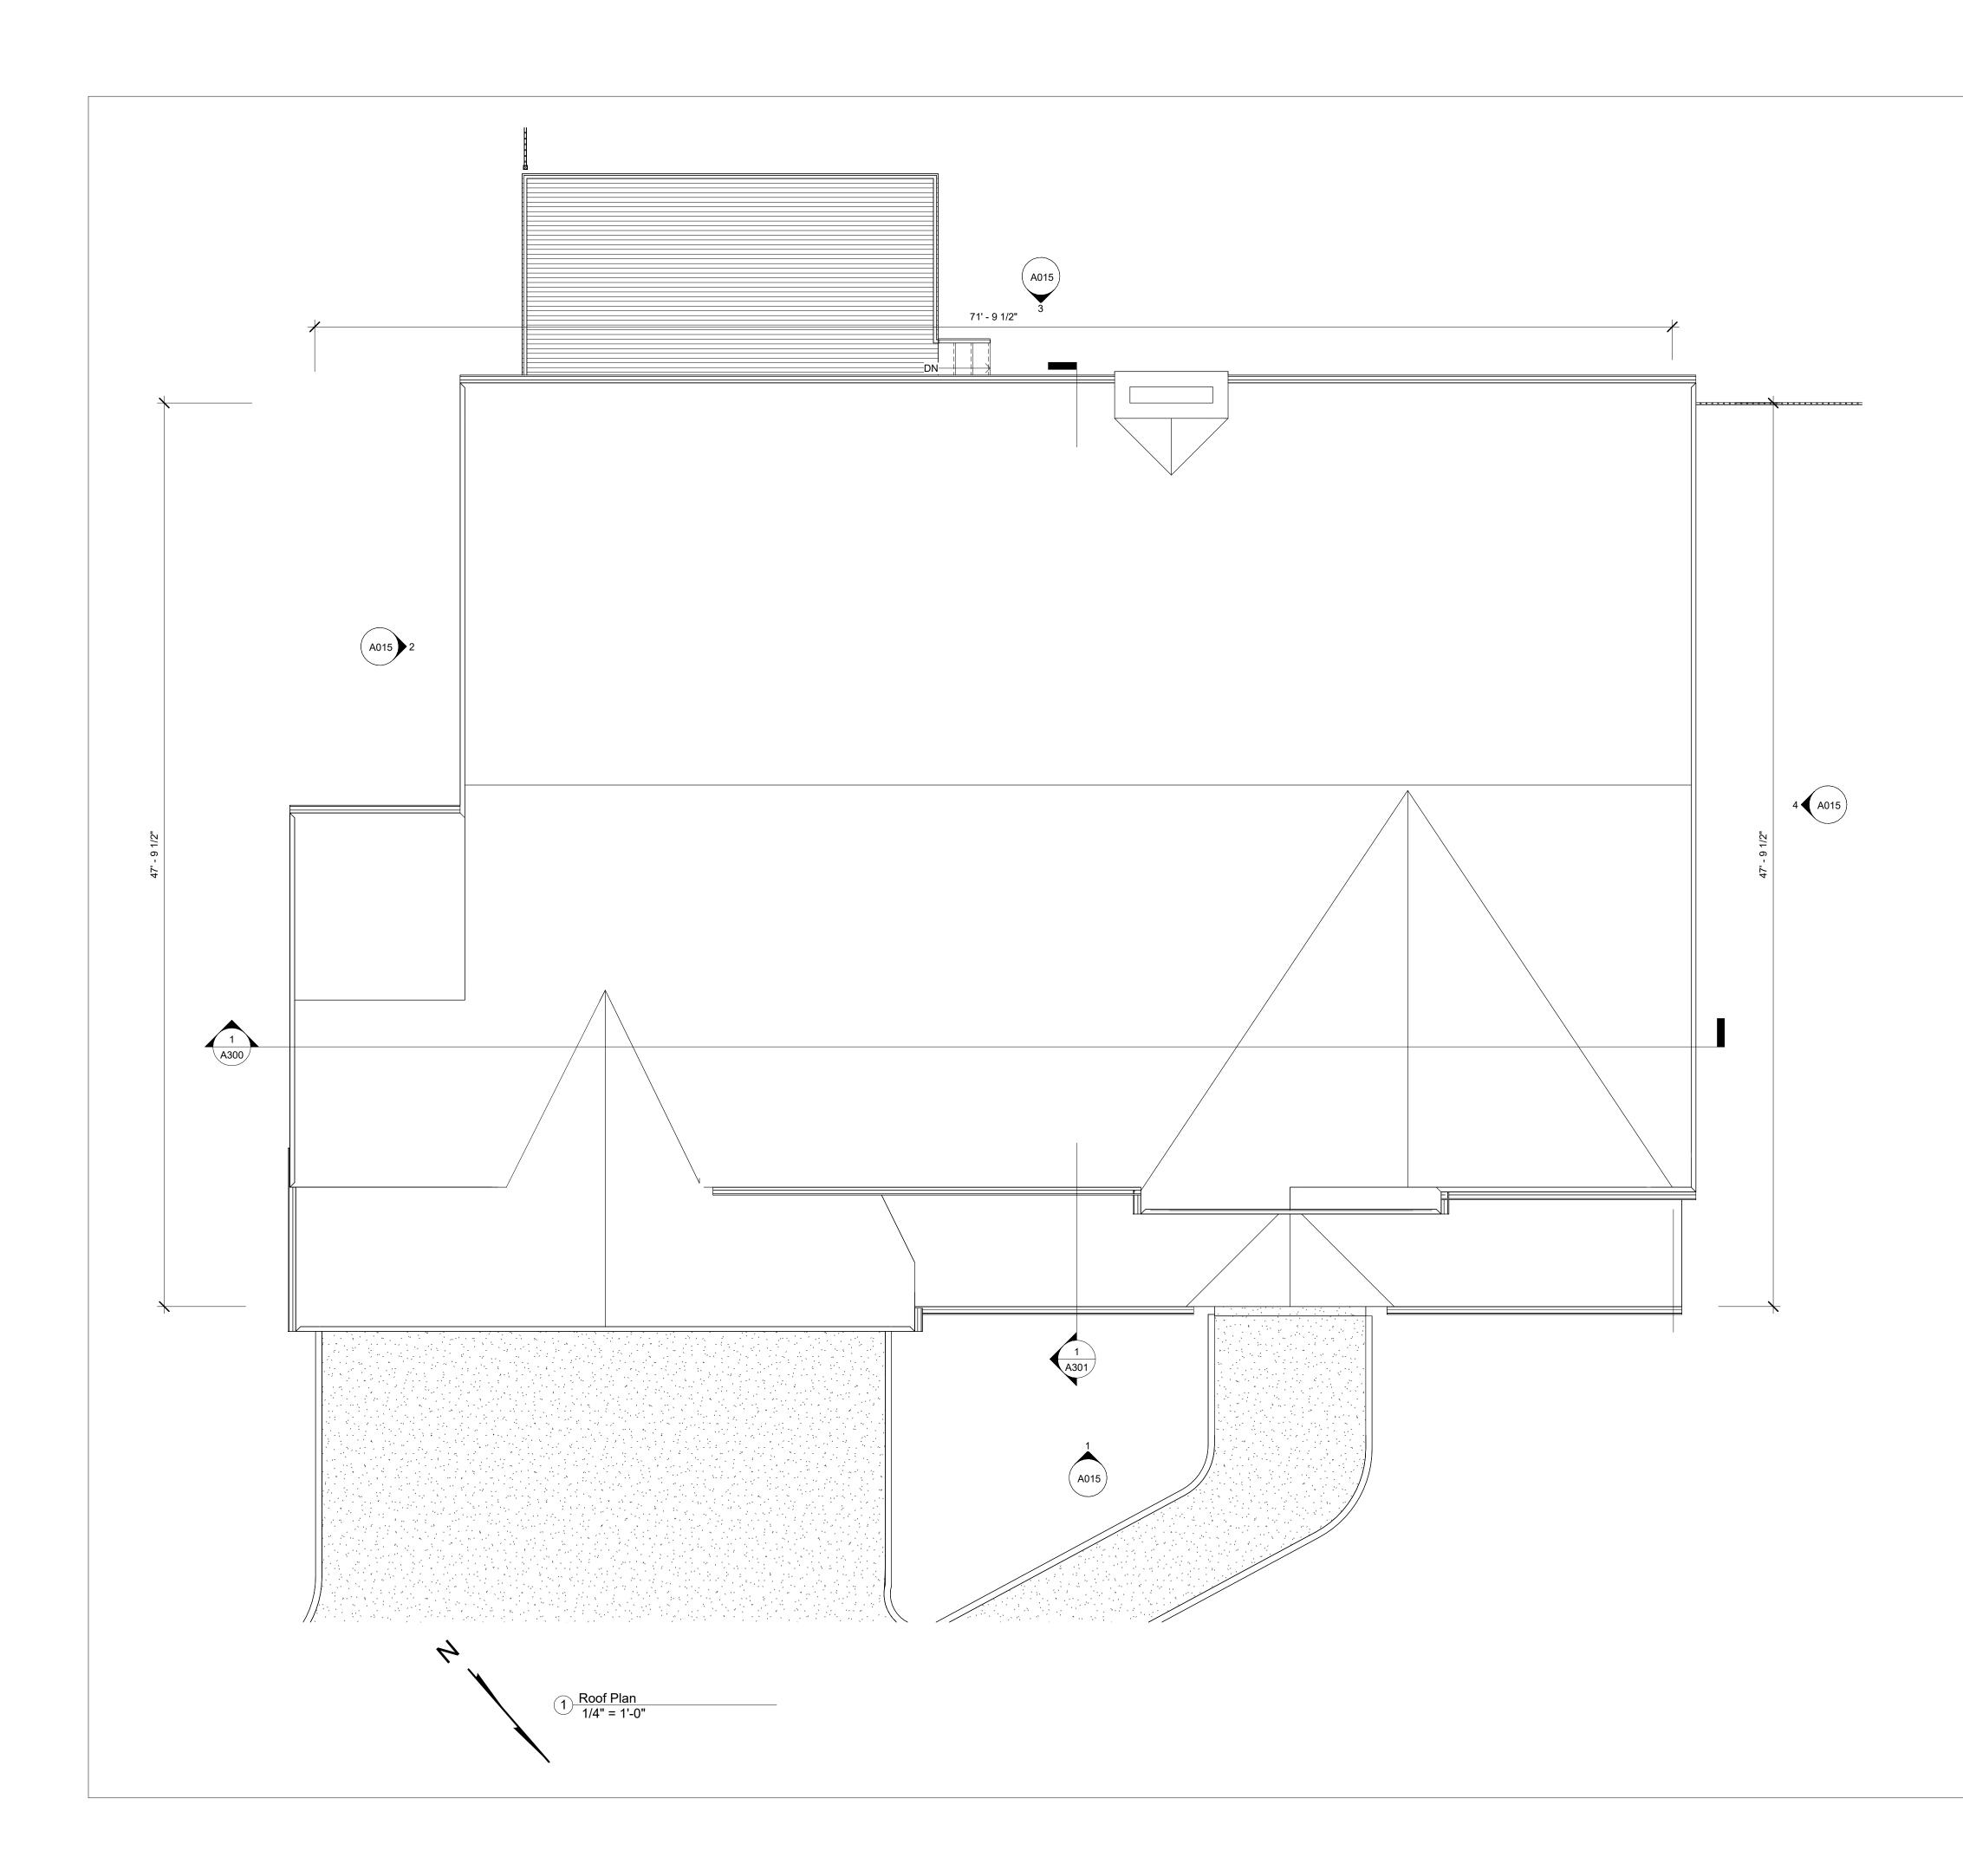

CONTACT INFO

OWNERSHIP ROUND HILL ROAD REALTY LLC

DESIGN ARCHITECT ZACHARY HARWIN, RA PHONE: 516-510-3747 EMAIL: zacharyharwin@gmail.com

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No. Description Date

DEPT OF BUILDINGS NO. ---- ----

PROFESSIONAL SEAL FILING TYPE IF REQUIRED

Project Number Project Number


LOT 4 RESIDENCE

111 ROUND HILL ROAD ARMONK, NY LOT:


BLOCK:


DRAWING TITLE ROOF PLAN DRAWING NO.


A104 Drawn By: Author Sheet: of

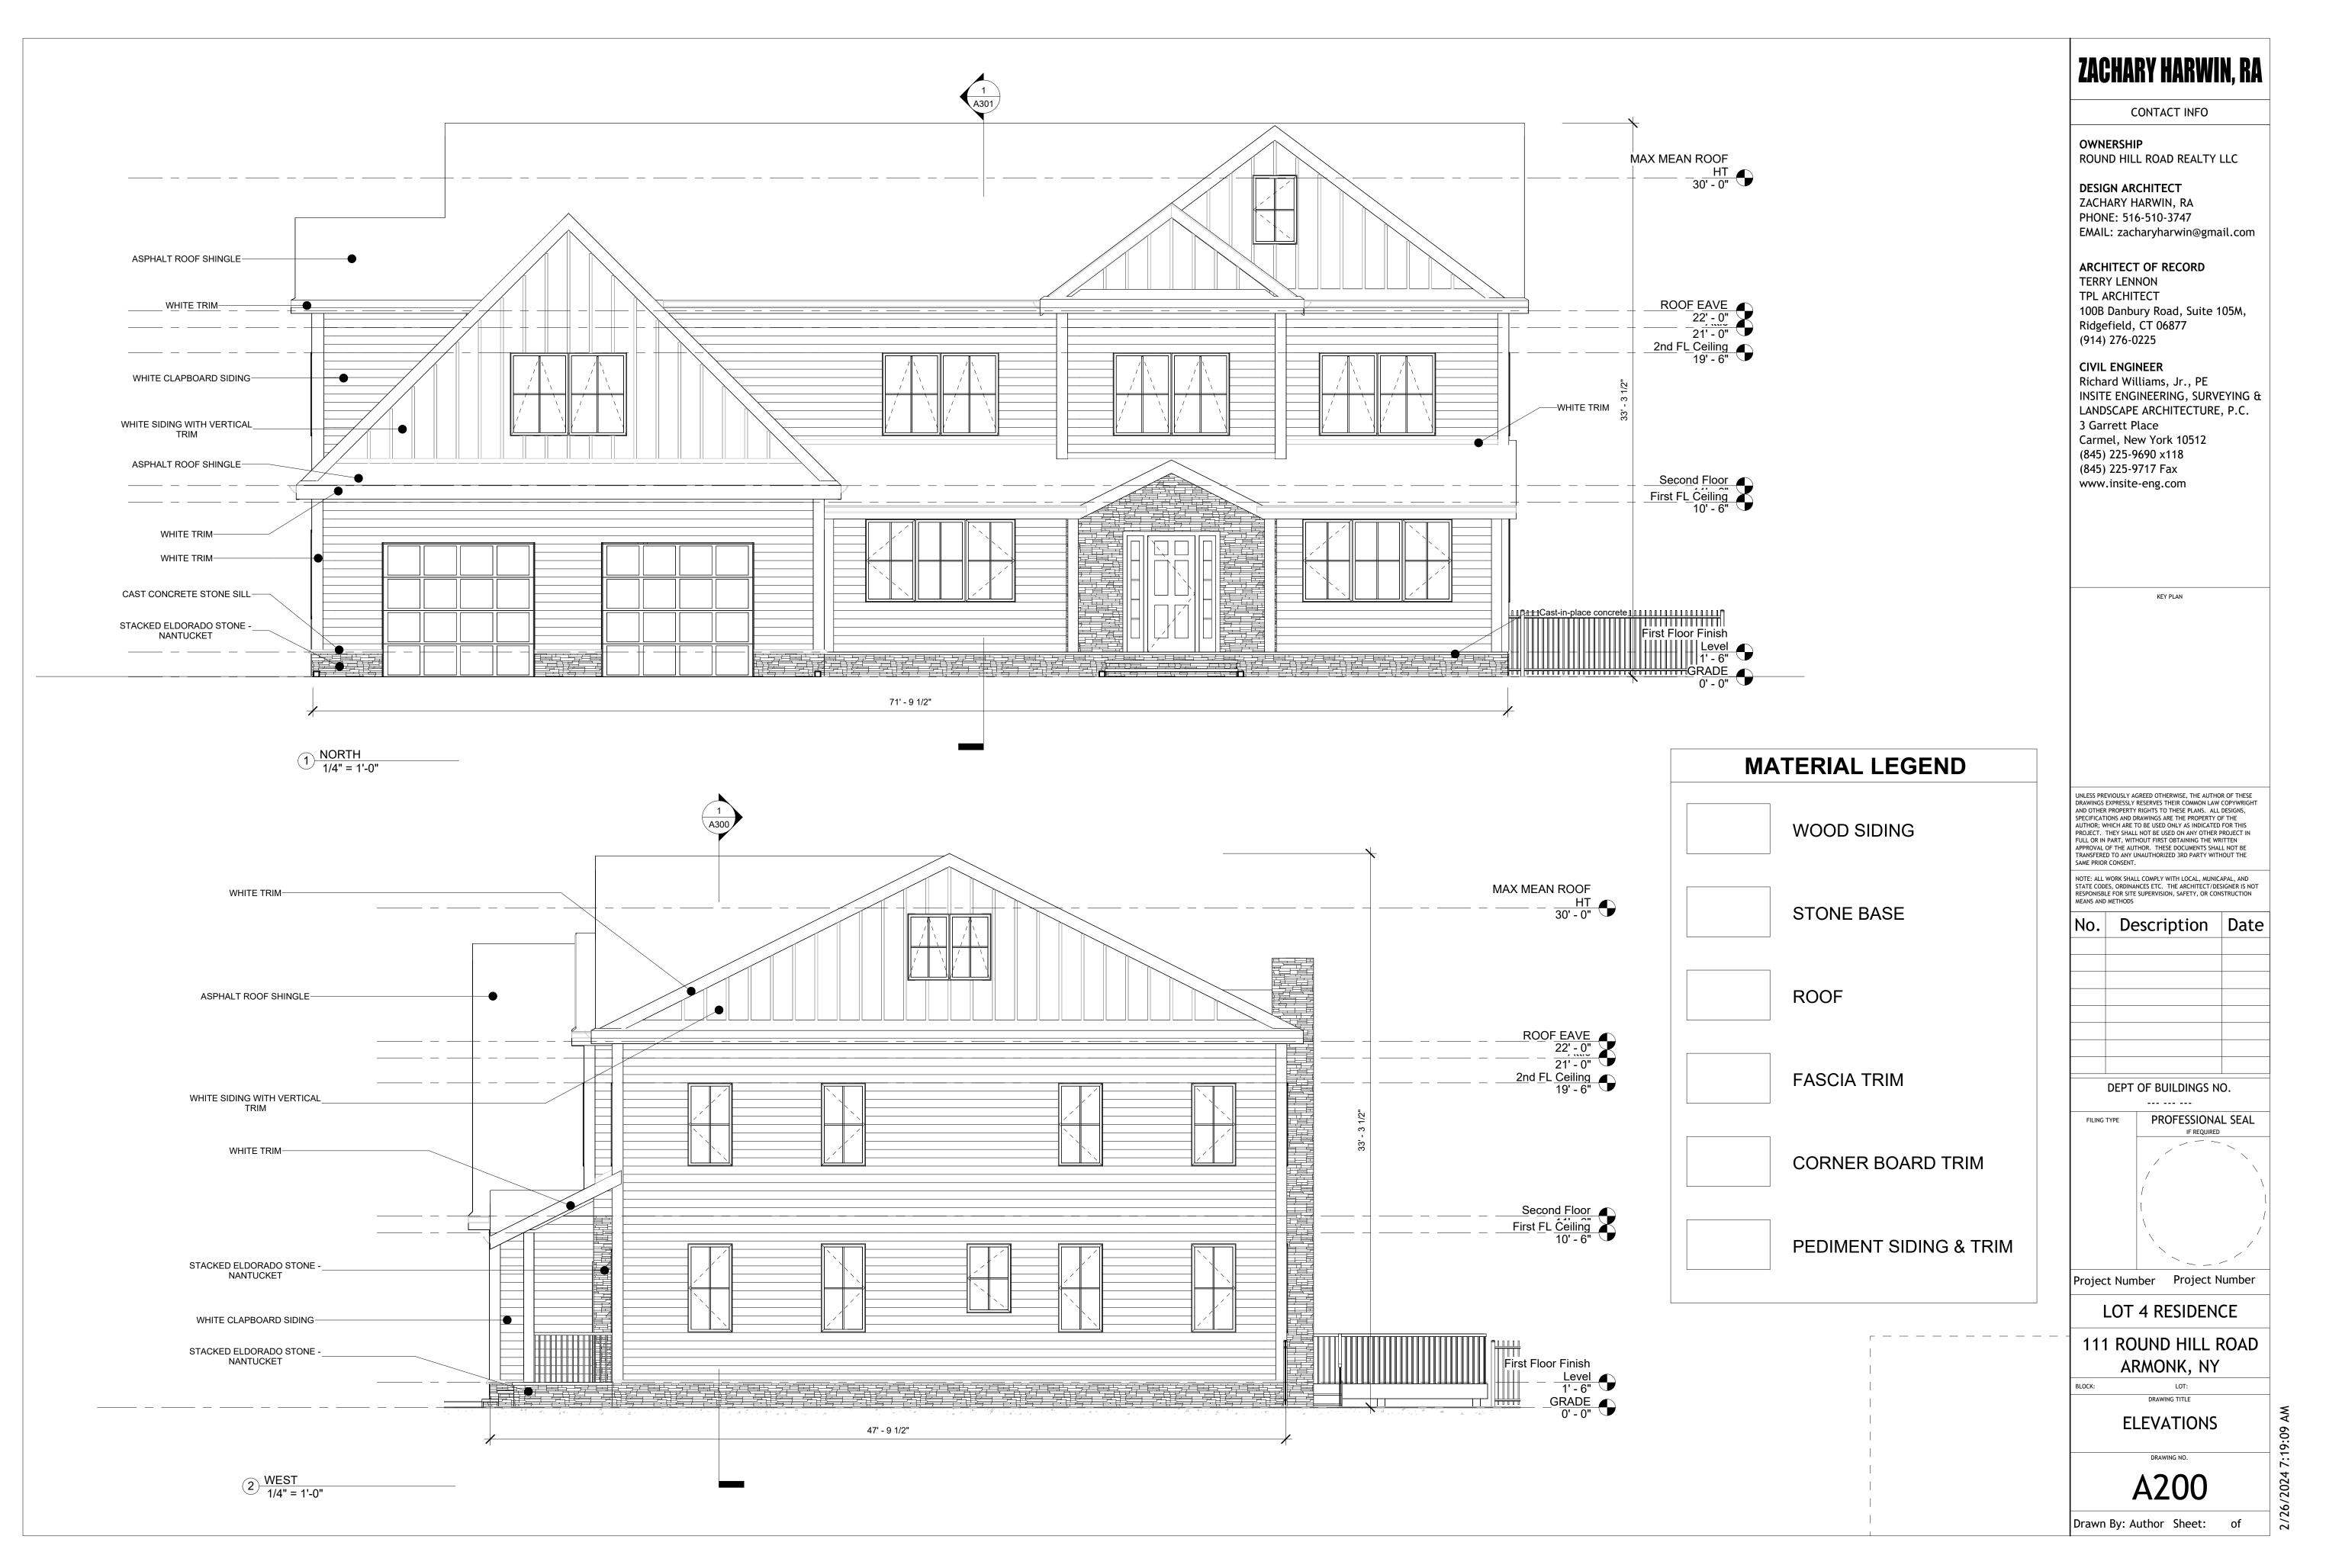



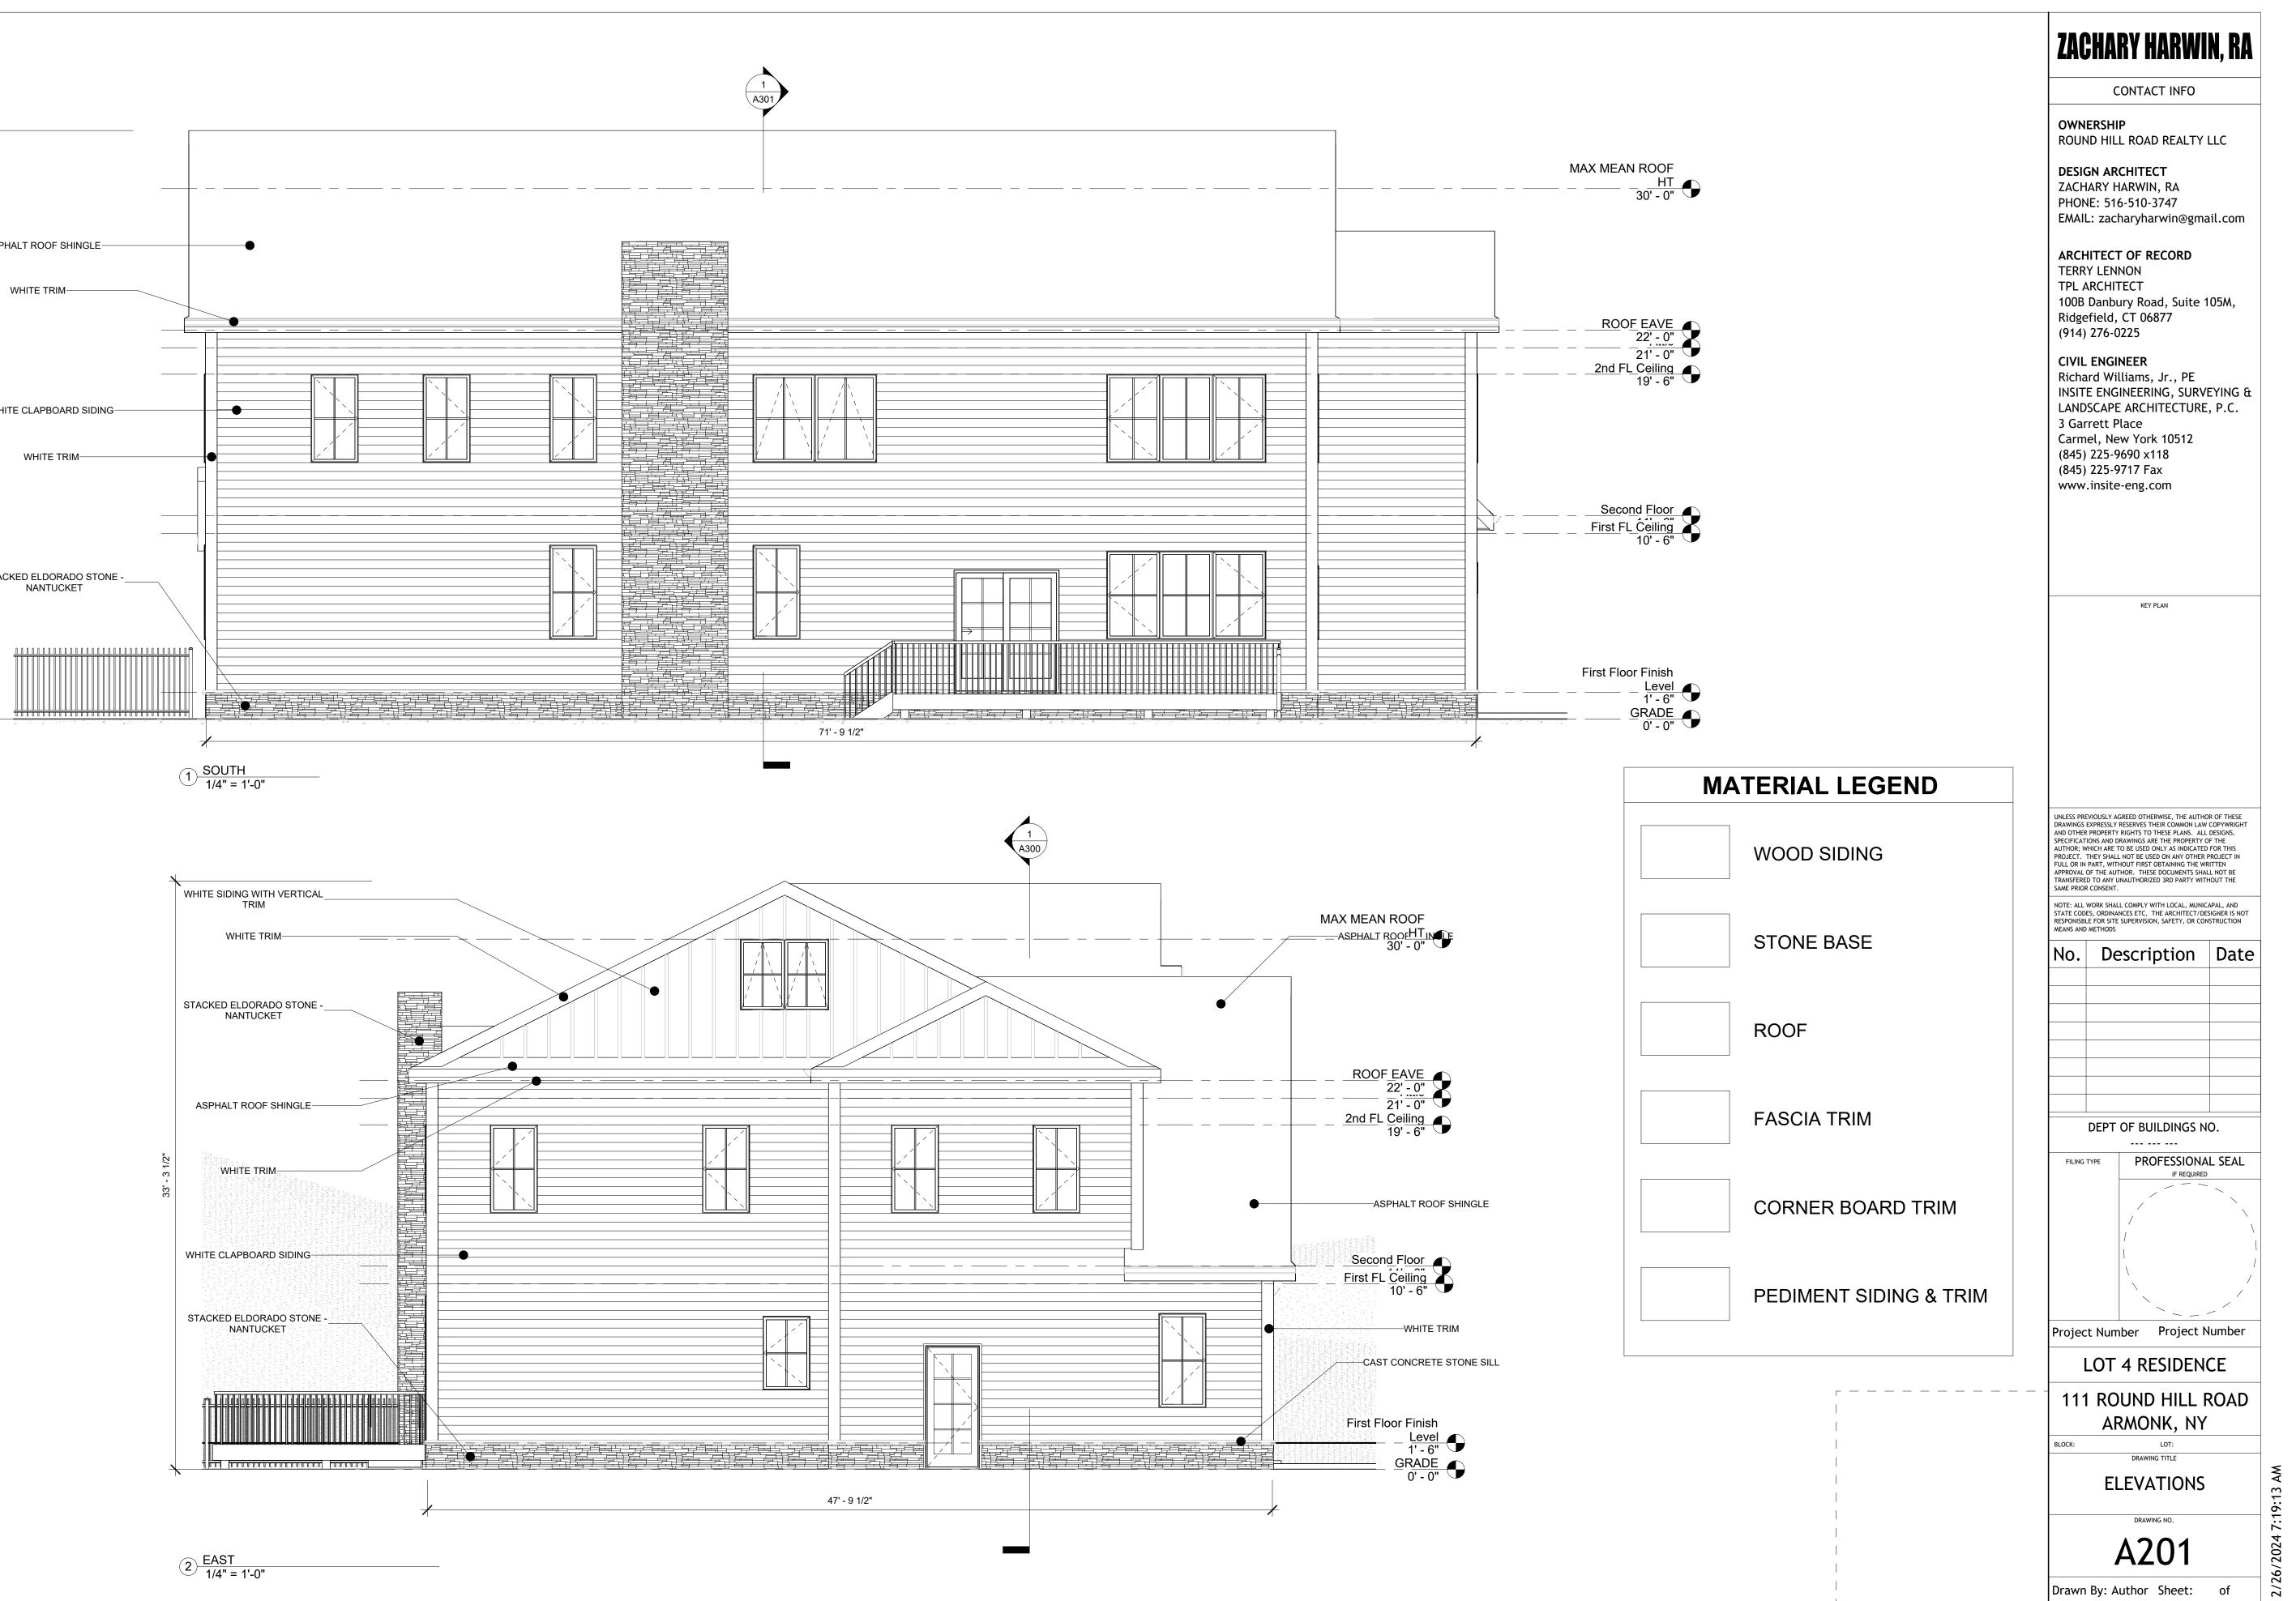


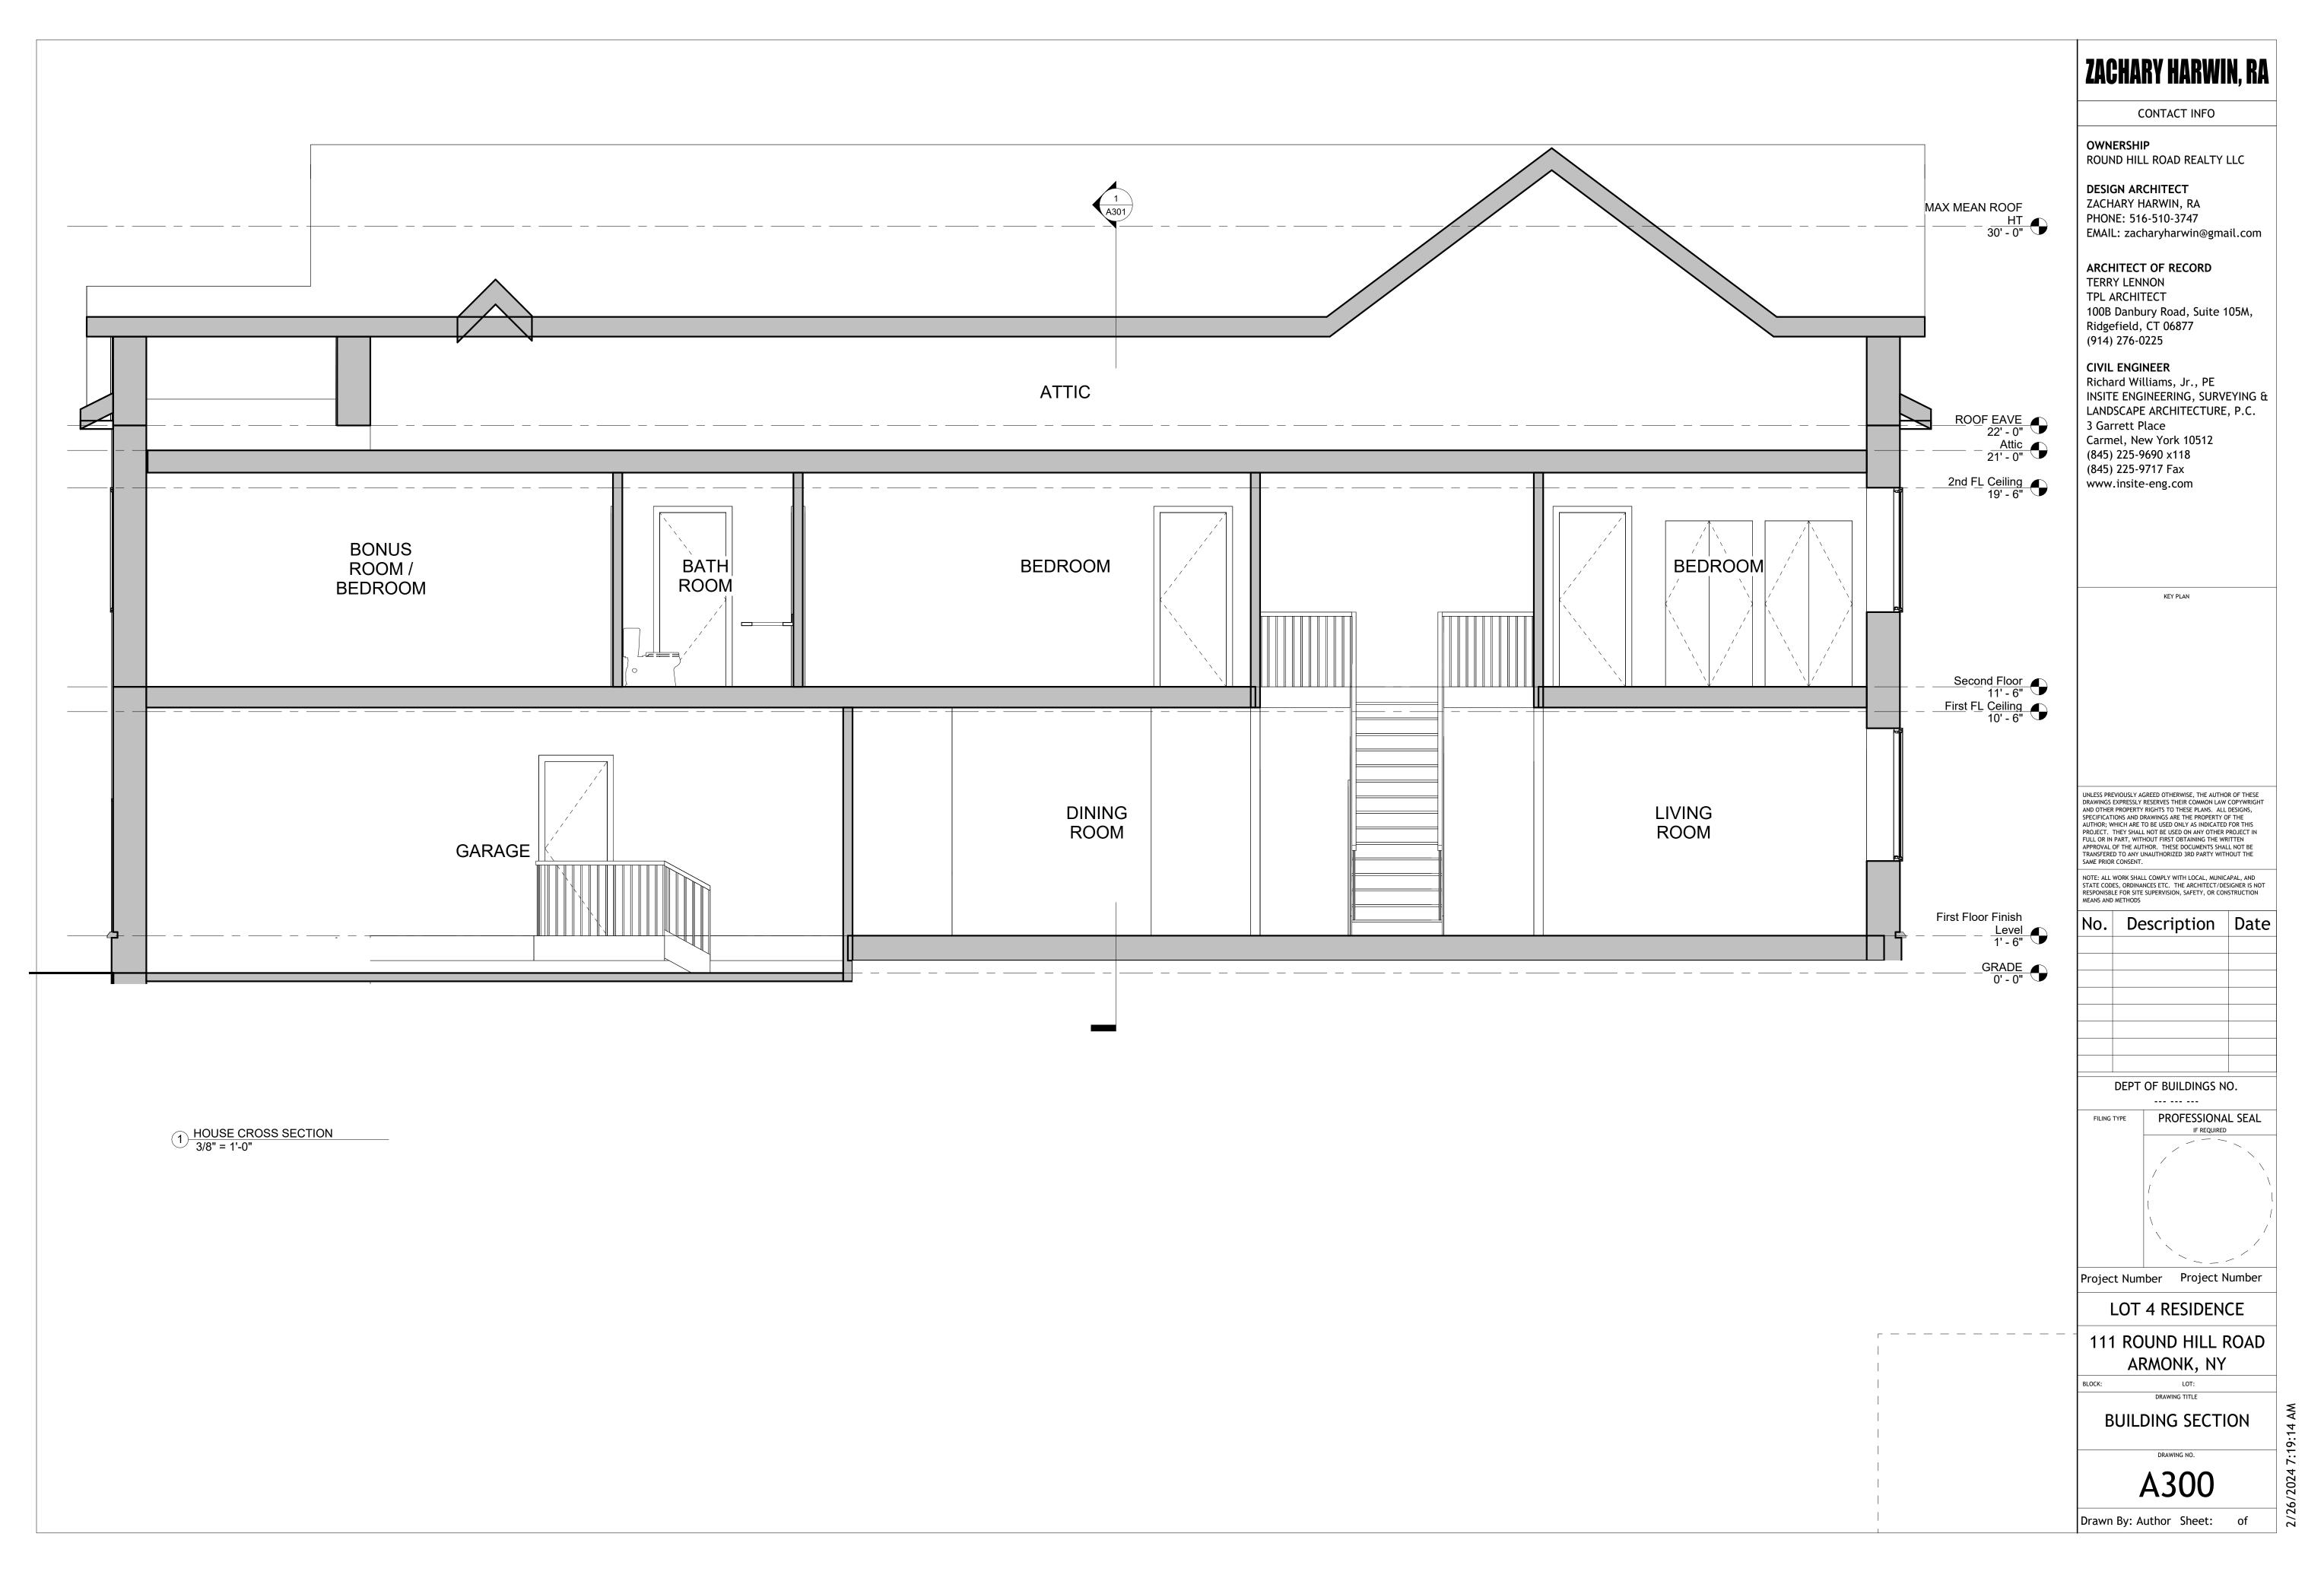

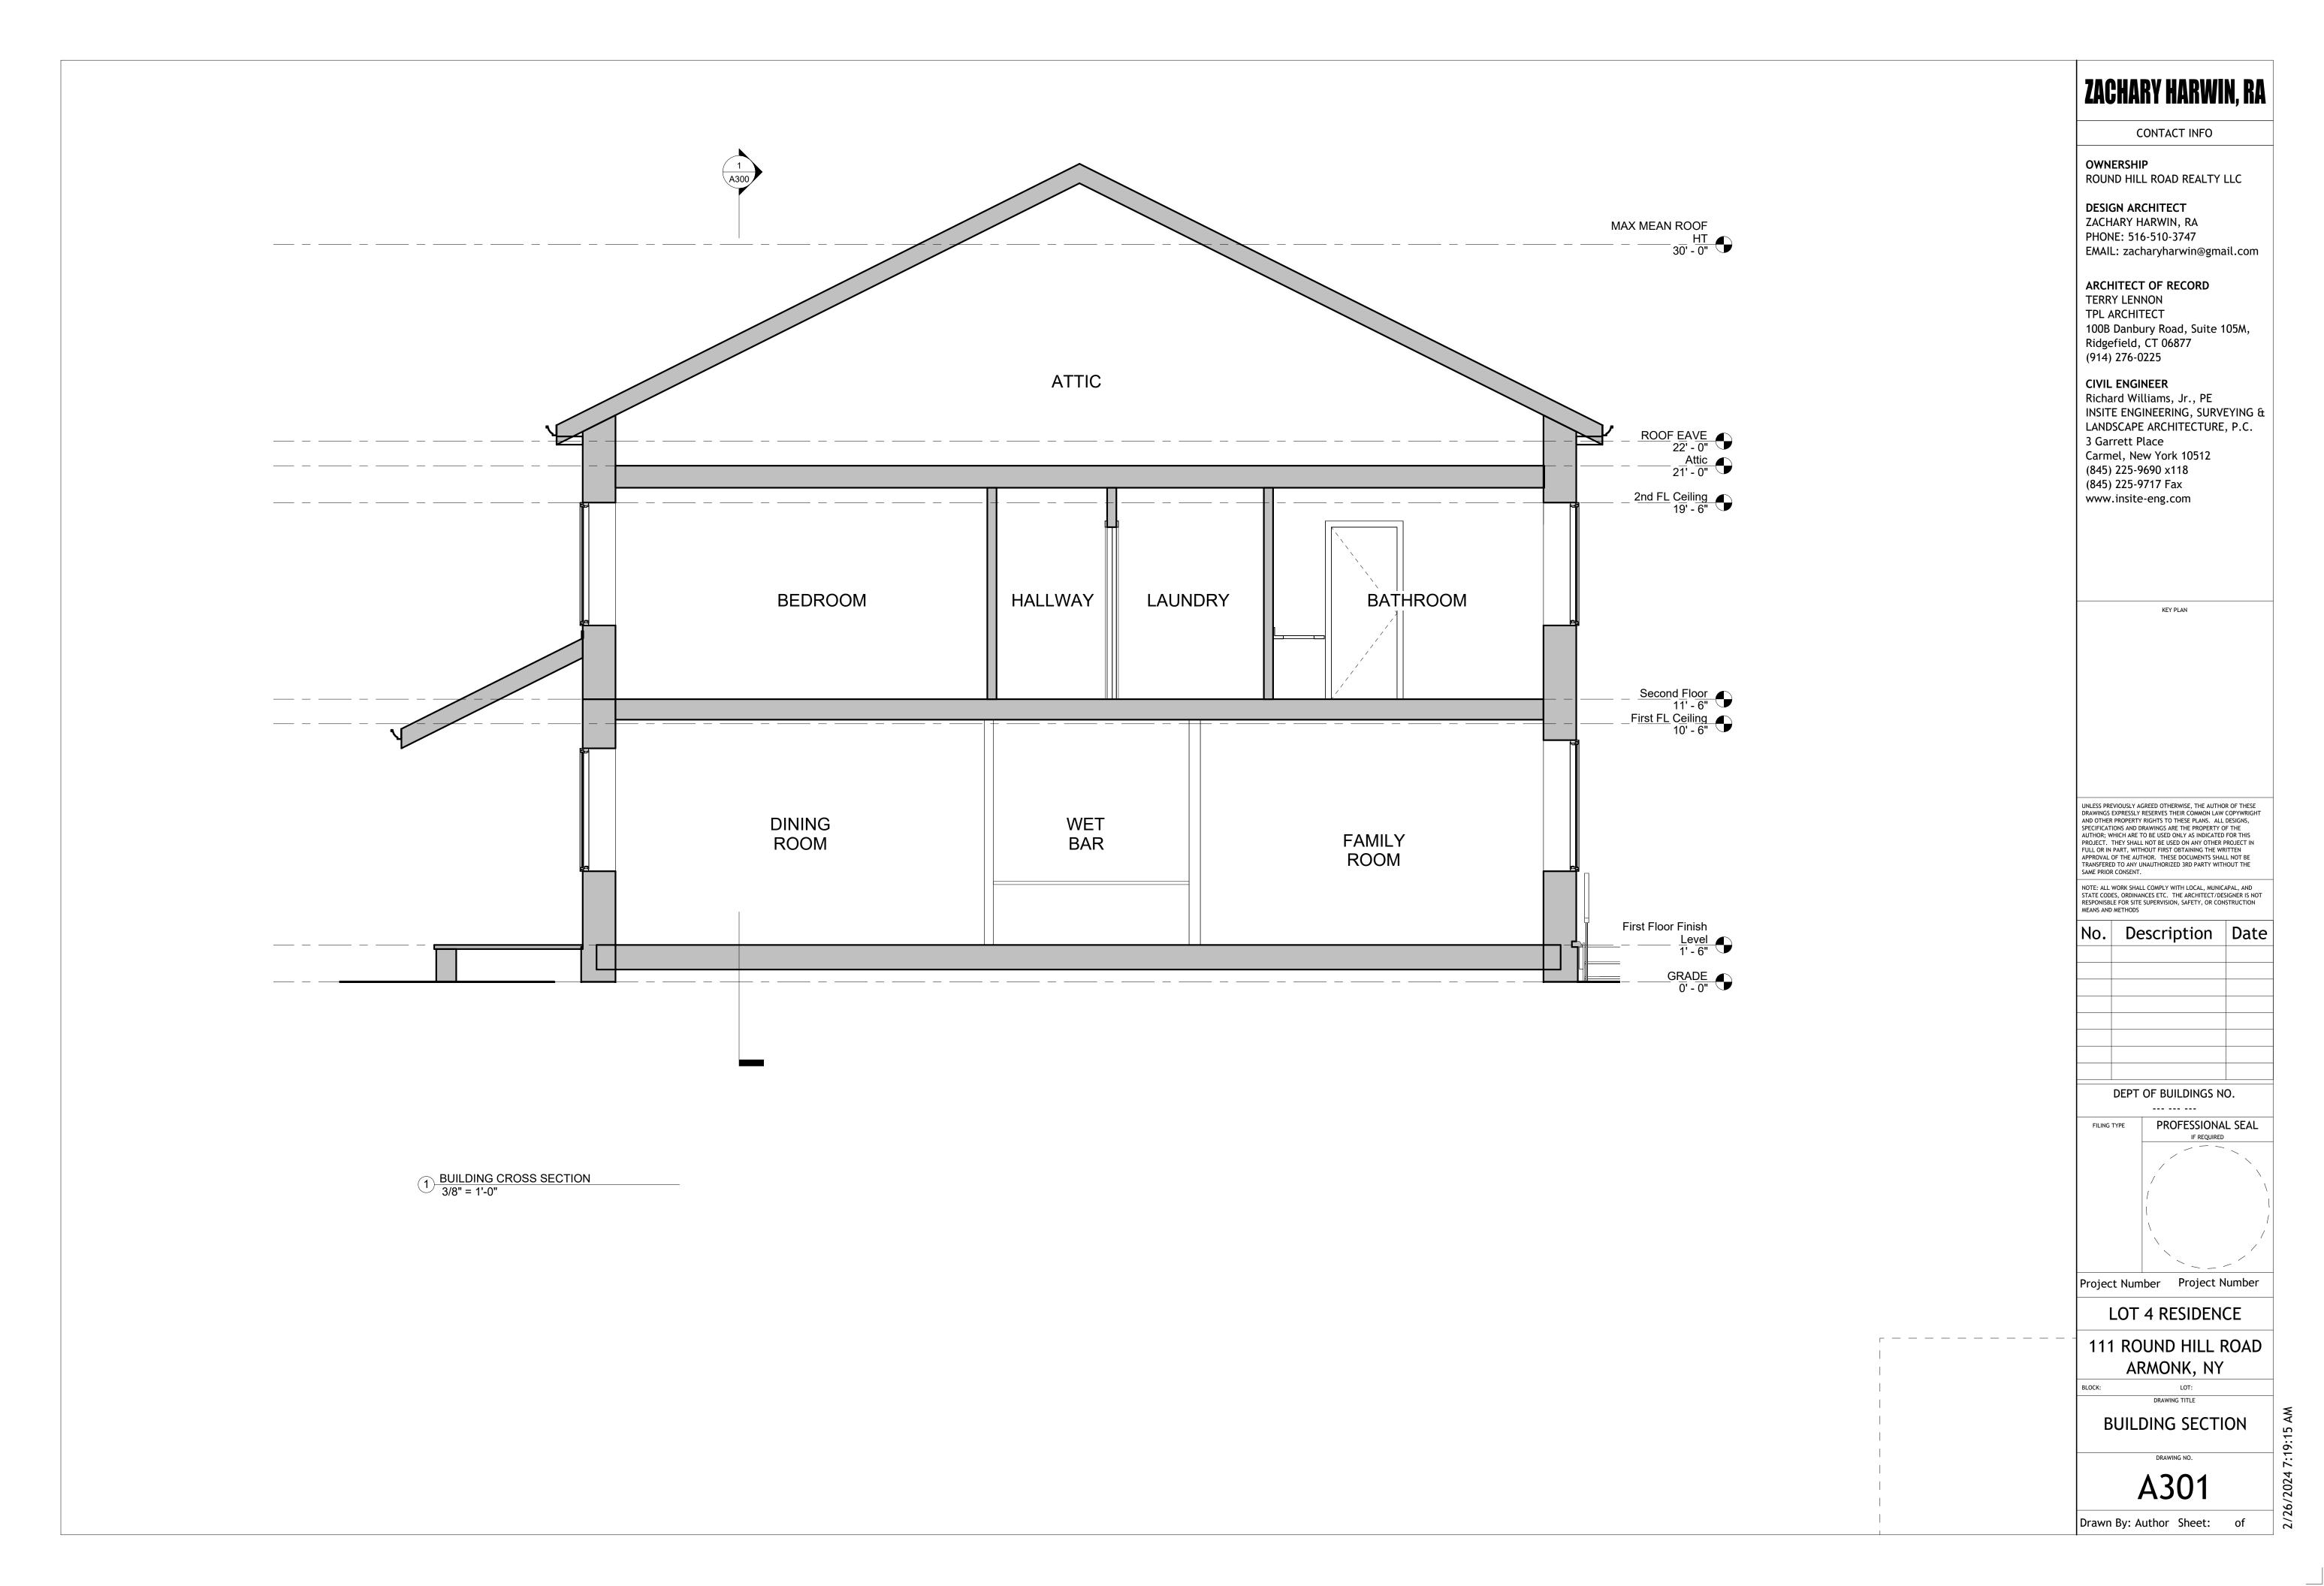





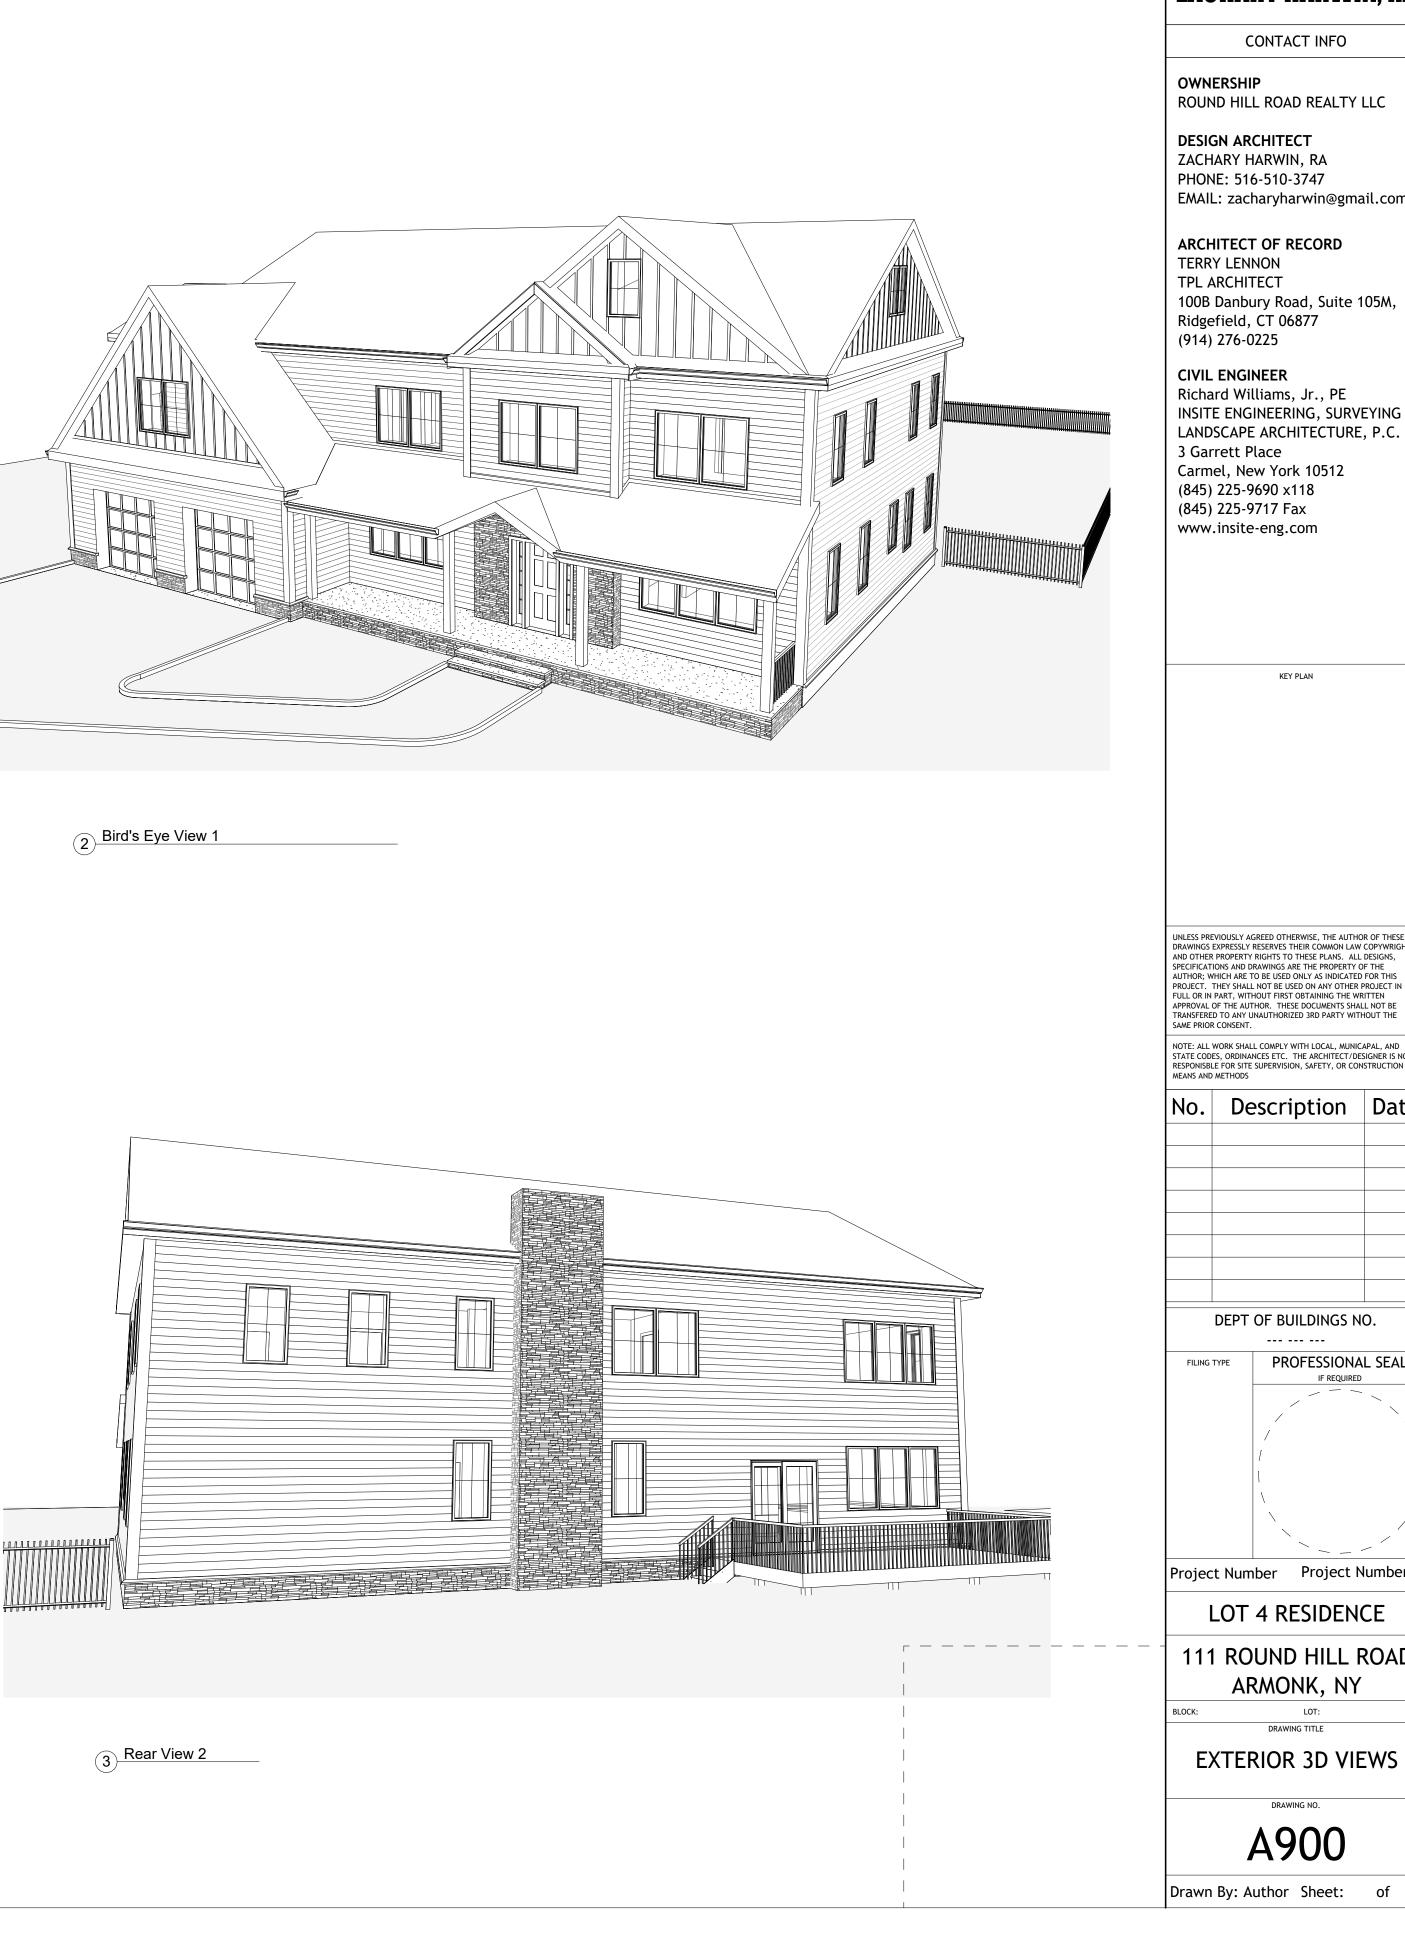



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No. Description Date

DEPT OF BUILDINGS NO. ---- ----

PROFESSIONAL SEAL FILING TYPE IF REQUIRED

Project Number Project Number

LOT 4 RESIDENCE

111 ROUND HILL ROAD ARMONK, NY LOT: BLOCK:

DRAWING TITLE HOME RENDERING DRAWING NO. A901



TOWN OF NORTH CASTLE

WESTCHESTER COUNTY 17 Bedford Road Armonk, New York 10504-1898

PLANNING DEPARTMENT Adam R. Kaufman, AICP Director of Planning

Telephone: (914) 273-3542 Fax: (914) 273-3554 www.northcastleny.com

FLOOR AREA CALCULATIONS WORKSHEET

Application	n Name or Identifying Title:	111 ROUND HILL ROAD - LOT 4 Date:	2024-02-26
Tax Map D	Designation or Proposed Lot No.:	1-9-13-7	
Floor Area			
1. To	otal Lot Area (Net Lot Area for Lo	ots Created After 12/13/06):	163,452 SF
2. M	aximum permitted floor area (per	r Section 355-26.B(4)):	13,175 SF
	mount of floor area contained with existing +		2,213.5 SF
	mount of floor area contained with existing +		2,871.4 SF
	mount of floor area contained with existing +		724.2 SF
	mount of floor area contained with existing +	hin porches capable of being enclosed: _ proposed =	233.7 SF
7. Ai	mount of floor area contained with existing +	hin basement (if applicable – see definition): _ proposed =	0 SF
	mount of floor area contained with existing +	hin attic (if applicable – see definition): _ proposed =	1,125.9 SF
9. Ai	mount of floor area contained with existing +		0 SF
10. Pr	roposed floor area: Total of Lines	s 3 – 9 =	7,168.7 SF

If Line 10 is less than or equal to Line 2, your proposal **complies** with the Town's maximum floor area regulations and the project may proceed to the Residential Project Review Committee for review. If Line 10 is greater than Line 2 your proposal does not comply with the Town's regulations.

Signature and Seal of Professional Preparing Worksheet

Date



TOWN OF NORTH CASTLE

WESTCHESTER COUNTY 17 Bedford Road Armonk, New York 10504-1898

PLANNING DEPARTMENT Adam R. Kaufman, AICP Director of Planning

Telephone: (914) 273-3542 Fax: (914) 273-3554 www.northcastleny.com

GROSS FLOOR AREA WORKSHEET

The following format is to be used for all applications for the purpose of demonstrating the gross floor area of a building or group of buildings as necessary to show compliance with a building or group of buildings as necessary to show compliance with floor area limitations of the Town Code or as otherwise necessary to illustrate the intended or potential use of a structure.

- 1. Scaled worksheets are to be prepared based upon floor plans which represent existing or proposed conditions as applicable to the particular circumstances of the approval being sought. All floor plans and worksheets are required to be prepared by a licensed or registered professional in the State of New York.
- 2. The floor area of each floor is to be divided into simple polygons (squares, rectangles, etc.) each being drawn on the plan. The area of each polygon is to be shown by providing the dimensions and resulting area measurement. Each polygon is to be assigned an identifying label for reference purposes.
- 3. A summary table for each floor is to be completed. The area of each polygon is to be listed by reference label then added, resulting in the floor area for the entire floor.
- 4. A similar summary table is to be provided listing the total floor are of each floor within the resulting floor area of each building.
- 5. Any exception of floor area from the gross floor area must be identified on the floor plans and summary tables. The rationale for any exception must accompany the floor area worksheets.
- 6. A schematic illustration of the format is shown below (or schematic illustration with areas calculated with CAD).



LOT AREA, NET – Lot area minus seventy five (75) percent of the area of any wetlands, waterbodies and, watercourses, but excluding any adjacent areas, all as defined in Chapter 209 Wetlands and Drainage, of the Town Code, and the area of any steep slopes, as defined Chapter 340, except that in the case of one-family lots, the deduction for steep slopes shall be only fifty (50) percent.

FLOOR AREA, GROSS -- The sum of the horizontal areas of the several stories of the building or buildings, excluding any floor area used for off-street parking or loading purposes (except for one- and two-family residences), measured from the exterior walls or, in the case of a common wall separating two buildings, from the center line of such a common wall, and including any two-story or any enclosed porch, or one having a roof and capable of being enclosed. See the definition of "basement" for exclusion of basement/mechanical areas in nonresidential buildings from "floor area, gross." For one- and two-family residences, any attic space with a floor to ceiling height of 7.5 feet or greater shall be included as part of gross floor area, as shall those portions of any basement with a floor to ceiling height of 7.5 feet or greater if the basement is considered a "story" in accordance with one of the following three alternative measurements:

- A. Where the finished surface of the floor above the basement is more than six feet above average grade.
- B. Where the finished surface of the floor above the basement is more than six feet above the finished ground level for more than 50% of the total building perimeter.
- C. Where the finished surface of the floor above the basement is more than 12 feet above the finished ground level at any point along the building perimeter.

Lot Size	Maximum Permitted Gross Floor
Lot Size	Area for One-Family Dwellings and
	Accessory Buildings ¹
	(square feet)
I. (1. 5.000	
Less than 5,000 square feet	1,875 or 50% of the lot area,
	whichever is greater
5,000 to 9,999 square feet	2,500 plus 25% of the lot area in
	excess of 5,000 square feet
10.000 . 14.000	- -
10,000 to 14,999 square feet	3,750 plus 20% of the lot area in
	excess of 10,000 square feet
15,000 square feet to 0.499	4,750 plus 15% of the lot area in
acres	excess of 15,000 square feet
	*
0.5 to 0.749 acres	5,768 plus 10% of the lot area in
	excess of 0.5 acres
0.75 to 0.999 acres	6,856 plus 8% of the lot area in
	excess of 0.75 acres
1.0 to 1.499 acres	7,727 plus 6% of the lot area in
	excess of 1.0 acres
1.5 to 1.999 acres	9,034 plus 5% of the lot area in
	excess of 1.5 acres
2.0 to 3.999 acres	10,122 plus 4% of the lot area in
	excess of 2.0 acres
4.0 acres or more	13,607 plus 3% of the lot area in
	excess of 4.0 acres

*Permitted gross floor area for two-family dwellings in the R-2F District shall be one-third (1/3) greater than that permitted for one-family dwellings.

F:\PLAN6.0\Application Forms\2016 Full Set\FLOOR AREA CALCULATIONS WORKSHEET 2016.doc

	ROC	OF PEAK LENGTH	IS			
	FEET	INCHES	HEIGHT			
GARAGE ROOF	7	9 1 / 2	7.79167 FT	7.6%		
MAIN ROOF HIGH PEAK	64	10 1 / 4	64.8542 FT	63.0%		
MAIN ROOF HIGH PEAK 2	21	3 1 / 4	21.2708 FT	20.7%		
MAIN ROOF LOW PEAK	9	0 0 / 0	9 FT	8.7%		
TOTAL LENGTH			102.917 FT	100.0%		
	MEAN I	LEVEL ROOF HEI	GHTS			
	MEAN I FEET	LEVEL ROOF HEI INCHES	GHTS HEIGHT			
GARAGE ROOF				X 7.6%	=	1.46054 FT
	FEET	INCHES	HEIGHT	X 7.6% X 63.0%	=	1.46054 FT 17.3688 FT
MAIN ROOF HIGH PEAK	FEET 19	INCHES 3 1 / 2	HEIGHT 19.2917 FT		=	
GARAGE ROOF MAIN ROOF HIGH PEAK MAIN ROOF HIGH PEAK 2 MAIN ROOF LOW PEAK	FEET 19 27	INCHES 3 1 / 2 6 3 / 4	HEIGHT 19.2917 FT 27.5625 FT	X 63.0%	= =	17.3688 FT