



A-100

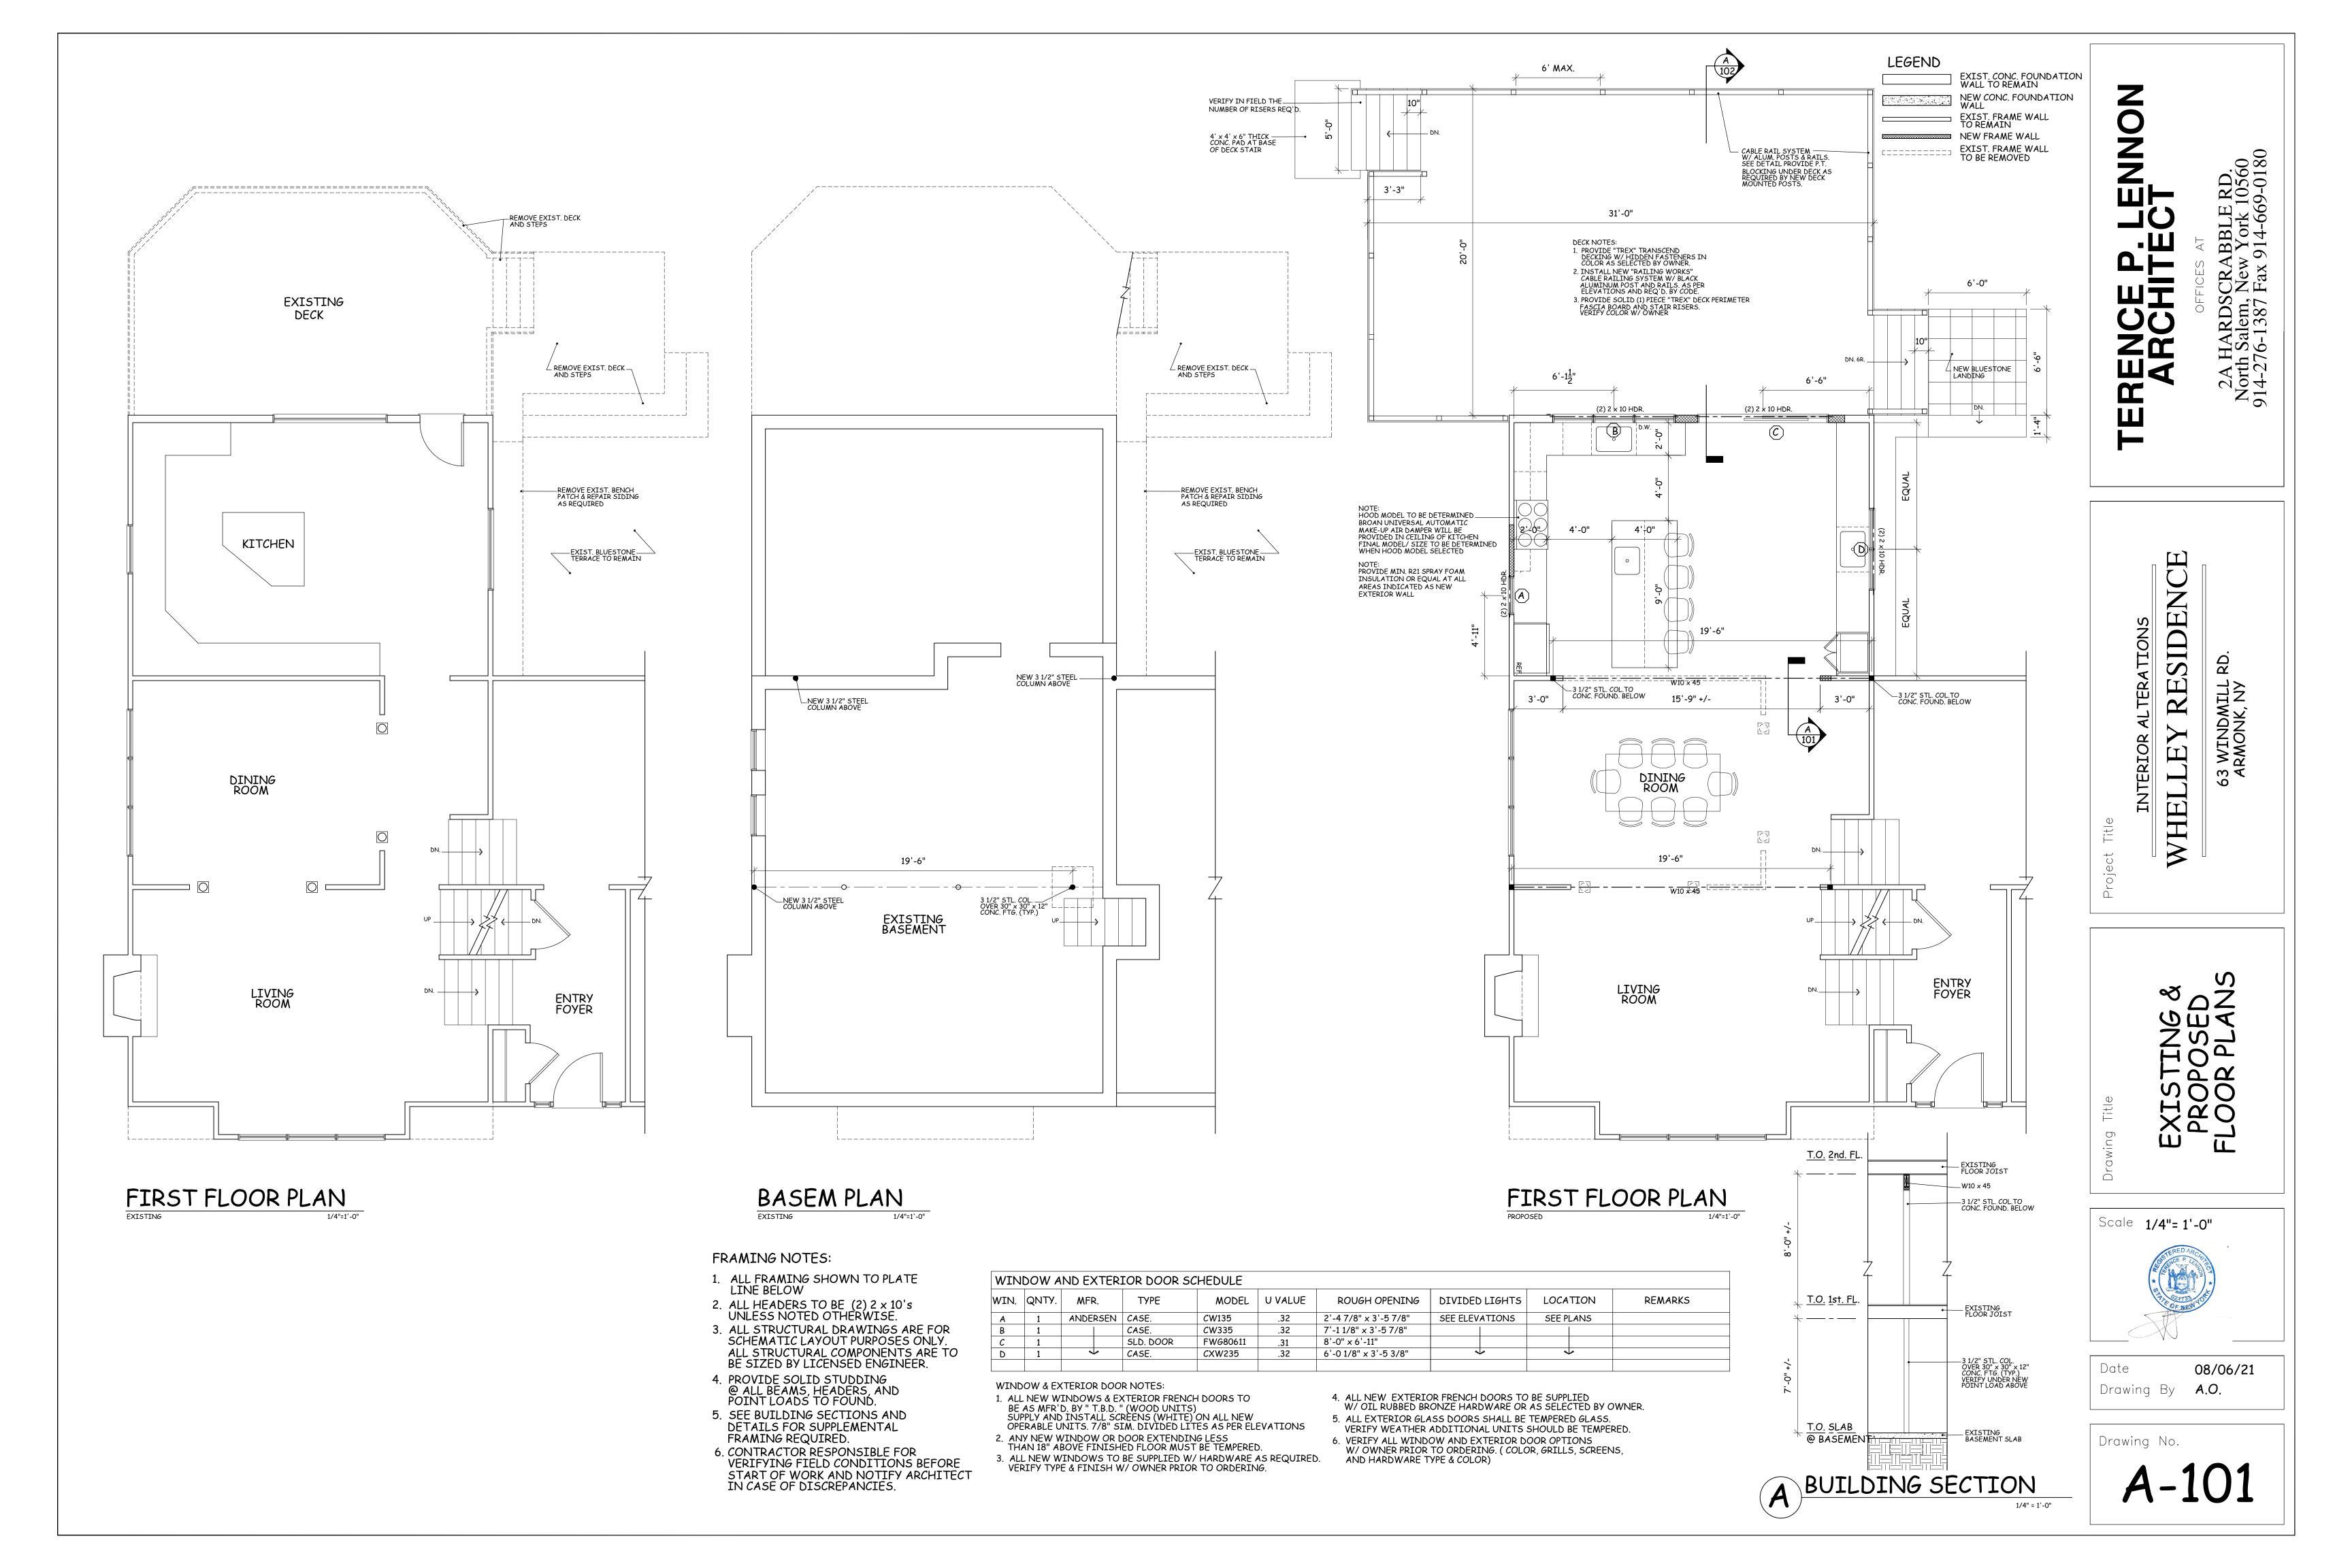

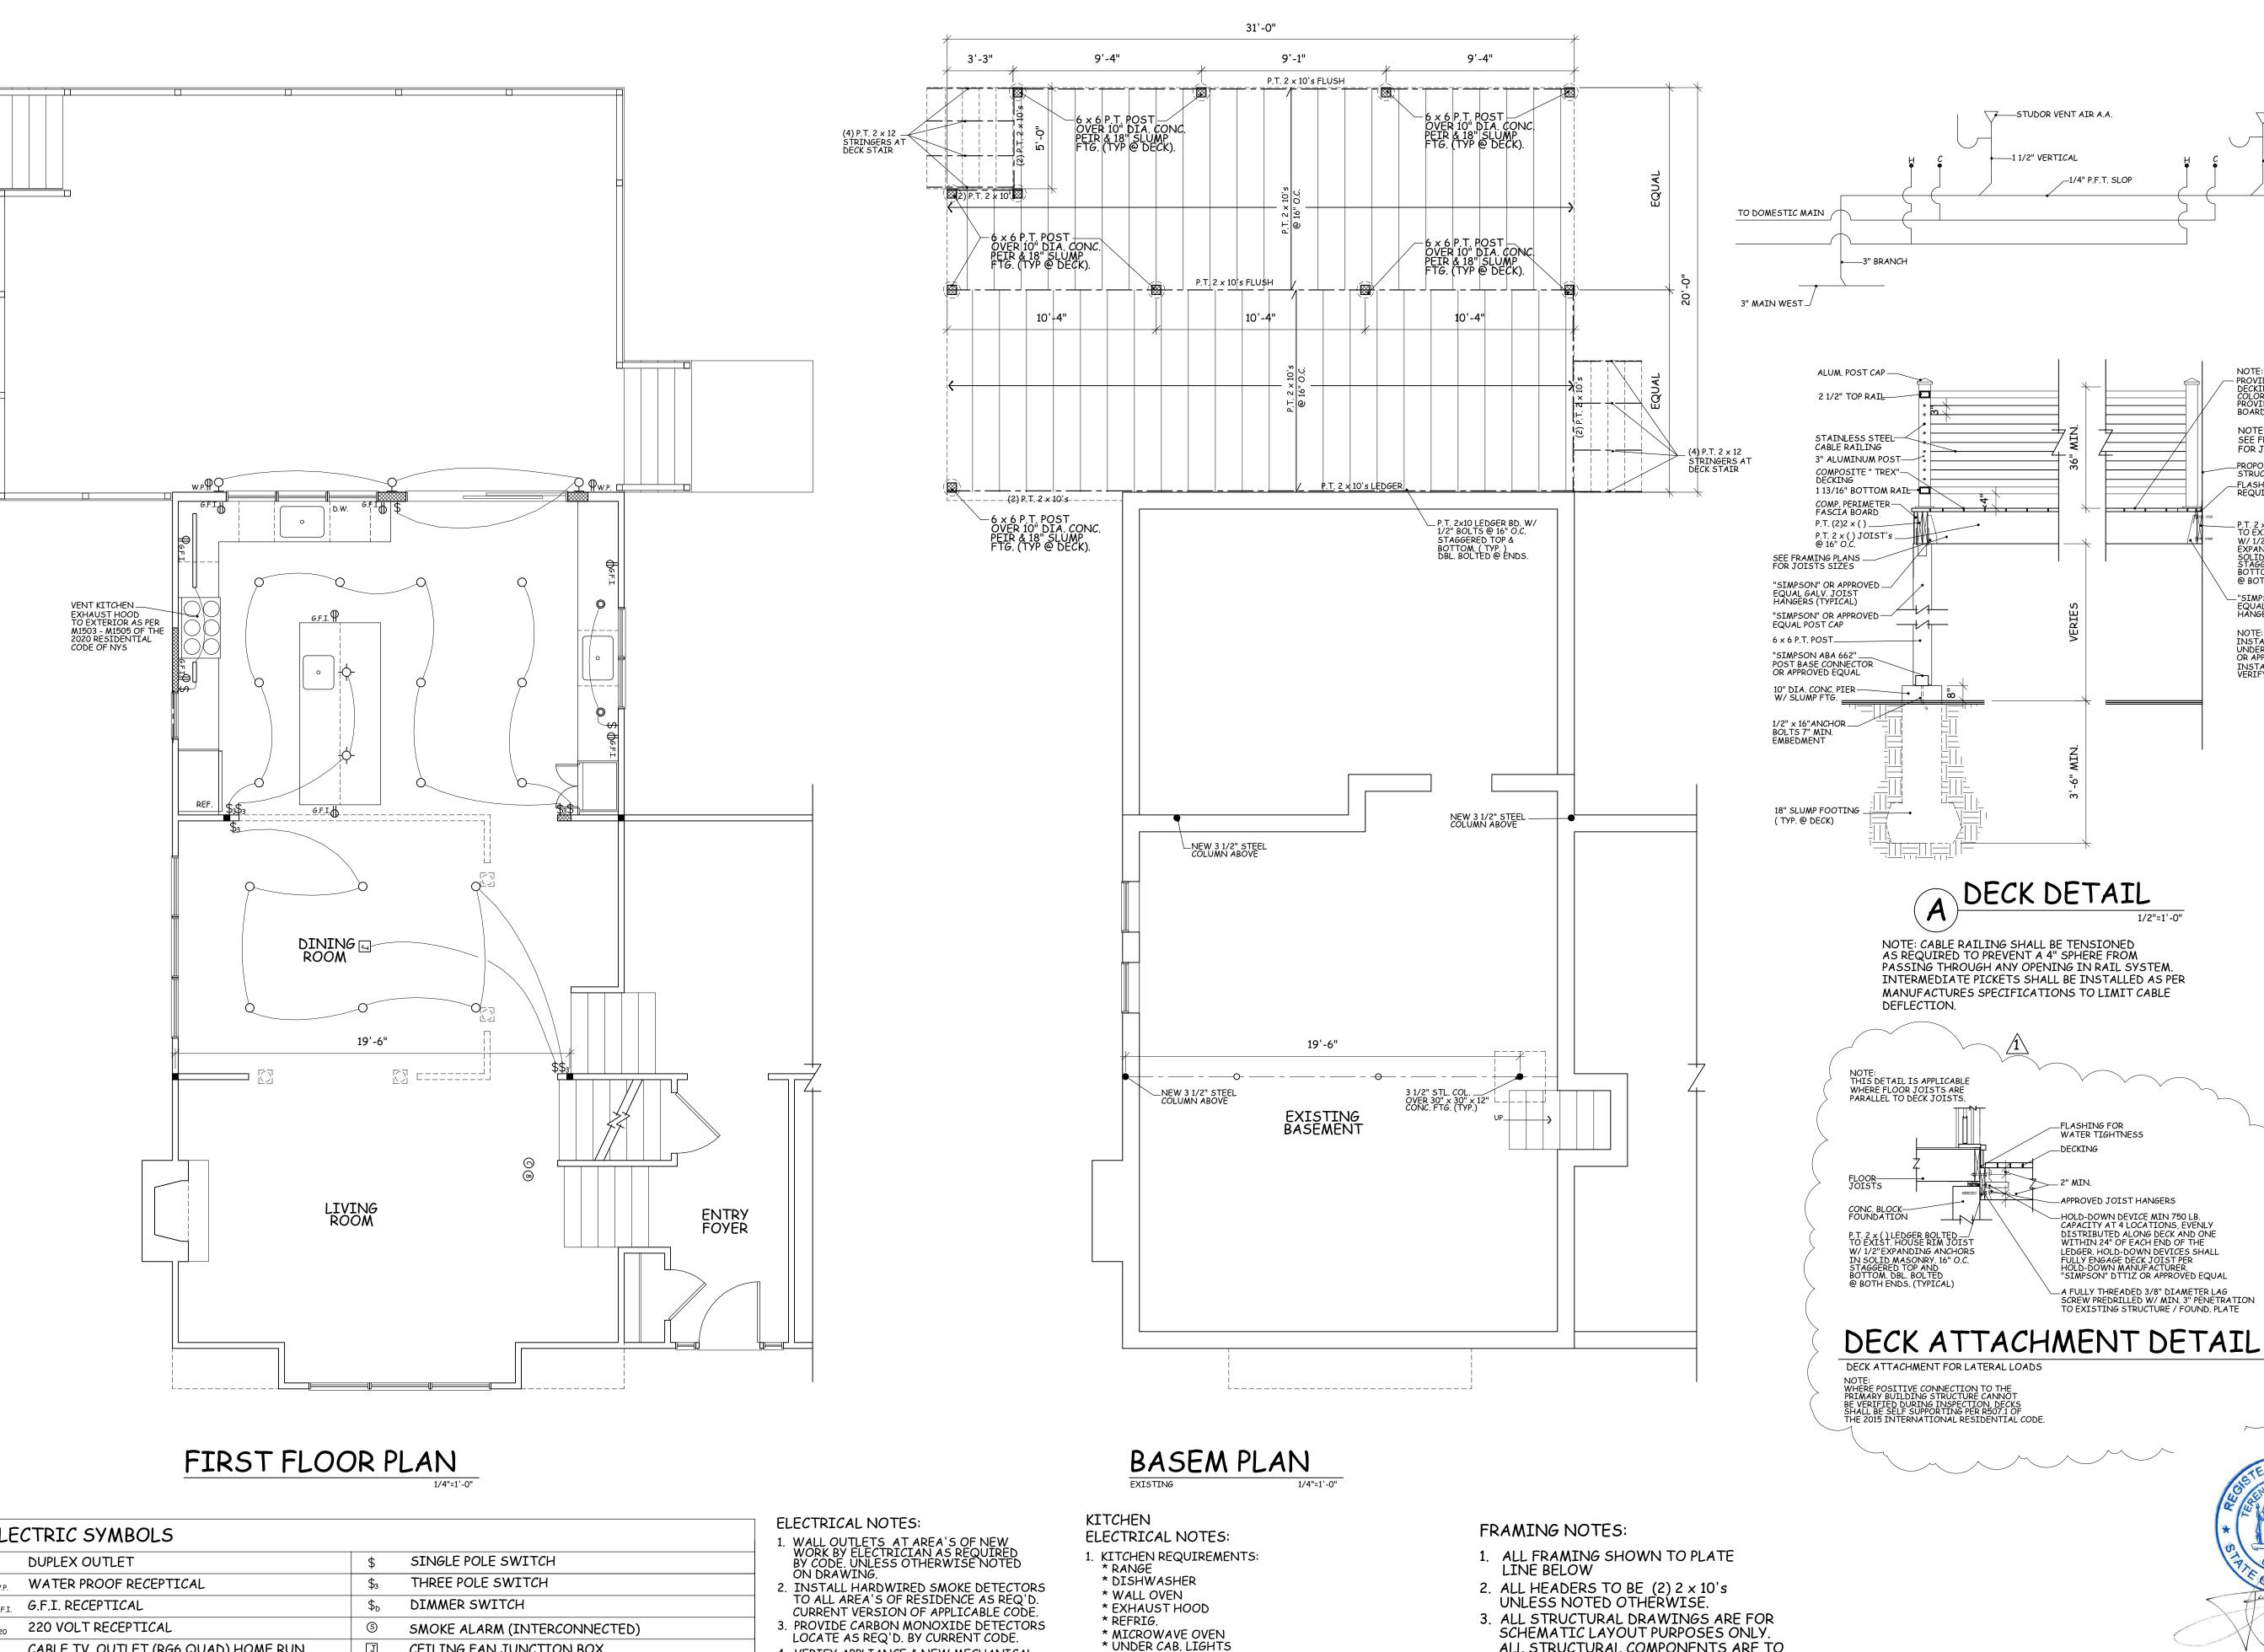

ELECTRIC SYMBOLS Ψ_{W.P.} WATER PROOF RECEPTICAL $\Phi_{G,F,I}$ G.F.I. RECEPTICAL Φ₂₂₀ 220 VOLT RECEPTICAL CEILING FAN JUNCTION BOX CABLE TV. OUTLET (RG6 QUAD) HOME RUN SURFACE MOUNTED LIGHT FIXTURE EXTER. SPOT LIGHT 5" RECESSED LIGHT W/ LED BULB & TRIM — UNDERCOUNTER LIGHTING 3" RECESSED LIGHT W/ LED BULB & TRIM WALL MOUNTED LIGHT FIXTURE HEAT DETECTOR (INSTALL AS REQ'D. BY CODE) CARBON MONOXIDE DET. (INSTALL AS REQ'D.) **EXHAUST FAN** 8

- 4. VERIFY APPLIANCE & NEW MECHANICAL EQUIPMENT ELECTRICAL REQUIREMENT W/ OWNER PRIOR TO ROUGH IN
- 5. PROVIDE OWNER W/ \$500 ALLOWANCE FOR THE SELECTION & INSTALLATION OF DIMMER SWITCHES. VERIFY LOCATIONS.

3. SEE FINAL KITCHEN PLAN BY OTHERS AND VERIFY APPLIANCE REQUIREMENTS PRIOR TO ROUGH.

4. VERIFY KITCHEN COUNTER ELECTRICAL

OUTLET LOCATIONS W/ KITCHEN SUPPLIER

* G.F.C.I. WALL OUTLETS

2. VERIFY CENTER OF KITCHEN ISLAND PRIOR TO ROUGHING

* GARBAGE DISPOSAL

IN CLG. FIXTURES.

- ALL STRUCTURAL COMPONENTS ARE TO BE SIZED BY LICENSED ENGINEER.
- PROVIDE SOLID STUDDING
 ALL BEAMS, HEADERS, AND POINT LOADS TO FOUND.
- 5. SEE BUILDING SECTIONS AND DETAILS FOR SUPPLEMENTAL FRAMING REQUIRED.
- 6. CONTRACTOR RESPONSIBLE FOR VERIFYING FIELD CONDITIONS BEFORE

- START OF WORK AND NOTIFY ARCHITECT IN CASE OF DISCREPANCIES.

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STUDOR VENT AIR A.A.

—1 1/2" VERTICAL

CLEAN OUT _

SEE FRAMING PLANS FOR JOISTS SIZES

_ P.T. 2 x () LEDGER BOLTED TO EXIST. HOUSE RIM JOIST

TO EXIST. HOUSE RIM JOIST
W/ 1/2" LAG SCREWS OR 1/2"
EXPANDING ANCHORS IN
SOLID MASONRY. 16" O.C.
STAGGERED TOP AND
BOTTOM. DBL. BOLTED
@ BOTH ENDS. (TYPICAL)

—"SIMPSON" OR APPROVED EQUAL GALV. JOIST HANGERS (TYPICAL)

NOTE:
INSTALL "TREX" RAIN ESCAPE
UNDER DECK DRAINAGE SYSTEM
OR APPORVED EQUAL.
INSTALL AS PER MFR. SPECS.
VERIFY OPTIONS W/ OWNER

_PROPOSED STRUCTURE —FLASHING AS REQUIRED.

STUDOR VENT AIR A.A.

—1 1/2" VERTICAL

4

DECK DETAIL

_APPROVED JOIST HANGERS

HOLD-DOWN DEVICE MIN 750 LB.
CAPACITY AT 4 LOCATIONS, EVENLY
DISTRIBUTED ALONG DECK AND ONE
WITHIN 24" OF EACH END OF THE

LEDGER. HOLD-DOWN DEVICES SHALL FULLY ENGAGE DECK JOIST PER HOLD-DOWN MANUFACTURER.
"SIMPSON" DTT1Z OR APPROVED EQUAL

— A FULLY THREADED 3/8" DIAMETER LAG SCREW PREDRILLED W/ MIN. 3" PENETRATION TO EXISTING STRUCTURE / FOUND. PLATE

LEGEND

EXIST. CONC. FOUNDATION WALL TO REMAIN

NEW CONC. FOUNDATION WALL

NEW FRAME WALL

TO BE REMOVED

EXIST. FRAME WALL TO REMAIN

EXIST. FRAME WALL

NOTE: CABLE RAILING SHALL BE TENSIONED AS REQUIRED TO PREVENT A 4" SPHERE FROM

DEFLECTION.

INTERMEDIATE PICKETS SHALL BE INSTALLED AS PER MANUFACTURES SPECIFICATIONS TO LIMIT CABLE

_1/4" P.F.T. SLOP

SIDEN TIONS RE LEY

EI

S3 WINDMILL I ARMONK, NY

回证


Scale AS NOTED

1 REVISED 08/16/21

08/06/21

Drawing By A.O.

Drawing No.

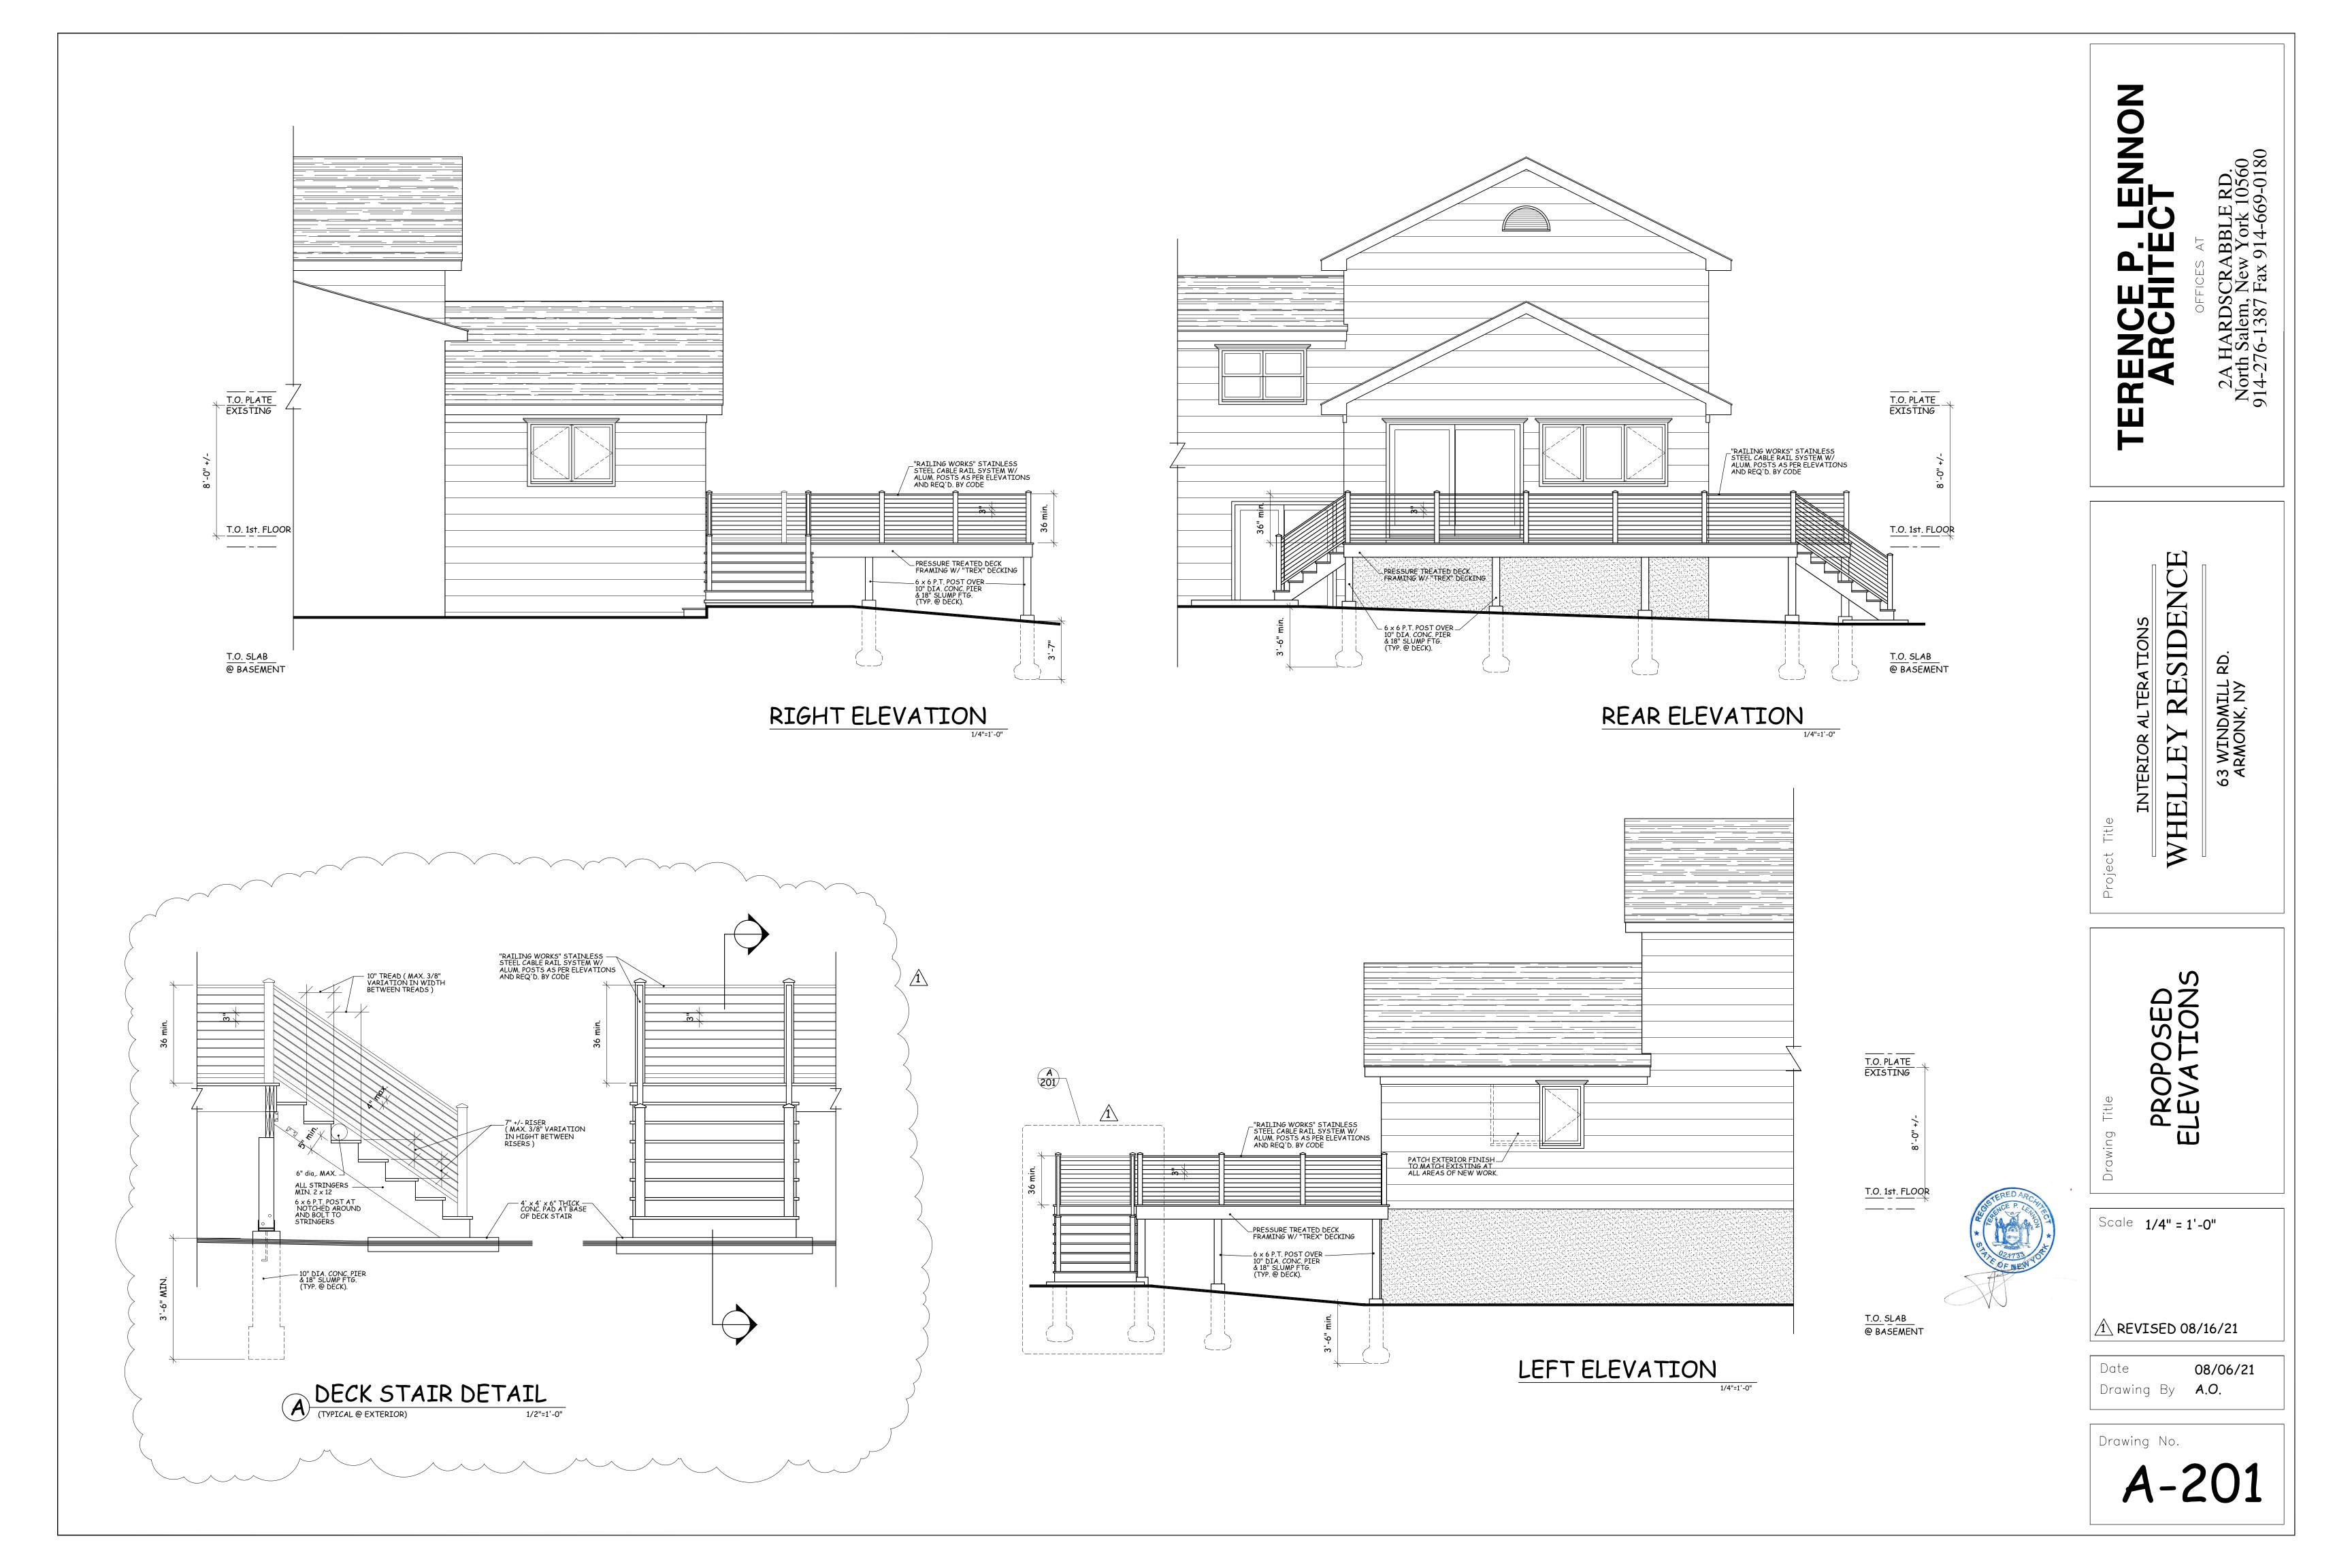



TOWN OF NORTH CASTLE

WESTCHESTER COUNTY 17 Bedford Road Armonk, New York 10504-1898

PLANNING DEPARTMENT Adam R. Kaufman, AICP Director of Planning

Telephone: (914) 273-3542 Fax: (914) 273-3554 www.northcastleny.com

GROSS LAND COVERAGE CALCULATIONS WORKSHEET

Applicat	tion Name or Identifying Title:	Date: _	· ·
Tax Map Designation or Proposed Lot No.:			
Gross Lot Coverage			
1.	Total lot Area (Net Lot Area for Lots Created After 12/13/06):		1,568 Actor
2.	Maximum permitted gross land coverage (per Section 355-26.C(1)(b)):		9,350
3.	BONUS maximum gross land cover (per Section 355-26.C(1)(b)):		
	Distance principal home is beyond minimum front yard setback x 10 =		0
4.	TOTAL Maximum Permitted gross land coverage = Sum of lines 2 and 3		9,350
5. U	Amount of lot area covered by principal building: Amount of lot area covered by principal building: Proposed = Proposed Proposed		2,112,284
6.	Amount of lot area covered by accessory buildings:		142
7.	Amount of lot area covered by decks:		718
8.	Amount of lot area covered by porches:		301
9.	Amount of lot area covered by driveway, parking areas and walkways: existing + proposed =		2,205
10.	Amount of lot area covered by terraces: 870 existing + g proposed =		789
11.	Amount of lot area covered by tennis court, pool and mechanical equip: existing + proposed =		44
12.	Amount of lot area covered by all other structures:		274
13. Prop	osed gross land coverage: Total of Lines $5-12=$		6,757
If Line 13 is less than or equal to Line 4, your proposal complies with the Town's maximum gross land coverage regulations and the project may proceed to the Residential Project Review Committee for review. If Line 13 is greater than Line 4 your proposal does not comply with the Town's regulations.			
Signature	e and Seal of Professional Preparing Worksheet Date		



63 Windmill Rd

Default size =

174.6808004